
EXTERNAL MATERIALS

- White paint to existing timber soffits (able to be reinstated to original finish in future)
 Light paint colour to existing brick (able to be reinstated to original finish in future)
 Travertine exterior floor tiles to replace existing damaged tiles
 Existing timber shingled roof
 White sandstone terraces walls

- White sandstone terraces walls
 New low-e glazing to all
 windows including existing +
 refurbish existing bronze frames
 Retain and relocate existing
 ceramic artwork
 Retain and refurbish existing
- copper door

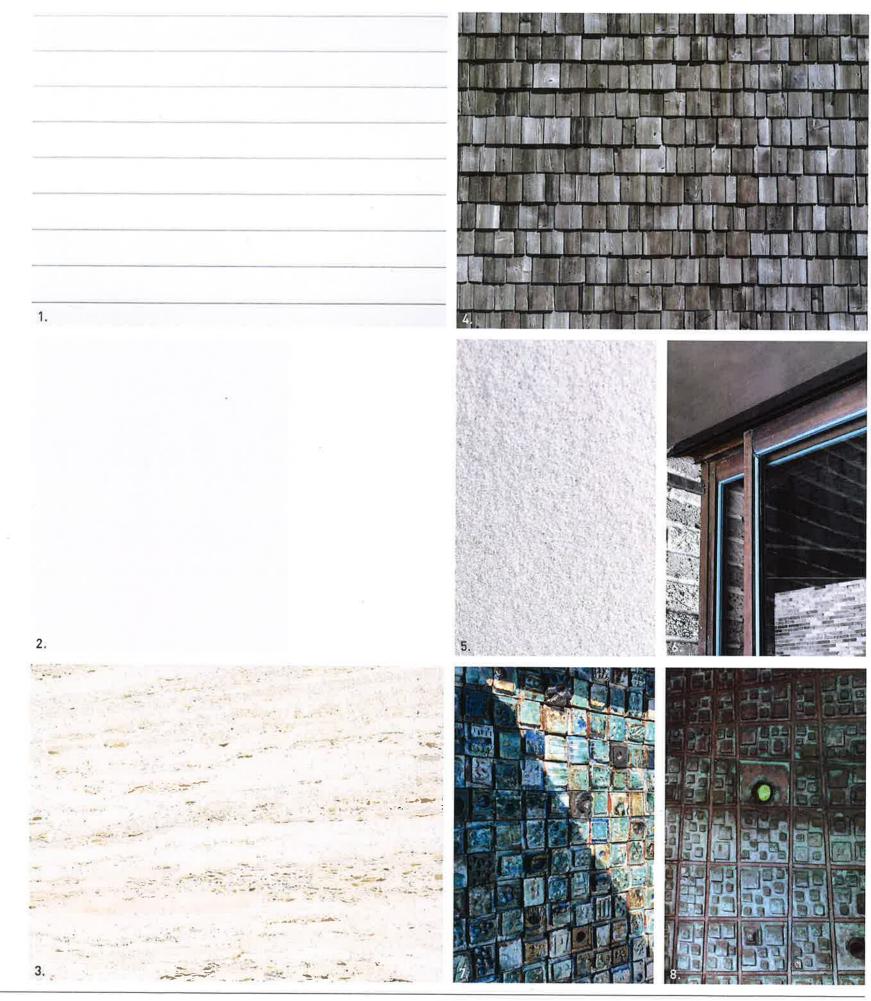



DRAWING REGISTER

DRAWING NUMBER	DRAWING TITLE	DRAWING SCALE	PAGE SIZE
LS4,55-01	DRAWING REGISTER, PROJECT NOTES AND PLANT SCHEDULE	NO SCALE	A2
LS4_55-02	SITE PLAN	1:200	A2
LS4_55-03	LANDSCAPE PLAN - REAR GARDEN	1:100	A2
LS4_55-04	SCHEMATIC PLANTING DETAILS	1:20	A2

PLANT SCHEDULE - REAR GARDEN					
LATIN NAME	COMMON NAME	MATURE HEIGHT	MATURE SPREAD	POT SIZE	QUANTITY
APTENIA CORDIFOLIA	BABY SUN ROSE	GROUNDCOVER	GROUNDCOVER	140MM	62
CARISSA MACROCARPA 'DESERT STAR'	NATAL PLUM	0,5 - 1M	1M	200MM	76
CISSUS ANTARCTICA	KANGAROO VINE	GROUNDCOVER	GROUNDCOVER	140MM =	320
CORYMBIA MACULATA	SPOTTED GUM	25 - 30M	8 - 10M	400L	1
ELAEOCARPUS EUMUNDI	EUMUNDI QUANDONG	10M	3 - 5M	400L	8
LIVISTONA AUSTRALIS	CABBAGE PALM	15 - 18M	6 - 8M	EX-GROUND	8
LOMANDRA LONGIFOLIA 'TANIKA'	MATRUSH	0,5M	0,6M	140MM	280
MISCANTHUS TRANSMORRISONENSI	EVERGREEN FEATHER GRASS	1 ₂ M	1M	140MM	27
PITTOSPORUM TOBIRA	JAPANESE PITTOSPORUM	0,5M	1M	300MM	80
RHAPHIOLEPIS INDICA 'SNOW MAIDEN'	INDIAN HAWTHORN	0,7 - 1M	1M	300MM	40
STENOTAPHRUM SECUNDATUM	SIR WALTER BUFFALO	MAINTAINED	MAINTAINED	TURF	66,5M²
SYZYGIUM PANICULATUM	MAGENTA LILLY PILLY	8M	2 - 4M	400L	8
XANTHORRHOEA AUSTRALIS	GRASS TREE	1,5M	1M	300MM	24

NOTES - GENERAL

FOR \$4,55 ONLY - NOT FOR CONSTRUCTION

DO NOT SCALE FROM DRAWINGS

ALL WORK TO BE CARRIED OUT IN ACCORDANCE WITH THE LANDSCAPE TECHNICAL SPECIFICATION

NO 'WASH OUT' FROM CONSTRUCTION TO TAKE PLACE IN IDENTIFIED GARDEN AREAS

ALL DISCREPANCIES OR CONFLICT TO BE BROUGHT TO THE ATTENTION OF THE PROJECT LANDSCAPE DESIGNER PRIOR TO CONSTRUCTION OR INSTALLATION

ALL DIMENSIONS IN MM UNLESS OTHERWISE STATED

ALL TREE DIMENSIONS AND RL'S IN METERS

USE FIGURED DIMENSIONS ONLY

VERIFY ALL DIMENSIONS ON SITE BEFORE THE COMMENCEMENT OF ANY WORKS

ANY LEVELS ARE NOMINAL AND ARE INDICATIVE ONLY

CONTRACTORS SHALL LOCATE AND PROTECT ALL SERVICES PRIOR TO CONSTRUCTION

CONTRACTORS TO CONTACT DIAL-BEFORE-YOU-DIG TO CONFIRM LOCATION OF SERVICES BEFORE EXCAVATION

ALL WORK SHALL BE CARRIED OUT IN ACCORDANCE WITH CURRENT VERSIONS OF AUSTRALIAN STANDARDS, BCA AND LOCAL GOVERNMENT REGULATIONS

STRUCTURAL DETAILS SHALL BE SUBJECT TO ENGINEER'S SPECIFICATIONS

DRAINAGE AND WATER FEATURE DETAILS SHALL BE SUBJECT TO HYDRAULIC ENGINEER'S SPECIFICATIONS

ALL WORK SHALL BE CARRIED OUT IN A PROFESSIONAL MANNER BY QUALIFIED TRADESPERSON ACCORDING TO THE LANDSCAPE DRAWINGS & TECHNICAL SPECIFICATION AND ENGINEER'S SPECIFICATIONS

PROTECT ALL ADJOINING PROPERTY BUILDING, WALLS AND PAVING, DAMAGED ELEMENTS ARE TO BE REPLACED AT NO COST TO THE CLIENT

NO RESPONSIBILITY WILL BE TAKEN BY FIELDWORK ASSOCIATES PTY LTD FOR ANY VARIATIONS IN DESIGN, CONSTRUCTION METHOD, MATERIALS SPECIFIED AND GENERAL SPECIFICATIONS WITHOUT PERMISSION FROM THE PROJECT ENGINEER OR LANDSCAPE DESIGNER

ANY SPECIFIED MATERIALS OR PRODUCTS ARE TO BE INSTALLED AS PER THE MANUFACTURER'S / SUPPLIER'S INSTRUCTIONS

SERVICE LOCATION ON PLANS ARE INDICATIVE ONLY. FIELDWORK ASSOCIATES PTY LTD ACCEPTS NO RESPONSIBILITY FOR THE ACCURACY OF SERVICE LOCATIONS, IT IS THE RESPONSIBILITY OF THE CONTRACTOR TO DETERMINE SERVICE LOCATIONS PRIOR TO THE COMMENCEMENT OF WORK, ANY DAMAGES TO SERVICES AND ASSOCIATED DAMAGES REMAINS THE RESPONSIBILITY OF THE CONTRACTOR AND SHALL BE RECTIFIED AT NO COST TO THE CLIENT

THIS DRAWING IS COPYRIGHT TO FIELDWORK ASSOCIATES PTY LTD

FIELDWORK ASSOCIATES PTY LTD RESERVES THE RIGHT NOT TO PROVIDE LANDSCAPE CERTIFICATES AT PROJECT COMPLETION IF NOT EMPLOYED THROUGH THE CONSTRUCTION DOCUMENTATION AND IMPLEMENTATION PHASES

ANY CLAIMS MADE AGAINST FIELDWORK ASSOCIATES PTY LTD FOR ANY FAULTS IN THE LANDSCAPE IMPLEMENTATION ARE VOID IF FIELDWORK ASSOCIATES PTY LTD HAS NOT BEEN EMPLOYED THROUGH THE CONSTRUCTION DOCUMENTATION AND IMPLEMENTATION PHASES

NOTES - PLANTING

PROJECT LANDSCAPE DESIGNER TO SET OUT PLANT MATERIAL

PLANT QUANTITIES TO BE CONFIRMED BY FIELDWORK ASSOCIATES PTY LTD AT TIME OF CONSTRUCTION

ALL GARDEN'BED AREAS TO BE CLEARED OF RUBBLE AND DEBRIS PRIOR TO PLANTING

PLANTING MEDIA TO BE CONFIRMED WITH LANDSCAPE CONTRACTOR AND FIELDWORK ASSOCIATES PTYLTD

ALL WEED SPECIES ON SITE ARE TO BE ERADICATED

ALL SITE SOIL IS TO BE MAINTAINED AND IMPROVED WITH COMPOST SPECIFIED BY FIELDWORK ASSOCIATES PTY LTD

ALL PLANT SPECIES SHOULD BE IN ACCORDANCE WITH THE PLANTING SCHEDULE UNLESS CONSENT IS GIVEN FROM FIELDWORK ASSOCIATES PTY LTD

ALL GARDEN BEDS ARE TO BE MULCHED, MULCH TYPE TBC WITH FIELDWORK ASSOCIATES PTY LTD

\$4.55 ONLY - NOT FOR CONSTRUCTION

FIELDWORK
ASSOCIATES

FIELD WORK ASSOCIATES
SUITE 111, 120 BOURKE STREET
WOOLLOOMOOLOO, NSW 2011
PON 03/555/19
EMAIL DESIGN@FIELDWORK NET AU

3 RIVERVIEW R AVALON	DATE 01.10.2019	
LANDSCAPE 54. DRAWING REGI	02.10.2019	
DRAWING NO. LS4,55-01	SCALE	


REASON FOR ISSUE REVIEW 54,55

C. OWEN

DRAWN
E. ROWE, C. LEE

CHECKED
C. OWEN

DATE

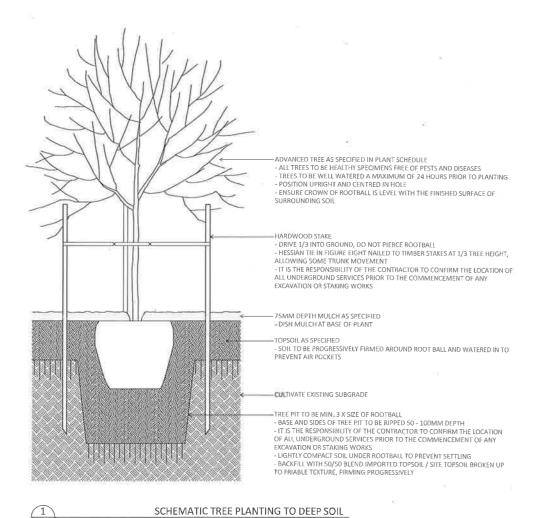

-PLANTING AS SPECIFIED IN PLANT SCHEDULE

- PLANT TO BE POSITIONED UPRIGHT AND IN CENTRE OF HOLE


- ENSURE CROWN OF ROOTBALL IS LEVEL WITH THE FINISHED SURFACE OF


75MM DEPTH MULCH AS SPECIFIED

- DISH MULCH AT BASE OF PLANT TOPSOIL A HORIZON AS SPECIFIED - SOIL TO BE PROGRESSIVELY FIRMED AROUND ROOT BALL AND WATERED IN TO PREVENT AIR POCKETS


CULTIVATE EXISTING SUBGRADE TO DEPTH OF 150MM

SCHEMATIC SHRUB AND GROUNDCOVER PLANTING TO DEEP SOIL

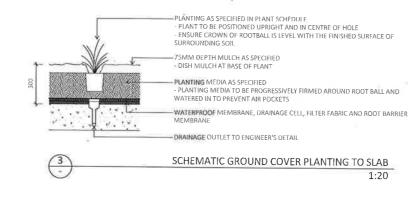

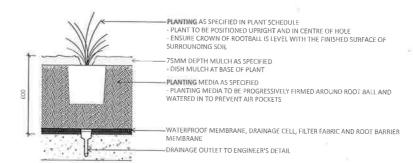

SCHEMATIC SHRUB AND GROUNDCOVER PLANTING TO SLAB

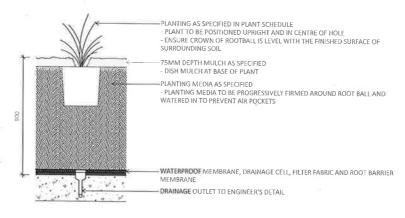

SCHEMATIC SHRUB AND GROUNDCOVER PLANTING TO SLAB

PROJECT LANDSCAPE DESIGNER TO SET OUT PLANT MATERIAL

PLANT QUANTITIES TO BE CONFIRMED BY FIELDWORK ASSOCIATES PTY LTD AT TIME OF CONSTRUCTION

ALL GARDEN BED AREAS TO BE CLEARED OF RUBBLE AND DEBRIS PRIOR TO PLANTING

PLANTING MEDIA TO BE CONFIRMED WITH LANDSCAPE CONTRACTOR AND FIELDWORK ASSOCIATES PTY LTD

ALL WEED SPECIES ON SITE ARE TO BE ERADICATED

ALL SITE SOIL IS TO BE MAINTAINED AND IMPROVED WITH COMPOST SPECIFIED BY FIELDWORK ASSOCIATES PTY LTD

ALL PLANT SPECIES SHOULD BE IN ACCORDANCE WITH THE PLANTING SCHEDULE UNLESS CONSENT IS GIVEN FROM FIELDWORK ASSOCIATES PTY LTD

ALL GARDEN BEDS ARE TO BE MULCHED, MULCH TYPE TBC WITH FIELDWORK ASSOCIATES PTY LTD

S4.55 ONLY - NOT FOR CONSTRUCTION

3 RIVERVIEW ROAD 1.10.2019 AVALON 2.10.2019 ANDSCAPE \$4,55 DOCUMENTATION CHEMATIC PLANTING DETAILS SCALE 1:20@A2

FIELDWORK

ROWE, C. LEE

DRAWING SCHEDULE

DA000	Drawing Schedule, Legend
DA001	BASIX Certificate
DA002	Site Analysis Plan
DA003	Site Plan
DA100	Boatshed Ground Plan
DA101	Boathouse Level 1 & Cellar Pla
DA102	Terrace & Gym Plan
DA103	House Plan
DA104	Guest & Carport Plan
DA300	Northern Elevation
DA301	Southern Elevation
DA302	Eastern Western Elevation

PRELIMINARY
NOTFORCONSTRUCTION

ISSUE

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ABBREVIATIONS

DA400 Section A & B

ACCRUJEL ACC	Air Conditioning Acrylic Air Condensor Unit Adjustable Above Finished Floor Level Aluminium Access Panel Australian Standard Balustrade Balcony Building Code of Australia Box Gutter Bulkhead Bitumen Brick Building Line Building Line Building Line Building Blockwork Bin Brass Bench Top Concrete Block Ceiling Fan Compressed Fibre Cement Construction Joint / Control Joint Column Concrete Chrome Plated Carpet Cement Render Cement Render Cement Render Cement Reder Ceramic Tile Door Dish Drain Diameter Door Dish Drain Diameter Downpipe Distribution Switchboard Drawing Exposed Aggregate Exhaust Cov(EG Exhaust Grille) Existing Ground Level Electrical Engineer Equal Existing Structure or Finish Exhaust Fixed Fibre Cement Finished Ceilling Level Finished Floor Level Floor Grate Finished Ground Level Flexible Mastic Fireplace Fire Resistant Fire	HYDS DE BELLE SEE SEE SEE SEE SEE SEE SEE SEE SEE	Stormwater Drain Stormwater Grate Stormwater Pit To Be Advised To Be Confirmed Top of Door Telephone Threshold Timber Timber Floor Top of Column Top of Kerb Top of Parapet Top of Wall Toilet Paper Holder Television Top of Window Underground Underside Universal Beam Universal Column Unless Noted Otherwise	U/G U/S UB UCNO UOS VIP WC WH WWP WP WP WP BEIN CORR ENIS KLDY LIV	Underside Universal Column Universal Column Unless Noted Otherwise Universal Column Unless Otherwise Specified Vinyl Vent Pipe Window Water Closet Weep Hole Washing Machine Waste Pipe Water Proof Membrane Water Tank Bedroom Dining Room Corridor Ensuite Kitchen Laundry Living Room
INS J	Insulation (Thermal/ Acoustic) Joinery item	UOS TV	Unless Otherwise Specified Television		
	.,		MARKATAN A		

SCALE NTS

RI DRAFT TB

DA000 B

BASI *Certificate Building Sustainability Index www.basix.nsw.gov.au

Alterations and Additions

Certificate number: A329719_02

NOTES

ISSUE

PRELIMINARY NOT FOR CONSTRUCTION

BASIX Certificate number: A329719_02

Certificate Prepared by (please complete before submitting to Council or PCA) Name / Company Name: Delisle Hunt Wood Pty Ltd ABN (if applicable): 631934837

Separate dwelling house

My renovation work is valued at \$50,000 or more, and includes a pool (and/or spa).

Dwelling type

Type of alteration and addition

Pool and Spa	Show on DA Plans	Show on CC/CDC Plans & specs	Certifie Check
Rainwater tank			
The applicant must install a rainwater tank of at least 1142 litres on the site. This reinwater tank must meet, and be installed in accordance with, the requirements of all applicable regulatory authorities.	1	1	1
The applicant must configure the rainwater tank to collect rainwater runoff from at least 150 aquare metres of roof area.		V	V
The applicant must connect the rathwater tank to a tap located within 10 metree of the edge of the outdoor spa		1	V
Outdoor spa	***		
The spa must not have a capacity greater than 3 kilolitres.	1	1	+ V
The spa must have a spa cover.		1	V
The applicant must install a spa pump timer		4	1
The applicant must install the following heating system for the outdoor spa that is part of this development; electric heat pump		1	1

heads have a flow rate no greater than 9 litres per minute or a 3 star water rating

e applicant must ensure new or attered tollets have a flow rate no greater than 4 litres per average flush or a minimum 3 star water rating

oncrete eleb on ground floor with in-eleb leating system...

BASIX Certificate number: A320719_02

page 4/9

dows and glazed doors following requirements must also be satisfied in relation to each window and glazed door: projections described as a ratio, the ratio of the projection from the wall to the height above the window or glazed door sill must be at a that shown in the table below. \checkmark xternal louvree and blinds must fully shade the window or glazed door baside which they are situated when fully drawn or closed. ershadowing buildings or vegetation must be of the height and distance from the centre and the base of the window and glazed door, as cified in the "overshadowing" column in the table below. ows and glazed doors glazing requirement Improved aluminium, single clear, (U-value 6.44, SHGC: 0.75) improved aluminium, single clear, (U-val. 6.44, SHGC: 0.75)

page 3 / 9

projection/height above elli relio | improved alluminium, single toned, (U-value: 6.39, SHGC: 0.56) | projection/height above slll relio | standard alluminium, single toned, U-value: 7.57, SHGC: 0.57) | U-value: 7.57, SHGC: 0.57) proposition region and proposition of the projection region and projection region re improved aluminium, single clear, (Un 6.44, SHGC: 0.75) improved aluminium, single clear, (U-v. 6.44, SHGC: 0.75) projecto improved aluminium, single pyrotytic (U-value: 4.48, SHGC: 0.46) projector improved aluminium, single py (U-value: 4.45, SHGC: 0.46) improved aluminium, single clea 6.44, SHGC: 0.75) projection/height above sill ratio improved aluminium, single pyrotytic low (U-value: 4.48, SHGC: 0.48) projection/height above sil ratio | Improved attentions, single boxed, (U-value: 6.39, SHGC: 0.56) | Improved attentions, single boxed, (U-value: 6.39, SHGC: 0.56) | Improved attentions, single boxed, (U-value: 6.39, SHGC: 0.56) | Improved attentions, single boxed, (U-value: 6.39, SHGC: 0.56) | Improved attentions, single boxed, (U-value: 6.39, SHGC: 0.56)

BASIX Certificate number: A329719_02

>=6,43
projection/height above sill ratio
>=6.43
projection/height above sill ratio
| (U-value: 6.39, SHGC: 0.56)
| (U-value: 6.39, SHGC: 0.56)
| (U-value: 6.39, SHGC: 0.56)
| (U-value: 6.36, SHGC: 0.56)
| (U-value: W3.10 W3.11 projection >=0.43 projection/height above sill ratio
>>0.43
(U-whate 6.39, SHOZ; 0.56)
projection/height above sill ratio
>>0.23
(U-whate 6.39, SHOZ; 0.56)
projection/height above sill ratio
>>0.23
(U-whate 6.39, SHOZ; 0.56)
projection/height above sill ratio
>>0.43
(U-whate 6.39, SHOZ; 0.56)
projection/height above sill ratio
>>0.43
(U-whate 6.39, SHOZ; 0.56)
(U-whate 6.39, SHOZ; 0.56) W3.15 W3.15 High W3.16 W4.03 improved aluminium, single to (U-value: 6.39, SHI3C: 0.56) Improved shimirshim, single to (U-value: 6.39, SHI3C: 0.56) 1.2 20.2 35.5 projection/height above silt ratio improved sluminium, single (U-value: 4.48, SH3C: 0.46)

BASIX Certificate number A329719 02

							Show on DA Plans	Show on CC/CDC Plans & specs	Cortifie Check	
Window / door no	Orientation	Area of glass Inc Irame	Oversha Height (m)	dowing Distance (m)	Sheding device		Eranter and glund type			
V4.06	E	1.2	0	0	projection/height above still ratio improved attention, single pyrotytic low-s, (U-value; 4.45, 5HGC; 0.46)					
W4.07	E	1.2	Ū	Ü	projection/height above sill ratio		improved aluminium, single pyrolytic low-e, (U-value: 4.48, SHGC: 0.46)			
W4 08	E	1.2	ō	ō	projection/height above still retio >=0.23		improved aluminium, single pyrolytic low-e, (LF-value: 4.48, SHGC: 0.46)			
W3.17	S	5.4	O	0	none		improved aluminium, single clear, (U-value: 6.44, SHGC: 0.75)			
W3.18	S	0.6	0	0	none		improved aluminium, single clear, (U-value: 6.44, SHGC: 0.75)			
lazed roofs								_		
The applicant must install the glazed roofs described in the table below, in accordance with the specifications listed in the table						V	1	1		
The following requirements must also be satisfied in relation to each glazed roof:							1	V		
Glazed roofs	glazing r	equiren	nonts					1		
Claired roof number	Area of c	faring	Shading	demon	G.	Ganayo				
G1	23.5		no shad	ing	improved a 4.48, SHG		Auminium, single pyrolytic low-e, (U-value: C: 0.48)			

itments identified with a "v" in the "Show on DA plans" column must be shown on the plans accompanying the development application for the propo-pment application is to be lodged for the proposed development).

entified with a "," in the "Show on CC/CDC plans & specs" column must be shown in the plans and specifications accompanying the application for a construction lying development certificate for the proposed development.

amilments identified with a "/" in the "Certifier check" column must be certified by a certifying authority as having been fulfilled, before a final occupation certificate for the


1805 RIVERVIEW 3

BASIX CERTIFICATE DA001

smart design studio

NTS

RI DRAFT TB

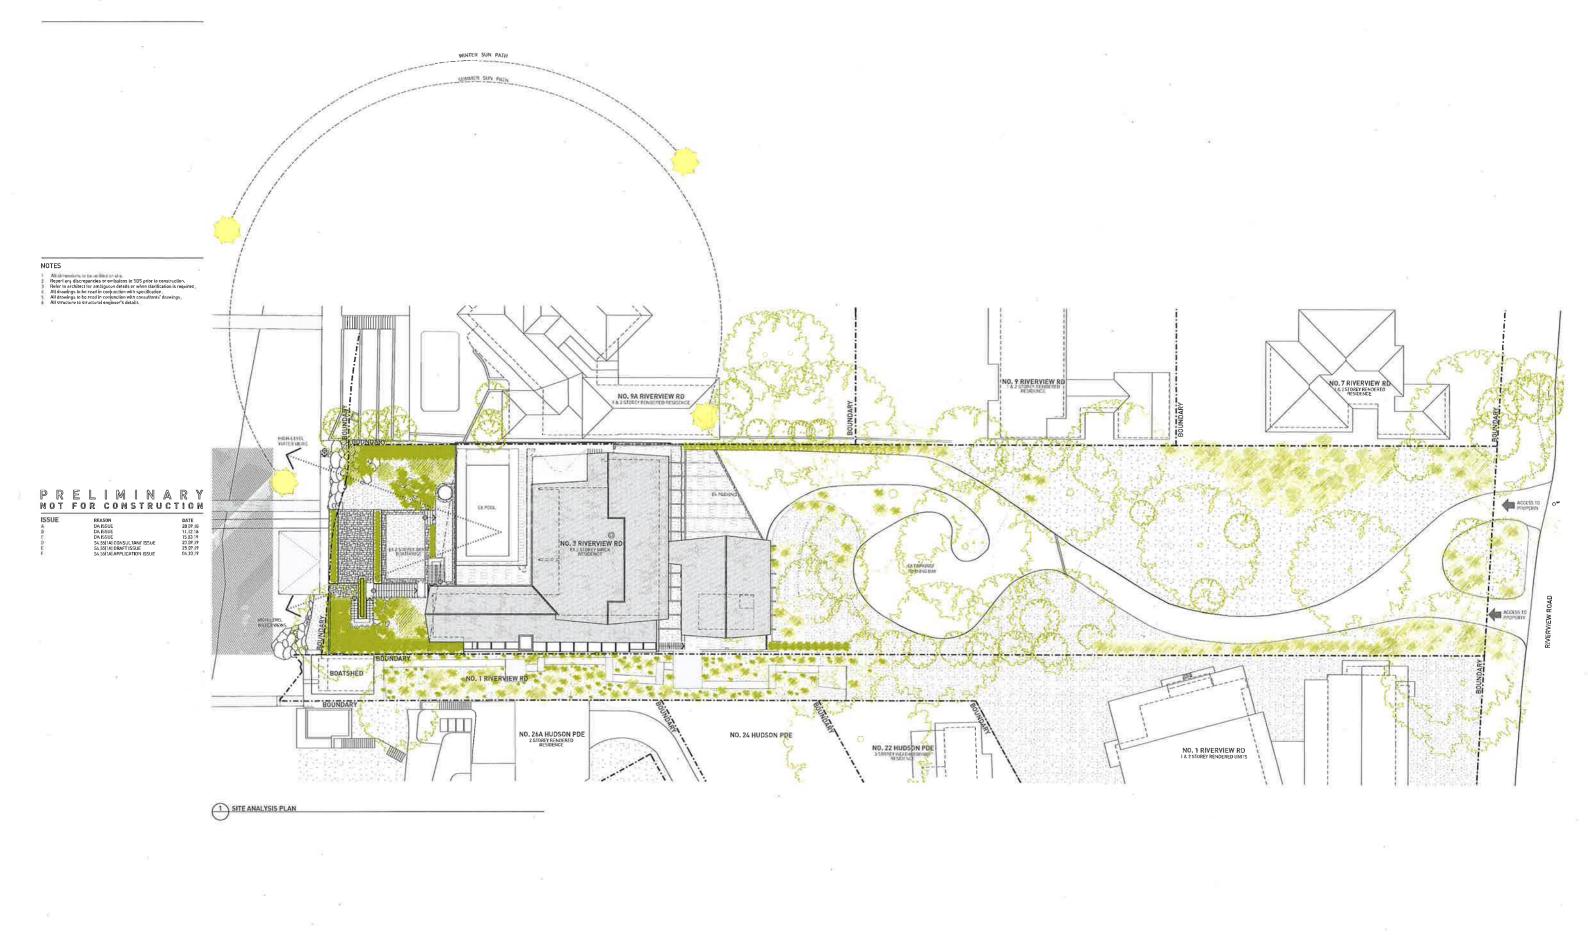

Smart design studio

Sign Boundard Street

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