

# **ACTION PLANS**

### 209 SOUTH CREEK ROAD WHEELER HEIGHTS NSW 2097

m: 0426 957 518

e: operations@actionplans.com.au


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## **DEVELOPMENT APPLICATION**

These plans are for Development Approval only.

SHEET NUMBER	SHEET NAME	DATE PUBLISHED
DA00	COVER	3/12/2019
DA01	SITE ANALYSIS	3/12/2019
DA02	SITE / ROOF / SEDIMENT EROSION / WASTE MANAGEMENT / STORMWATER CONCEPT PLAN	3/12/2019
DA03	EXISTING GROUND FLOOR PLAN	3/12/2019
DA04	EXISTING FIRST FLOOR PLAN	3/12/2019
DA05	PROPOSED GROUND FLOOR PLAN	3/12/2019
DA06	PROPOSED FIRST FLOOR PLAN	3/12/2019
DA07	NORTH / EAST ELEVATION	3/12/2019
DA08	SOUTH / WEST ELEVATION	3/12/2019
DA09	LONG / CROSS SECTION	3/12/2019
DA10	AREA CALCULATIONS	3/12/2019
DA11	SAMPLE BOARD	3/12/2019
DA12	WINTER SOLSTICE 9 AM	3/12/2019
DA13	WINTER SOLSTICE 12 PM	3/12/2019
DA14	WINTER SOLSTICE 3 PM	3/12/2019
DA15	BASIX COMMITMENTS	3/12/2019

ITEM DETAILS	DEVELOPMENT APPLICATION							
ADDRESS	209 South Creek Road, Wheeler Heights NS	W 2097						
LOT & DP/SP	LOT 7 DP 232162							
COUNCIL	NORTHERN BEACHES COUNCIL (WARRING	NORTHERN BEACHES COUNCIL (WARRINGAH)						
SITE AREA	790.40m²							
FRONTAGE	15.240m							
CONTROLS	PERMISSIBLE / REQUIRED	EXISTING	PROPOSED	COMPLIANCE				
	m / m² / %	m / m² / %	m / m² / %					
<u>LEP</u>								
LAND ZONING	R2 – LOW DENSITY RESIDENTIAL	R2	R2	YES				
MINIMUM LOT SIZE	600m²	790.40m²	UNCHANGED	YES				
FLOOR SPACE RATIO	NOT IDENTIFEID	N/A	N/A	N/A				
MAXIMUM BUILDING HEIGHT	8.5m	7.913m	UNCHANGED	YES				
<u>HAZARDS</u>								
DEVELOPMENT ON SLOPING LAND	AREA A: Slopes less than 5 degrees AREA D: Collaroy Plateau Area Flanking slope	es 5-15 degrees		Please read in				
WILDLIFE CORRIDORS	YES IDENTIFEID			conjunction with the Statement of				
LAND ADJOINING PUBLIC OPEN SPACE	YES IDENTIFEID			Environmental Effects				
DCP								
WALL HEIGHT	7.2m	6.459m	UNCHANGED	YES				
NUMBER OF STOREYS	N/A	2	UNCHANGED	N/A				
SIDE BOUNDARY ENVELOPE	4m			YES				
SIDE BOUNDARY SETBACKS	0.9m	N: 1.294m S: 1.105m	UNCHANGED	YES				
FRONT BOUNDARY SETBACK	6.5m	6.643m	UNCHANGED	YES				
REAR BOUNDARY SETBACK	6.0m	29.106m	UNCHANGED	YES				
LANDSCAPE OPEN SPACE	40% (316.16m²)	38.3% (303.13m <sup>2</sup> )	UNCHANGED	NO (existing)				
PRIVATE OPEN SPACE	60m²	108.69m²	116.06m²	YES				

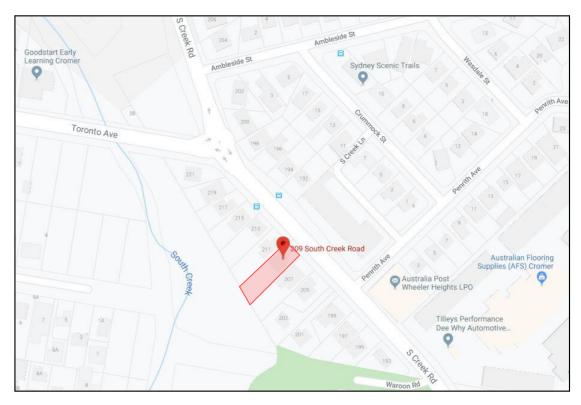


#### **NCC & AS COMPLIANCES SPECIFICATIONS**

- EARTHWORKS: METHOD OF EXCAVATION AND FILL - PART 3.1.1 OF NCC - SURFACE SUBSOIL-STORMWATER DRAINAGE - PART 3.1.2 OF NCC - TERMITE-RISK MANAGEMENT - PART 3.1.3 OF NCC - FOOTINGS & SLAB - PART 3.2 OF NCC INCLUDING AS2870 - MASONRY CONSTRUCTION - PART 3.3 OF NCC INCLUDING AS3700 - SUB FLOOR VENTILATION - PART 3.4.1 OF NCC - FRAMING - PART 3.4 OF NCC - ROOF, WALL-CLADDING, GUTTERS & DOWNPIPES - PART 3.5 OF NCC - GLAZING - PART 3.6 OF NCC INCLUDING AS1288 - FIRE SEPARATION - PART 3.7.1 OF NCC - SMOKE ALARMS - PART 3.7.2 OF NCC - HEATING APPLIANCES - PART 3.7.3 OF NCC - WET AREAS-PROTECTION OF WALLS & FLOORS - PART 3.8.1 OF NCC - MINIMUM ROOF HEIGHTS - PART 3.8.3 OF NCC - FACILITIES REQUIRRED & SANITARY DOOR CONSTRUCTION - PART 3.8.3 OF NCC - LIGHT: NATURAL AND ARTIFICIAL - PART 3.8.4 OF NCC - VENTILATION & LOCATION OF TOILETS - PART 3.8.5 OF NCC - SOUND INSULATION - PART 3.8.6 OF NCC - STAIR CONSTRUCTION INCLUDING DIMENSIONS - PART 3.9.1 OF NCC - BALUSTRADES & OTHER BARRIERS - PART 3.9.2 OF NCC - FENCING & OTHER PROVISIONS - REGS & AS1926 - DEMOLITION WORKS - AS2601-1991 THE DEMOLITION OF STRUCTURES. - ALL WATERPROOF MEMBRANES TO COMPLY WITH WITH AS 3740-2004 - ALL PLUMBING & DRAINAGE WORK TO COMPLY WITH AS 3500 - SITE CLASSIFICATION AS TO AS 2870 - ALL PLASTERBOARD WORK TO COMPLY WITH AS 2588-1998 - ALL STRUCTURAL STEEL WORK TO COMPLY WITH AS 4100 & AS 1554 - ALL CONCRETE WORK TO COMPLY WITH AS 3600 - ALL ROOF SHEETING WORK TO COMPLY WITH AS 1562-1992 - ALL SKYLIGHTS TO COMPLY WITH WITH AS 4285-2007 - ALL CERAMIC TILING TO COMPLY WITH AS 3958.1-2007 & 3958.2-1992 - ALL GLAZING ASSEMBLIES TO COMPLY WITH AS2047 & 1288 - ALL TIMBER RETAINING WALLS ARE TO COMPLY WITH AS 1720.1-2010,


AS 1720.2-2006, AS 1720.4-2006, AS 1170.1-1989 & AS 1170.4-1993

- ALL CONSTRUCTION TO COMPLY TO AS3959- 1991

- ALL RETAINING WALLS ARE TO COMPLY WITH 3700 - 2011 & AS 3600 -2001

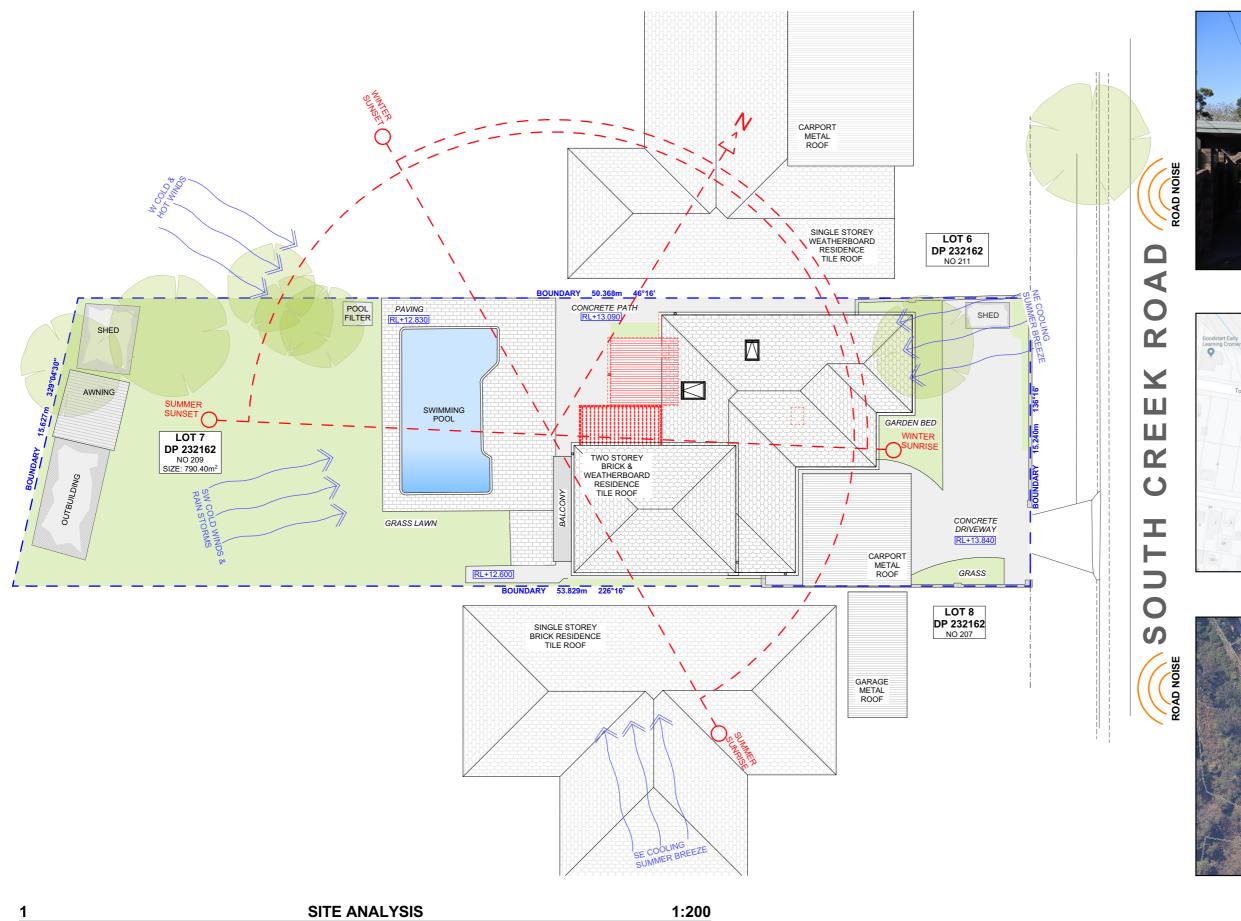



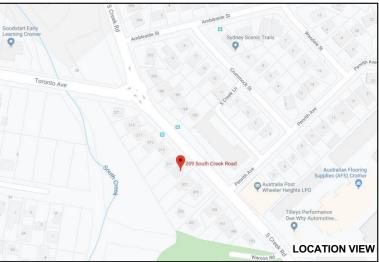



#### NOTE: ALL DEMOLISHED ELEMENTS TO ENG. SPECIFICATIONS AND AS. 2601 - 2001



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С	21.11.19	FINAL DESIGN AMENDMENT	EAS	are to be used only.  The Builder/Contractor shall check and verify all levers.
D	28.11.19	DA 'PROOF READ'	EAS	dimensions on site prior to commencement o creation of shop drawings, or fabrication of com
				All errors and omissions are to be verified Builder/Contractor and referred to the designer price commencement of works.
	A B C	A 01.11.19  B 15.11.19  C 21.11.19	A 01.11.19 INITIAL DESIGN PLAN  B 15.11.19 FIRST DESIGN AMENDMENT  C 21.11.19 FINAL DESIGN AMENDMENT	A         01.11.19         INITIAL DESIGN PLAN         EAS           B         15.11.19         FIRST DESIGN AMENDMENT         RNA           C         21.11.19         FINAL DESIGN AMENDMENT         EAS



 _
SOFT LANDSCAPE
HARD LANDSCAPE
PROPOSED
EXISTING
 DEMOLISHED

**EXISTING** EX. DP. DOWNPIPE PROP. PROPOSED DP. DOWNPIPE

KYLIE & ROB HARRISON

CLIENT


PROJECT ADDRESS 209 SOUTH CREEK ROAD WHEELER HEIGHTS NSW 2097


DRAWING NO. **DA01** 

SITE ANALYSIS DATE

DRAWING NAME

Tuesday, 3 December SCALE 1:200 @A3

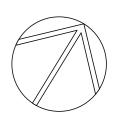

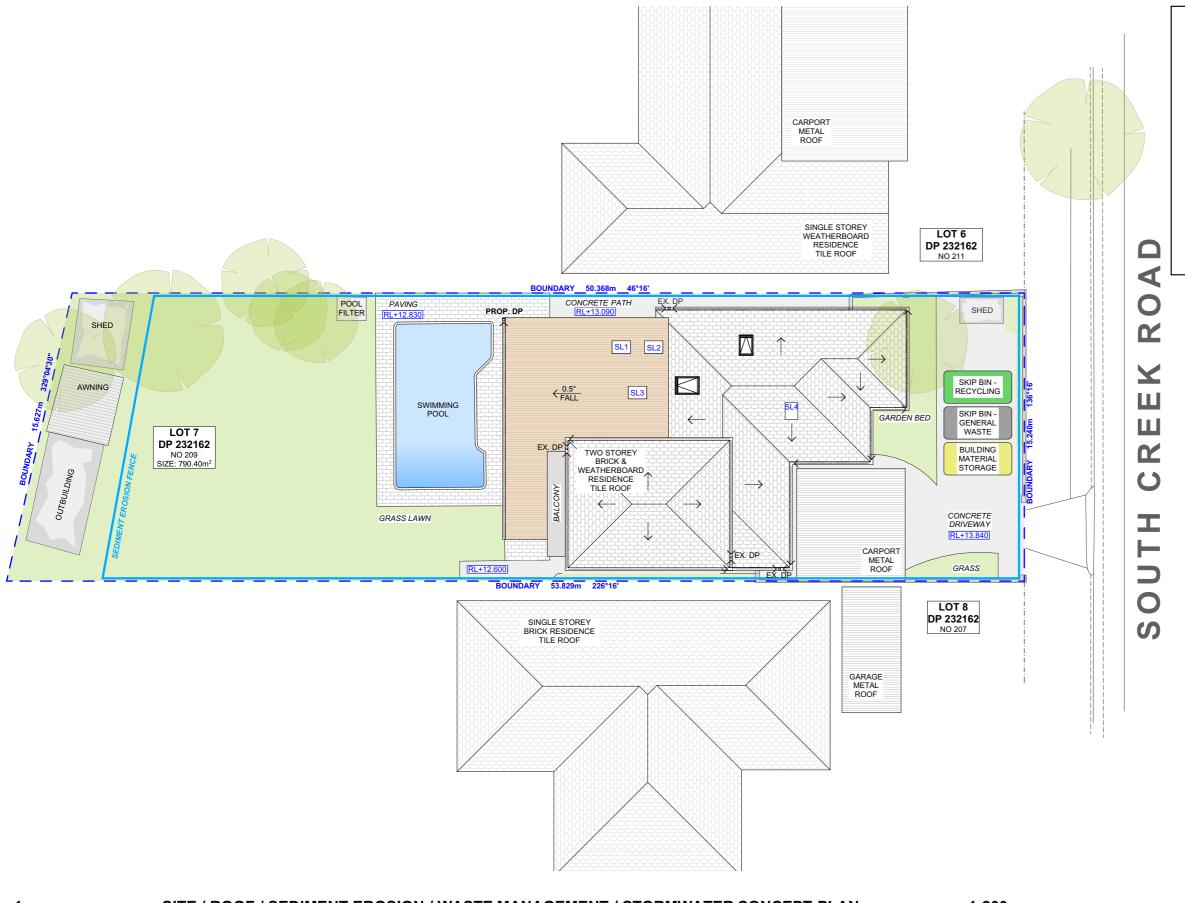

DISTURBED AREA

ORECTON

OSM

NAX

DETAIL OF

OVERLAP

WIRE OR STEEL MESH

(WHERE REQUIRED)

VINDISTURBED

AREA

V

SEDIMENT FENCE

#### DUST CONTROL :

TO REDUCE DUST GENERATED BY WIND ACTION, THE REMOVAL OF THE TOP SOIL IS TO BE MINIMISED. TO PREVENT DUST GENERATION, WATERING DOWN OF THE SITE, ESPECIALLY DURING THE MOVEMENT OF MACHINERY IS REQUIRED. WHERE EXCAVATING INTO ROCK, KEEP THE SURFACE MOIST TO MINIMISE DUST. CONSTRUCT A GRAVEL ENTRY/EXIT POINT USING BLUE METAL AND RESTRICT ALL VEHICLE MOVEMENTS WITHIN THE SITE TO A MINIMUM. ENSURE WIND BREAKS, SUCH AS EXISTING FENCES ARE MAINTAINED DURING THE CONSTRUCTION PHASE UNTIL NEW LANDSCAPING IS PROVIDED OR REINSTATED. PREVENT DUST BY COVERING STOCKPILES

#### **SEDIMENT NOTE:**

1. ALL EROSION AND SEDIMENT CONTROL MEASURES TO BE INSPECTED AND MAINTAINED DAILY BY THE SITE MANAGER.

2. MINIMISE DISTURBED AREAS, REMOVE EXCESS SOIL FROM EXCAVATED AREA AS SOON AS POSSIBLE.
3. ALL MATERIAL STOCKPILE TO BE CLEAR FROM DRAINS, GUTTERS AND FOOTPATHS, OR WITHIN SEDIMENT FENCE AREA.

4. DRAINAGE TO BE CONNECTED TO STORMWATER AS SOON AS POSSIBLE. IF STORED ON SITE, IT MUST BE FILTERED BEFORE RELEASING INTO STORMWATER SYSTEM OR WATERWAYS.

5. ROADS AND FOOTPATHS TO BE SWEPT DAILY.

#### STOCKPILES:

ALL STOCKPILES ARE TO BE KEPT ON-SITE WHERE POSSIBLE. ANY MATERIALS PLACED ON THE FOOTPATHS OR NATURE STRIPS REQUIRE COUNCIL'S PERMISSION

ALL STOCKPILES ARE TO BE PLACED AWAY FROM THE DRAINAGE LINES AND STREET GUTTERS. IT IS BEST TO LOCATE THESE ON THE HIGHEST PART OF THE SITE IF POSSIBLE. PLACE WATERPROOF COVERING OVER STOCKPILES.

IF REQUIRED PROVIDE DIVERSION DRAIN & BANK AROUND STOCKPILES.

#### **GUTTER PROTECTION:**

PROVIDE PROTECTION TO DOWNHILL GRATE IN GUTTER BY MEANS OF SAND BAGS OR BLUE METAL WRAPPED IN GEOTEXTILE FABRIC. WHEN SOIL OR SAND BUILDS UP AROUND THIS SEDIMENT BARRIER, THE MATERIAL SHOULD BE RELOCATED BACK TO THE SITE FOR DISPOSAL.

NOTE: ALL PROPOSED STORMWATER TO CONNECT WITH EXISTING


SITE / ROOF / SEDIMENT EROSION / WASTE MANAGEMENT / STORMWATER CONCEPT PLAN

1:200

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A 01.11.19	INITIAL DESIGN PLAN	EAS	altered, reproduce means in part or
B 15.11.19 FIR	ST DESIGN AMENDMENT	RNA	Action Plans.  Do not scale mea
-	IAL DESIGN AMENDMENT	EAS	are to be used on The Builder/Contr
.au D 28.11.19	DA 'PROOF READ'	EAS	dimensions on si creation of shop d
			All errors and Builder/Contractor



Action Plans.

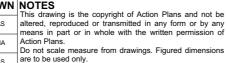Do not scale measure from drawings. Figured dimensions are to be used only.

The Builder/Contractor shall check and verify all levels and dimensions on site prior to commencement of any work, creation of shop drawings, or fabrication of components.

All errors and omissions are to be verified by the Builder/Contractor and referred to the designer prior to the commencement of works.



**LEGEND** 

EX. EXISTING
DP. DOWNPIPE
PROP. PROPOSED
DP. DOWNPIPE

# CLIENT KYLIE & ROB HARRISON

#### PROJECT ADDRESS 209 SOUTH CREEK ROAD WHEELER

HEIGHTS NSW 2097

DA02

DRAWING NO.

# DATE

Tuesday, 3 December


#### DRAWING NAME

SITE / ROOF / SEDIMENT EROSION / WASTE MANAGEMENT / STORMWATER CONCEPT PLAN

#### SCALE

1:200 @A3



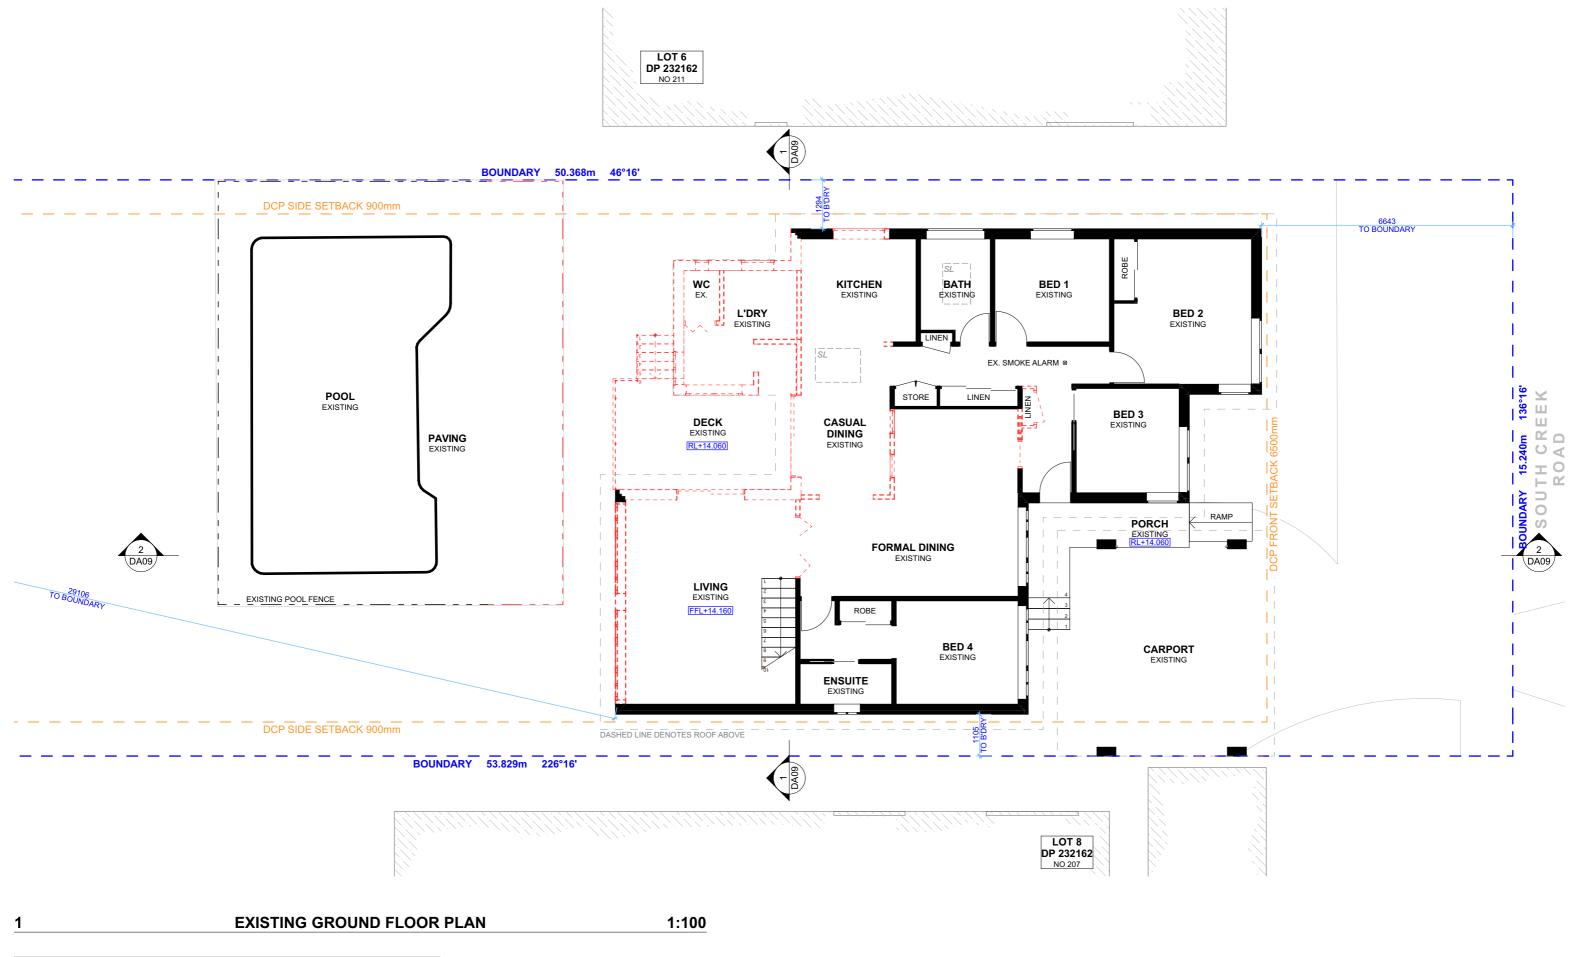


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commencement of works.



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DRAWING NO. **DA03** 

2019

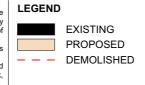
Tuesday, 3 December

EXISTING GROUND FLOOR PLAN DATE

DRAWING NAME

SCALE 1:100 @A3



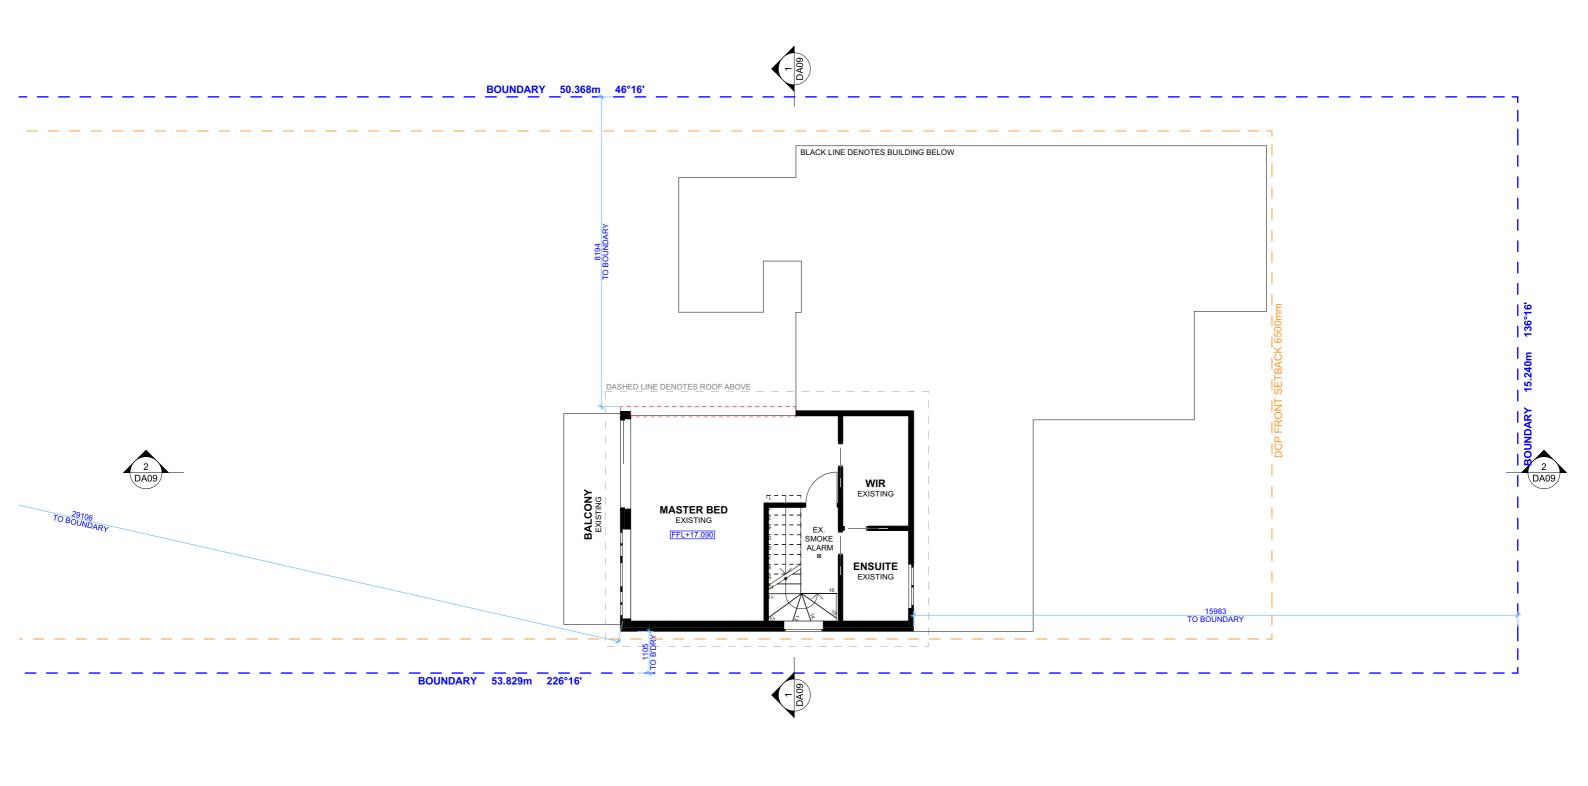

EXISTING FIRST FLOOR LEVEL

1:100

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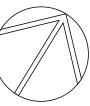
DA04 EXISTING FIRST FLOOR PLAN


SCALE

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Tuesday, 3 December 2019

DRAWING NAME



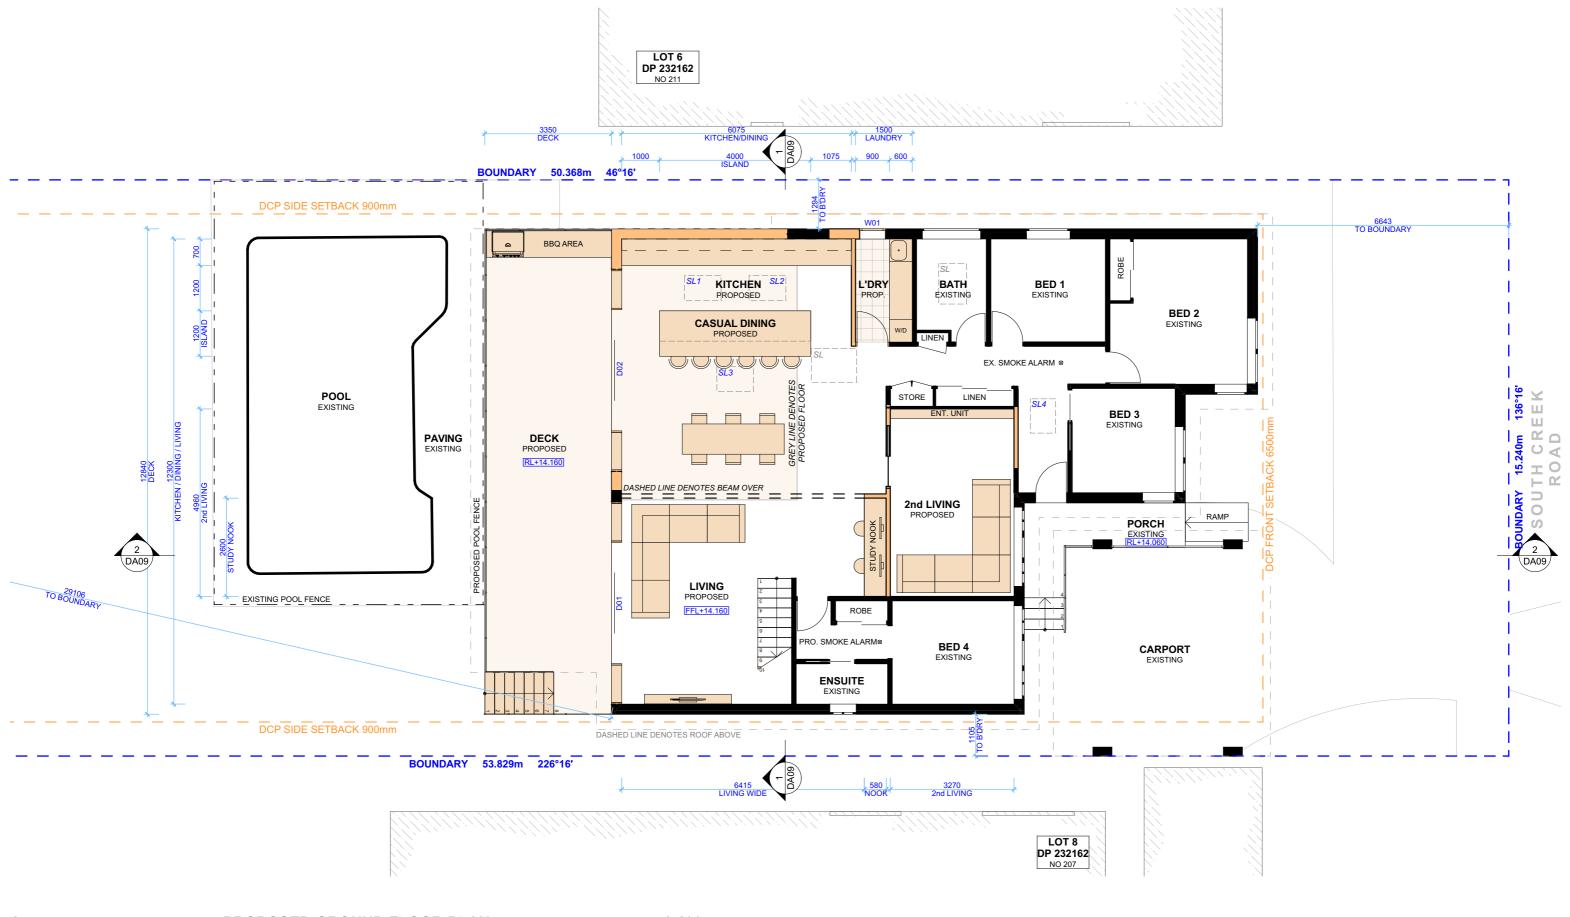


PROPOSED GROUND FLOOR PLAN 1:100



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DRAWING NO. **DA05** 


2019

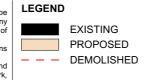PROPOSED GROUND FLOOR PLAN DATE

DRAWING NAME

Tuesday, 3 December SCALE 1:100 @A3




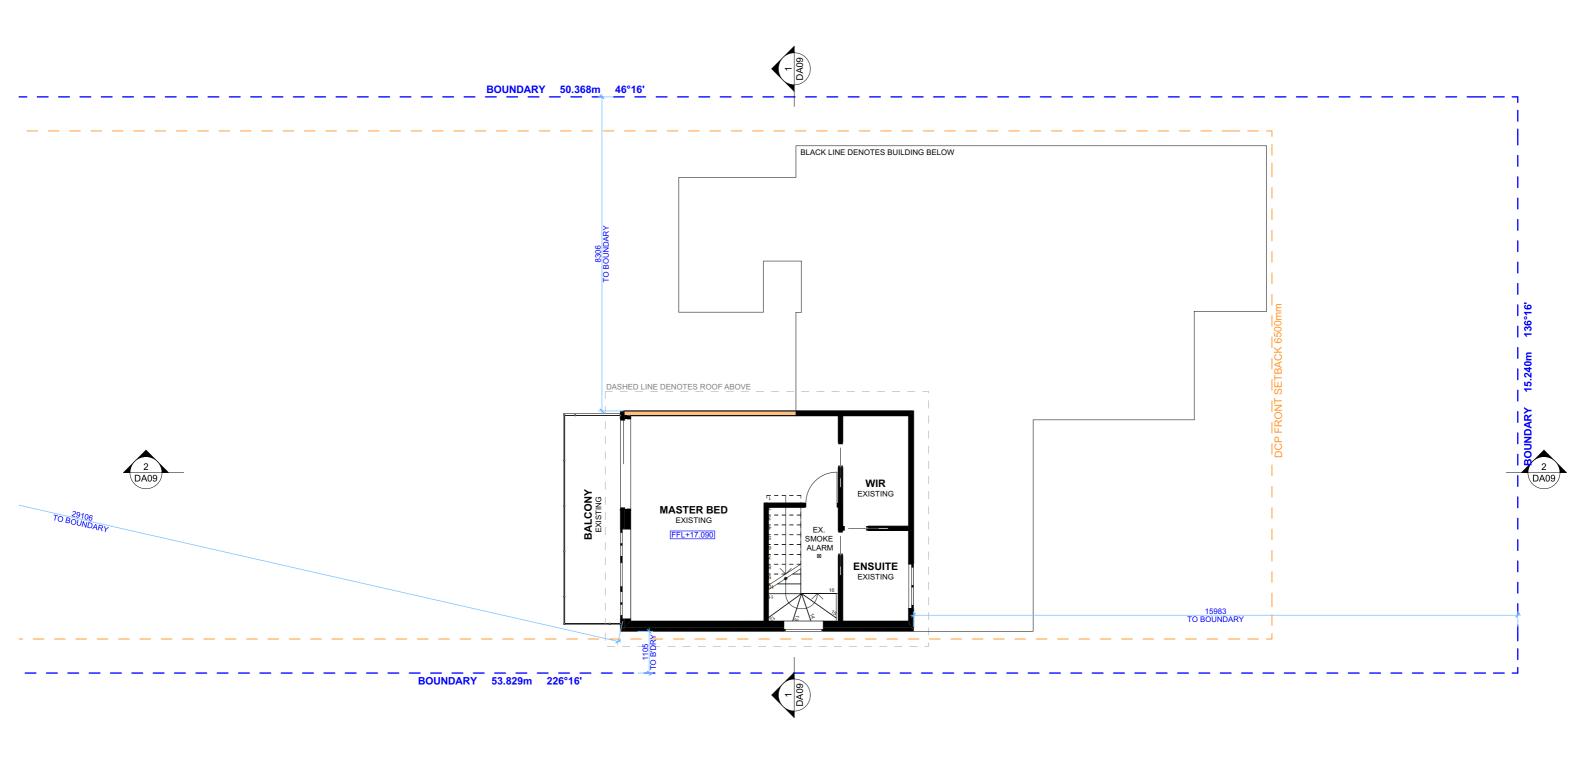

1:100 PROPOSED FIRST FLOOR LEVEL



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**DA06** 

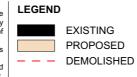
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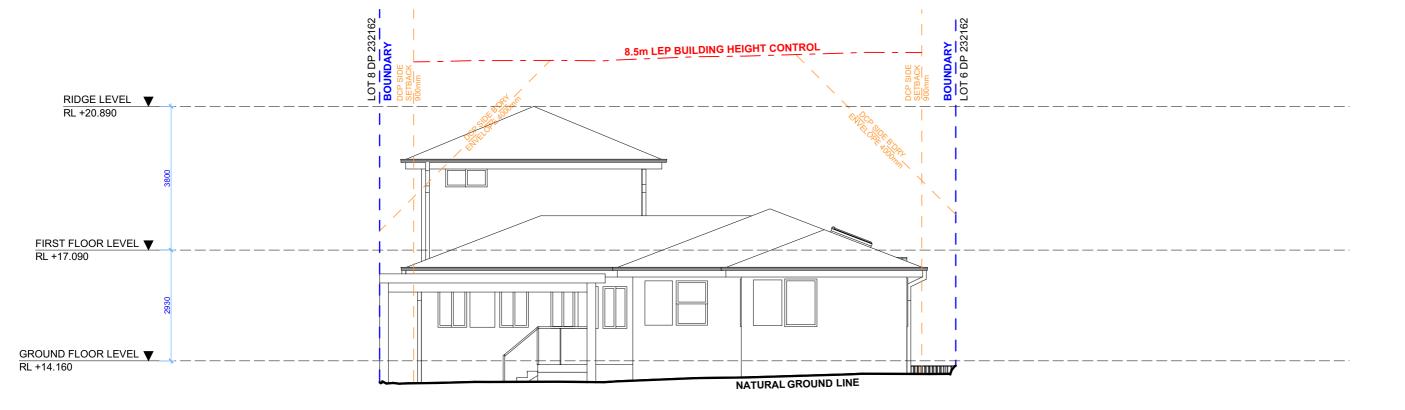
PROPOSED FIRST FLOOR PLAN DATE


Tuesday, 3 December 2019

SCALE 1:100 @A3

DRAWING NAME



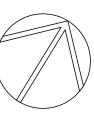

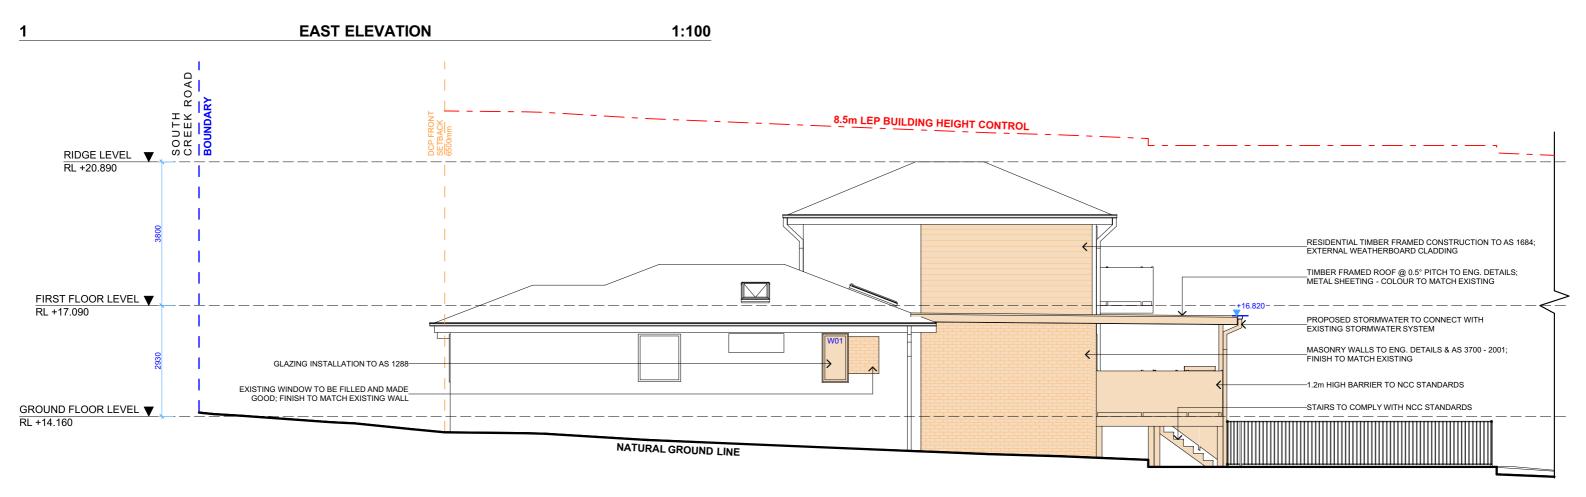


NORTH ELEVATION 1:100




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DRAWING NO.	DRAWING NAME
DA07	NORTH / EAST ELEVATION
DATE	
Tuesday, 3 December	SCALE
2019	1:100 @A3
	DA07





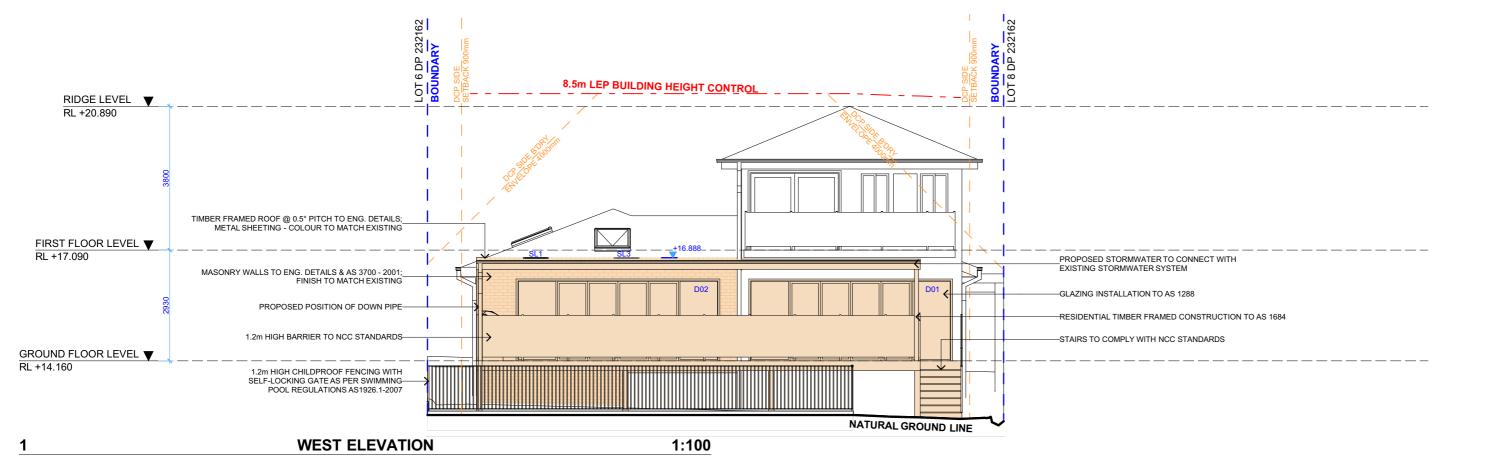
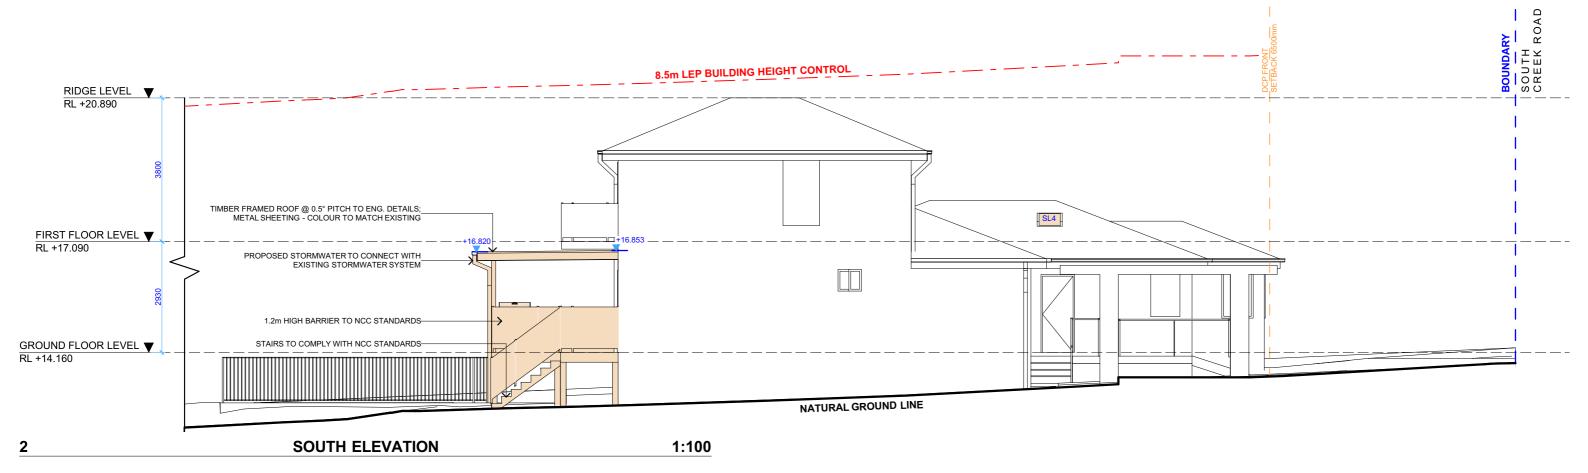
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COMMENTS

REV. DATE

DRWN

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ACTION FIGURE.
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CLIENT KYLIE & ROB HARRISON

PROJECT ADDRESS 209 SOUTH CREEK ROAD WHEELER HEIGHTS NSW 2097 DA08


SOUTH / WEST ELEVATION


**DATE**Tuesday, 3 December 2019

SCALE

DRAWING NAME

1:100 @A3

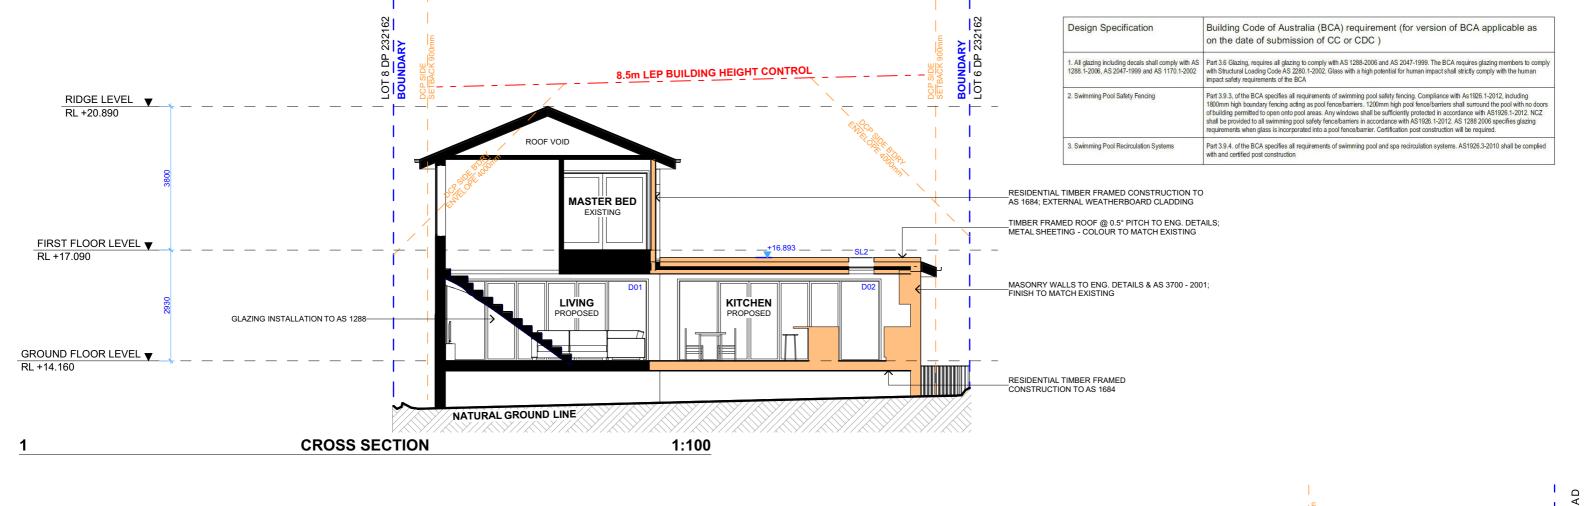

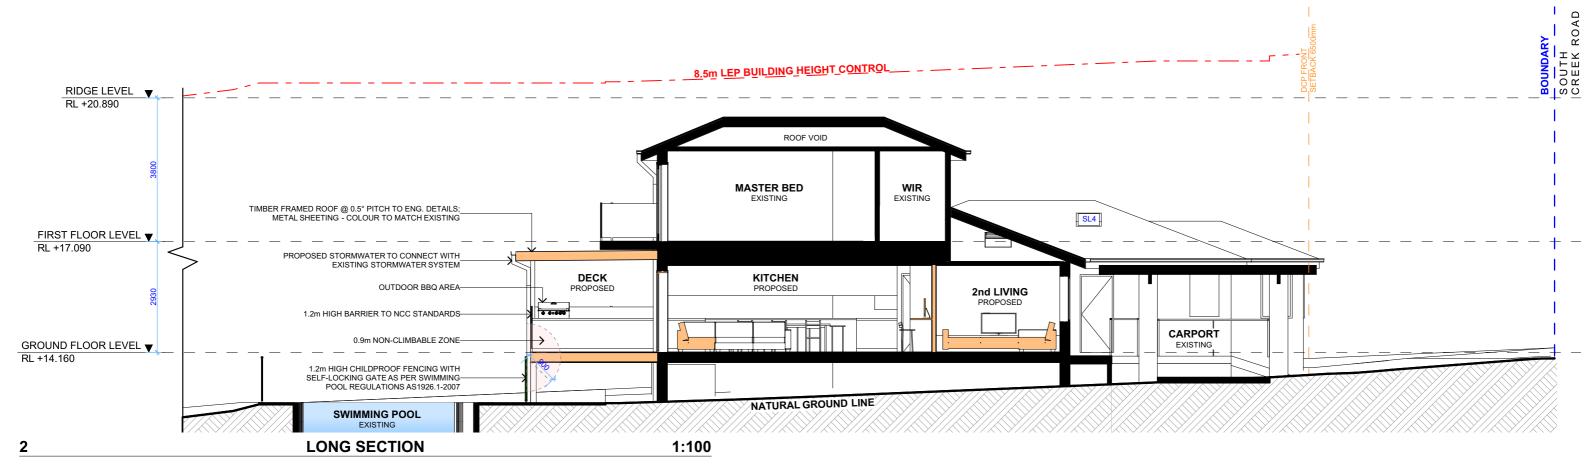




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CLIENT	DRAWING NO.	DRAWING NAME
KYLIE & ROB HARRISON	DA09	LONG / CROSS SECTION
PROJECT ADDRESS	DATE	
209 SOUTH CREEK	Tuesday, 3 December	SCALE
ROAD WHEELER HEIGHTS NSW 2097	2019	1:100 @A3



1:200

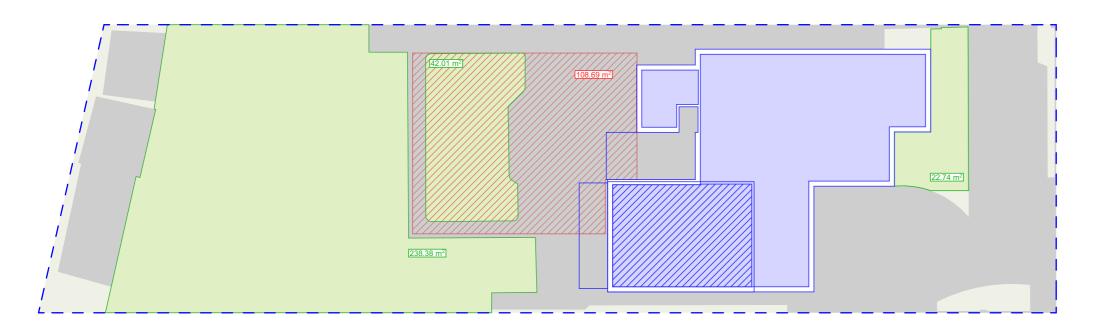
**CONTROL TABLE** SITE AREA: 790.40m<sup>2</sup> PROPOSED REQUIRED **EXISTING** LANDSCAPED OPEN SPACE 40% (316.16m²) 38.3% (303.13m<sup>2</sup>) UNCHANGED PRIVATE OPEN SPACE 60m<sup>2</sup> 108.69m<sup>2</sup> 116.06m<sup>2</sup> IMPERVIOUS AREA N/A N/A N/A HARD SURFACE AREA N/A N/A N/A

N/A

N/A

N/A

**AREA CALCULATIONS EXISTING** 

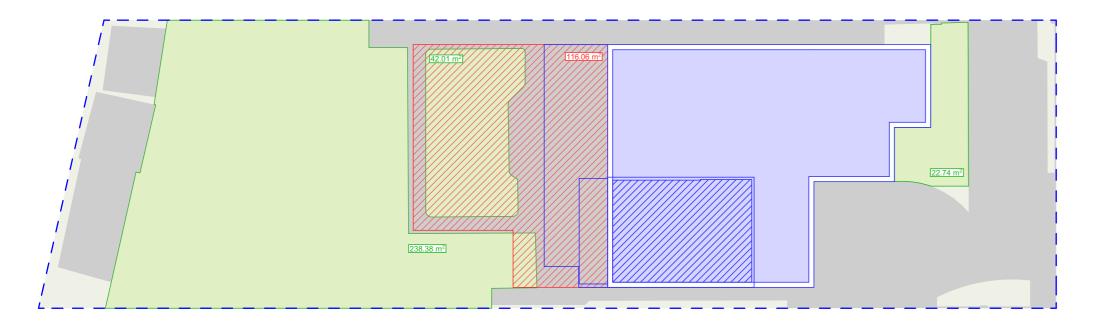

**AREA CALCULATIONS PROPOSED** 1:200



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LEGEND

CLIENT KYLIE & ROB HARRISON

PROJECT ADDRESS 209 SOUTH CREEK ROAD WHEELER HEIGHTS NSW 2097

**DA10** 

DRAWING NO.

FLOOR AREA

AREA CALCULATIONS


DATE

Tuesday, 3 December 2019

**SCALE** 1:200 @A3

DRAWING NAME



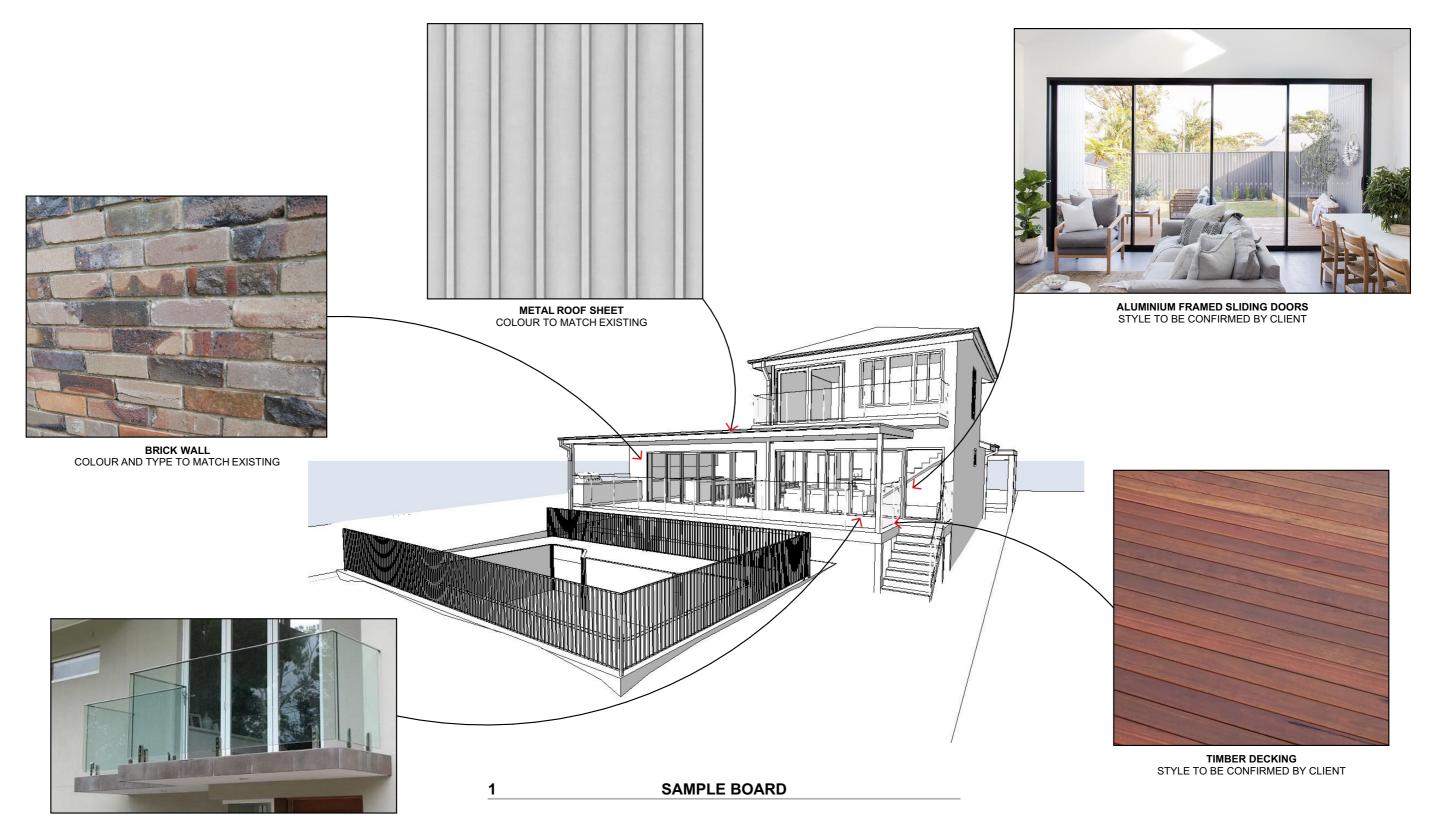

GLASS HANDRAIL STYLE TO BE CONFIRMED BY CLIENT

**ACTION PLANS** 

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	REV.	DATE	COMMENTS	DRWN
	А	01.11.19	INITIAL DESIGN PLAN	EAS
	В	15.11.19	FIRST DESIGN AMENDMENT	RNA
	С	21.11.19	FINAL DESIGN AMENDMENT	EAS
1	D	28.11.19	DA 'PROOF READ'	EAS

LEGEND

PROJECT ADDRESS 209 SOUTH CREEK ROAD WHEELER HEIGHTS NSW 2097

CLIENT

KYLIE & ROB HARRISON

DRAWING NO.


DRAWING NAME SAMPLE BOARD **DA11** 

DATE

Tuesday, 3 December 2019

SCALE


@A3

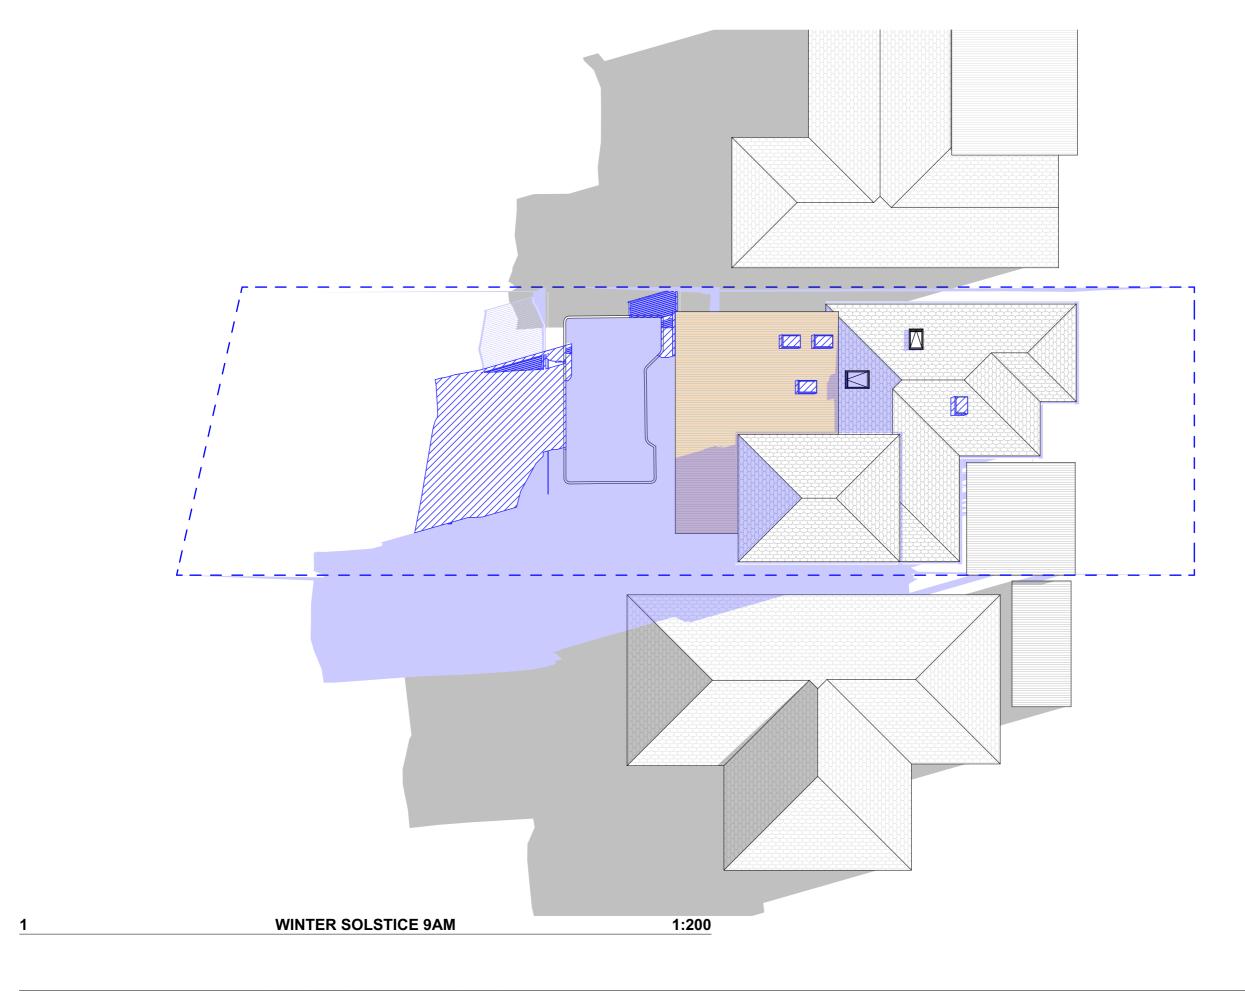



m: 0426 957 518 e:operations@actionplans.com.au w: www.actionplans.com.au

REV.	DATE	COMMENTS	DRWN	NOTES This draw
А	01.11.19	INITIAL DESIGN PLAN	EAS	altered, re
В	15.11.19	FIRST DESIGN AMENDMENT	RNA	Action Pla
С	21.11.19	FINAL DESIGN AMENDMENT	EAS	are to be to
D	28.11.19	DA 'PROOF READ'	EAS	dimension creation of
				All errors Builder/Co

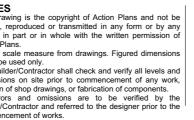



LEGEND EXISTING SHADOWS PROPOSED SHADOWS NEIGHBOURING SHADOWS CLIENT

KYLIE & ROB HARRISON

PROJECT ADDRESS 209 SOUTH CREEK ROAD WHEELER HEIGHTS NSW 2097


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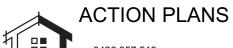
**DA12** 

DATE Tuesday, 3 December 2019 DRAWING NAME WINTER SOLSTICE 9 AM

SCALE 1:200 @A3






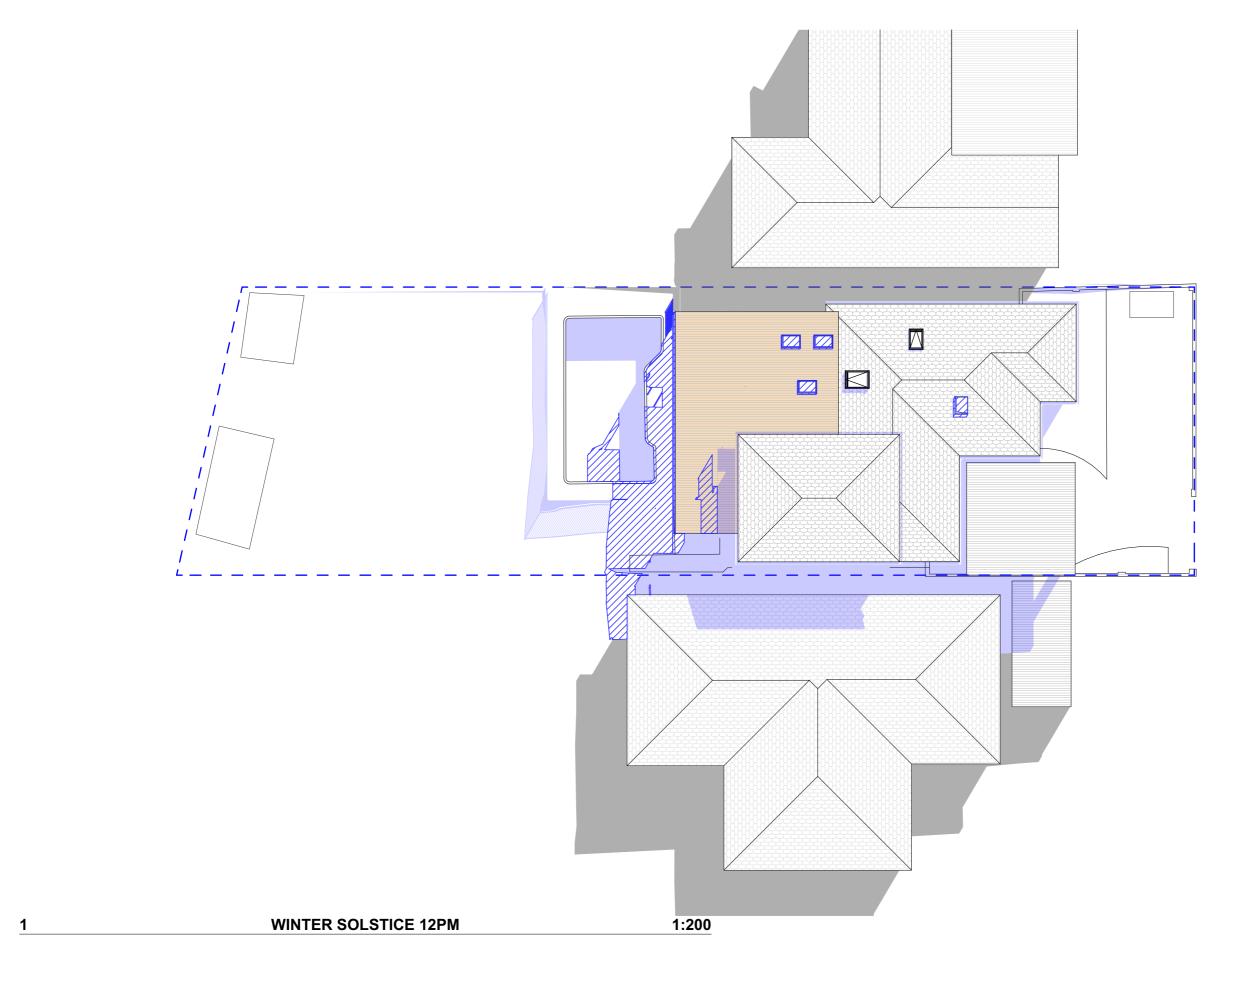

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REV.	DATE	COMMENTS	DRWN	NOTE This dr
Α	01.11.19	INITIAL DESIGN PLAN	EAS	altered
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С	21.11.19	FINAL DESIGN AMENDMENT	EAS	are to b
D	28.11.19	DA 'PROOF READ'	EAS	dimens
				All err Builder

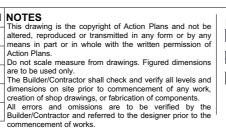

LEGEND

EXISTING SHADOWS PROPOSED SHADOWS NEIGHBOURING SHADOWS

### CLIENT

KYLIE & ROB HARRISON

# PROJECT ADDRESS

209 SOUTH CREEK ROAD WHEELER HEIGHTS NSW 2097

### DRAWING NO.

WINTER SOLSTICE 12 PM **DA13** 


#### DATE

Tuesday, 3 December 2019

# DRAWING NAME

SCALE 1:200 @A3




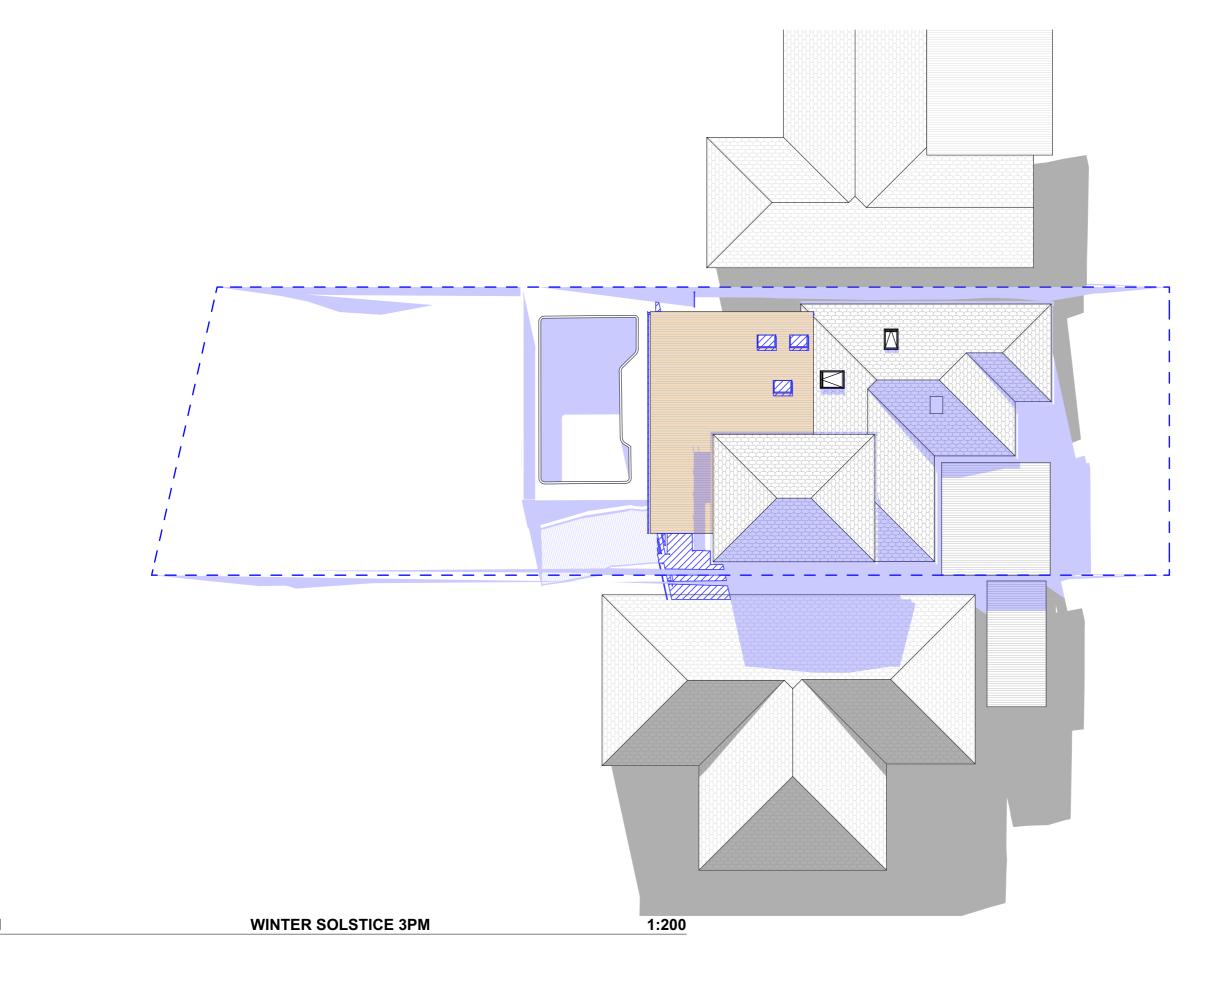



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	REV.	DATE	COMMENTS	DRWN	NOTES This drawing is the copyrig
	Α	01.11.19	INITIAL DESIGN PLAN	EAS	altered, reproduced or tran
	В	15.11.19	FIRST DESIGN AMENDMENT	RNA	Action Plans.  Do not scale measure from
	С	21.11.19	FINAL DESIGN AMENDMENT	EAS	are to be used only. The Builder/Contractor shall
u	D	28.11.19	DA 'PROOF READ'	EAS	dimensions on site prior to creation of shop drawings, o
					All errors and omissions Builder/Contractor and refer commencement of works.



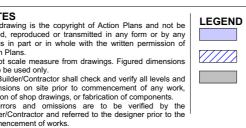

CLIENT

KYLIE & ROB HARRISON

PROJECT ADDRESS 209 SOUTH CREEK ROAD WHEELER HEIGHTS NSW 2097 DRAWING NO.

**DA14** 

DATE
Tuesday, 3 December SCALE
2019

DRAWING NAME
WINTER SOLSTICE 3 PM

SCALE 1:200 @A3



Building Sustainability Index www.basix.nsw.gov.au

#### **Alterations and Additions**

Certificate number: A365060

This certificate confirms that the proposed development will meet the NSW government's requirements for sustainability, if it is built in accordance with the commitments set out below. Terms used in this certificate, or in the commitments. have the meaning given by the document entitled "BASIX Alterations and Additions Definitions" dated 06/10/2017 published by the Department. This document is available at www.basix.nsw.gov.au

#### Secretary

Date of issue: Wednesday, 27, November 2019
To be valid, this certificate must be lodged within 3 months of the date of issue.



Project address				
Project name	209 South Creek Road			
Street address	209 South Creek Road Wheeler Heights 2097			
Local Government Area	Northern Beaches Council			
Plan type and number	Deposited Plan 232162			
Lot number	7			
Section number				
Project type				
Dwelling type	Separate dwelling house			
Type of alteration and addition	My renovation work is valued at \$50,000 or mo and does not include a pool (and/or spa).			

Certificate Prepared by (please complete before submitting to Council or PCA)
Name / Company Name: Action Plans
ABN (if applicable): 17118297587

Fixtures and systems	Show on DA Plans	Show on CC/CDC Plans & specs	Certifier Check
Lighting			
The applicant must ensure a minimum of 40% of new or altered light fixtures are fitted with fluorescent, compact fluorescent, or light-emitting-diode (LED) lamps.		<b>~</b>	<b>✓</b>
Fixtures	•		
The applicant must ensure new or altered showerheads have a flow rate no greater than 9 litres per minute or a 3 star water rating.		<b>✓</b>	<b>✓</b>
The applicant must ensure new or altered toilets have a flow rate no greater than 4 litres per average flush or a minimum 3 star water rating.		✓	✓
The applicant must ensure new or altered taps have a flow rate no greater than 9 litres per minute or minimum 3 star water rating.		✓	

Construction			Show on DA Plans	Show on CC/CDC Plans & specs	Certifier Check
nsulation requirements					
The applicant must construct the new or altered construction (floor(s), walls, and ceilings/roofs) in accordance with the specifications listed in the table below, except that a) additional insulation is not required where the area of new construction is less than 2m2, b) insulation specified is not required for parts of altered construction where insulation already exists.					<b>V</b>
Construction	Additional insulation required (R-value)	Other specifications			
suspended floor with open subfloor: framed (R0.7).	R0.8 (down) (or R1.50 including construction)				
suspended floor with enclosed subfloor: framed (R0.7).	R0.60 (down) (or R1.30 including construction)				
external wall: brick veneer	R1.16 (or R1.70 including construction)				
flat ceiling, pitched roof	ceiling: R3.00 (up), roof: foil/sarking	medium (solar absorptance 0.475 - 0.70)			

Glazing requ	uirements						Show on DA Plans	Show on CC/CDC Plans & specs	Certifier Check
Windows and	d glazed do	ors							
					hading devices, in accordance with reach window and glazed door.	the specifications listed in the table below.	<b>~</b>	<b>~</b>	<b>~</b>
The following requirements must also be satisfied in relation to each window and glazed door:					✓	✓			
Each window or glazed door with standard aluminium or timber frames and single clear or toned glass may either match the description, or, have a U-value and a Solar Heat Gain Coefficient (SHGC) no greater than that listed in the table below. Total system U-values and SHGCs must be calculated in accordance with National Fenestration Rating Council (NFRC) conditions.					<b>✓</b>	<b>✓</b>			
For projections described in millimetres, the leading edge of each eave, pergola, verandah, balcony or awning must be no more than 500 mm above the head of the window or glazed door and no more than 2400 mm above the sill.				<b>✓</b>	<b>✓</b>	<b>✓</b>			
Pergolas with polycarbonate roof or similar translucent material must have a shading coefficient of less than 0.35.					~	<b>~</b>			
Pergolas with fixed battens must have battens parallel to the window or glazed door above which they are situated, unless the pergola also shades a perpendicular window. The spacing between battens must not be more than 50 mm.						<b>✓</b>	<b>✓</b>		
Windows and glazed doors glazing requirements  Window / door Orientation Area of Overshadowing Shading device Frame and glass type									
no.	Onentation	Area of glass inc. frame (m2)	Height (m)	Distance (m)	Shading device	Frame and glass type			
W1	N	0.917	0	0	eave/verandah/pergola/balcony >=450 mm	standard aluminium, single clear, (or U-value: 7.63, SHGC: 0.75)			
D1	W	11.45	0	0	eave/verandah/pergola/balcony >=900 mm	standard aluminium, single clear, (or U-value: 7.63, SHGC: 0.75)			
	W	11.45	0	0	eave/verandah/pergola/balcony >=900 mm	standard aluminium, single clear, (or U-value: 7.63. SHGC: 0.75)			
D2					2-000 IIIIII	0-value. 7.00, 51100. 0.73)			
D2 Skylights					7-555 11111	0-value. 7.00, 01100. 0.73)			

Glazing require	ements			Show on DA Plans	Show on CC/CDC Plans & specs	Certifier Check
The following requ	uirements must also	be satisfied in relation to each skylight:			<b>✓</b>	✓
Each skylight may either match the description, or, have a U-value and a Solar Heat Gain Coefficient (SHGC) no greater than that listed in the table below.					<b>✓</b>	<b>✓</b>
External awnings	and louvres must f	ully shade the skylight above which they a	re situated when fully drawn or closed.		<b>✓</b>	<b>~</b>
Skylights glaz	ing requiremen	nts				
Skylight number	Area of glazing inc. frame (m2)	Shading device	Frame and glass type			
S1	0.645	no shading	aluminium, moulded plastic single clear, (or U-value: 6.21, SHGC: 0.808)			
S2	0.645	external adjustable awning or blind	aluminium, moulded plastic single clear, (or U-value: 6.21, SHGC: 0.808)			
S3	0.645	external adjustable awning or blind	aluminium, moulded plastic single clear, (or U-value: 6.21, SHGC: 0.808)			
S4	0.645	external adjustable awning or blind	aluminium, moulded plastic single clear, (or U-value: 6.21, SHGC: 0.808)			

In these commitments, "applicant" means the person carrying out the development.

Commitments identified with a "v" in the "Show on DA plans" column must be shown on the plans accompanying the development application for the proposed development (if a development application is to be lodged for the proposed development).

Commitments identified with a "v" in the "Show on CC/CDC plans & specs" column must be shown in the plans and specifications accompanying the application for a construction certificate / complying development certificate for the proposed development.

Commitments identified with a "v" in the "Certifier check" column must be certified by a certifying authority as having been fulfilled, before a final occupation certificate for the development may be issued.



	REV.	DATE	COMMENTS	DRW
	А	01.11.19	INITIAL DESIGN PLAN	EAS
	В	15.11.19	FIRST DESIGN AMENDMENT	RNA
	С	21.11.19	FINAL DESIGN AMENDMENT	EAS
1	D	28.11.19	DA 'PROOF READ'	EAS

	NOTES	CLIENT
_	This drawing is the copyright of Action Plans and not be altered, reproduced or transmitted in any form or by any means in part or in	CLIENT
	whole with the written permission of Action Plans.	1/// IE 0 E
_	Do not scale measure from drawings. Figured dimensions are to be used only.	KYLIE & F
	The Builder/Contractor shall check and verify all levels and dimensions on site prior to commencement of any work, creation of shop	HARRISO
	drawings, or fabrication of components.	
	All errors and omissions are to be verified by the Builder/Contractor and referred to the designer prior to the commencement of works.	
	All window & door dimensions, orientation, glazing materials, opening types, frame types are to be confirmed by a suitably qualified	PROJEC1
	person prior to the ordering of any such materials are to take place.	
	U value takes precedence over glazing type/colour in all cases.	209 SOUT
	all new glazing must meet the BASIX specified frame and glass type, <u>OR</u> meet the ecified U value and SHGC value.	ROAD WE

PROJECT ADDRESS 209 SOUTH CREEK ROAD WHEELER HEIGHTS NSW 2097

KYLIE & ROB

HARRISON

DRAWING NO. **DA15** 

BASIX COMMITMENTS

DRAWING NAME

DATE Tuesday, 3 December 2019