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DEVELOPMENT APPLICATION

THESE PLANS ARE FOR DEVELOPMENT APPROVAL ONLY.

ITEM DETAILS	DEVELOPMENT APPLICATION					
ADDRESS	174 WOORARRA AVENUE, ELAN	174 WOORARRA AVENUE, ELANORA HEIGHTS NSW 2101				
LOT & DP/SP	LOT 1 DP 514777	LOT 1 DP 514777				
COUNCIL	NORTHERN BEACHES COUNCIL	(PITTWATER)				
SITE AREA	645m²					
FRONTAGE	19.2m					
CONTROLS	PERMISSIBLE / REQUIRED	EXISTING	PROPOSED	COMPLIANCE		
CONTROLS	m/m²/%	m/m²/%	m/m²/%			
LEP						
LAND ZONING	E4 – ENVIRONMENTAL LIVING	E4	E4	YES		
MINIMUM LOT SIZE	550m ²	645m²	UNCHANGED	YES		
FLOOR SPACE RATIO	NOT IDENTIFIED	N/A	N/A	N/A		
MAXIMUM BUILDING HEIGHT	8.5m	6.9m	UNCHANGED	YES		
<u>HAZARDS</u>						
ACID SULFATE SOILS	CLASS 5	N/A	N/A	N/A		
BIODIVERSITY	IDENTIFIED	N/A	N/A	N/A		
BUSHFIRE PRONE LAND	VEGETATION CATEGORY 1	N/A	N/A	N/A		
GEOTECHNICAL HAZARD H1/H2	H1	N/A	N/A	N/A		
SEPP COASTAL MANAGEMENT	IDENTIFIED	N/A	N/A	N/A		
<u>DCP</u>						
SIDE BOUNDARY ENVELOPE	3.5m	N/A	N/A	YES		
CIDE DOUNDARY CETDACKS	W: 2.5m	W: 1.272m	W: UNCHANGED	NO		
SIDE BOUNDARY SETBACKS	E: 1m	E: 0.913m	E: UNCHANGED	NO		
FRONT BOUNDARY SETBACK	6.5m	7.045m	UNCHANGED	YES		
REAR BOUNDARY SETBACK	6.5m	20.075m	UNCHANGED	YES		
LANDSCAPE OPEN SPACE	AREA 1 60% (387m²)	50% (334.54m²)	48% (309.97m²)	NO		
PRIVATE OPEN SPACE	80m²	89m²	UNCHANGED	YES		

SHEET NUMBER	SHEET NAME	DATE PUBLISHED
DA00	COVER	15/09/2020
DA01	NOTATION	15/09/2020
DA02	SITE ANALYSIS	15/09/2020
DA03	SITE / ROOF / SEDIMENT EROSION / WASTE MANAGEMENT / STORMWATER CONCEPT PLAN	15/09/2020
DA04	EXISTING GROUND FLOOR PLAN	15/09/2020
DA05	PROPOSED GROUND FLOOR PLAN	15/09/2020
DA06	EXISTING FIRST FLOOR PLAN	15/09/2020
DA07	PROPOSED FIRST FLOOR PLAN	15/09/2020
DA08	NORTH / EAST ELEVATION	15/09/2020
DA09	SOUTH / WEST ELEVATION	15/09/2020
DA10	LONG / CROSS SECTION	15/09/2020
DA11	CARPORT LONG / CROSS SECTION	15/09/2020
DA12	AREA CALCULATIONS / SAMPLE BOARD	15/09/2020
DA13	WINTER SOLSTICE 9 AM	15/09/2020
DA14	WINTER SOLSTICE 12 PM	15/09/2020
DA15	WINTER SOLSTICE 3 PM	15/09/2020
DA16	BASIX COMMITMENTS	15/09/2020

174 WOORARRA AVENUE, **ELANORA HEIGHTS NSW 2101**




NCC & AS COMPLIANCES SPECIFICATIONS

- EARTHWORKS PART 3.1.1 OF NCC
- EARTH RETAINING STRUCTURES PART 3.1.2 OF NCC
- DRAINAGE PART 3.1.3 OF NCC
- TERMITE-RISK MANAGEMENT PART 3.1.4 OF NCC
- FOOTINGS & SLAB PART 3.2 OF NCC INCLUDING AS 2870-2011
- MASONRY PART 3.3 OF NCC INCLUDING AS 3700:2018
- FRAMING PART 3.4 OF NCC
- SUB FLOOR VENTILATION PART 3.4.1 OF NCC
- ROOF CLADDING AND WALL-CLADDING PART 3.5 OF NCC
- GLAZING PART 3.6 OF NCC INCLUDING AS 1288
- FIRE SAFETY PART 3.7 OF NCC
- FIRE SEPARATION OF EXTERNAL WALLS PART 3.7.2 OF NCC
- FIRE PROTECTION OF SEPARATING WALLS AND FLOORS- PART 3.7.3 OF NCC
- SMOKE ALARMS PART 3.7.5 OF NCC
- WET AREAS AND EXTERNAL WATERPROOFING PART 3.8.1 OF NCC
- ROOM HEIGHTS PART 3.8.2 OF NCC
- FACILITIES PART 3.8.3 OF NCC
- LIGHT PART 3.8.4 OF NCC
- VENTILATION PART 3.8.5 OF NCC
- SOUND INSULATION PART 3.8.6 OF NCC
- STAIRWAYAND RAMP CONSTRUCTION PART 3.9.1 OF NCC
- BARRIERS AND HANDRAILS PART 3.9.2 OF NCC
- SWIMMING POOLS PART 3.10.1 OF NCC
- CONSTRUCTION IN BUSHFIRE PRONE AREAS PART 3.10.5 OF NCC
- FENCING & OTHER PROVISIONS REGS & AS1926.1 2012
- DEMOLITION WORKS AS2601-2001 THE DEMOLITION OF STRUCTURES.
- WATERPROOFING OF WET AREAS TO COMPLY WITH AS $3740\mbox{-}2010$
- ALL PLUMBING & DRAINAGE WORK TO COMPLY WITH AS 3500:2018
- ALL PLASTERBOARD WORK TO COMPLY WITH AS 2588:2018
- ALL STRUCTURAL STEEL WORK TO COMPLY WITH AS 4100-1992 & AS 1554
- ALL CONCRETE WORK TO COMPLY WITH AS 3600:2018
- ALL ROOF SHEETING WORK TO COMPLY WITH AS 1562.1-2018
- ALL SKYLIGHTS TO COMPLY WITH AS 4285-2019
- ALL CERAMIC TILING TO COMPLY WITH AS 3958.1-2007 & 3958.2-1992
- ALL GLAZING ASSEMBLIES TO COMPLY WITH AS 2047-2014 & 1288
- ALL TIMBER RETAINING WALLS ARE TO COMPLY WITH AS 1720.1-2010,
- AS 1720.2-2006, AS 1720.4-2006, AS 1170.1-2002 & AS 1170.4-2007
- ALL RETAINING WALLS ARE TO COMPLY WITH 3700:2018 & AS 3600:2018 ALL CONSTRUCTION TO COMPLY WITH AS 3959:2018

NOTES


- APPROVED MEANS BY THE 'RELEVANT LOCAL AUTHORITY' OR COUNCIL
- THE OWNER WILL DIRECTLY PAYTHE FEES ASSOCIATED WITH THE FOLLOWING:
- BUILDING APPROVAL FROM COUNCIL, FOOTPATH AND KERB DEPOSITS WITH THE LOCAL COUNCIL, INSURANCE FEE TO BUILDING SERVICES CORPORATION, LONG SERVICE LEAVE SERVICE LEVY FEE AND APPROVAL FEE BY WATER AND SEWERAGE AUTHORITY. ALL OTHER FEES ARE TO BE PAID BY THE BUILDER. THE AMOUNT OF ANY LOCAL AUTHORITY DEPOSITS WHICH ARE FORFEITED DUE TO DAMAGE OR OTHER CAUSE WILL BE DEDUCTED FROM THE PAYMENTS DUE TO THE BUILDER.
- THE BUILDER IS TO PROVIDE AT HIS/HER OWN EXPENSE ADEQUATE PUBLIC RISK INSURANCE AND ARRANGE INDEMNIFICATION UNDER THE WORKERS COMPENSATION ACT. WORKS INSURANCE TO BE STATED IN THE CONTRACT CONDITIONS.
- ALL WORK TO BE CARRIED OUT IN A TRADESMEN LIKE MANNER AND IN ACCORDANCE WITH THE STANDARDS CODES AND REGULATIONS OF THE STANDARDS ASSOCIATION OF AUSTRALIA, BUILDING CODE OF AUSTRALIA AND ANY STATUTORY AUTHORITY HAVING JURISDICTION OVER THE WORK.
- ALL TENDERERS ARE TO VISIT THE SITE TO SATISFY THEMSELVES AS TO THE NATURE AND EXTENT OF THE WORKS, FACILITIES AVAILABLE AND DIFFICULTIES ENTAILED IN THE WORKS AS VARIATIONS WILL NOT BE ALLOWED DUE TO WORK ARISING OWING TO NEGLECT OF THIS CLAUSE.
- ALL WORK AND MATERIALS TO COMPLY WITH THE CURRENT AUSTRALIAN STANDARDS AT THE TIME OF COMMENCEMENT WERE APPLICABLE.
- THESE DRAWINGS SHALL BE READ IN CONJUNCTION WITH ALL STRUCTURAL AND OTHER CONSULTANTS DRAWINGS AND SPECIFICATIONS AND WITH ANY SUCH WRITTEN INSTRUCTIONS AS MAY BE ISSUED DURING THE COURSE OF THE CONTRACT.
- SET OUT DIMENSIONS SHOWN ON THIS DRAWING SHALL BE VARIFIED BY THE BUILDER ON SITE BEFORE COMMENCEMENT OF ANY WORK. DIMENSIONS SHOULD NOT BE OBTAINED BY SCALING THE DRAWINGS. USE ONLY FIGURED DIMENSIONS, ALL DIMENSIONS ARE IN MILLIMETRES.
- THE BUILDER IS TO ENSURE ALL CONSTRUCTION. LEVELS AND OTHER ITEMS COMPLY WITH THE CONDITIONS OF THE BUILDING APPROVAL.
- THE BUILDER IS TO COMPLY WITH ALL ORDINANCES, LOCAL AUTHORITY REGULATIONS AND THE REQUIREMENTS OF ALL SERVICES SUPPLY AUTHORITIES HAVING JURISDICTION OVER THE WORKS.
- ALL PLUMBING AND DRAINAGE WORK TO BE INSTALLED AND COMPLETED BY A LICENCED TRADESMAN AND IN ACCORDANCE WITH THE STATUTORY BODY HAVING AUTHORITY OVER THE WORKS. CONNECT ALL WASTE TO SYDNEY WATER SEWER LINE
- ALL NEW DOWNPIPES ARE TO BE CONNECTED TO THE EXISTING STORM WATER SYSTEM.
- ALL POWER AND STORMWATER OUTLET LOCATIONS SHALL BE DETERMINED ONSITE BY THE OWNER.
- SMOKE DETECTOR ALARM TO BE INSTALLED IN ACCORDANCE WITH AS3786 AND THE BUILDING CODE OF AUSTRALIA.
- ELECTRICAL WORK TO BE IN ACCORDANCE WITH SAA WIRING RULES AND BE DONE BY A LICENCED TRADESMAN
- ANY DETAILING IN ADDITION TO WHAT IS SUPPLIED SHALL BE RESOLVED BETWEEN THE OWNER AND THE BUILDER TO THE OWNERS APPROVAL, EXCEPT FOR ANY STRUCTURAL DETAILS OR DESIGN WHICH IS SUPPLIED BY THE ENGINEER.
- ALL TIMBER SIZES AND CONCRETE DETAILS TO BE CONFIRMED BY THE BUILDER PRIOR TO COMMENCEMENT OF ANY WORK.
- ALL STRUCTURAL WORK IS TO BE IN ACCORDANCE WITH THE STRUCTURAL DETAILS PREPARED BY A STRUCTURAL ENGINEER (i.e.) PIERS, FOOTINGS, CONCRETE SLABS, RETAINING WALLS, STEELWORK, FORMWORK, UNDERPINNING, ADDITIONAL STRUCTURAL LOADS, TIMBER FRAMING, WIND BRACING AND ASSOCIATED CONNECTIONS. BUILDER TO OBTAIN PRIOR TO FINALISING TENDER.
- ANY WORK INDICATED ON THE PLANS BUT NOT SPECIFIED, AND ANY ITEM NOT SHOWN ON THE PLAN WHICH IS OBVIOUSLY NECESSARY AS A PART OF CONSTRUCTION AND/OR FINISH IS TO BE CONSIDERED AS SHOWN AND SPECIFIED, AND IS TO BE DONE AS PART OF THE CONTRACT. VARIATIONS WILL NOT BE PERMITTED WITHOUT THE WRITTEN CONSENT OF THE OWNER.
- THE BUILDER SHALL PROVIDE SEDIMENT AND SILTRATION CONTROL MEASURES AS REQUIRED BY COUNCIL AND MAINTAIN THEM THROUGH THE DURATION OF THE WORKS.
- A LEGIBLE COPY OF THE PLANS BEARING APPROVAL STAMPS MUST BE MAINTAINED ON THE JOB AT ALL TIMES. HOURS OF CONSTRUCTION WILL BE RESTRICTED TO THE TIMES AS REQUIRED BY THE BUILDING APPROVAL.
- THE BUILDER IS TO ARRANGE FOR ALL INSPECTIONS REQUIRED BY THE AUTHORITIES AND LENDING INSTITUTIONS TO THEIR REQUIREMENTS.
- THE BUILDER IS TO OBTAIN APPROVAL FOR INTERUPTIONS TO EXISTING SERVICES AND MINIMISE THE DURATION AND NUMBER OF INTERUPTIONS. ANY INTERRUPTIONS WITH EXISTING SERVICES AND EQUIPMENT TO BE ATTENDED TO BY THE APPROPRIATELY SKILLED TRADESMEN.
- THE BUILDER SHALL RESTORE, REINSTATE OR REPLACE ANY DAMAGE CAUSED TO EXISTING STRUCTURES OR LANDSCAPING BY CONSTRUCTION WORK OR WORKMEN. PROVIDE PROTECTION TO EXISTING TREES TO REMAIN AS REQUIRED BY APPROVAL CONDITIONS.
- ALL BRICKWORK IS TO BE SELECTED BY OWNER AND IS TO COMPLY WITH AS1640
- ALL MASONRY TO COMPLY WITH AS3700
- ALL METALWORK AND FLASHING ITEMS NECESSARY TO SATISFACTORY COMLPETE WORK SHALL BE PROVIDED.
- ALL GUTTERS, DOWNPIPES TO BE COLORBOND.
- ALL TIMBER CONSTRUCTION TO BE IN ACCORDANCE WITH THE AUSTRALIAN STANDARD 1684 "TIMBER FRAMING CODE"
- ALL GLAZING INSTALLED TO COMPLY WITH AS1288, 2047 AND IN ACCORDANCE WITH MANUFACTURERS RECOMMENDATION
- ALL WALL AND CEILING LININGS TO BE PLASTERBOARD OR CEMENT RENDER AS SELECTED AND VILLA BOARD IN WET AREAS, TO COMPLY WITH THE RELEVANT AUSTRALIAN STANDARDS OR INSTALLED IN ACCORDANCE WITH MANUFACTURERS SPECIFICATION.
- ALL BATHROOMS AND WET AREAS TO BE ADEQUATELY WATERPROOFED TO MANUFACTURERS SPECIFATION AND AS3740 AND PART 3.8.1 OF THE BUILDING CODE OF AUSTRALIA HOUSING PROVISIONS
- STAIRS AND BALUSTRADES TO COMPLYWITH PART 3.9.1 & 3.9.2 OF THE BUILDING CODE OF AUSTRALIA HOUSING PROVISION.
- TERMITE PROTECTION MEASURES TO COMPLY WITH AS 3660 AND BE INSTALLED TO MANUFACTURERS SPECIFICATION.
- ANY DETAILING ADDITIONAL TO THAT SUPPLIED, SHALL BE RESOLVED BETWEEN THE OWNER AND THE BUILDER TO THE OWNERS APPROVAL. EXCEPT FOR ANY STRUCTURAL DETAILS OR DESIGN WHICH IS TO BE SUPPLIED BY THE STRUCTURAL ENGINEER.

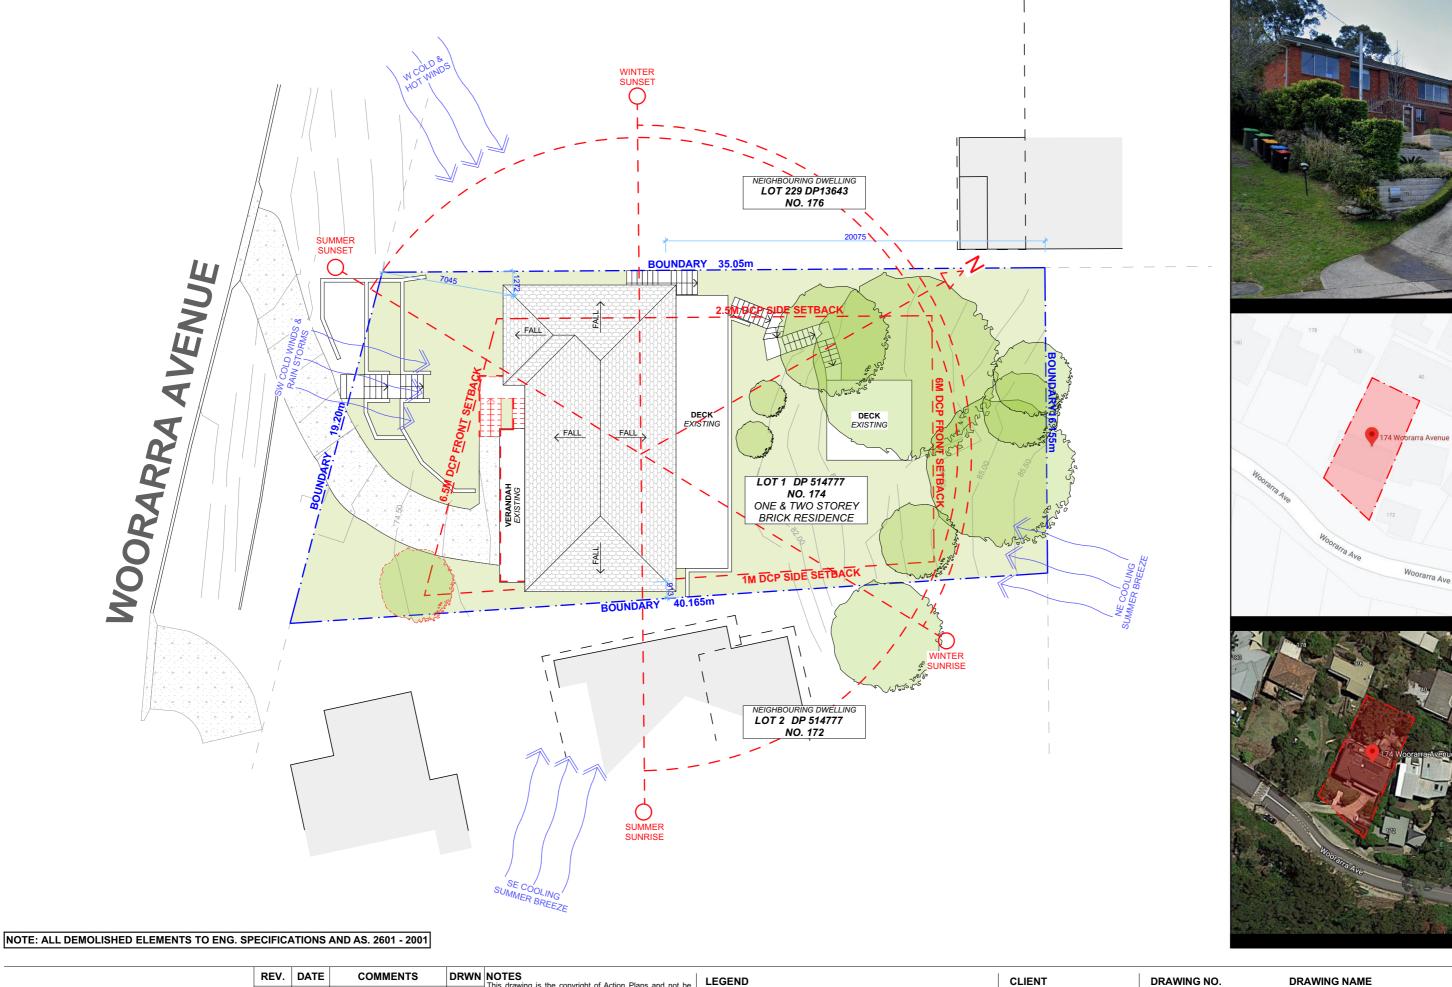



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SEAN & KATHRYN TAPP

PROJECT ADDRESS

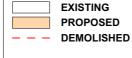174 WOORARRA AVENUE, ELANORA HEIGHTS NSW 2101

DRAWING NO. **DA02**

DATE Tuesday, 15

September 2020


SITE ANALYSIS

SCALE 1:200 @A3



AERIAL MAP

STREET VIEW

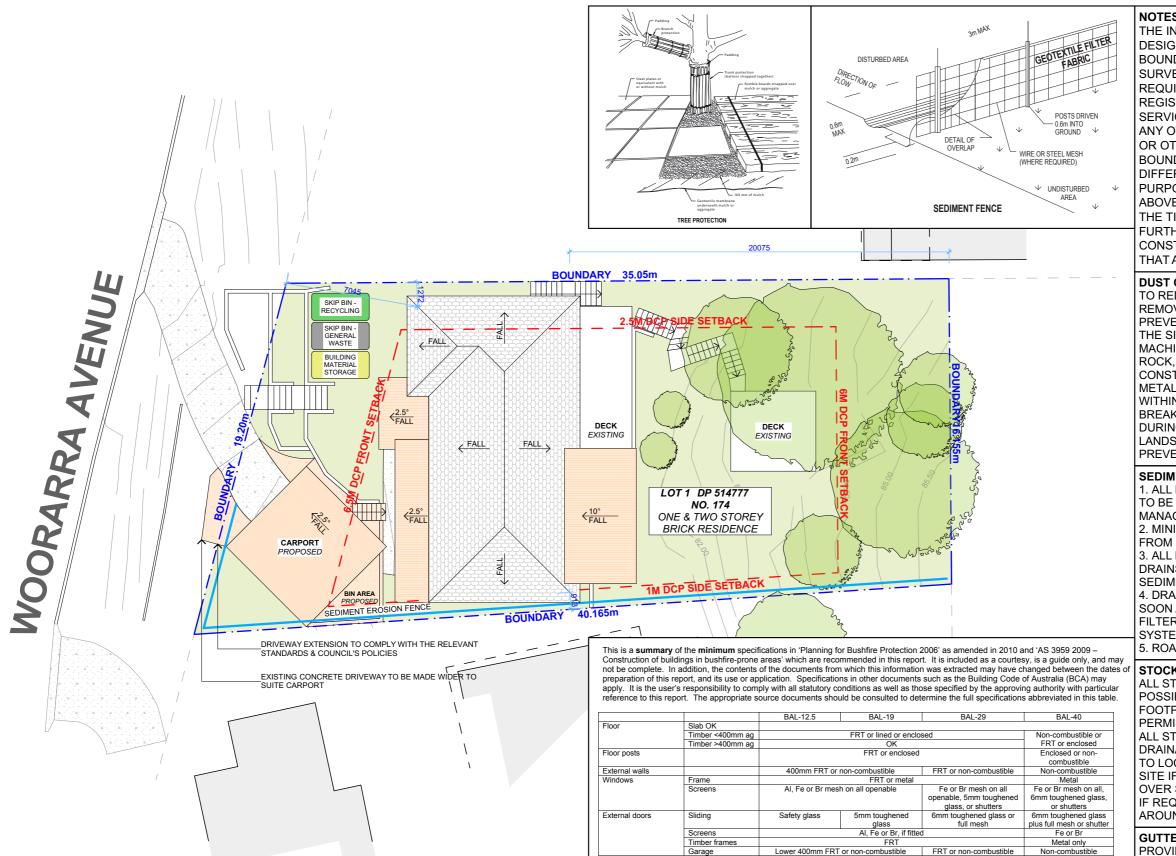

NOTES REGARDING BOUNDARY

THE INFORMATION SHOWN ON THIS PLAN IS FOR DESIGN PURPOSES ONLY. THE POSITION OF BOUNDARY LINES HAVE BEEN ESTABLISHED BY A SURVEY TO MEET THE IDENTIFICATION REQUIREMENTS FOR COUNCIL AND NOT FOR REGISTRATION WITH THE LAND REGISTRATION SERVICES NSW NOR MAY THIS PLAN BE USED FOR ANY OTHER PURPOSE. SUBSEQUENT REGISTERED OR OTHER SURVEYS MAY AFFECT THE DEFINED BOUNDARY POSITIONS IN THIS AREA. ANY DIFFERENCES OF THIS NATURE ARE BEYOND THE PURPOSES OF THIS PLAN. THIS PLAN IS FOR THE ABOVE STATED PURPOSES ONLY. RESTRICTIONS ON THE TITLE HAVE NOT BEEN INVESTIGATED. IF FURTHER DEVELOPMENT IS CONTEMPLATED OR CONSTRUCTION INTENDED THEN IT IS IMPORTANT THAT A SURVEY SET OUT IS CARRIED OUT.

DUST CONTROL:

TO REDUCE DUST GENERATED BY WIND ACTION, THE REMOVAL OF THE TOP SOIL IS TO BE MINIMISED. TO PREVENT DUST GENERATION, WATERING DOWN OF THE SITE, ESPECIALLY DURING THE MOVEMENT OF MACHINERY IS REQUIRED. WHERE EXCAVATING INTO ROCK, KEEP THE SURFACE MOIST TO MINIMISE DUST. CONSTRUCT A GRAVEL ENTRY/EXIT POINT USING BLUE METAL AND RESTRICT ALL VEHICLE MOVEMENTS WITHIN THE SITE TO A MINIMUM. ENSURE WIND BREAKS, SUCH AS EXISTING FENCES ARE MAINTAINED DURING THE CONSTRUCTION PHASE UNTIL NEW LANDSCAPING IS PROVIDED OR REINSTATED. PREVENT DUST BY COVERING STOCKPILES

SEDIMENT NOTE:

1. ALL EROSION AND SEDIMENT CONTROL MEASURES TO BE INSPECTED AND MAINTAINED DAILY BY THE SITE MANAGER.

2. MINIMISE DISTURBED AREAS, REMOVE EXCESS SOIL FROM EXCAVATEDAREA AS SOON AS POSSIBLE.
3. ALL MATERIAL STOCKPILE TO BE CLEAR FROM DRAINS, GUTTERS AND FOOTPATHS, OR WITHIN SEDIMENT FENCE AREA.

4. DRAINAGE TO BE CONNECTED TO STORMWATER AS SOON AS POSSIBLE. IF STORED ON SITE, IT MUST BE FILTERED BEFORE RELEASING INTO STORMWATER SYSTEM OR WATERWAYS.

5. ROADS AND FOOTPATHS TO BE SWEPT DAILY.

STOCKPILES:

ALL STOCKPILES ARE TO BE KEPT ON-SITE WHERE POSSIBLE. ANY MATERIALS PLACED ON THE FOOTPATHS OR NATURE STRIPS REQUIRE COUNCIL'S PERMISSION.

ALL STOCKPILES ARE TO BE PLACED AWAY FROM THE DRAINAGE LINES AND STREET GUTTERS. IT IS BEST TO LOCATE THESE ON THE HIGHEST PART OF THE SITE IF POSSIBLE. PLACE WATERPROOF COVERING OVER STOCKPILES.

IF REQUIRED PROVIDE DIVERSION DRAIN & BANK AROUND STOCKPILES.

GUTTER PROTECTION:

PROVIDE PROTECTION TO DOWNHILL GRATE IN GUTTER BY MEANS OF SAND BAGS OR BLUE METAL WRAPPED IN GEOTEXTILE FABRIC. WHEN SOIL OR SAND BUILDS UP AROUND THIS SEDIMENT BARRIER, THE MATERIAL SHOULD BE RELOCATED BACK TO THE SITE FOR DISPOSAL.

NOTE: ALL PROPOSED STORMWATER
TO CONNECT WITH EXISTING



ACTION PLANS

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Builder/Contractor and referred to the designer prior to the

EXISTING
PROPOSED
DEMOLISHED

Above ground

Sheeted Non

<300mm to glass

Vents etc Roofs

Services

LEGEND

Ag

CLIENT

Exposed water & gas pipes to metal ium Fe Stainless steel

Fully sarked (Flammability Index <5)
-combustible, fully sarked (Flammability Index <5

Al. Fe or Br mesh 2mm

Non-combustible sleeve/lining, 4mm safety glass supports, <3mm spaced deck, FRT or non-combus

FRT or non-combustible. <3mm spaced dec

300mm wide FRT or non-combustible

Fire Resistant Timber Al

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FRT or non-combustible

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DRAWING NO.

Fe or Br mesh 2mm

FRL -/30/

Any supports, unspace

deck, non-combustible

unspaced deck

DA03

DATE

Tuesday, 15 September 2020


DRAWING NAME

SITE / ROOF / SEDIMENT EROSION / WASTE MANAGEMENT / STORMWATER CONCEPT PLAN

SCALE

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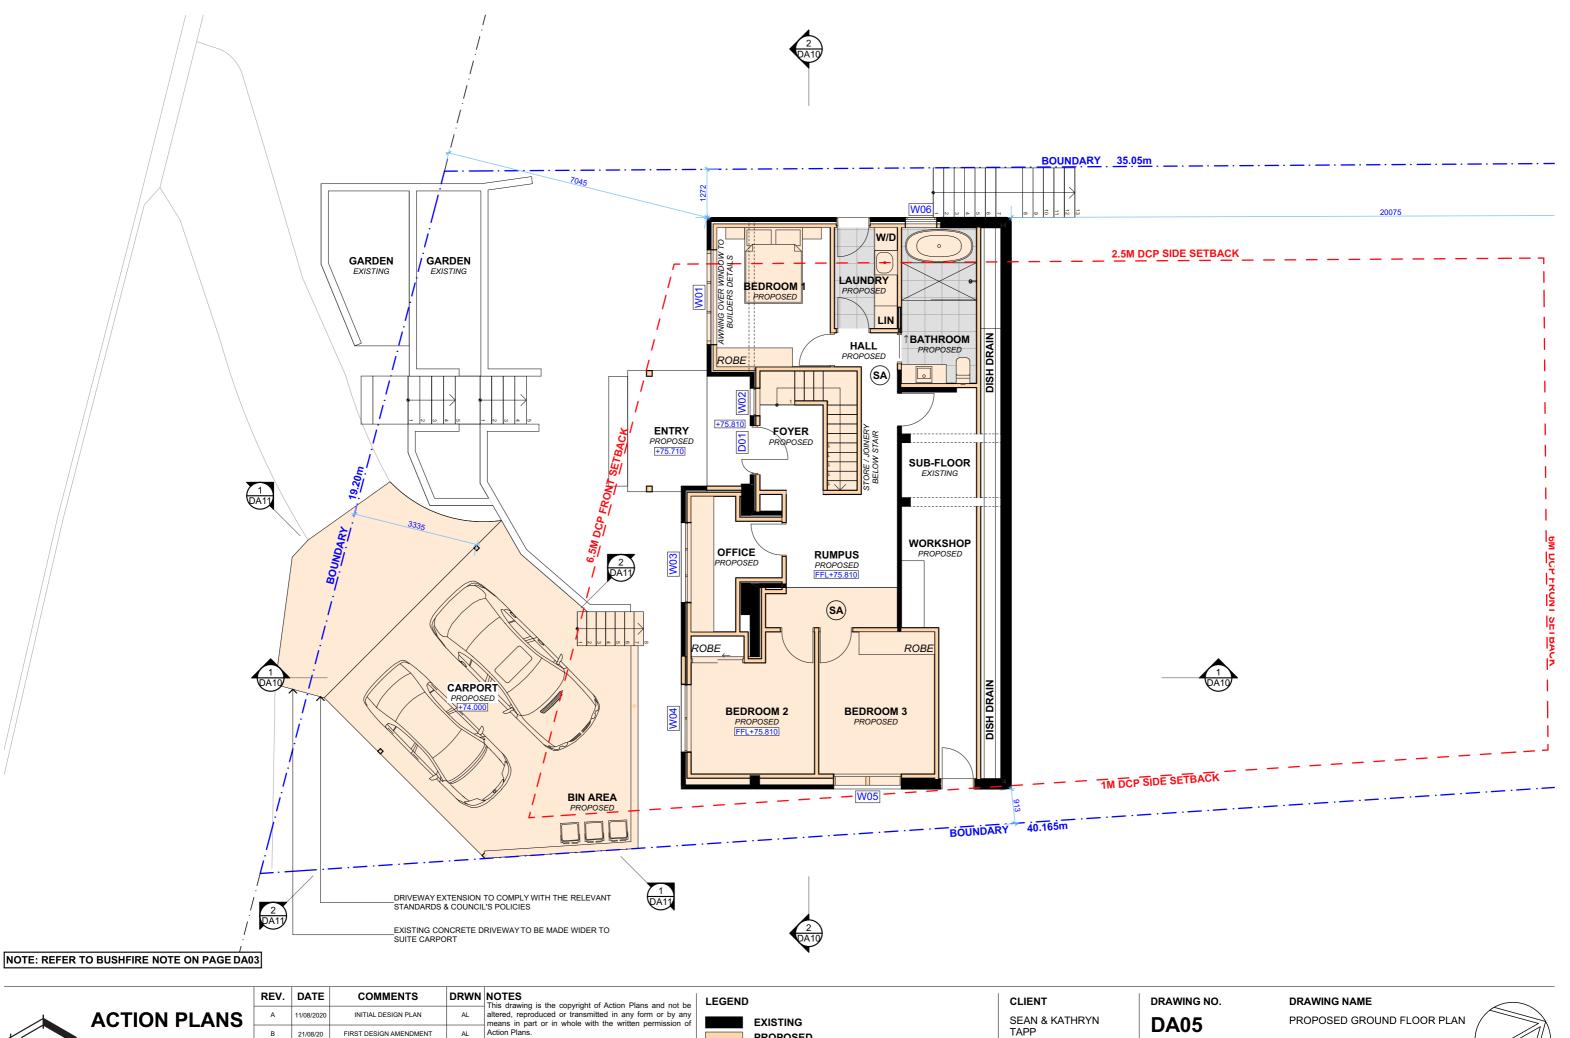
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Tuesday, 15

September 2020

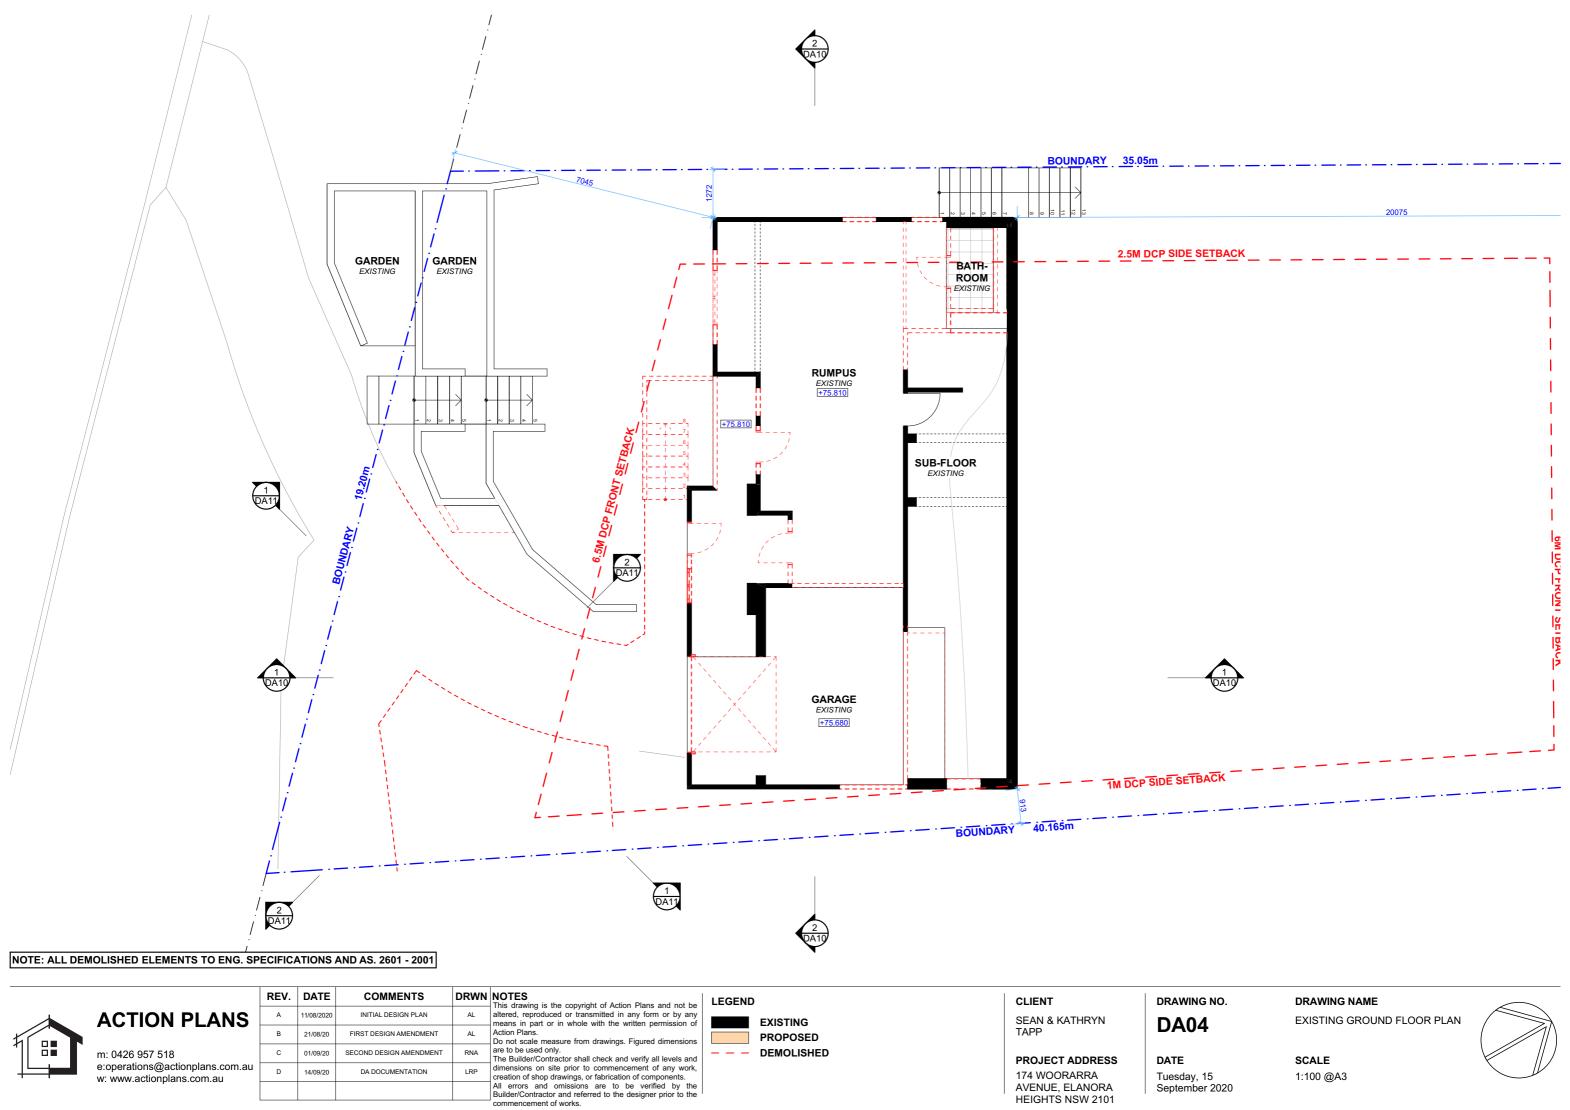







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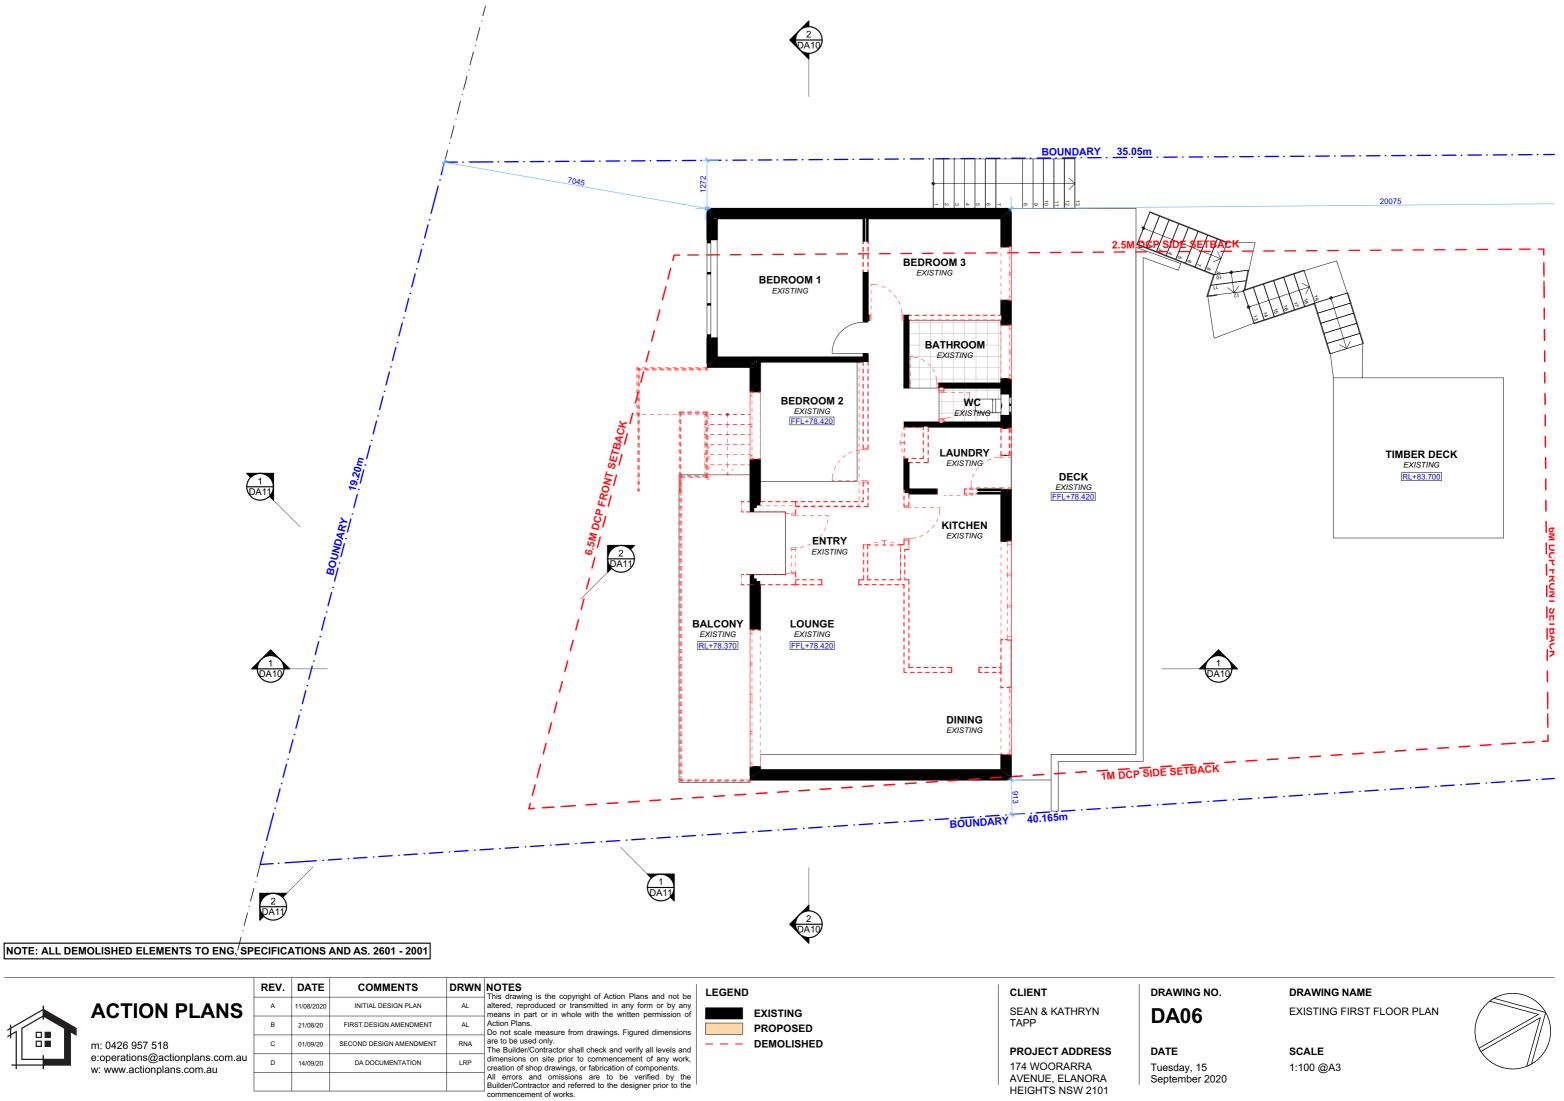
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DATE

Tuesday, 15 September 2020

SCALE

1:100 @A3





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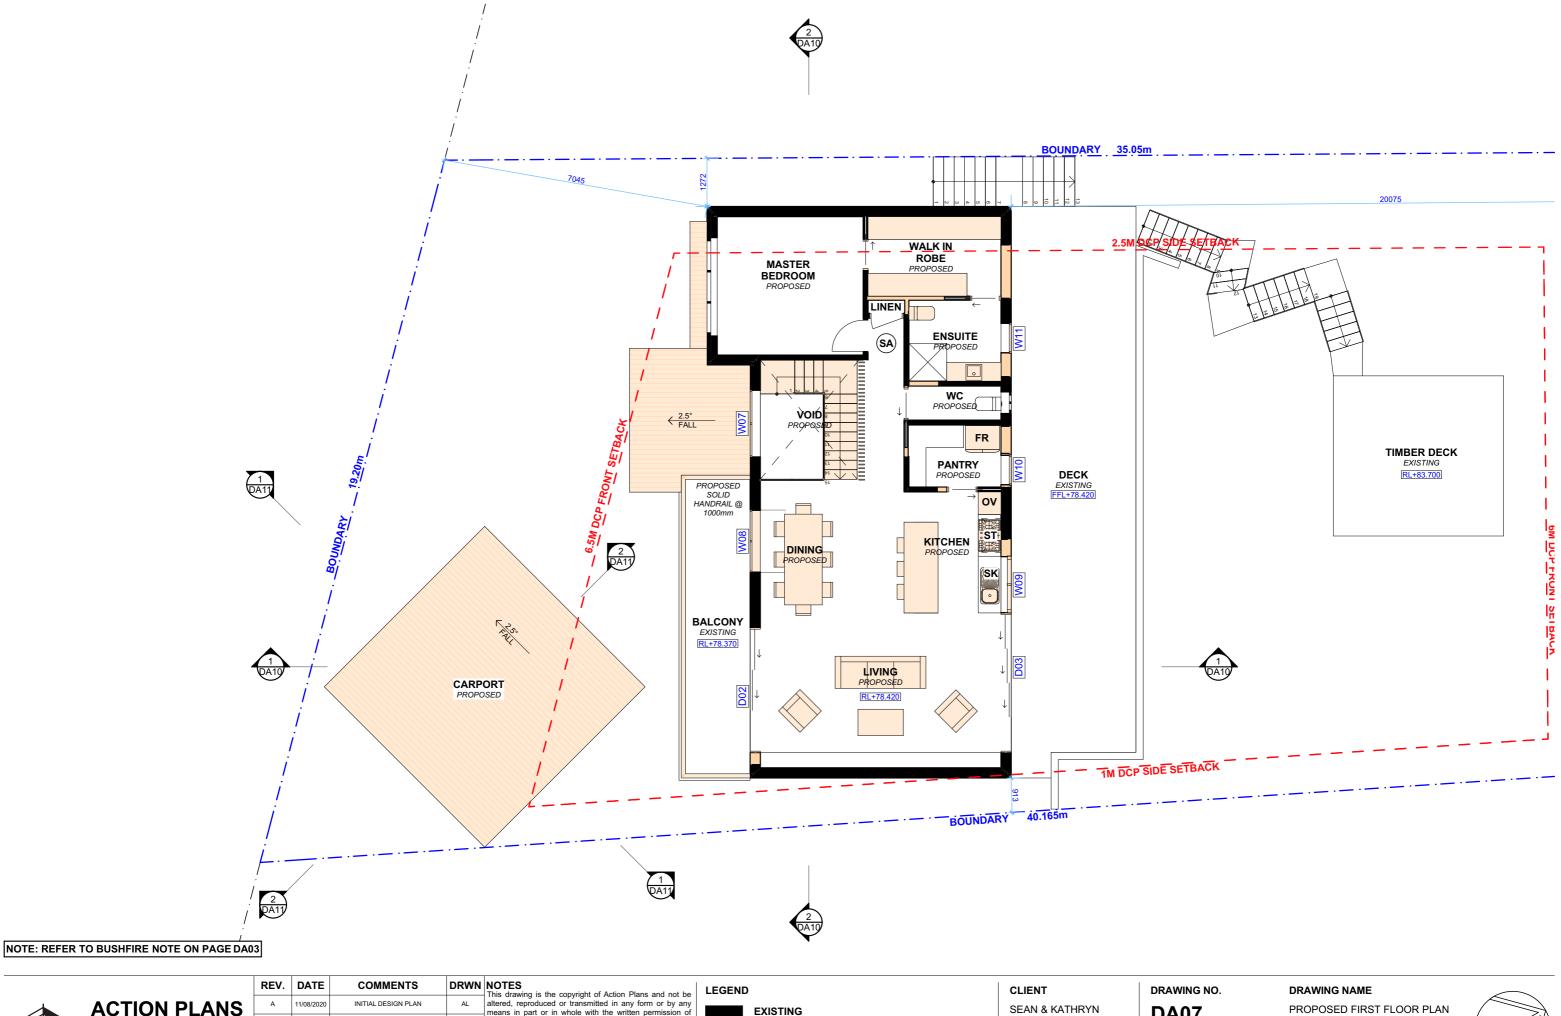
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September 2020

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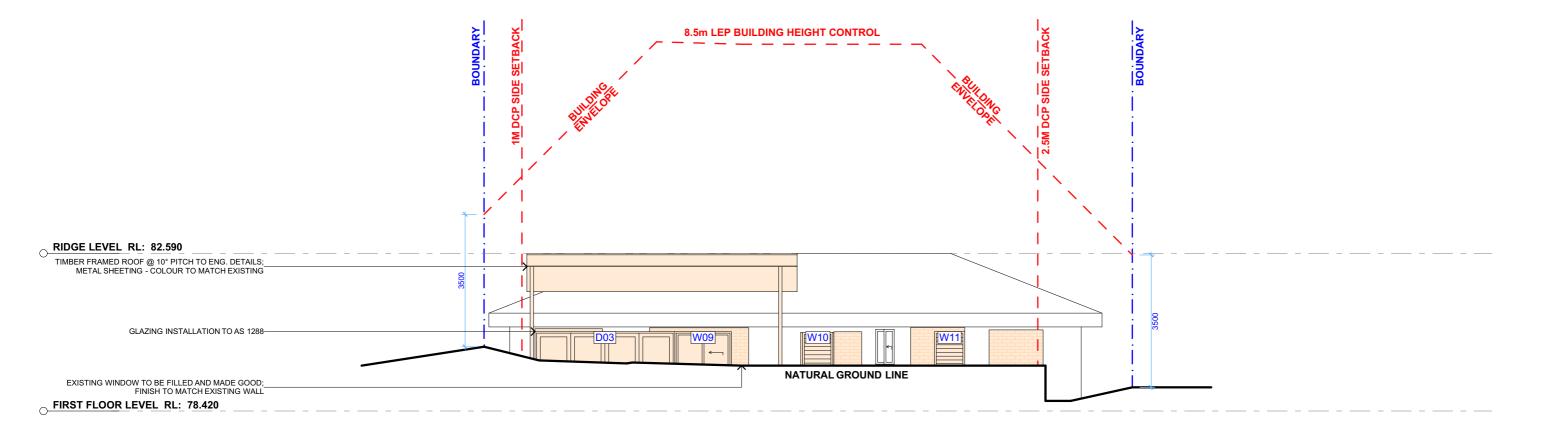
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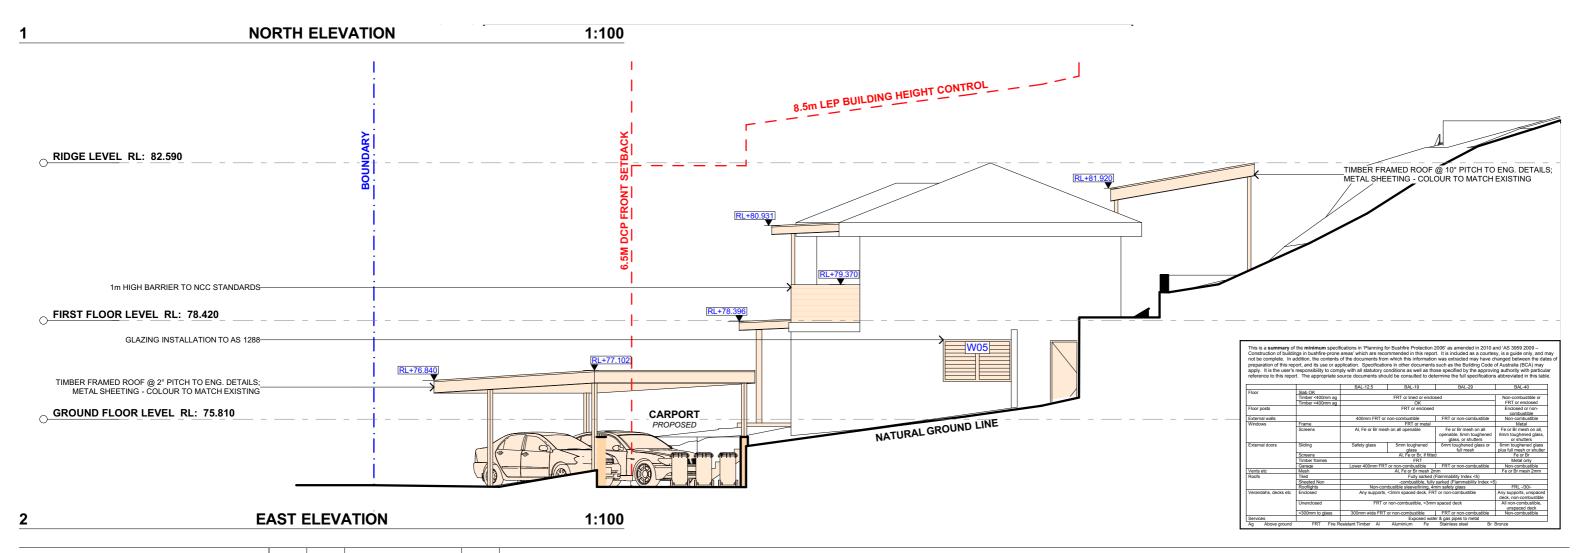
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DA07

September 2020









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LEGEND

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DRAWING NO.

DA08

Tuesday, 15

September 2020


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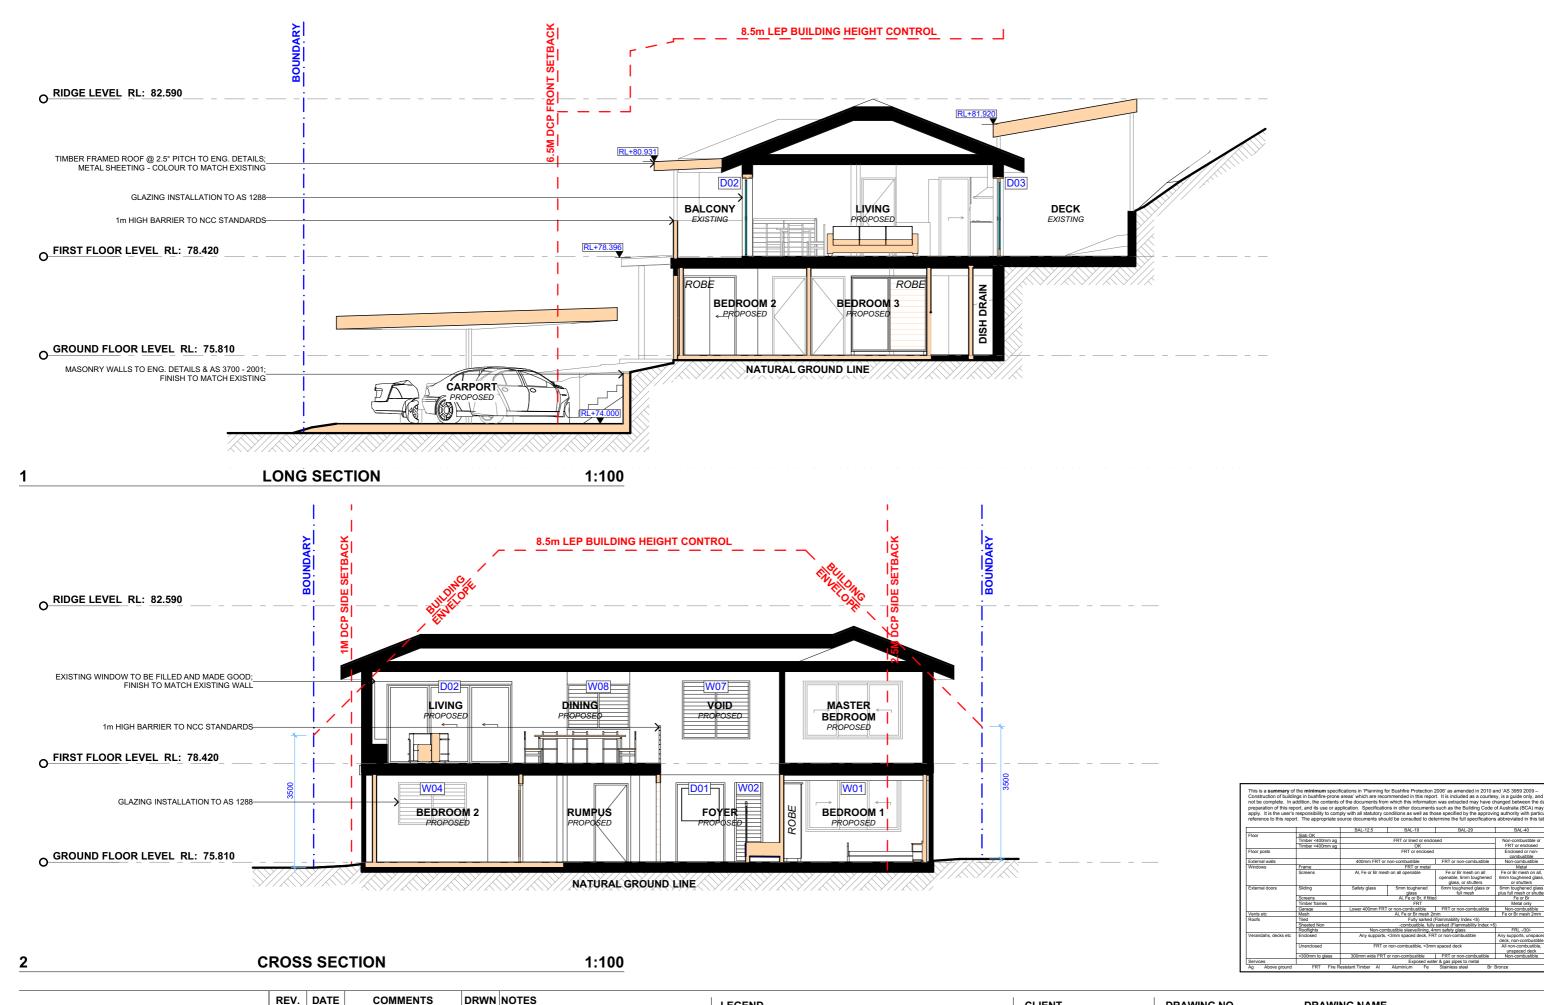
DATE SCALE

DRAWING NAME

1:100 @A3

NORTH / EAST ELEVATION



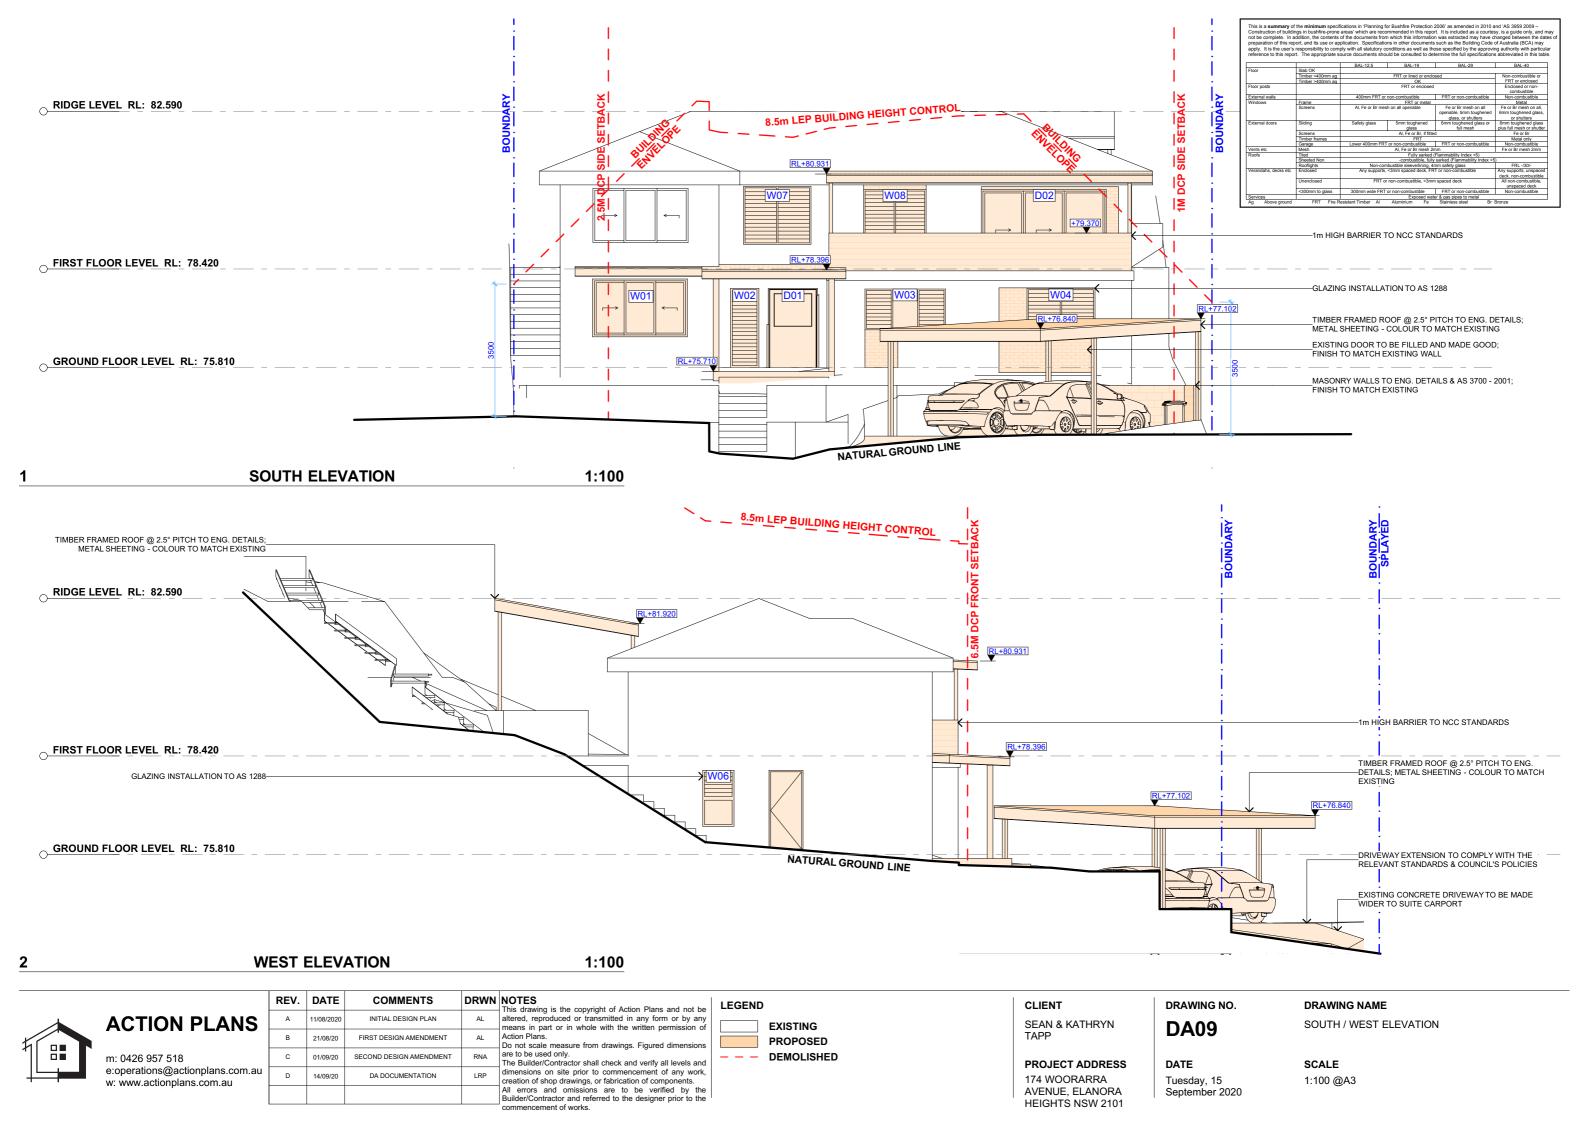



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	REV.	DATE	COMMENTS	DKWN
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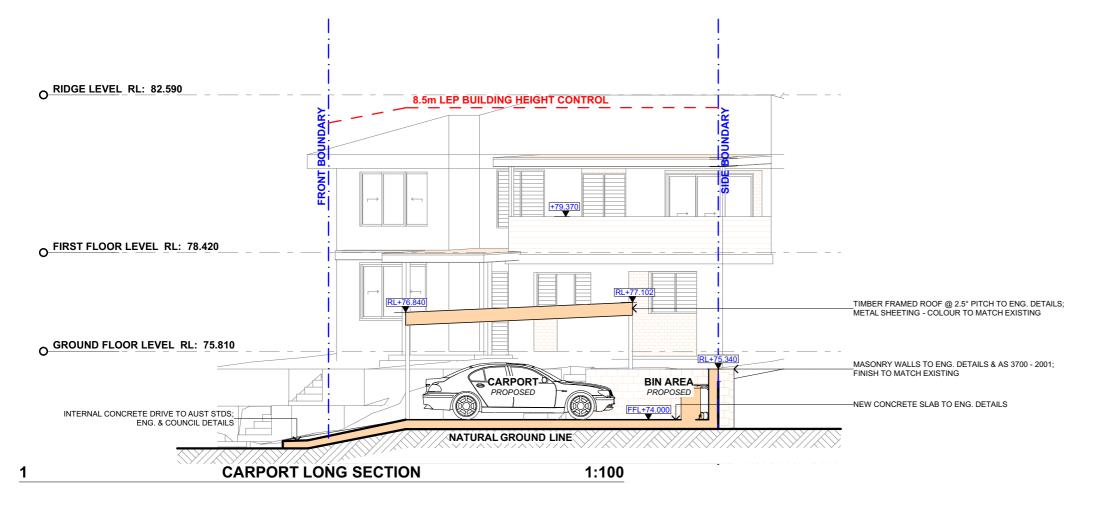
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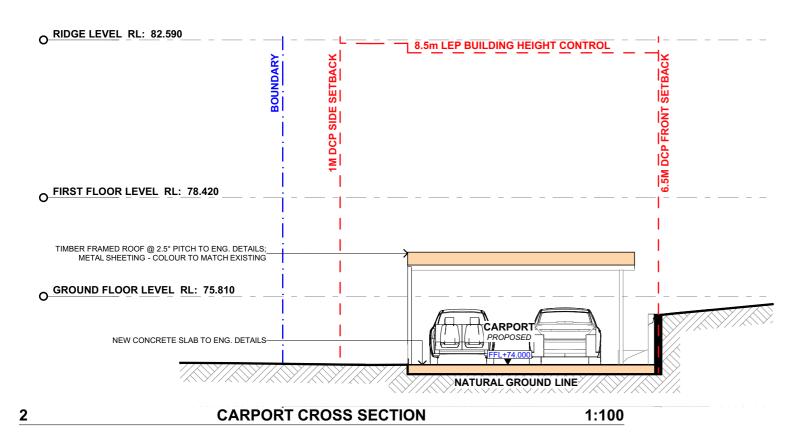
DRAWING NO.

DA10

DATE Tuesday, 15 September 2020 DRAWING NAME

LONG / CROSS SECTION





Construction of buildi not be complete. In a	ngs in bushfire-prone a addition, the contents of	areas' which are reco	ommended in this repo m which this informatio	2006' as amended in 2010 a rt. It is included as a courter n was extracted may have o	sy, is a guide on hanged between
apply. It is the user's	responsibility to comp	ly with all statutory of	conditions as well as the	s such as the Building Code ose specified by the approvi termine the full specification	ng authority with
		RAI -12 5	RAI -19	BAI -29	BAI -40
Floor	Slab OK				
	Timber <400mm ag		FRT or lined or enclo	sed	Non-combustil
	Timber >400mm ag		OK		FRT or enclo
Floor posts			FRT or enclosed		Enclosed or r combustible
External walls		400mm FRT or	non-combustible	FRT or non-combustible	Non-combust
Windows	Frame		FRT or metal	•	Metal
	Screens	Al, Fe or Br me	sh on all openable	Fe or Br mesh on all openable, 5mm toughened glass, or shutters	Fe or Br mesh 6mm toughened or shutten
External doors	Sliding	Safety glass	5mm toughened glass	6mm toughened glass or full mesh	6mm toughened plus full mesh or
	Screens		Al, Fe or Br, if fitte	d	Fe or Br
	Timber frames		FRT		Metal only
	Garage	Lower 400mm FR	T or non-combustible	FRT or non-combustible	Non-combust
Vents etc	Mesh		Al, Fe or Br mesh 2r	mm	Fe or Br mesh
Roofs	Tiled			(Flammability Index <5)	
	Sheeted Non			sarked (Flammability Index <5	
	Rooflights		mbustible sleeve/lining, 4		FRL -/30/-
Verandahs, decks etc	Enclosed	,	, <3mm spaced deck, FR		Any supports, un deck, non-comb
	Unenclosed		r non-combustible, <3mn		All non-combus unspaced de
1	<300mm to glass	300mm wide FRT	or non-combustible	FRT or non-combustible	Non-combust
Services			Exposed wat	er & gas pipes to metal	



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LEGEND

CLIENT

SEAN & KATHRYN TAPP

PROJECT ADDRESS 174 WOORARRA AVENUE, ELANORA HEIGHTS NSW 2101 DRAWING NO.


DA11

DATETuesday, 15

September 2020

DRAWING NAME

CARPORT LONG / CROSS SECTION

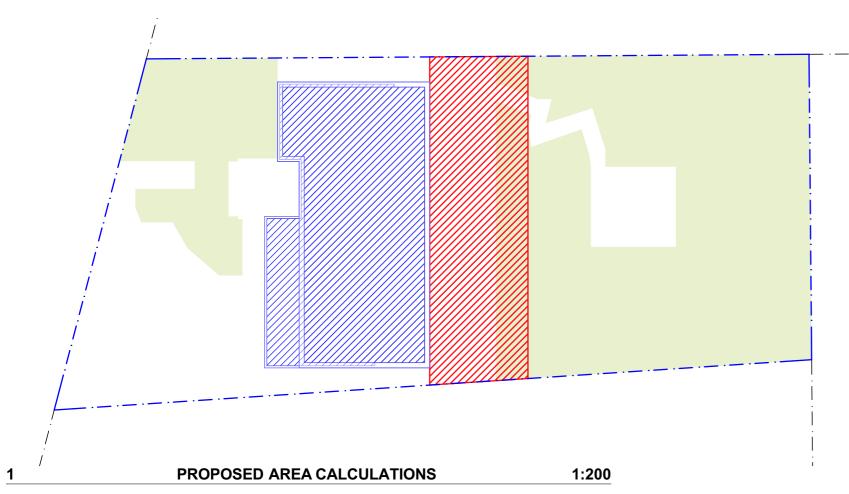

ITEM DETAILS DEVELOPMENT APPLICATION 174 WOORARRA AVENUE, ELANORA HEIGHTS NSW 2101 ADDRESS LOT & DP/SP LOT 1 DP 514777 COUNCIL SITE AREA NORTHERN BEACHES COUNCIL (PITTWATER) 645m² **FRONTAGE** 19.2m PERMISSIBLE / REQUIRED **EXISTING** PROPOSED COMPLIANCE CONTROLS m/m²/% m/m²/% m/m²/% MINIMUM LOT SIZE UNCHANGED YES FLOOR SPACE RATIO NOT IDENTIFIED N/A N/A N/A DCP LANDSCAPE OPEN SPACE AREA 1 60% (389.22m²) 48% (309.97m²) 50% (334.54m²) NO PRIVATE OPEN SPACE UNCHANGED 89m² YES 80m²

CS-01 **CONCRETE STAIRS PERSPECTIVE**

COLOURBOND METAL ROOF SHEETING COLOUR TO BE CONFIRMED BY CLIENT WHERE MARKED ON ELEVATION.

COLOUR TO BE CONFIRMED BY CLIENT AND COMPLY WITH NCC STANDARDS

ALUMINIUM WINDOW FRAME TO COMPLY WITH BASIX SPECIFICATIONS WHERE MARKED ON ELEVATION.

DRAWING NAME

SAMPLE BOARD



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D	14/09/20	DA DOCUMENTATION	LRP	dimensions on site prior to creation of shop drawings, of
				All errors and omissions Builder/Contractor and refer commencement of works.
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LEGEND



CLIENT

SEAN & KATHRYN TAPP

PROJECT ADDRESS 174 WOORARRA

AVENUE, ELANORA HEIGHTS NSW 2101


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DA12

Tuesday, 15

September 2020

AREA CALCULATIONS / SAMPLE BOARD DATE



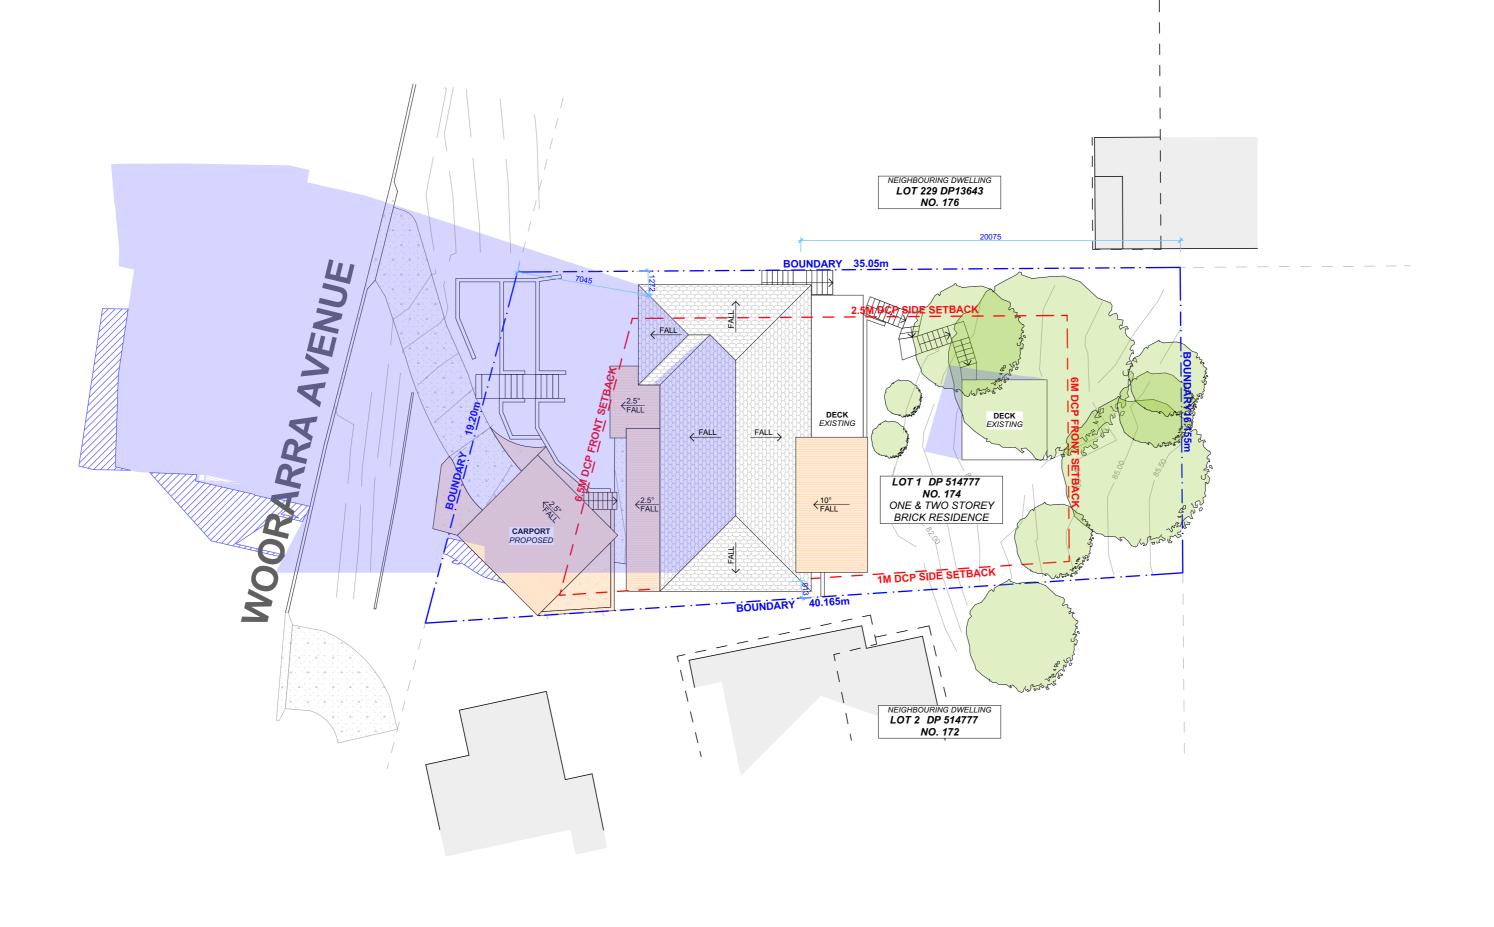


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LEGEND



CLIENT

SEAN & KATHRYN TAPP

PROJECT ADDRESS

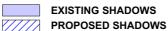174 WOORARRA AVENUE, ELANORA HEIGHTS NSW 2101

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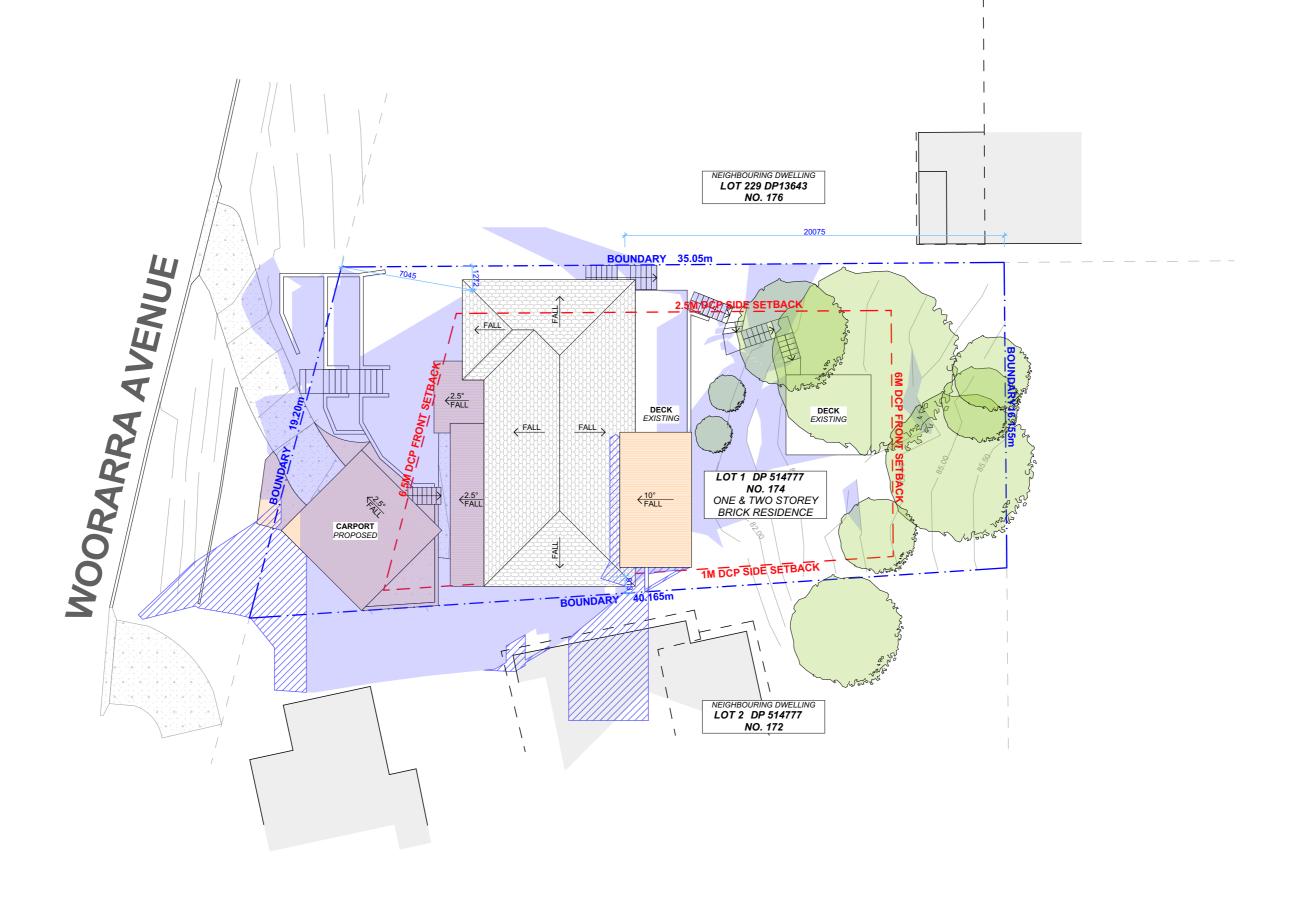
DA13

DATE

Tuesday, 15 September 2020

DRAWING NAME

WINTER SOLSTICE 9 AM





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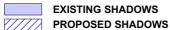
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LEGEND



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PROJECT ADDRESS

174 WOORARRA AVENUE, ELANORA HEIGHTS NSW 2101

DRAWING NO.

DA14

DATE Tuesday, 15 September 2020


DRAWING NAME

WINTER SOLSTICE 12 PM

SCALE

1:200 @A3



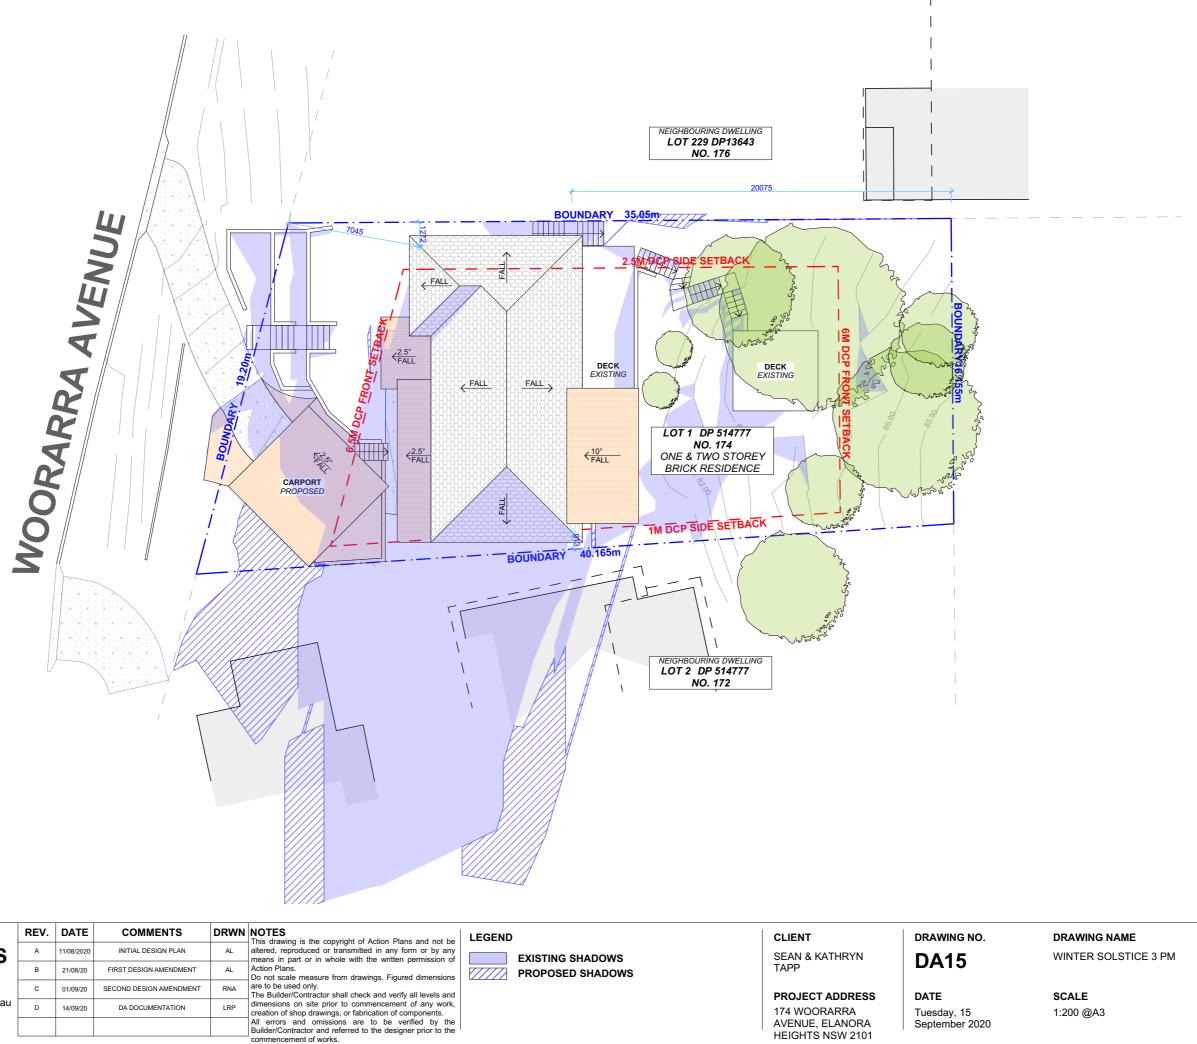




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LEGEND



CLIENT

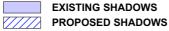SEAN & KATHRYN TAPP

PROJECT ADDRESS 174 WOORARRA AVENUE, ELANORA HEIGHTS NSW 2101

DA15

DATE Tuesday, 15 September 2020 DRAWING NAME

WINTER SOLSTICE 3 PM



BASIX Certificate Building Sustainability Index www.basix.nsw.gov.au

Alterations and Additions

Certificate number: A389954

This certificate confirms that the proposed development will meet the NSW government's requirements for sustainability, if it is built in accordance with the commitments set out below. Terms used in this certificate, or in the commitments, have the meaning given by the document entitled "BASIX Alterations and Additions Definitions" dated 06/10/2017 published by the Department. This document.

Secretary
Date of issue: Friday, 11, September 2020
To be valid, this certificate must be lodged within 3 months of the date of issue.



Project address					
Project name	174 WOORARRA AVENUE, ELANORA HEIGHT NSW 2101				
Street address	174 WOORARRA Avenue ELANORA HEIGHTS 2101				
Local Government Area	Northern Beaches Council				
Plan type and number	Deposited Plan 514777				
Lot number	1				
Section number					
Project type					
Dwelling type	Separate dwelling house				
Type of alteration and addition	My renovation work is valued at \$50,000 or more and does not include a pool (and/or spa).				

Fixtures and systems	Show on DA Plans	Show on CC/CDC Plans & specs	Certifier Check
Lighting			
The applicant must ensure a minimum of 40% of new or altered light fixtures are fitted with fluorescent, compact fluorescent, or light-emitting-diode (LED) lamps.		✓	~
Fixtures		•	
The applicant must ensure new or altered showerheads have a flow rate no greater than 9 litres per minute or a 3 star water rating.		✓	✓
The applicant must ensure new or altered toilets have a flow rate no greater than 4 litres per average flush or a minimum 3 star water rating.		✓	~
The applicant must ensure new or altered taps have a flow rate no greater than 9 litres per minute or minimum 3 star water rating.		✓	

Construction	Show on DA Plans	Show on CC/CDC Plans & specs	Certifier Check		
Insulation requirements					
The applicant must construct the new or altere the table below, except that a) additional insula is not required for parts of altered construction	~	~	~		
Construction					
floor above existing dwelling or building.	nil				
external wall: brick veneer					
external wall: framed (weatherboard, fibro, metal clad)	R1.30 (or R1.70 including construction)				

Certificate Prepared by (please complete before submitting to Council or PCA) Name / Company Name: Action Plans ABN (if applicable): 17118297587

> Building Sustainability Index www.basix.nsw.gov.au Planning, Industry & Environment Planning, Industry & Environment

BASIX Certificate number: A389954

Glazing requirements Windows and glazed doors The applicant must install the windows, glazed doors and shading devices, in accordance with the specifications listed in the table below. Relevant overshadowing specifications must be satisfied for each window and glazed door. The following requirements must also be satisfied in relation to each window and glazed door: Each window or glazed door with improved frames, or pyrolytic low-e glass, or clear/air gap/clear glazing, or toned/air gap/clear glazing must have a U-value and a Solar Heat Gain Coefficient (SHGC) no greater than that listed in the table below. Total system U-values and SHGCs must be calculated in accordance with National Fenestration Rating Council (INFRC) conditions. The description is provided for information only. Alternative systems with complying U-value and SHGC may be substituted. For projections described in millimetres, the leading edge of each eave, pergola, verandah, balcony or awning must be no more than 500 mm above the head of the window or glazed door and no more than 2400 mm above the sill. Pergolas with polycarbonate roof or similar translucent material must have a shading coefficient of less than 0.35. External louvres and blinds must fully shade the window or glazed door beside which they are situated when fully drawn or closed. Pergolas with fixed battens must have battens parallel to the window or glazed door above which they are situated, unless the pergola also shades a perpendicular window. The spacing between battens must not be more than 50 mm. Pergolas with adjustable shading may have adjustable blades or removable shade cloth (not less than 80% shading ratio). Adjustable blades must overlap in plan view. Windows and glazed doors glazing requirements improved aluminium, single clear, (U-va 6.44, SHGC: 0.75) =600 mm improved aluminium, single clear, (U-value: 6.44, SHGC: 0.75)

Glazing requi	irements						Show on DA Plans	Show on CC/CDC Plans & specs	Certifier Check
Window / door no.	Orientation	Area of glass inc. frame (m2)	Oversha Height (m)	Distance (m)	Shading device	Frame and glass type			
W04	S	1.98	0	0		improved aluminium, single clear, (U-value: 6.44, SHGC: 0.75)			
W05	E	1.98	0	0	eave/verandah/pergola/balcony >=600 mm	improved aluminium, single clear, (U-value: 6.44, SHGC: 0.75)			
W06	W	1.23	0	0	external louvre/blind (adjustable)	improved aluminium, single clear, (U-value: 6.44, SHGC: 0.75)			
W07	S	2.74	0	0		improved aluminium, single clear, (U-value: 6.44, SHGC: 0.75)			
W08	s	1.99	0	0	eave/verandah/pergola/balcony >=900 mm	improved aluminium, single clear, (U-value: 6.44, SHGC: 0.75)			
W09	N	1.65	0	0		improved aluminium, single clear, (U-value: 6.44, SHGC: 0.75)			
W10	N	0.86	0	0		improved aluminium, single clear, (U-value: 6.44, SHGC: 0.75)			
W11	N	0.88	0	0		improved aluminium, single clear, (U-value: 6.44, SHGC: 0.75)			
D01	S	2.73	0	0	eave/verandah/pergola/balcony >=900 mm	improved aluminium, single clear, (U-value: 6.44, SHGC: 0.75)			
D02	S	6.94	0	0		improved aluminium, single clear, (U-value: 6.44, SHGC: 0.75)			
D03	N	7.76	0	0	eave/verandah/pergola/balcony >=900 mm	improved aluminium, single clear, (U-value: 6.44, SHGC: 0.75)			

BASIX Certificate number: A389954

in these commitments, "applicant" means the person carrying out the development Commitments identified with a "\" in the "Show on DA plans" column must be shown on the plans accompanying the development application for the proposed development (if a development application is to be lodged for the proposed development).

Commitments identified with a "</" in the "Show on CC/CDC plans & specs" column must be shown in the plans and specifications accompanying the application for a construction sertificate / complying development certificate for the proposed development.

mmitments identified with a "\sqrt^* in the "Certifier check" column must be certified by a certifying authority as having been fulfilled, before a final occupation certificate for the elopment may be issued.

Building Sustainability Index www.basix.nsw.gov.au Planning, Industry & Environment Planning, Industry & Environmen Building Sustainability Index www.basix.nsw.gov.au Planning, Industry & Environment

BASIX Certificate number: A389954

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All errors and omissions are to be verified by the Builder/Contractor and referred to the designer prior to the commencement of works. All window & door dimensions, orientation, glazing materials, opening types, frame types are to be confirmed by a suitably qualified person prior to the ordering of any such materials are to take place.

U value takes precedence over glazing type/colour in all cases.

all new glazing must meet the BASIX specified frame and glass type, <u>OR</u> meet the ecified U value and SHGC value.

CLIENT

SEAN & KATHRYN TAPP

PROJECT ADDRESS 174 WOORARRA AVENUE, ELANORA HEIGHTS NSW 2101

DRAWING NO. **DA16**

September 2020

DRAWING NAME BASIX COMMITMENTS

DATE Tuesday, 15