




LONG SECTION A, 1:100 HORIZONTAL, 1:50 VERTICAL

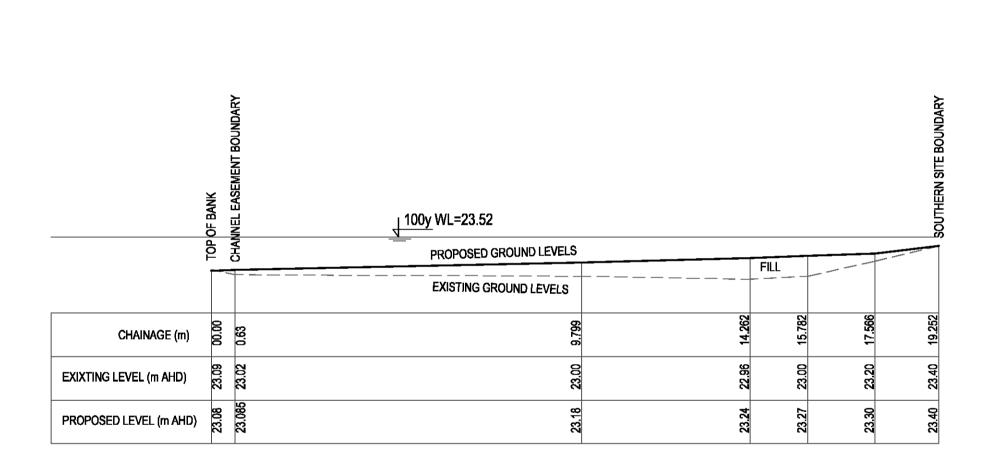

LONG SECTION B, 1:100 HORIZONTAL, 1:50 VERTICAL

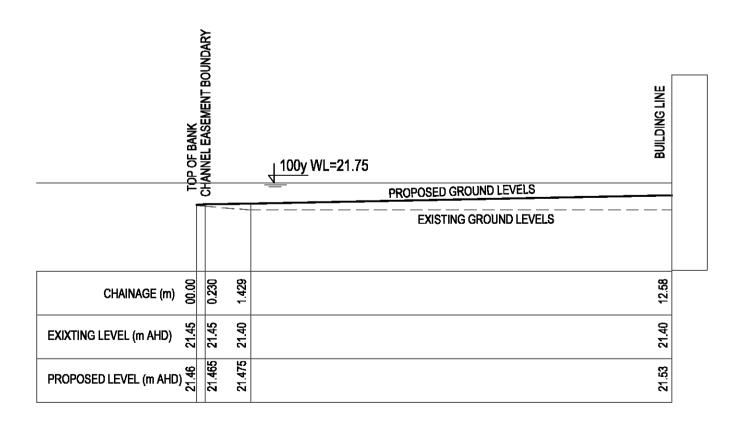

LONG SECTION D, 1:100 HORIZONTAL, 1:50 VERTICAL

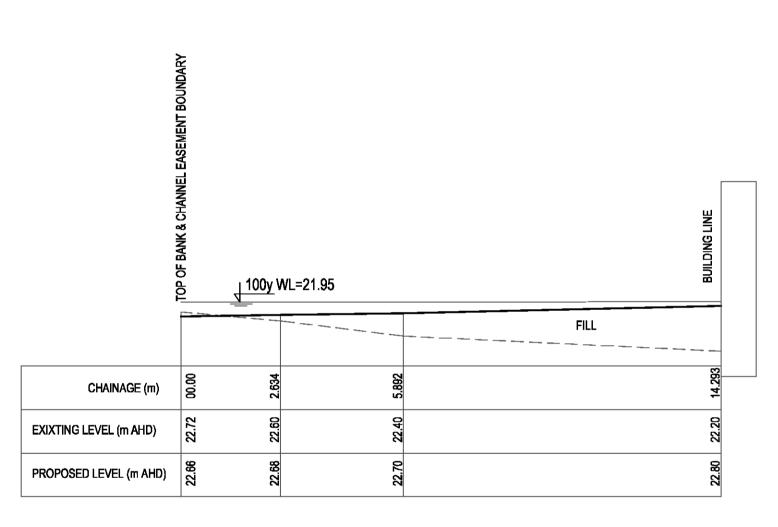


LONG SECTION C, 1:100 HORIZONTAL, 1:50 VERTICAL

		HANNEL EASEMENT BOUNDARY	00y WL=21.02				СИТ	EXISTING	GROUND LEVELS		ACCESS ROAD
			<del></del>		and the second second	PROPOSED GROUND L	EVELS				
CHAINAGE (m)	00.00	0.462		9.577	11.623	15.073	16.504	18.223	21.273	2000	22.045
EXIXTING LEVEL (m AHD)	20.90	20.90		20.82	21.00	21.40	21.70	21.60	21.80	8 6	21.80
PROPOSED LEVEL (m AHD)	20.89	20.89		20.91	20.93	20.96	21.00	21.10	21.40	2 2	21.50


LONG SECTION E, 1:100 HORIZONTAL, 1:50 VERTICAL


Amendments			FLOOD STUDY FOR	DRAWN BY: P.K.	
Issue	Date	Comments	PROPOSED SUBDIVISION AT	DD444410 N	
1	9/02/18	for comments	No. 24 MULLABURDA DOAD MEMBORT	DRAWING No.C-3307-05	
2	19/02/18	for DA	No. 34 NULLABURRA ROAD, NEWPORT		
3	26/03/18	Amended layout	LONG OFOTIONS	SCALE: AS SHOWN	
4	21/09/18	Right overbank assumed to be 50% blocked for proposed conditions	LONG SECTIONS	OUALL. AU DITOTTI	
5	25/10/18	1.8x1.2 m Culvert proposed		Kozarovski & Partners	
В	5/11/18	dedicated overland flow area proposed	DESIGNED BY: PAVEL KOZAROVSKI,		
7	17/12/18	The layout of the pool type fence adjusted to suit 2D modelling results	· ·	14/52-54 KINGSWAY, CRONULLA NSW 2230	
8	16/01/19	additional section through the western wall added	MIEAus, CPEng, NPER-3	(02) 8544 8720	
-	-	-		Mobile: 0412 997 767 pavelk@optusnet.com.a	

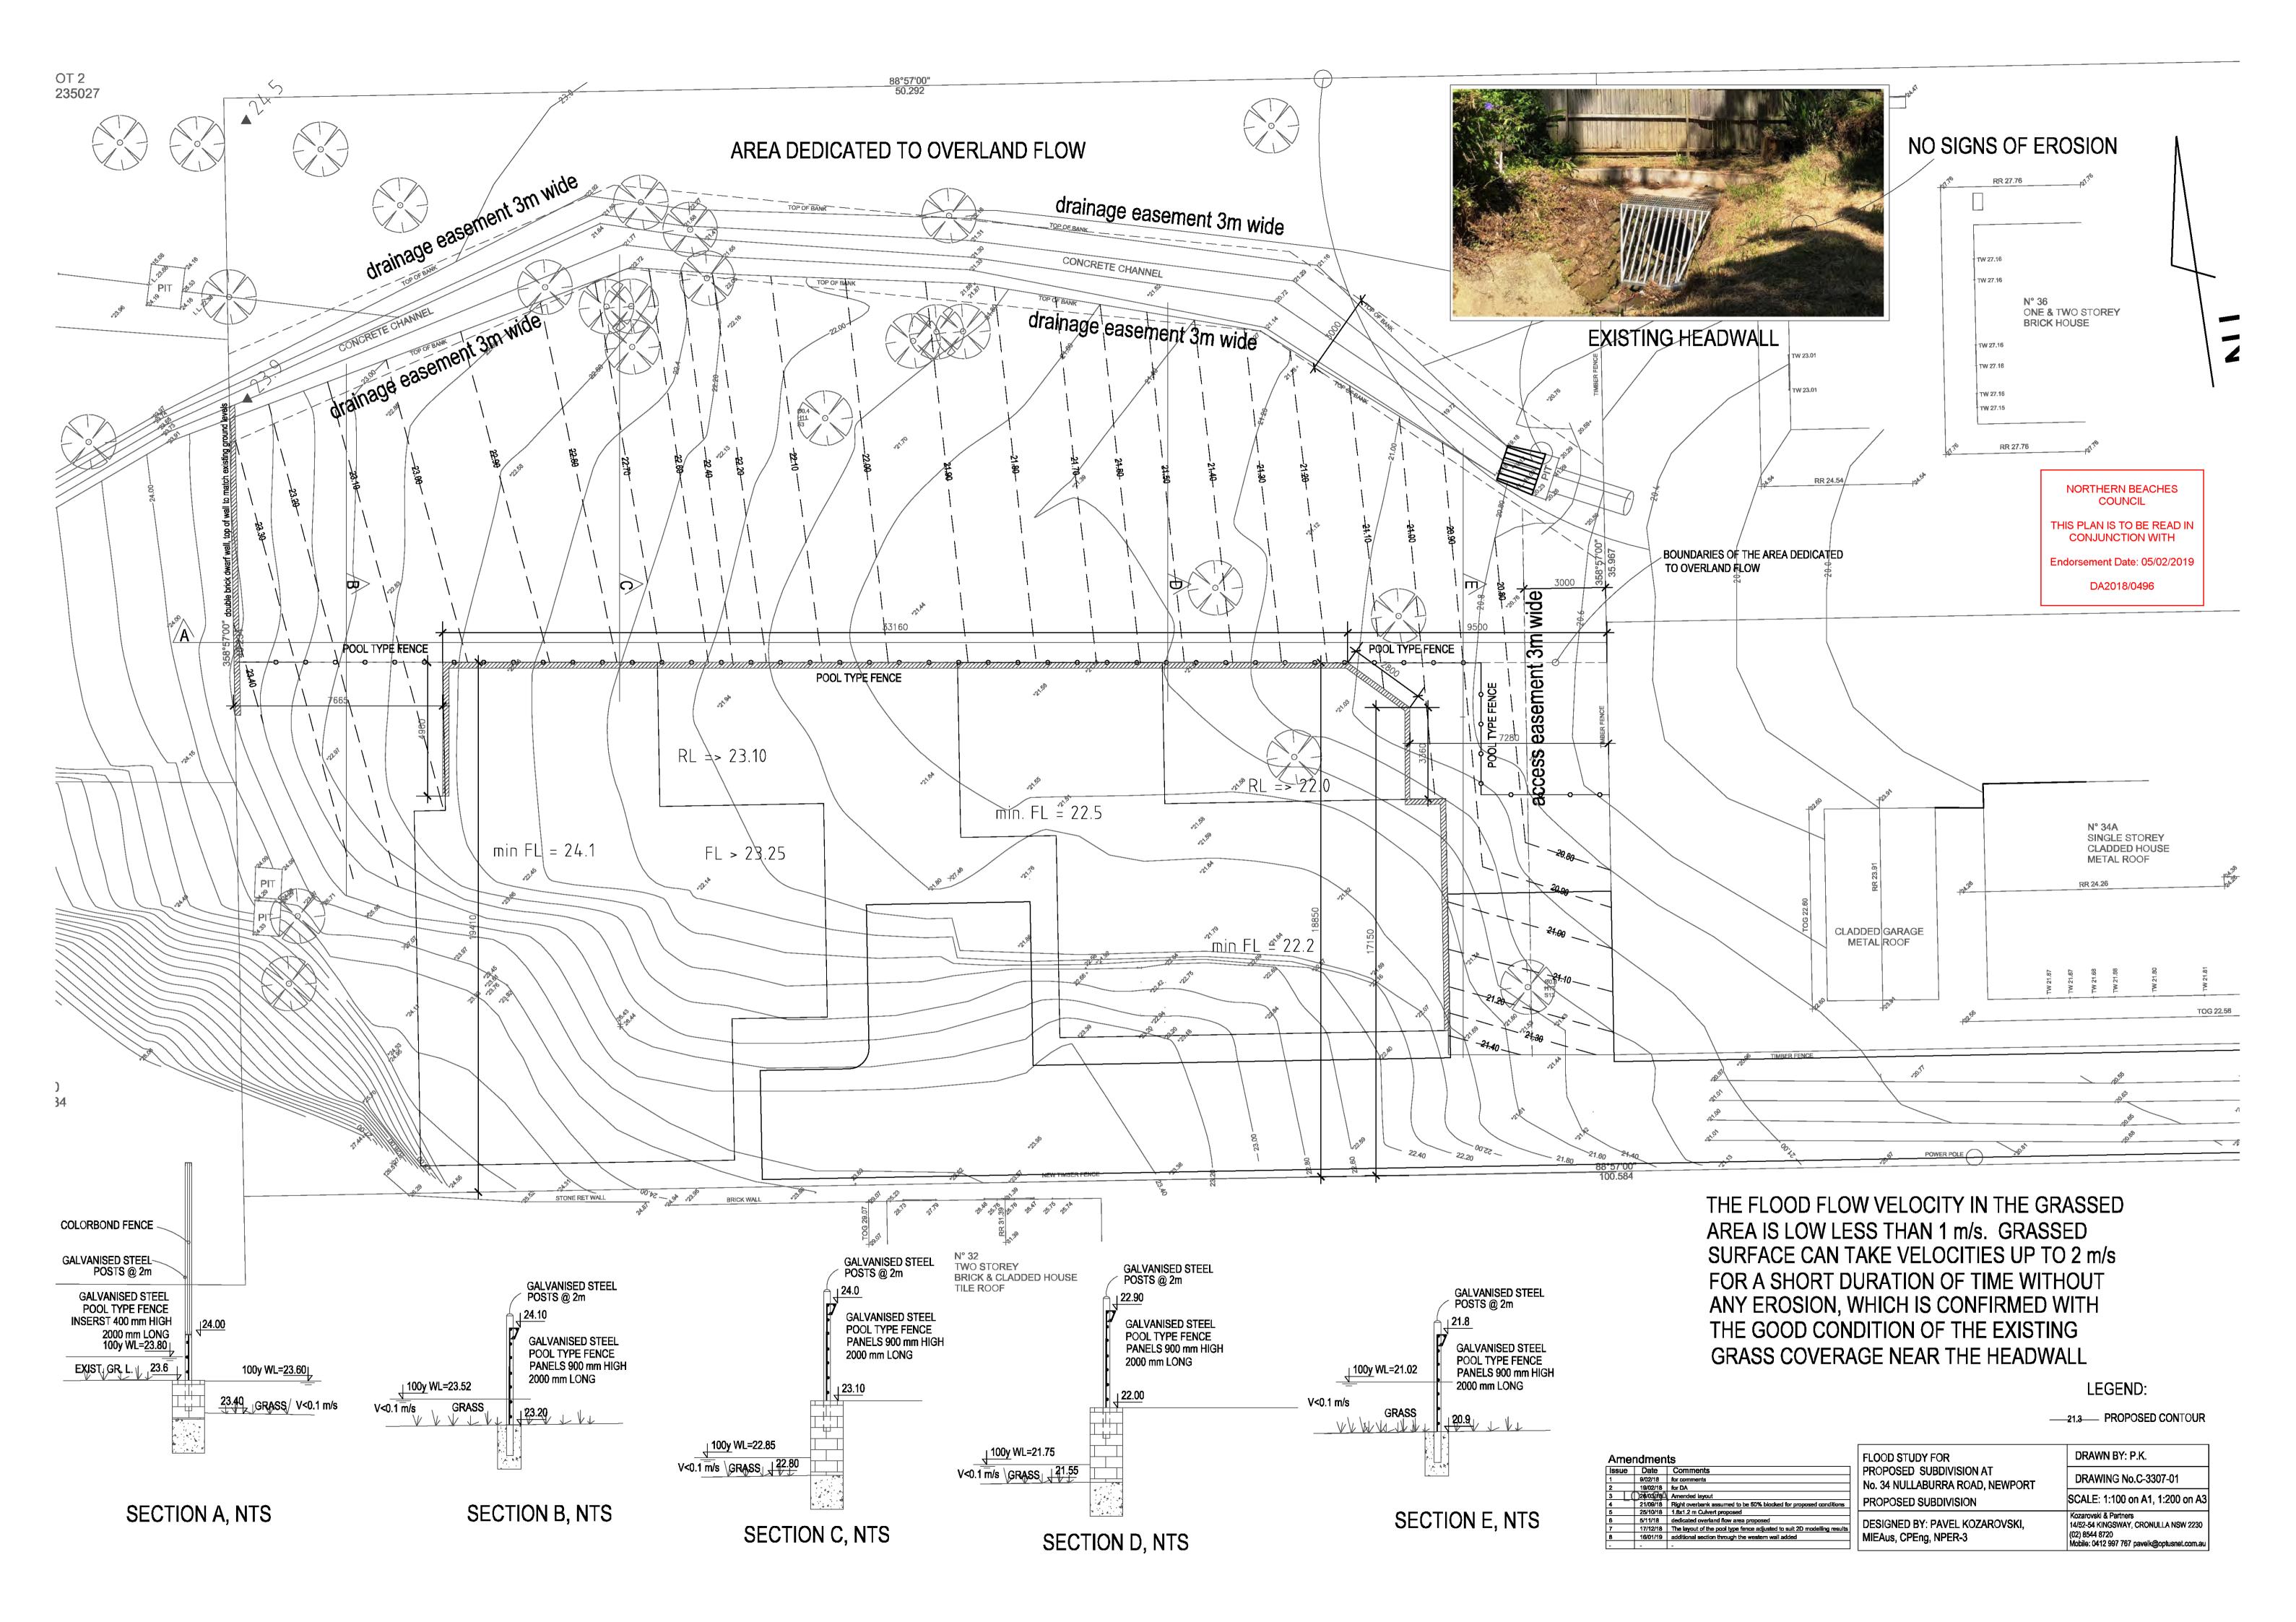





Endorsement Date: 05/02/2019 DA2018/0496

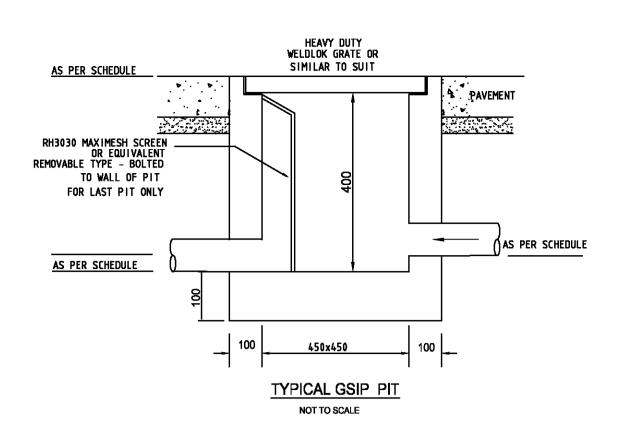


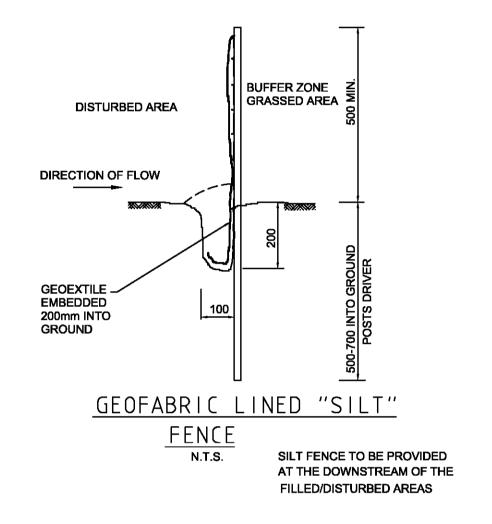

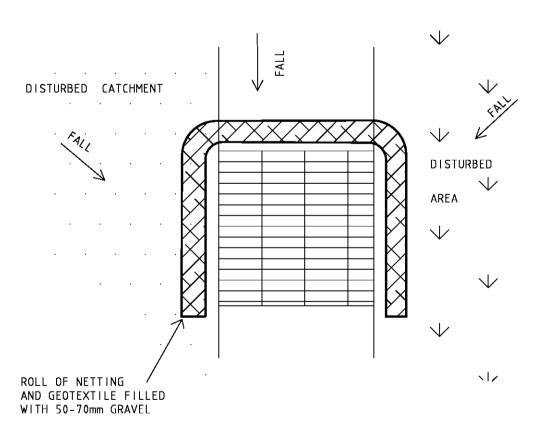



PLAN OF SURFACE INLET SEDIMENT TRAP

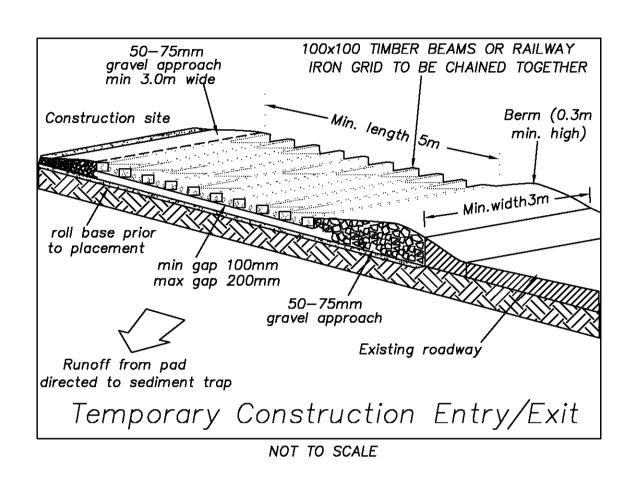

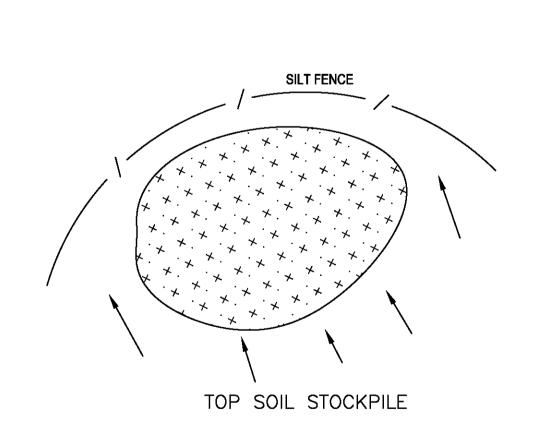

## ALL DISTURBED AREAS ARE TO BE STABILISED BY TURFS.

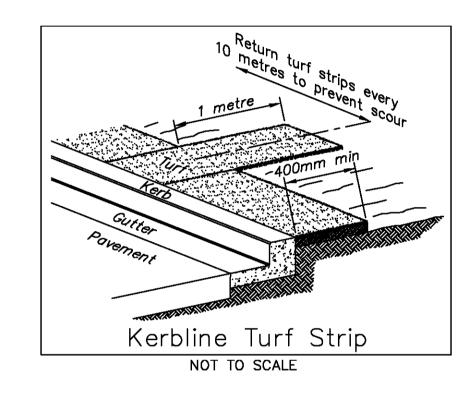

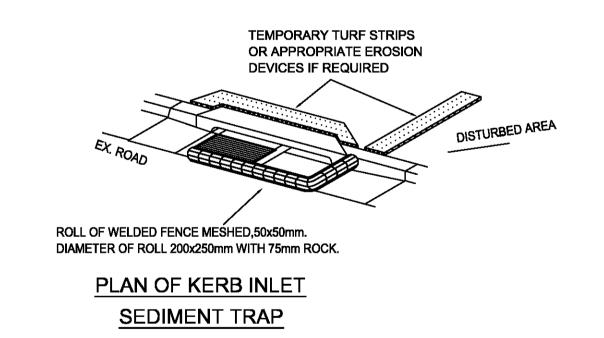

## PROVIDE KERB INLET TRAP TO EXISTING KERB PIT

## SEDIMENT AND EROSION CONTROL

## ORDER OF OPERATIONS

- 1 PROVIDE SHAKER PAD AT SINGLE SITE ENTRY POINT AND POLLUTION WARNING SIGNAGE.
- 2 CONSTRUCT CUT OFF DRAINS TO DIRECT CLEAN WATER AROUND SITE WHERE NECESSARY 3 PLACE BARRIER FENCE TO RESTRICT VEHICULAR TO A SINGLE POINT IF PRACTICAL.
- 4 PLACE SEDIMENT FENCING AND CONSTRUCT DIRTY WATER CHANNEL/MOUND AS SHOWN IF
- REQUIRED 5 CONSTRUCT SEDIMENT BASIN IF SHOWN TO DETAIL
- 6 PROVIDE STRAW BALES IF SHOWN
- 7 CONSTRUCT ROADS AND DRAINAGE TO PLAN DIRECTING DIRTY WATER TO APPROVED
- SEDIMENT CONTROL DEVICES AT ALL TIMES 8 PITS AND PIPES TO BE PROTECTED AT ALL TIMES WITH FILTER BARRIERS.
- 9 A 1 METRE WIDE COUCH TURF STRIP SHALL BE LAID BEHIND ALL KERBS IMMEDIATELY UPON COMPLETION OF FOOTPATH REGARDING.
- 10 CONSTRUCT ROAD WORKS ONLY AND MINIMIZE DISTURBANCE ON LOTS UNTIL ROAD SURFACE IS STABLE WITH SANDSTONE
- 11 ON STABILISATION OF ROAD SURFACE COMPLETE TOPSOIL STRIPPING AND BULK
- EARTHWORKS TO LOT REGRADING AREA AND SEED ON COMPLETION OF TOPSOILING TO DESIGN LEVELS.
- 12 AT COMPLETION OF ALL WORKS REVEGETATE DISTURBED AREAS AS DIRECTED WITHIN 14
- 13 SEDIMENT CONTROL MEASURES TO BE REMOVED AS DIRECTED BY COUNCIL OR
- SUPERINTENDENT

