

# **ACTION PLANS**

m: 0426 957 518 e: operations@actionplans.com.au w: www.actionplans.com.au

PLANS PUBLISHED 13 March 2025

## **DEVELOPMENT APPLICATION**

These plans are for Council Approval only.

NO.	DRAWING NAME
DA00	COVER
DA01	NOTATION
DA02	SAFTEY NOTES
DA03	SITE ANALYSIS
DA04	SITE / ROOF / SEDIMENT EROSION / WASTE MANAGEMENT / STORMWATER CONCEPT PLAN
DA05	EXISTING GROUND FLOOR PLAN
DA06	PROPOSED GROUND FLOOR PLAN
DA07	NORTH / EAST ELEVATION
DA08	SOUTH / WEST ELEVATION
DA09	LONG / CROSS SECTION
DA10	AREA CALCULATIONS
DA11	WINTER SOLSTICE 9 AM
DA12	WINTER SOLSTICE 12 PM
DA13	WINTER SOLSTICE 3 PM


- **DA14** SAMPLE BOARD
- DA15 BASIX COMMITMENTS

### **NCC 2022 & AS COMPLIANCES SPECIFICATIONS**


- STRUCTURE - PART H1 & SECTION 2 OF NCC - SITE PREPARATION - PART H1D3 & SECTION 3 OF NCC - FOOTINGS & SLABS - PART H1D4 & SECTION 4 OF NCC - MASONRY - PART H1D5 & SECTION 5 OF NCC - FRAMING - PART H1D6 & SECTION 6 OF NCC - ROOF AND WALL CLADDING - PART H1D7 & SECTION 7 OF NCC - GLAZING - PART H1D8 & SECTION 8 OF NCC - DAMP & WEATHERPROOFING - PART H2 OF NCC - FIRE SAFETY - PART H3 & SECTION 9 OF NCC - HEALTH & AMENITY - PART H4 & SECTION 10 OF NCC - SAFE MOVEMENT & ACCESS - PART H5 & SECTION 11 0F NCC - ANCILLARY PROVISIONS - PART H7 & SECTION 12 OF NCC - SWIMMING POOLS - PART H7P1 & NSW H7D2 OF NCC - CONSTRUCTION IN BUSHFIRE PRONE AREAS - PART NSW H7D4 OF NCC - ENERGY EFFICIENCY - PART H6 & SECTION 13 OF NCC - POOL FENCING & OTHER PROVISIONS - REGULATIONS, & AS 1926 - DEMOLITION WORKS TO COMPLY WITH AS 2601-2001 THE DEMOLITION OF STRUCTURES. - WATERPROOFING OF WET AREAS TO COMPLY WITH AS 3740:2021 - ALL PLUMBING & DRAINAGE WORK TO COMPLY WITH AS 3500:2021 - ALL PLASTERBOARD WORK TO COMPLY WITH AS 2588:2018 - ALL STRUCTURAL STEEL WORK TO COMPLY WITH AS 4100:2020 & AS 1554.1:2014 ALL CONCRETE WORK TO COMPLY WITH AS 3600:2018
ALL ROOF SHEETING WORK TO COMPLY WITH AS 3600:2018
ALL SKYLIGHTS TO COMPLY WITH AS 4285:2019
ALL CERAMIC TILING TO COMPLY WITH AS 3958.1-2007 & 3958.2-1992 - ALL GLAZING ASSEMBLIES TO COMPLY WITH AS 2047-2014 & AS 1288:2021

- ALL TIMBER RETAINING WALLS ARE TO COMPLY WITH AS 1720, AS 1170
- ALL RETAINING WALLS ARE TO COMPLY WITH AS 3700:2018 & AS 3600:2018
- ALL CONSTRUCTION IN BUSHFIRE-PRONE AREAS TO COMPLY WITH AS 3959:2018

## **34 JOHNSON STREET, FRESHWATER 2096**

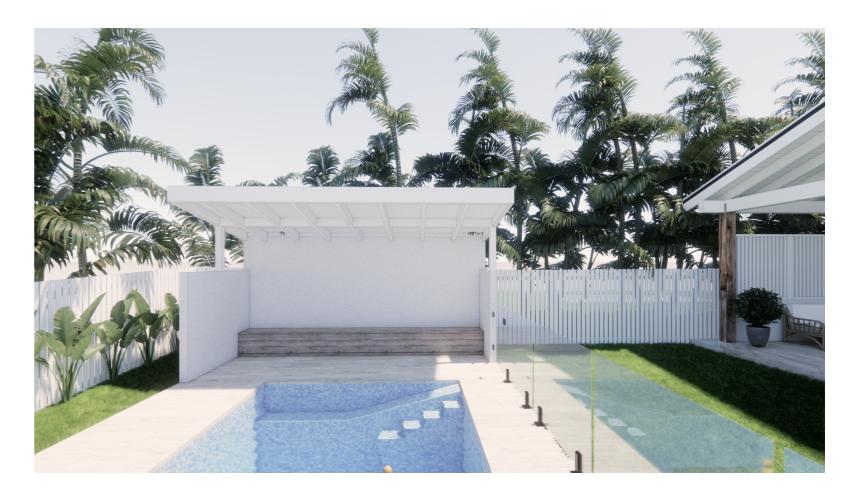

ITEM DETAILS	DEVELOPMENT APPLICATION									
ADDRESS	34 JOHNSON STREET, FRESHWATE	R, NSW 2096								
LOT & DP/SP	LOT 67 DP 7310	OT 67 DP 7310								
COUNCIL	NORTHERN BEACHES COUNCIL (W.	IORTHERN BEACHES COUNCIL (WARRINGAH)								
SITE AREA	404.1m <sup>2</sup>									
FRONTAGE	10.06m									
CONTROLS	PERMISSIBLE / REQUIRED	EXISTING	PROPOSED	COMPLIANCE						
	m / m² / %	m / m² / %	m / m² / %							
<u>LEP</u>										
LAND ZONING	R2 – LOW DENSITY RESIDENTIAL	R2	R2	YES						
MINIMUM LOT SIZE	600m <sup>2</sup>	404.1m <sup>2</sup>	UNCHANGED	YES						
FLOOR SPACE RATIO	NOT IDENTIFEID	N/A	N/A	N/A						
MAXIMUM BUILDING HEIGHT	8.5m	7.919m	UNCHANGED	YES						
HAZARDS										
DEVELOPMENT ON SLOPING										
LAND	LANDSLIP RISK MAP - AREA A	N/A	N/A	N/A						
DCP										
WALL HEIGHT	7.2m	6.085m	UNCHANGED	YES						
NUMBER OF STOREYS	2	2	UNCHANGED	YES						
SIDE BOUNDARY ENVELOPE	5m		UNCHANGED	YES						
SIDE BOUNDARY SETBACKS	0.9m	E: 0.95m	UNCHANGED	NO						
SIDE BOUNDART SETBACKS	0.911	W: 0.1m	UNCHANGED	NO						
FRONT BOUNDARY SETBACK	6.5m	4.667m	UNCHANGED	NO						
	6.0m	(HOUSE)15.534m	UNCHANGED							
REAR BOUNDARY SETBACK	6.0m	(CABANA) -	1.23m	NO						
LANDSCAPE OPEN SPACE	40% (161.64m²)	22.4% (90.85m <sup>2</sup> )	UNCHANGED	YES						
PRIVATE OPEN SPACE	60m <sup>2</sup>	70.26m <sup>2</sup>	UNCHANGED	YES						

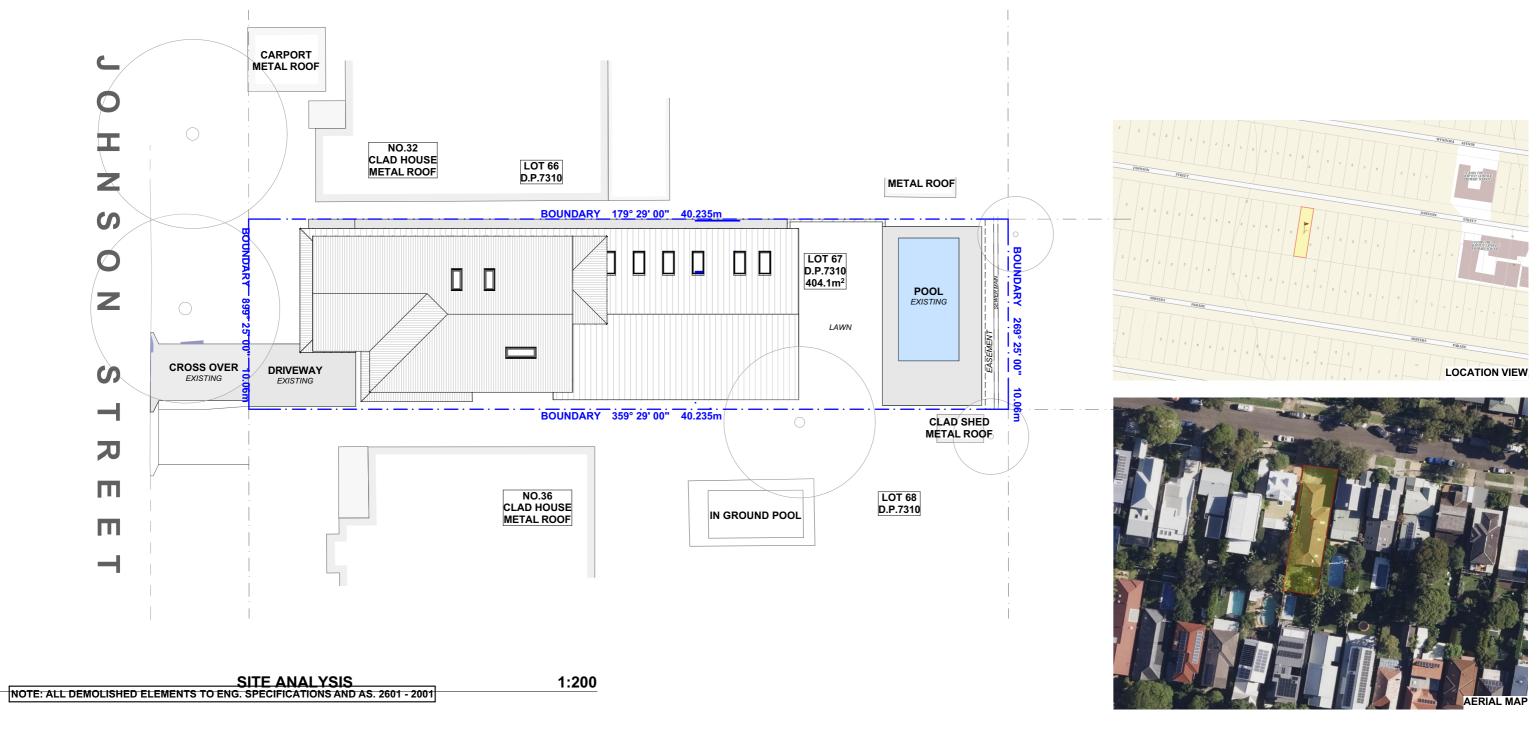


		REV.	DATE	COMMENTS	DRWN	NOTES This drawing is the copyright of Action Plans and not be altered, reproduced or	LEGEN	ח		CLIENT	DRAWIN
	ACTION PLANS	A	13.03.2025	DA - SUBMISSION	CR	This drawing is use copyright or Action Prairs and not be altered, reproduced or transmitted in any form or by any means in part or in whole with the written permission of Action Plans. Do not scale measure from drawings. Figured dimensions are to be used only.		EXISTING	TILED FLOOR	NANCY BARTLETT & KATE BOCK	DA0
	m: 0426 957 518 e:operations@actionplans.com.au					The Builder/contractor/owner is to ensure that the approved boundary setbacks and approved levels are confirmed and set out by a registered Surveyor prior to construction, the boundary setbacks take precedence over all other dimensions. The Builder/Contractor shall check and yerliv ALL dimensions on site prior to		DEMOLISHED METAL ROOFING	TIMBER FLOOR	NATE BOOK	
						commencement of any work, creation of shop drawings, or fabrication of components.		TILED ROOFING		PROJECT ADDRESS	DATE
	w: www.actionplans.com.au					All errors and omissions are to be verified by the Builder/Contractor/client and referred to the designer prior to the commencement of works.		TIMBER STUD		34 JOHNSON STREET, FRESHWATER 2096	Thursday 2025

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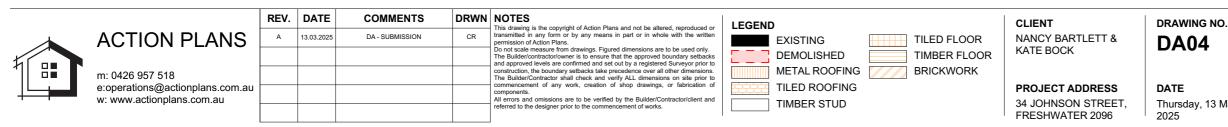
VING NO.

DRAWING NAME SITE ANALYSIS

day, 13 March

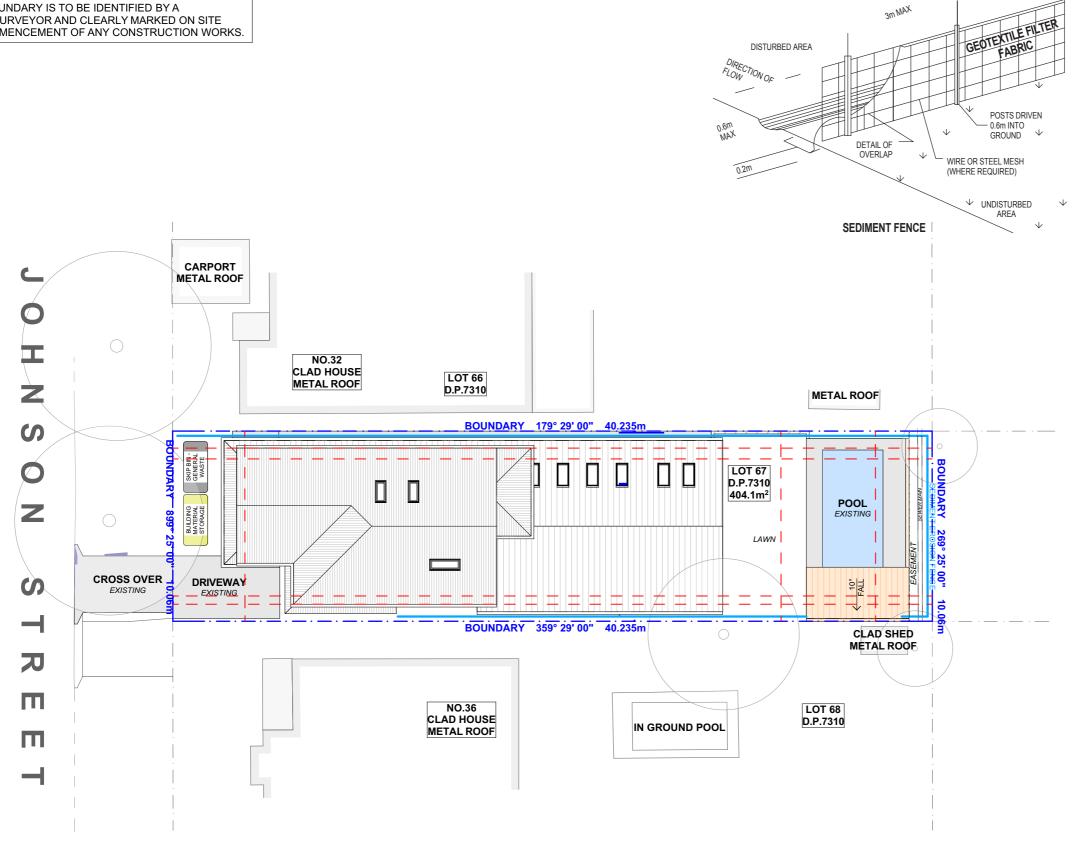

### SITE / ROOF / SEDIMENT EROSION / WASTE MANAGEMENT PLAN 1:200



#### NOTES REGARDING BOUNDARY

THE INFORMATION SHOWN ON THIS PLAN IS FOR DESIGN PURPOSES ONLY. THE POSITION OF BOUNDARY LINES HAVE BEEN ESTABLISHED BY A SURVEY TO MEET THE IDENTIFICATION REQUIREMENTS FOR COUNCIL AND NOT FOR REGISTRATION WITH THE LAND REGISTRATION SERVICES NSW NOR MAY THIS PLAN BE USED FOR ANY OTHER PURPOSE. SUBSEQUENT REGISTERED OR OTHER SURVEYS MAY AFFECT THE DEFINED BOUNDARY POSITIONS IN THIS AREA. ANY DIFFERENCES OF THIS NATURE ARE BEYOND THE PURPOSES OF THIS PLAN. THIS PLAN IS FOR THE ABOVE STATED PURPOSES ONLY. RESTRICTIONS ON THE TITLE HAVE NOT BEEN INVESTIGATED. IF FURTHER DEVELOPMENT IS CONTEMPLATED OR CONSTRUCTION INTENDED THEN IT IS IMPORTANT THAT A SURVEY SET OUT IS CARRIED OUT.

#### DUST CONTROL :

TO REDUCE DUST GENERATED BY WIND ACTION, THE REMOVAL OF THE TOP SOIL IS TO BE MINIMISED. TO PREVENT DUST GENERATION, WATERING DOWN OF THE SITE, ESPECIALLY DURING THE MOVEMENT OF MACHINERY IS REQUIRED. WHERE EXCAVATING INTO ROCK, KEEP THE SURFACE MOIST TO MINIMISE DUST. CONSTRUCT A GRAVEL ENTRY/EXIT POINT USING BLUE METAL AND RESTRICT ALL VEHICLE MOVEMENTS WITHIN THE SITE TO A MINIMUM. ENSURE WIND BREAKS, SUCH AS EXISTING FENCES ARE MAINTAINED DURING THE CONSTRUCTION PHASE UNTIL NEW LANDSCAPING IS PROVIDED OR REINSTATED. PREVENT DUST BY COVERING STOCKPILES

#### SEDIMENT NOTE :

1. ALL EROSION AND SEDIMENT CONTROL MEASURES TO BE INSPECTED AND MAINTAINED DAILY BY THE SITE MANAGER.

2. MINIMISE DISTURBED AREAS, REMOVE EXCESS SOIL FROM EXCAVATEDAREA AS SOON AS POSSIBLE. 3. ALL MATERIAL STOCKPILE TO BE CLEAR FROM DRAINS, GUTTERS AND FOOTPATHS, OR WITHIN SEDIMENT FENCE AREA.

4. DRAINAGE TO BE CONNECTED TO STORMWATER AS SOON AS POSSIBLE. IF STORED ON SITE, IT MUST BE FILTERED BEFORE RELEASING INTO STORMWATER SYSTEM OR WATERWAYS

5. ROADS AND FOOTPATHS TO BE SWEPT DAILY.

#### STOCKPILES :

ALL STOCKPILES ARE TO BE KEPT ON-SITE WHERE POSSIBLE. ANY MATERIALS PLACED ON THE FOOTPATHS OR NATURE STRIPS REQUIRE COUNCIL'S PERMISSION

ALL STOCKPILES ARE TO BE PLACED AWAY FROM THE DRAINAGE LINES AND STREET GUTTERS. IT IS BEST TO LOCATE THESE ON THE HIGHEST PART OF THE SITE IF POSSIBLE. PLACE WATERPROOF COVERING OVER STOCKPILES


IF REQUIRED PROVIDE DIVERSION DRAIN & BANK AROUND STOCKPILES.

**GUTTER PROTECTION :** PROVIDE PROTECTION TO DOWNHILL GRATE IN GUTTER BY MEANS OF SAND BAGS OR BLUE METAL WRAPPED IN GEOTEXTILE FABRIC. WHEN SOIL OR SAND BUILDS UP AROUND THIS SEDIMENT BARRIER, THE MATERIAL SHOULD BE RELOCATED BACK TO THE SITE FOR DISPOSAL

NOTE:	ALL PROPOSED STORMWATER
	TO CONNECT WITH EXISTING

DRAWING NAME SITE / ROOF / SEDIMENT EROSION / WASTE MANAGEMENT / STORMWATER CONCEPT PLAN SCALE 1:200 @A3

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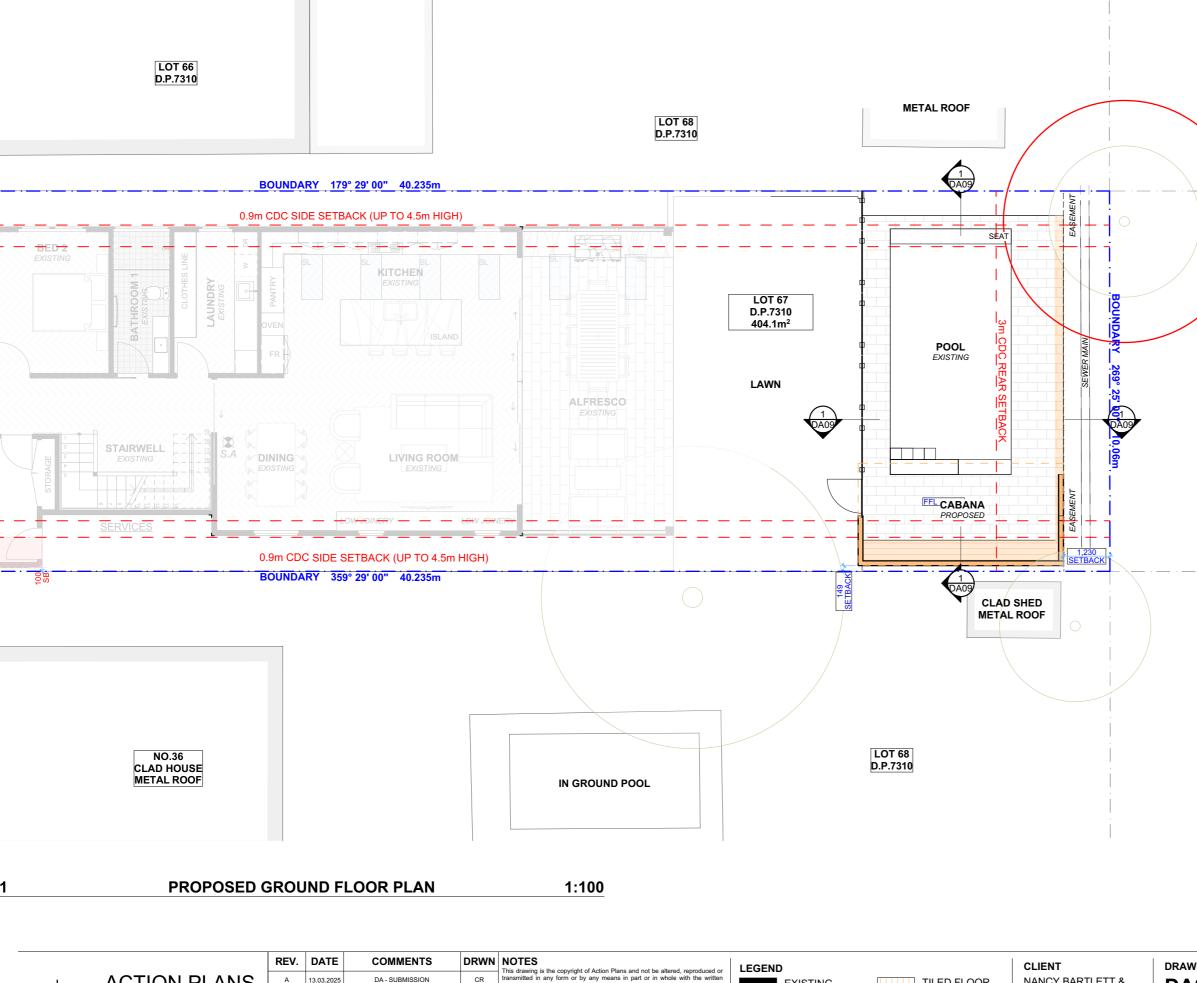
	REV.	DATE	COMMENTS	DRWN	This drawing is the copyright of Action Plans and not be altered, reproduced or	LEGEND		CLIENT	DRAWIN
ACTION PLANS	A	13.03.2025		TILED FLOOR	NANCY BARTLETT &	DA0			
					Do not scale measure from drawings. Figured dimensions are to be used only. The Builder/contractor/owner is to ensure that the approved boundary setbacks and approved levels are confirmed and set out by a registered Surveyor prior to	DEMOLISHED	TIMBER FLOOR	KATE BOCK	
m: 0426 957 518					construction, the boundary setbacks take precedence over all other dimensions. The Builder/Contractor shall check and verify ALL dimensions on site prior to	METAL ROOFING	BRICKWORK		
e:operations@actionplans.com.au					commencement of any work, creation of shop drawings, or fabrication of components.	TILED ROOFING		PROJECT ADDRESS	DATE
w: www.actionplans.com.au					All errors and omissions are to be verified by the Builder/Contractor/client and referred to the designer prior to the commencement of works.	TIMBER STUD		34 JOHNSON STREET, FRESHWATER 2096	Thursday 2025

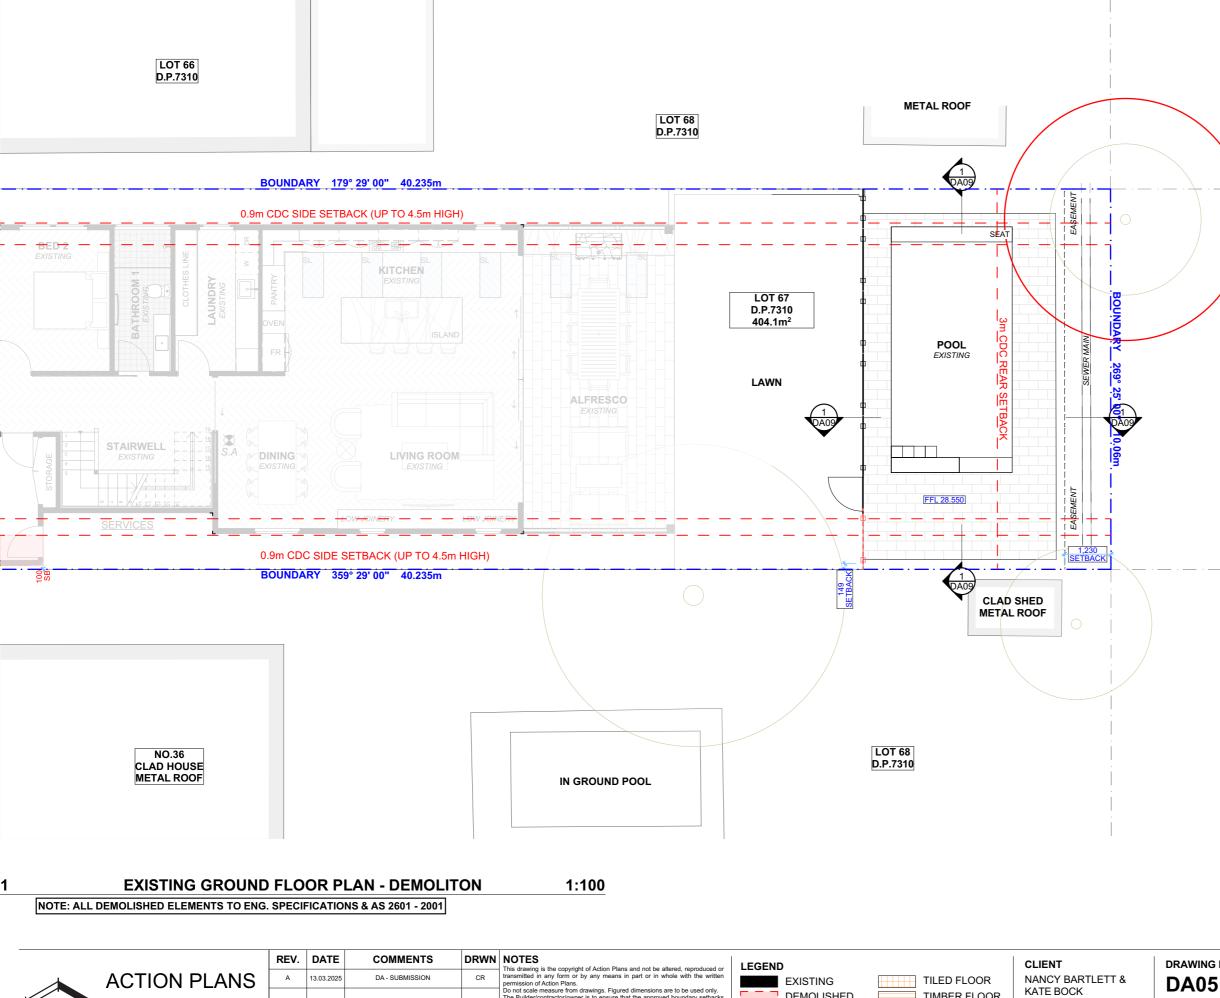RAWING NO.

DRAWING NAME EXISTING GROUND FLOOR PLAN



ursday, 13 March




	REV.	DATE	COMMENTS	DRVIN	This drawing is the copyright of Action Plans and not be altered, reproduced or	LEGEN	D		CLIENT	DRAWIN
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					Do not scale measure from drawings. Figured dimensions are to be used only. The Builder/contractor/owner is to ensure that the approved boundary setbacks and approved levels are confirmed and set out by a registered Surveyor prior to		DEMOLISHED	TIMBER FLOOR	KATE BOCK	DAV
m: 0426 957 518		construction, the boundary setbacks take precedence over	construction, the boundary setbacks take precedence over all other dimensions. The Builder/Contractor shall check and verify ALL dimensions on site prior to		METAL ROOFING	BRICKWORK				
e:operations@actionplans.com.au					commencement of any work, creation of shop drawings, or fabrication of components.		TILED ROOFING		PROJECT ADDRESS	DATE
w: www.actionplans.com.au	om.au				All errors and omissions are to be verified by the Builder/Contractor/client and referred to the designer prior to the commencement of works.		] TIMBER STUD		34 JOHNSON STREET, FRESHWATER 2096	Thursday 2025

RAWING NO. A06

DRAWING NAME PROPOSED GROUND FLOOR PLAN



ursday, 13 March

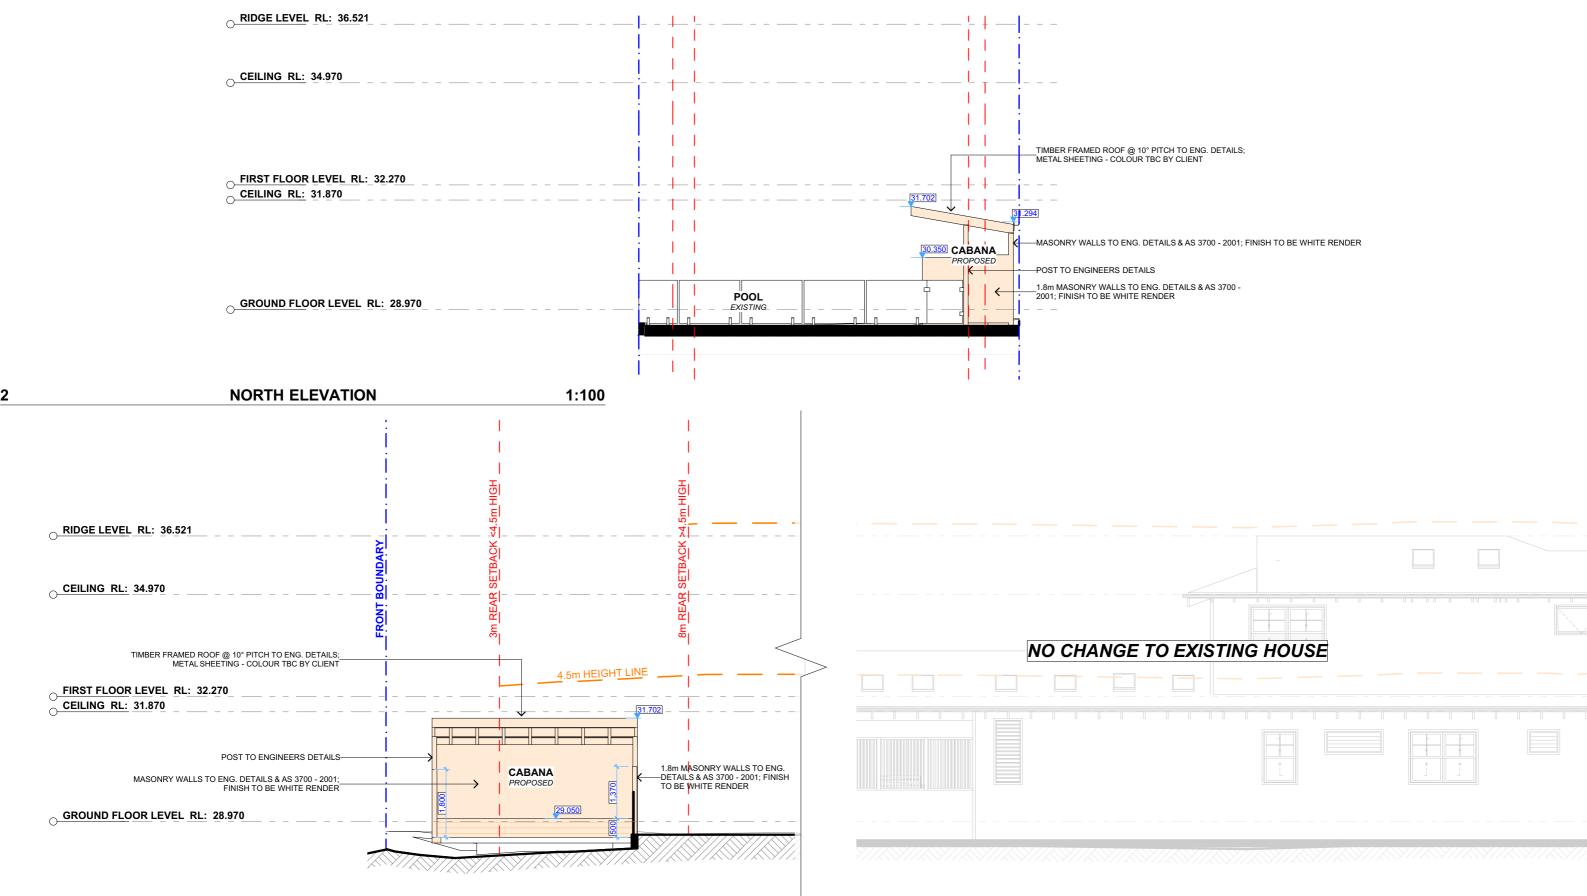

#### **EAST ELEVATION - SIDE**

1:100




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ACTION PLANS	A	13.03.2025	DA - SUBMISSION	SION CR transmi permise	transmitted in any form or by any means in part or in whole with the written permission of Action Plans.	METAL ROOFING EXISTING	NANCY BARTLETT &	DA0	
I					Do not scale measure from drawings. Figured dimensions are to be used only. The Builder/contractor/owner is to ensure that the approved boundary setbacks and approved levels are confirmed and set out by a registered Surveyor prior to		KATE BOCK	Driv	
m: 0426 957 518 e:operations@actionplans.com.au w: www.actionplans.com.au					construction, the boundary setbacks take precedence over all other dimensions. The Builder/Contractor shall check and verify ALL dimensions on site prior to commencement of any work, creation of shop drawings, or fabrication of components. All errors and omissions are to be verified by the Builder/Contractor/client and referred to the designer prior to the commencement of works.	TIMBER CLAD			
						components.	BRICKWORK	PROJECT ADDRESS	DATE
						CONCRETE	34 JOHNSON STREET, FRESHWATER 2096	Thursday 2025	

RAWING NO. DA07

DRAWING NAME NORTH / EAST ELEVATION


hursday, 13 March

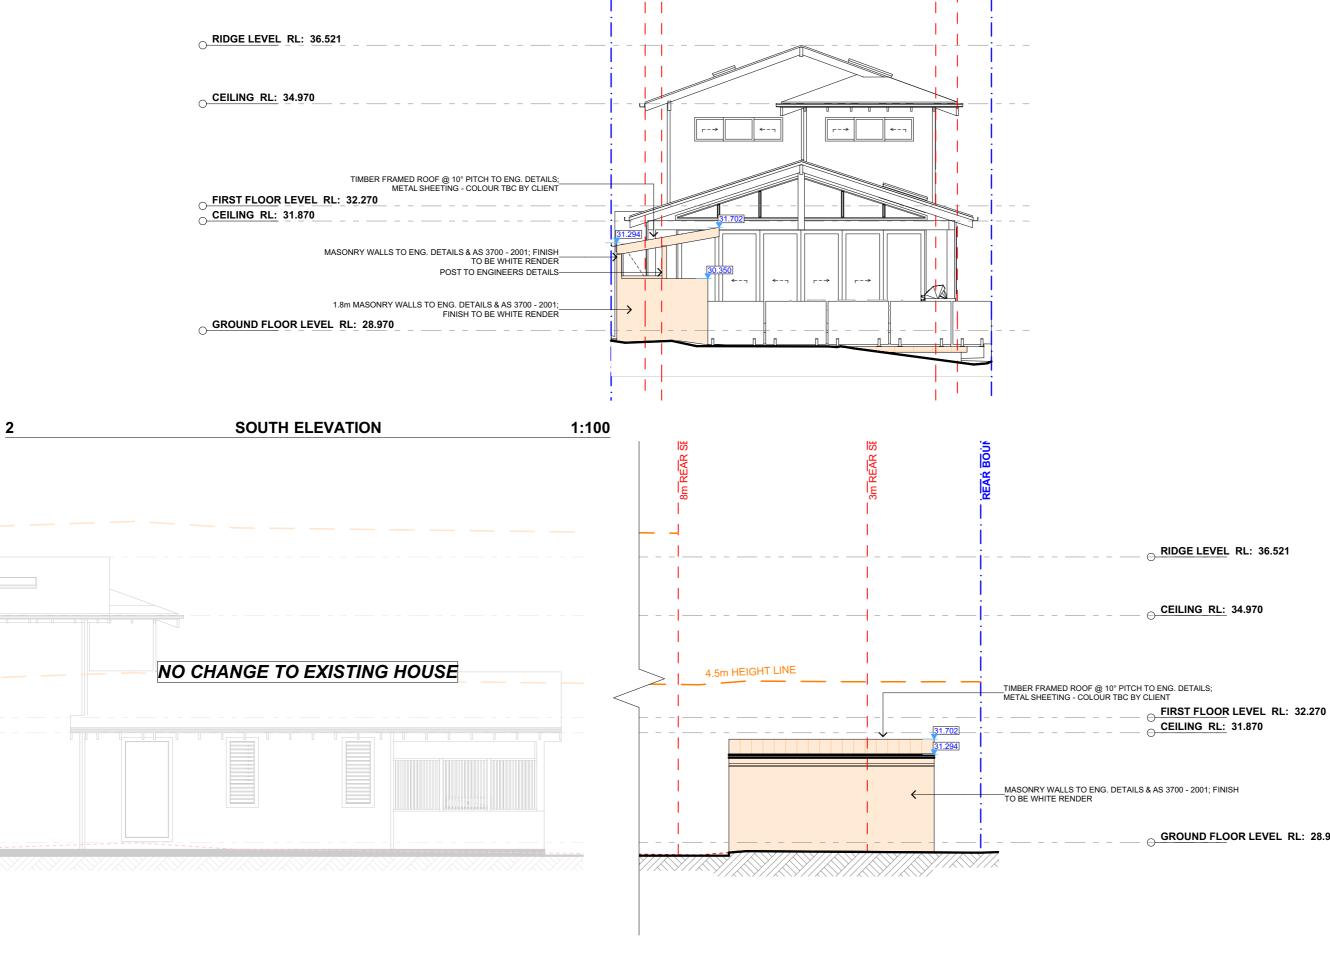

### WEST ELEVATION - SIDE

1

1:100

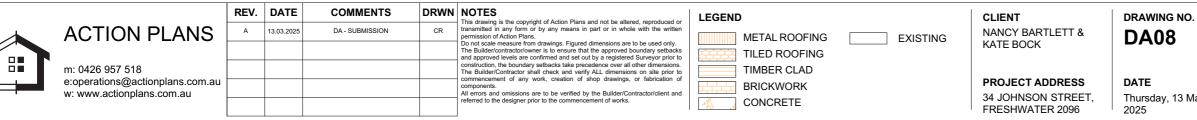



SCALE Thursday, 13 March 1:100 @A3

DRAWING NAME SOUTH / WEST ELEVATION

GROUND FLOOR LEVEL RL: 28.970

\_ RIDGE LEVEL RL: 36.521

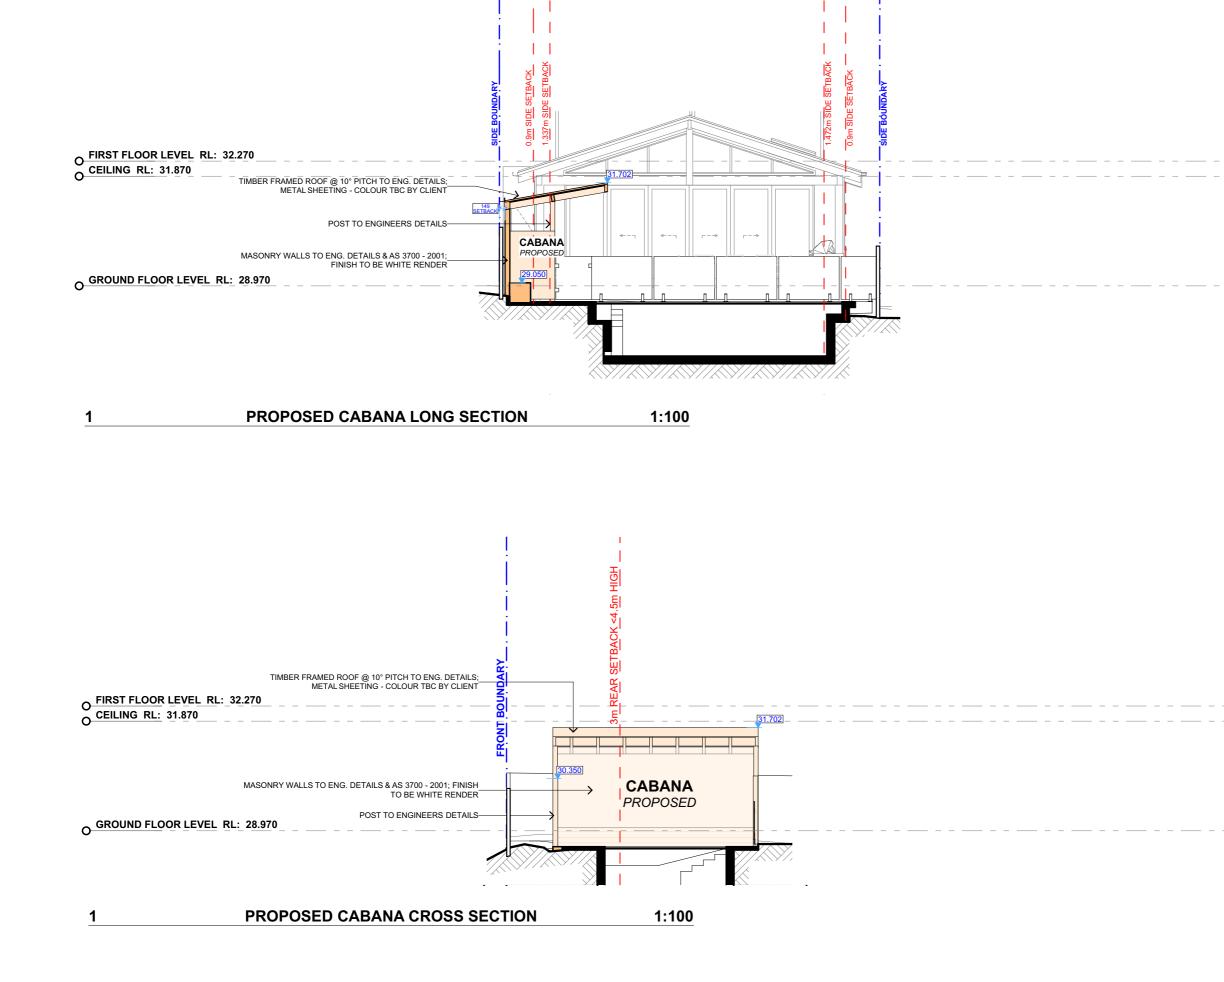


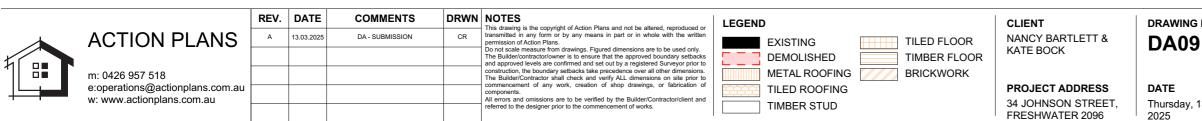

DRAWING NO.

DRAWING NAME LONG / CROSS SECTION

Thursday, 13 March

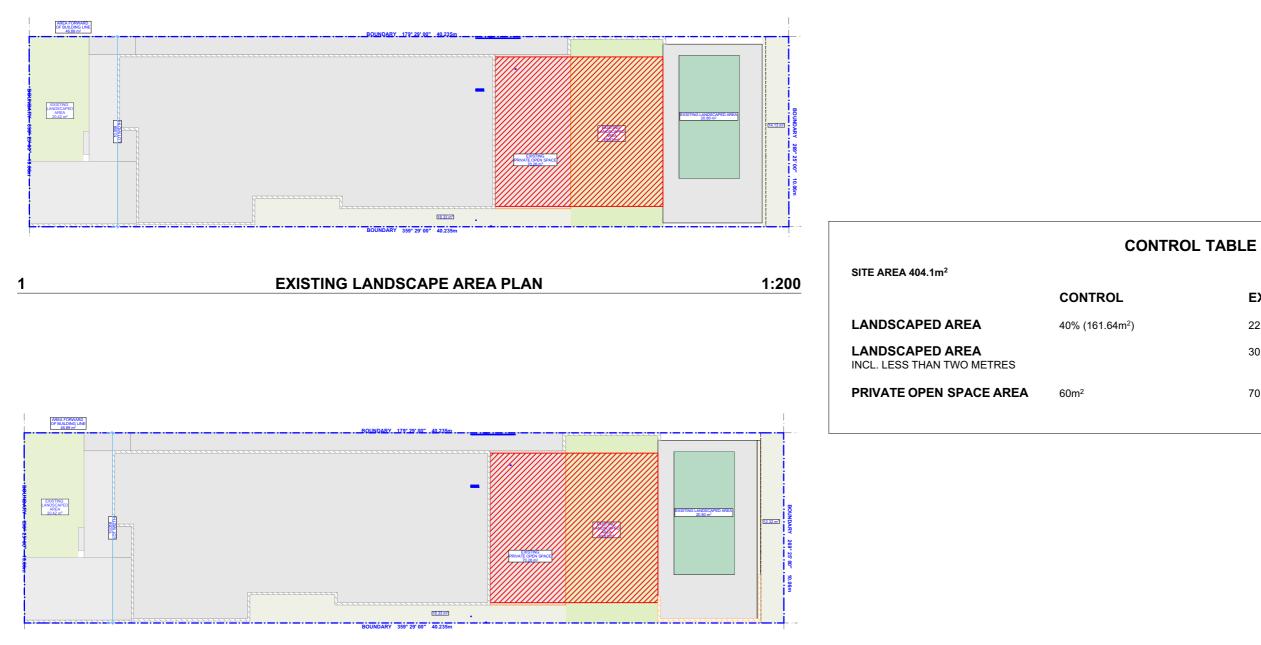

PROPOSED LANDSCAPED AREA PLAN

1:200

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	m: 0426 957 518 e:operations@actionplans.com.au w: www.actionplans.com.au							KATE BOCK	
								PROJECT ADDRESS	DATE
								34 JOHNSON STREET, FRESHWATER 2096	Thursday 2025

#### EXISTING

22.4% (90.85m<sup>2</sup>) 30.5% (123.31m<sup>2</sup>)

70.26m<sup>2</sup>

#### PROPOSED

UNCHANGED

30% (121.5m<sup>2</sup>)


UNCHANGED

VING NO. 10

DRAWING NAME AREA CALCULATIONS




day, 13 March

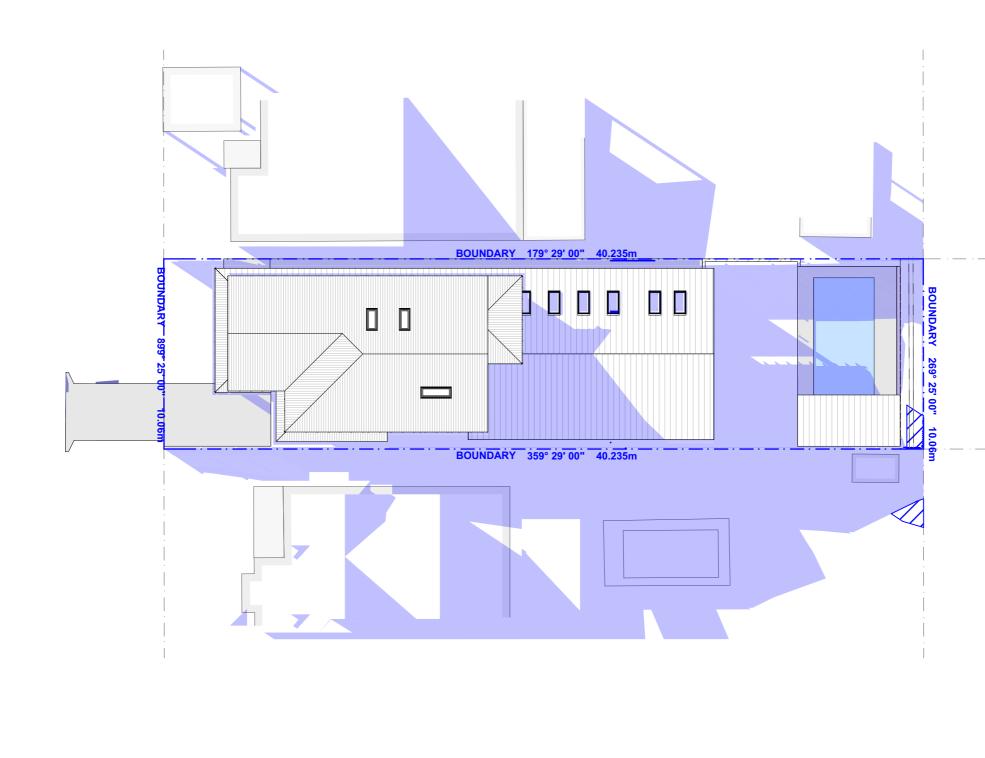

1

WINTER SOLSTICE 9AM


1:200

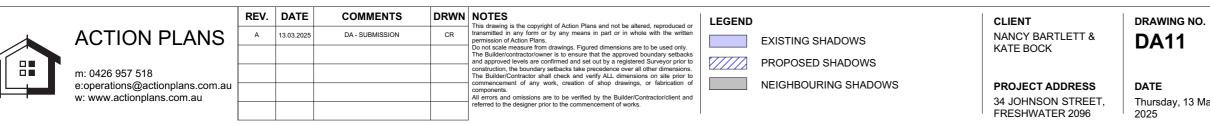


DRAWING NAME WINTER SOLSTICE 9 AM



Thursday, 13 March

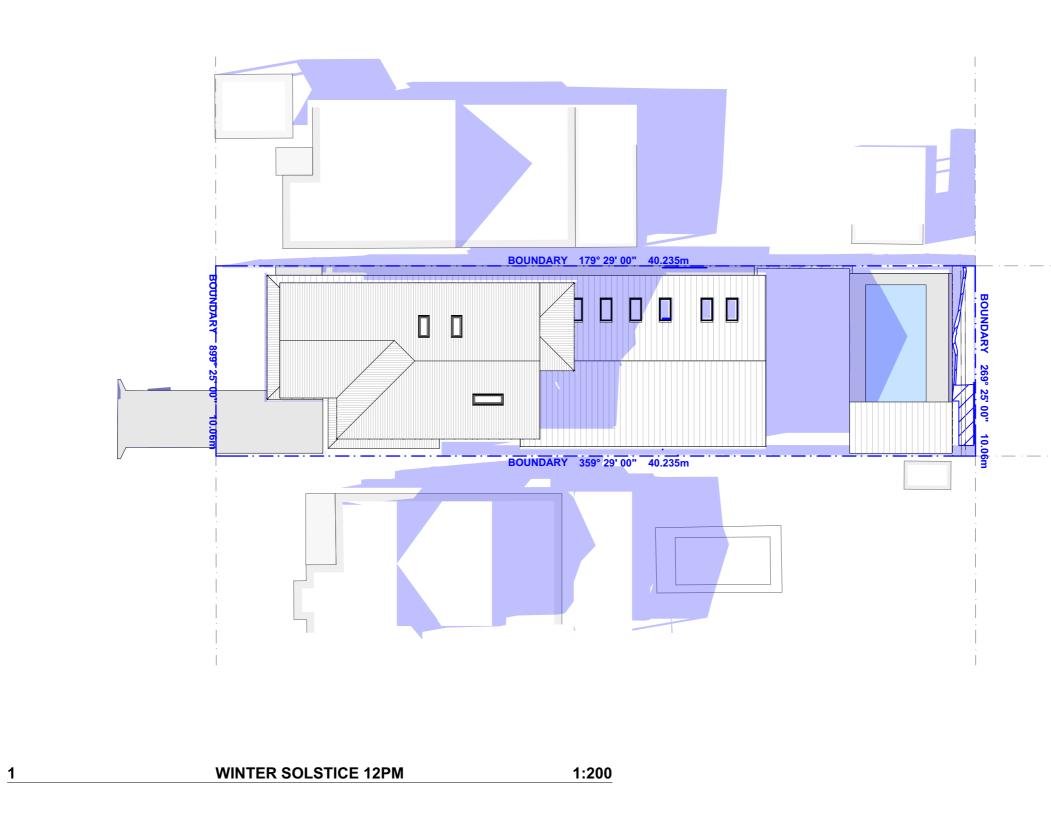

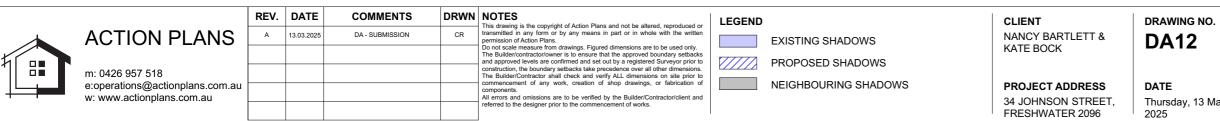


DRAWING NAME WINTER SOLSTICE 12 PM



Thursday, 13 March




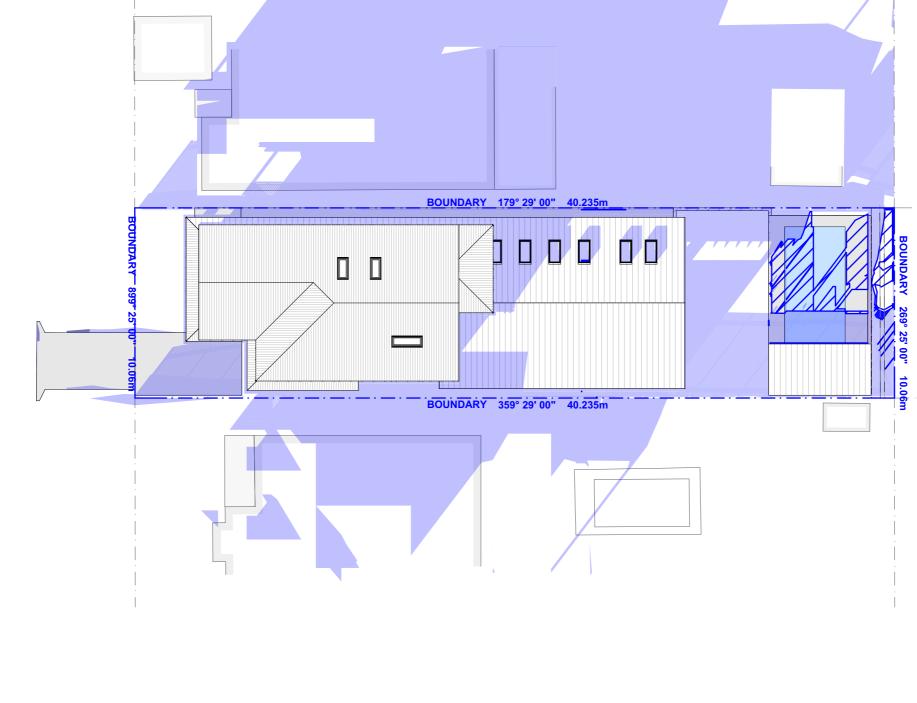

1

WINTER SOLSTICE 3PM

1:200

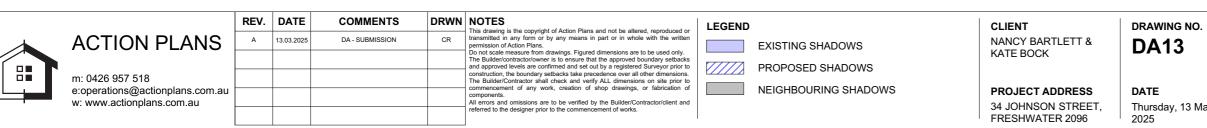

DRAWING NAME WINTER SOLSTICE 3 PM



Thursday, 13 March

## **BASIX** Certificate

Building Sustainability Index www.basix.nsw.gov.au

### Alterations and Additions

Certificate number: A1783559

This certificate confirms that the proposed development will meet the  $\ensuremath{\mathsf{NSW}}$ government's requirements for sustainability, if it is built in accordance with the commitments set out below. Terms used in this certificate, or in the commitments, have the meaning given by the document entitled "BASIX Definitions" dated 10/09/2020 published by the Department. This document is available at www.basix.nsw.gov.au

Secretary Date of issue: Friday, 14 February 2025 To be valid, this certificate must be lodged within 3 months of the date of issue.



Project name	#1197_24JOHNSON ST FRESHWATER_NANCY BARTLETT & KATE BLOCK						
Street address	34 JOHNSON Street FRESHWATER 2096						
Local Government Area	Northern Beaches Council						
Plan type and number	Deposited Plan DP7310						
Lot number	67						
Section number	-						
Project type							
Dwelling type	Dwelling house (detached)						
Type of alteration and addition	I want a BASIX Certificate for optional compliance. This means I won't have to comply with any existing Council energy and water efficiency provisions.						
N/A	N/A						
Certificate Prepared by	ease complete before submitting to Council or PCA)						
Name / Company Name: ACTION PLANS PTY LTD							

ABN (if applicable): 55660046711

Project address

#### Legend

In these commitments, "applicant" means the person carrying out the development

Commitments identified with a V in the "Show on DA plans" column must be shown on the plans accompanying the development application for the proposed development (if a development application is to be lodged for the proposed development).

Commitments identified with a V in the "Show on CC/CDC plans & specs" column must be shown in the plans and specifications accompanying the application for a construction certificate / complying development certificate for the proposed development.

Commitments identified with a V in the "Certifier check" column must be certified by a certifying authority as having been fulfilled, before a final occupation certificate for the development may be issued.

Construction			Show on DA Plans	Show on CC/CDC Plans & specs	Certifier Check
nsulation requirements					
listed in the table below, except that a) add	tered construction (floor(s), walls, and ceilings/ ditional insulation is not required where the are s of altered construction where insulation alrea	a of new construction is less than 2m2, b)	~	~	~
Construction	Additional insulation required (R- value)	Other specifications			
external wall: framed (weatherboard, fibro, metal clad)	R1.30 (or R1.70 including construction)				
raked ceiling, pitched/skillion roof: framed	ceiling: R2.50 (up), roof: foil/sarking	medium (solar absorptance 0.475 - 0.70)	1		

			REV.	DATE	COMMENTS	DRWN	NOTES This drawing is the copyright of Action Plans and not be altered, reproduced or transmitted in any form or by any means in part or in whole with	CLIENT	DRAV
	ACTION PLANS	A	13.03.2025	DA - SUBMISSION	CR	the written permission of Action Plans. Do not scale measure from drawings. Figured dimensions are to be used only. NANC1	NANCY BARTLETT &	DA	
							Surveyor prior to construction, the boundary setbacks take precedence over all other dimensions. The Builder/Contractor shall check and verify ALL dimensions on site prior to commencement of any work, creation of shop drawings, or	KATE BOCK	
*	m: 0426 957 518					fabrication of components. All errors and omissions are to be verified by the Builder/Contractor/client and referred to the designer prior to the			
╨╌┾╾┛	e:operations@actionplans.com.au w: www.actionplans.com.au					commencement of works. All window & door dimensions, orientation, glazing materials, opening types, frame types are to be confirmed by a suitably qualified person prior to the ordering of any such materials are to take place. U value takes precedence over glazing type/colour in all	PROJECT ADDRESS	DATE	
						cases. all new glazing must meet the BASIX specified frame and glass type, <u>OR</u> meet the ecified U value and SHGC value.	34 JOHNSON STREET,	Thurso	
								FRESHWATER 2096	2025



WING NO. 15

DRAWING NAME BASIX COMMITMENTS