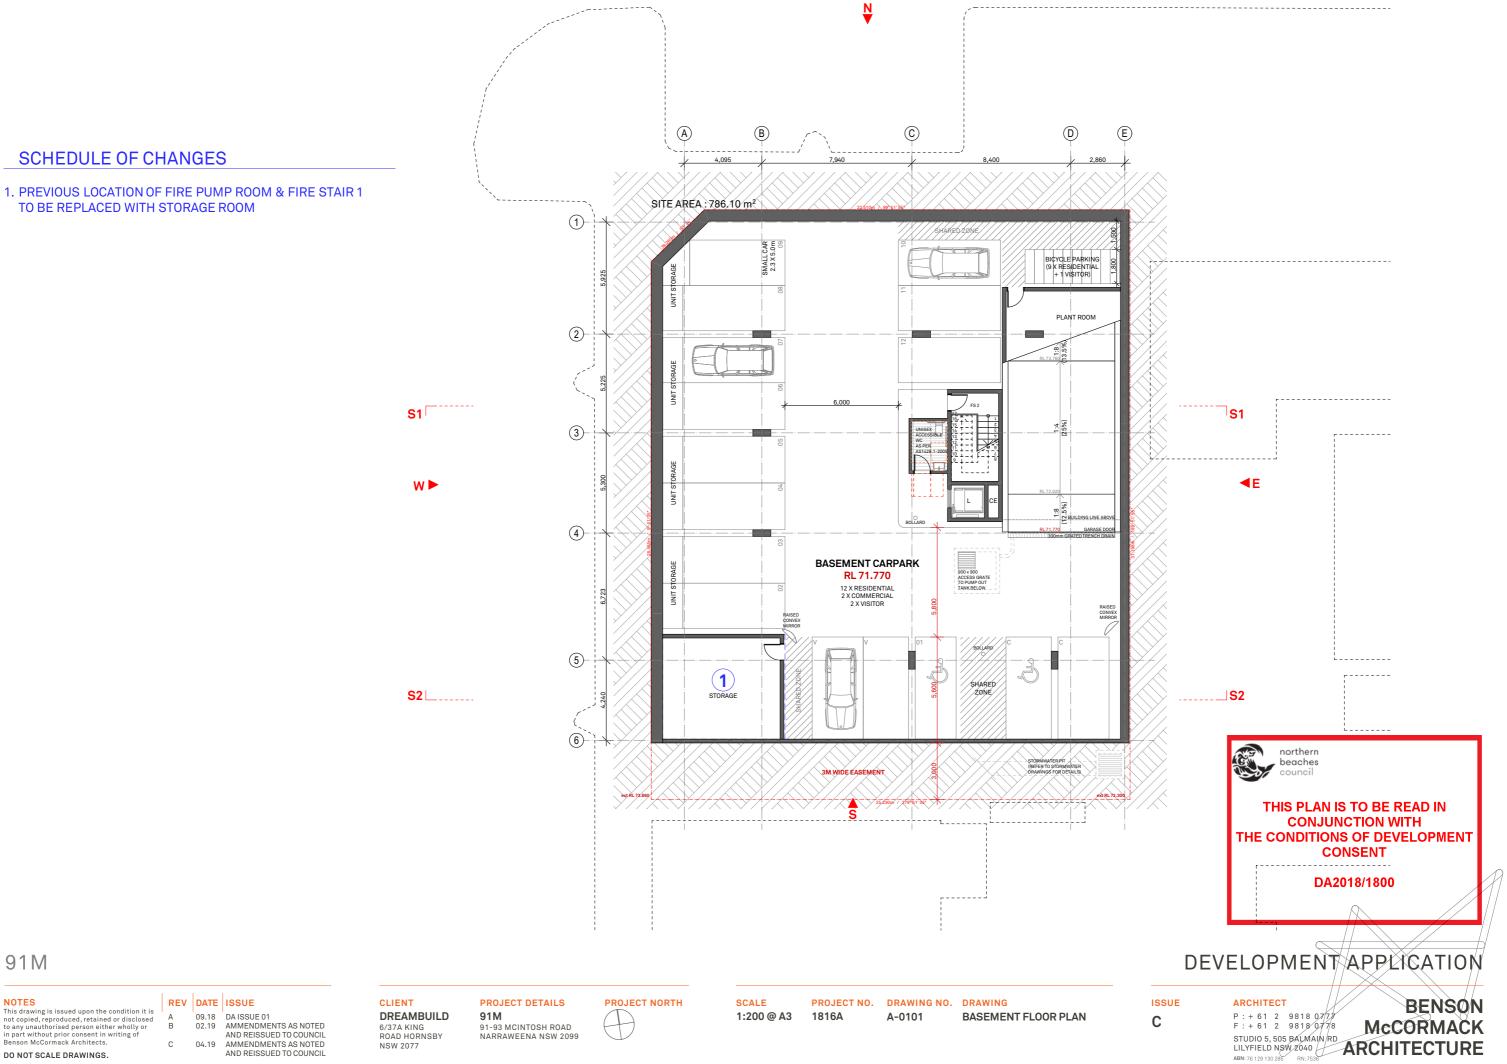


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91M

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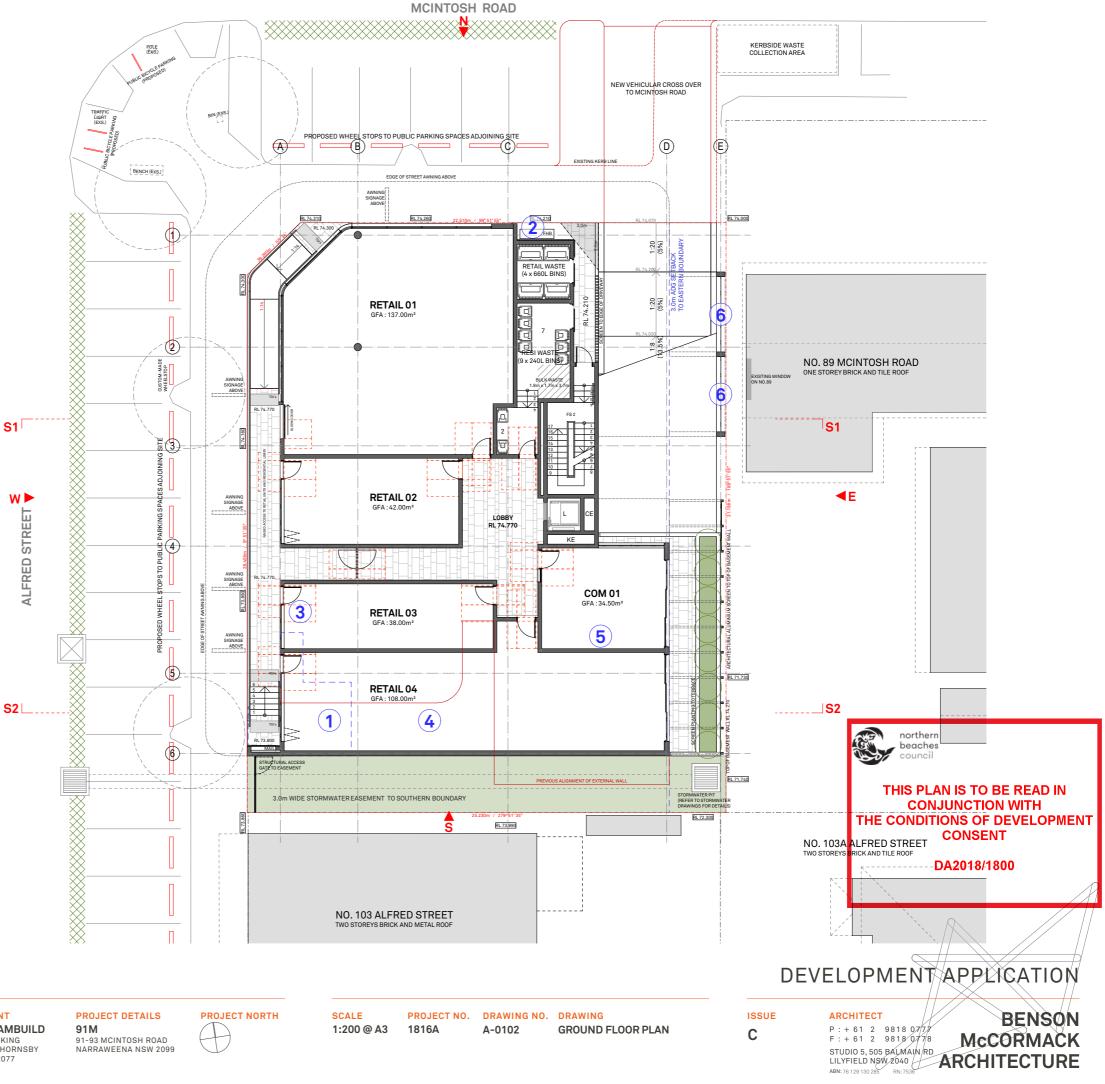
А

В

С

SCHEDULE OF CHANGES

- 1. PREVIOUS LOCATION OF FIRE HYDRANT BOOSTER & FIRE STAIR 1
- 2. PROPOSED LOCATION OF FIRE HYDRANT BOOSTER
- 3. AMENDMENTS TO AREA AND FRONT FACADE OF RETAIL 03
- 4. PROPOSED AREA OF RETAIL 04
- 5. PROPOSED AREA OF COM1 AND REMOVAL OF COM 2
- 6. PROPOSED POLYCARBONATE ACOUSTIC BARRIER AT 2.2M (HEIGHT) x 4M (LENGTH) x 10MM (THICK) TO ACOUSTIC CONSULTANT SPECIFICATION



91M

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В

AMMENDMENTS AS NOTED 02.19 AND REISSUED TO COUNCIL С 04.19 AMMENDMENTS AS NOTED AND REISSUED TO COUNCIL

CLIENT DREAMBUILD 6/37A KING ROAD HORNSBY NSW 2077



ALE	PROJECT NO.	DRAWING NO.	DRAWING
200 @ A3	1816A	A-0102	GROUND FLOOR PLAN

SCHEDULE OF CHANGES

- 1. CIRCULATION DOOR CLEARANCES AS SHOWN TO UNIT 01 THIS HAS RESULTED IN MINOR CHANGES TO THE ENTRY OF UNITS 01 AND 02
- 2. UNIT BALCONY SIZES ADDED AND AMENDED AS SHOWN FROM PREVIOUS ISSUE
- 3. MINOR INCREASE IN SIZE TO UNIT 06 DUE TO EXTERNAL WALL CHANGES AT LEVEL 2
- 4. REDUCTION IN LENGTH OF STREET AWNING TO ALFRED ST TO ACCOMODATE 3M WDIE EASEMENT TO SOUTHERN BOUNDARY
- 5. MINOR AMENDMENTS TO CORE CONFIGURATION

S2

S1

W 🕨

STREET

ALFRED

2

PRIVATE OPEN SPACE

	UNIT NO.	BALCONY DIMENSION	BALCONY AREA (m ²)
FIRST FLOOR	UNIT 01	3350 W x 3000D	10m ²
	UNIT 02	3350 W x 3000D	10m ²
	UNIT 03	2650 W x 3020D	8m ²
	UNIT 04	2650 W x 3020D	8m ²
	UNIT 05	4880 W x 2400D	11.7m ²
	UNIT 06	3600 W x 3620D	12.7m ²
SECOND FLOOR	UNIT 07	2530 MIN. DEPTH	76.1m ²
	UNIT 08	9650 W x 2530D	24.5m ²
	UNIT 09	6150 W x 2530D	25.9m ²

91M

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REV DATE ISSUE 09.18 DA ISSUE 01 А В 02.19 AMMENDMENTS AS NOTED AND REISSUED TO COUNCIL С 04.19 AMMENDMENTS AS NOTED AND REISSUED TO COUNCIL

CLIENT DREAMBUILD 6/37A KING ROAD HORNSBY NSW 2077




91-93 MCINTOSH ROAD NARRAWEENA NSW 2099




JECT	NORTH	
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ALE .	PROJECT NO.	DRAWING NO.	DRAWING
00 @ A3	1816A	A-0103	1ST FLOOR PLAN

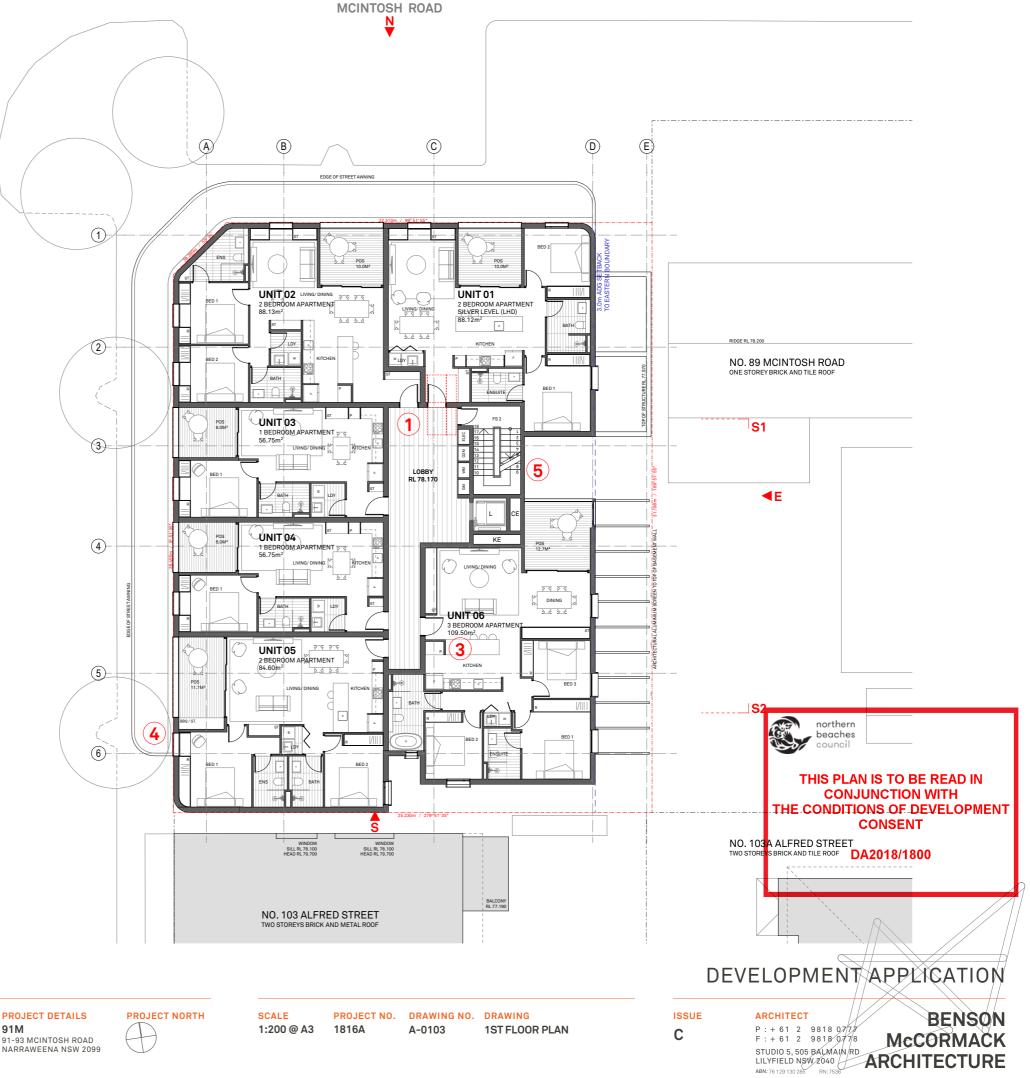

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3


FIRST FLOOR

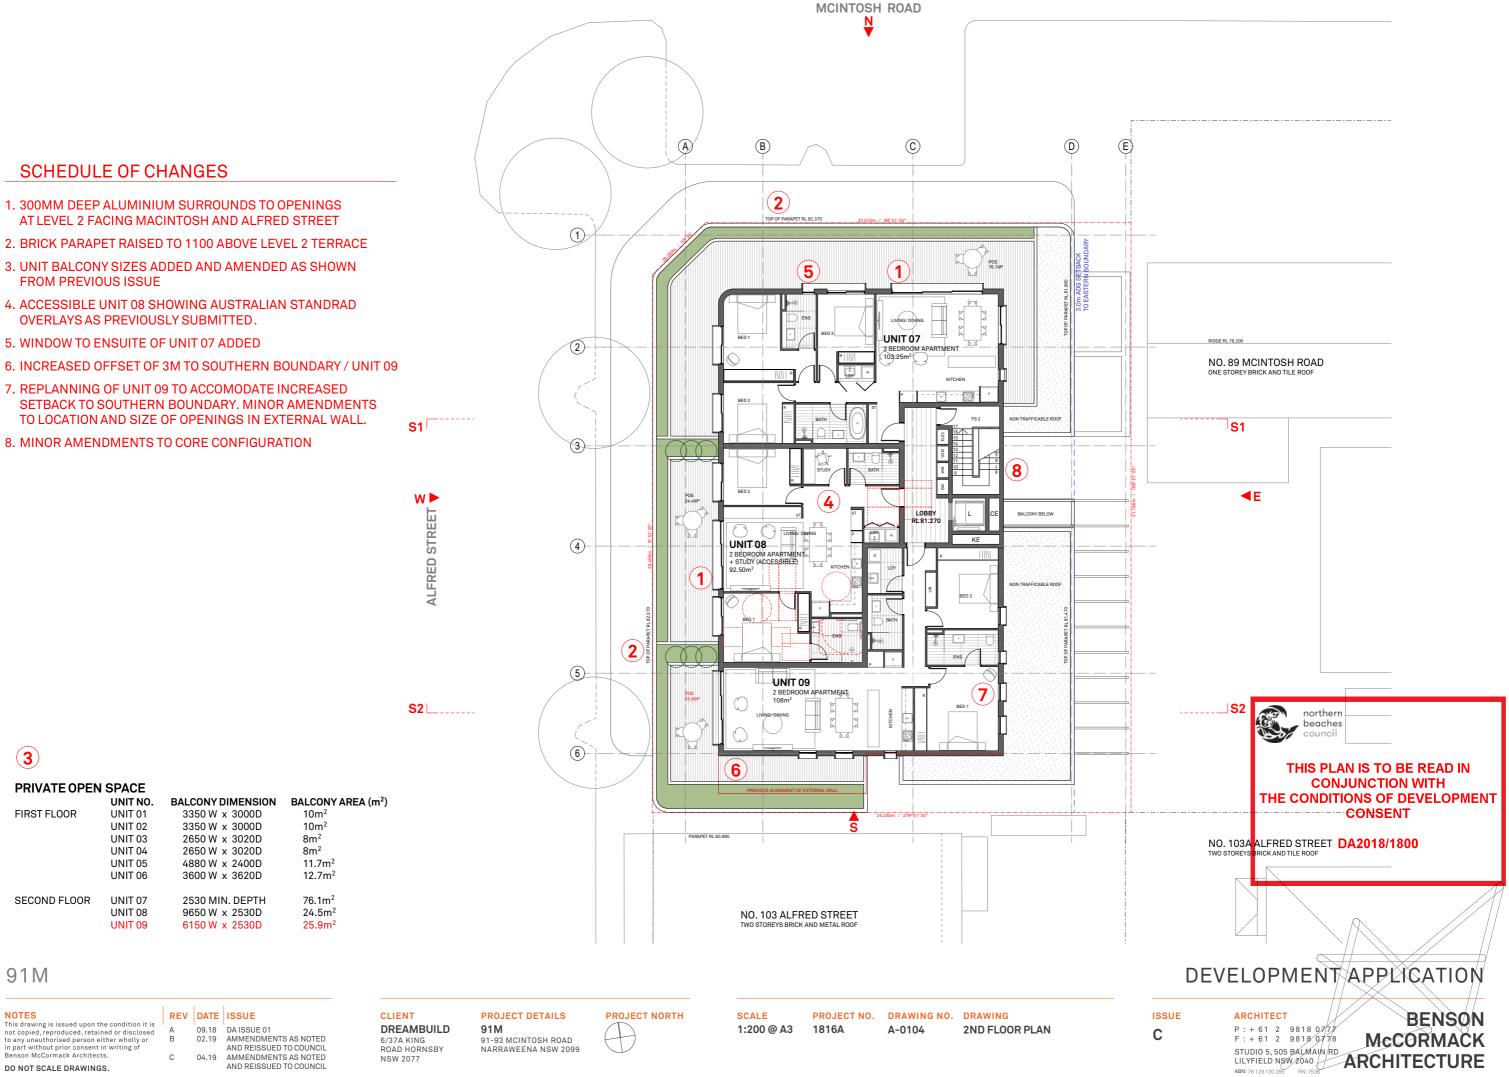SECOND FLOOR

- NOTES
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T NORTH	SCA
	1:2

ALE	PROJECT NO.	DRAWING NO.	DRAWING
200 @ A3	1816A	A-0104	2ND FLOOR PLAN

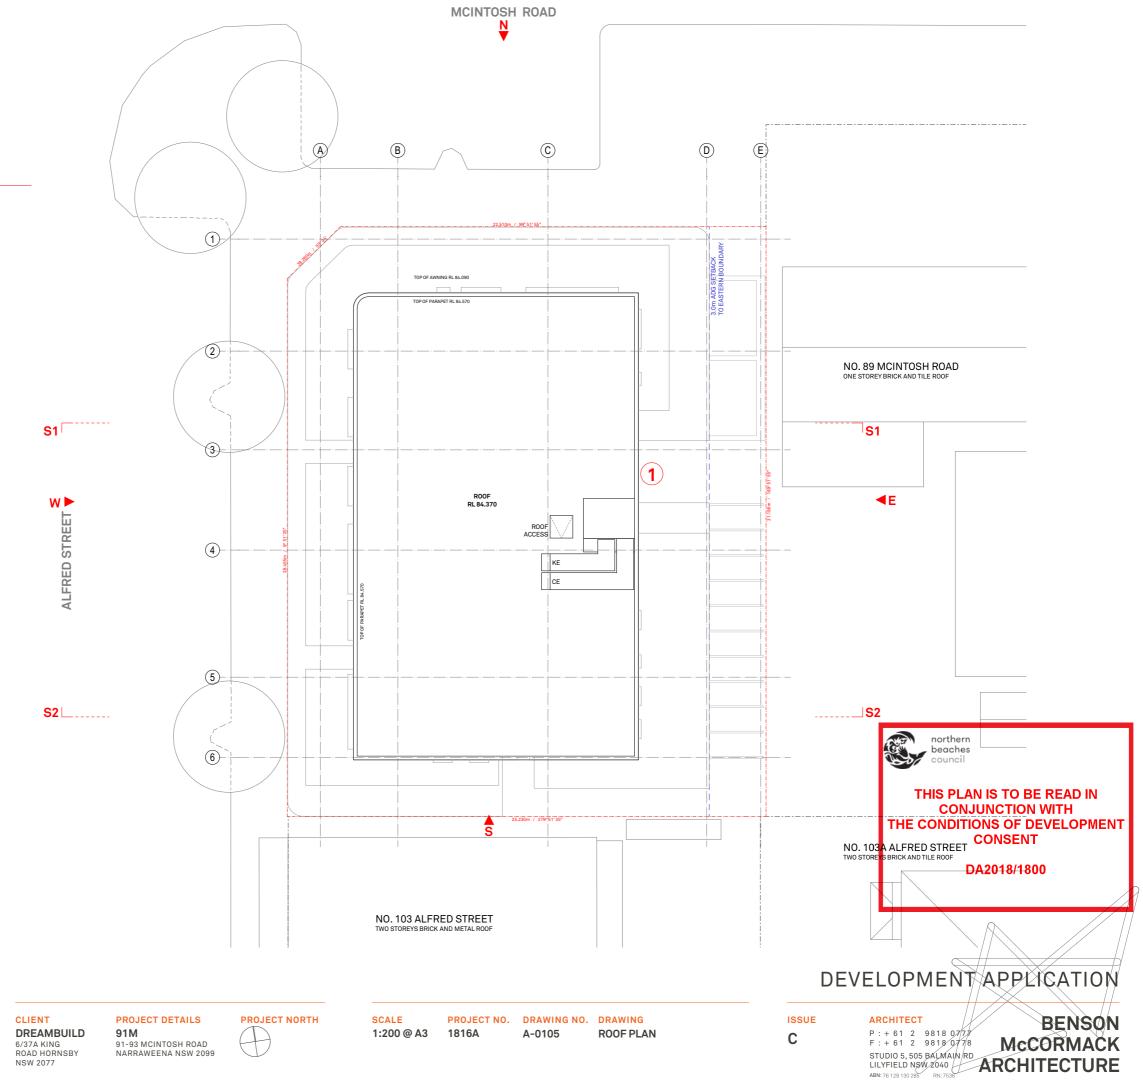

SCHEDULE OF CHANGES

1. MINOR AMENDMENTS TO CORE CONFIGURATION AND ROOFTOP PLANT

91M

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A B 09.18 DA ISSUE 01 02.19 AMMENDMENTS AS NOTED AND REISSUED TO COUNCIL 04.19 AMMENDMENTS AS NOTED С AND REISSUED TO COUNCIL

SCALE	PROJECT NO.	DRAWING NO.	DRAWING
1:200 @ A3	1816A	A-0105	ROOF PLAN

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MATERIAL BUILT FORM

91M

91-93 MCINTOSH ROAD NARRAWEENA NSW 2099

91M

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CLIENT DREAMBUILD 6/37A KING ROAD HORNSBY NSW 2077

PROJECT DETAILS


PROJECT NORTH

SCALE PROJECT NO. DRAWING NO. DRAWING 1:100 @ A3 1816A A-0201 MCINTOSH RD ELEVATION

SCHEDULE OF CHANGES

2. PROPOSED LOCATION OF FIRE HYDRANT BOOSTER

ARY	
SITE BOUNDARY	
SITE	LEVEL ROOF
	RL 84.370
	FBK 2
	ALU 1
	8.5m MAX HEIGHT OF BUILDING
	TOP OF PARAPET RL 82.370
	LEVEL 2
	RL 81.270
	FBK 1 (CORBEL)
	AWN 1 LEVEL 1
	U/S OF AWNING RL77.470
	mac the knife
	UNDER AWNING SIGNAGE
	RECESSED MAILBOX WITHIN BATTENED SCREEN W.
	STW 1
$\Delta \Delta$	GROUND LEVEL
	RL 74.770
	BASEMENT 1
	RL71.770
	northern
	Ga beaches
	council
	THIS PLAN IS TO BE READ IN
	CONJUNCTION WITH
	THE CONDITIONS OF DEVELOPMENT
	CONSENT
	DA2018/1800
	\cap
	DEVELOPMENTAPPLICATION
ISSUE	ARCHITECT P:+61 2 9818 07/7
С	F:+61 2 9818 0778 MCCORMACK
	STUDIO 5, 505 BALMAIN RD LILYFIELD NSW 2040 ABN: 78 190 285 RN: 758

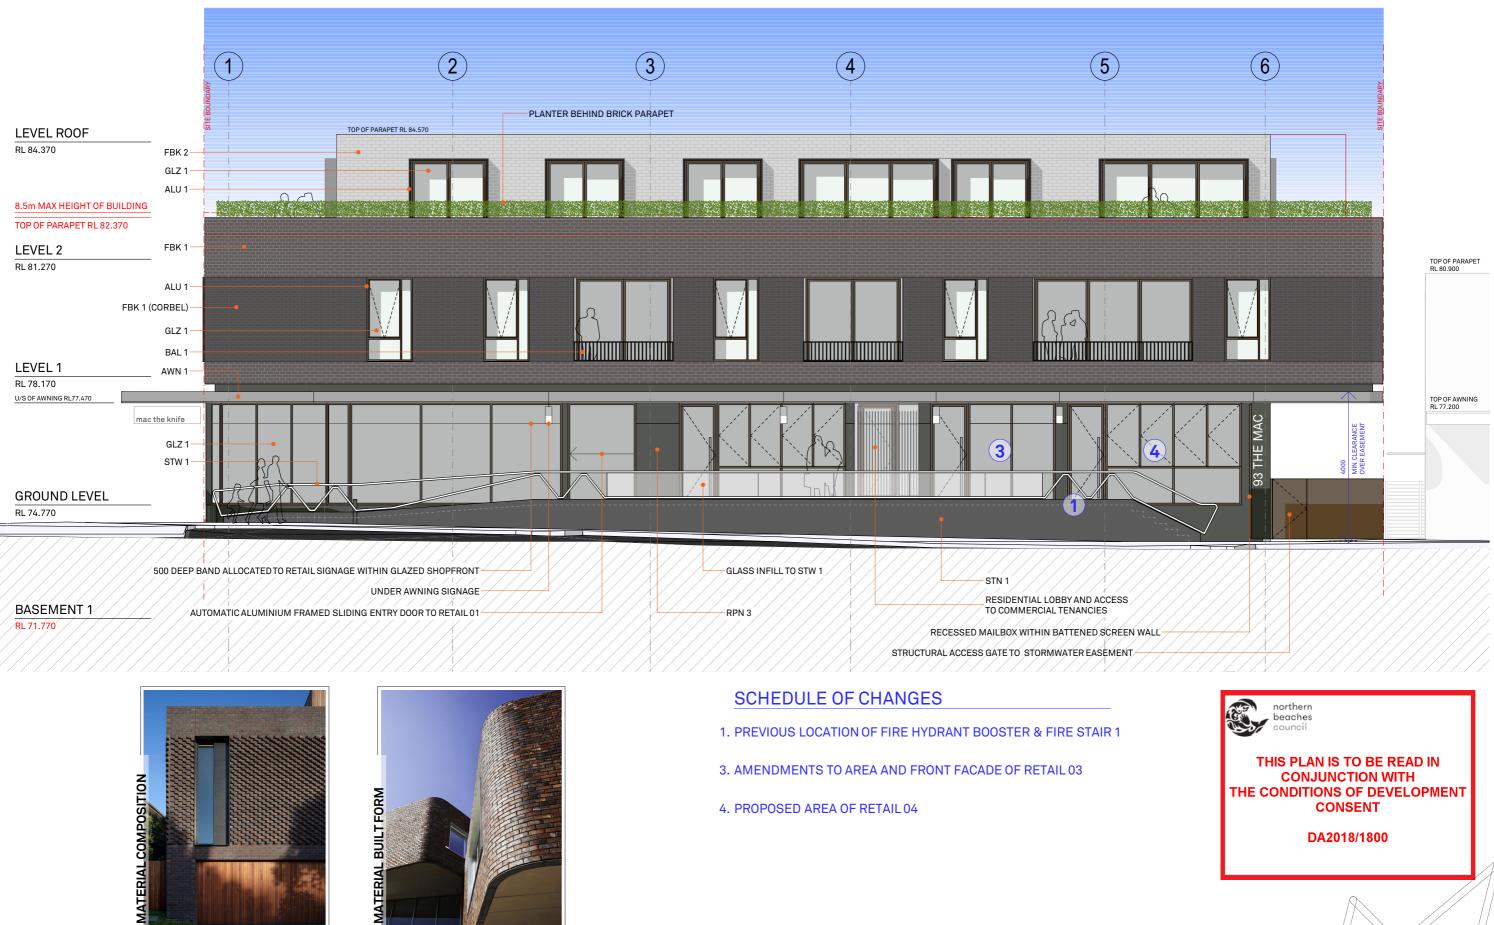



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С

02.19 AMMENDMENTS AS NOTED AND REISSUED TO COUNCIL 04.19 AMMENDMENTS AS NOTED AND REISSUED TO COUNCIL CLIENT DREAMBUILD 6/37A KING ROAD HORNSBY NSW 2077

PROJECT DETAILS

PROJECT NORTH

SCALE PROJECT NO. DRAWING NO. DRAWING 1:100 @ A3 1816A A-0202 ALFRED ST ELEVATION

91M 91-93 MCINTOSH ROAD NARRAWEENA NSW 2099



ARCHITECT

ABN: 76 129 130 285

P:+61 2 9818 0777 F:+61 2 9818 0778

STUDIO 5, 505 BALMAIN RD


BENSON McCORMACK LILYFIELD NSW 2040

ISSUE С



BASEMENT PARKING



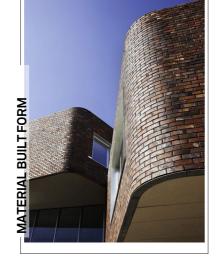

91M

91-93 MCINTOSH ROAD

NARRAWEENA NSW 2099

91M

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С

02.19 AMMENDMENTS AS NOTED AND REISSUED TO COUNCIL 04.19 AMMENDMENTS AS NOTED AND REISSUED TO COUNCIL CLIENT DREAMBUILD 6/37A KING ROAD HORNSBY NSW 2077


PROJECT DETAILS


PROJECT NORTH

SCALE PROJECT NO. DRAWING NO. DRAWING 1:100 @ A3 1816A A-0203 EAST ELEVATION

SCHEDULE OF CHANGES

- 2. PROPOSED LOCATION OF FIRE HYDRANT BOOSTER
- 4. PROPOSED AREA OF RETAIL 04
- 5. PROPOSED AREA OF COM1 AND REMOVAL OF COM 2
- 6. PROPOSED POLYCARBONATE ACOUSTIC BARRIER AT 2.2M (HEIGHT) x 4M (LENGTH) x 10MM (THICK) TO ACOUSTIC CONSULTANT SPECIFICATION

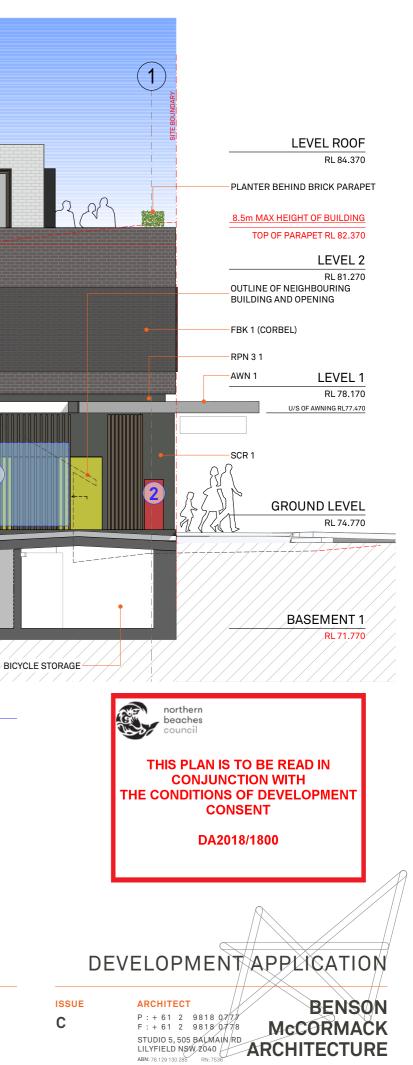

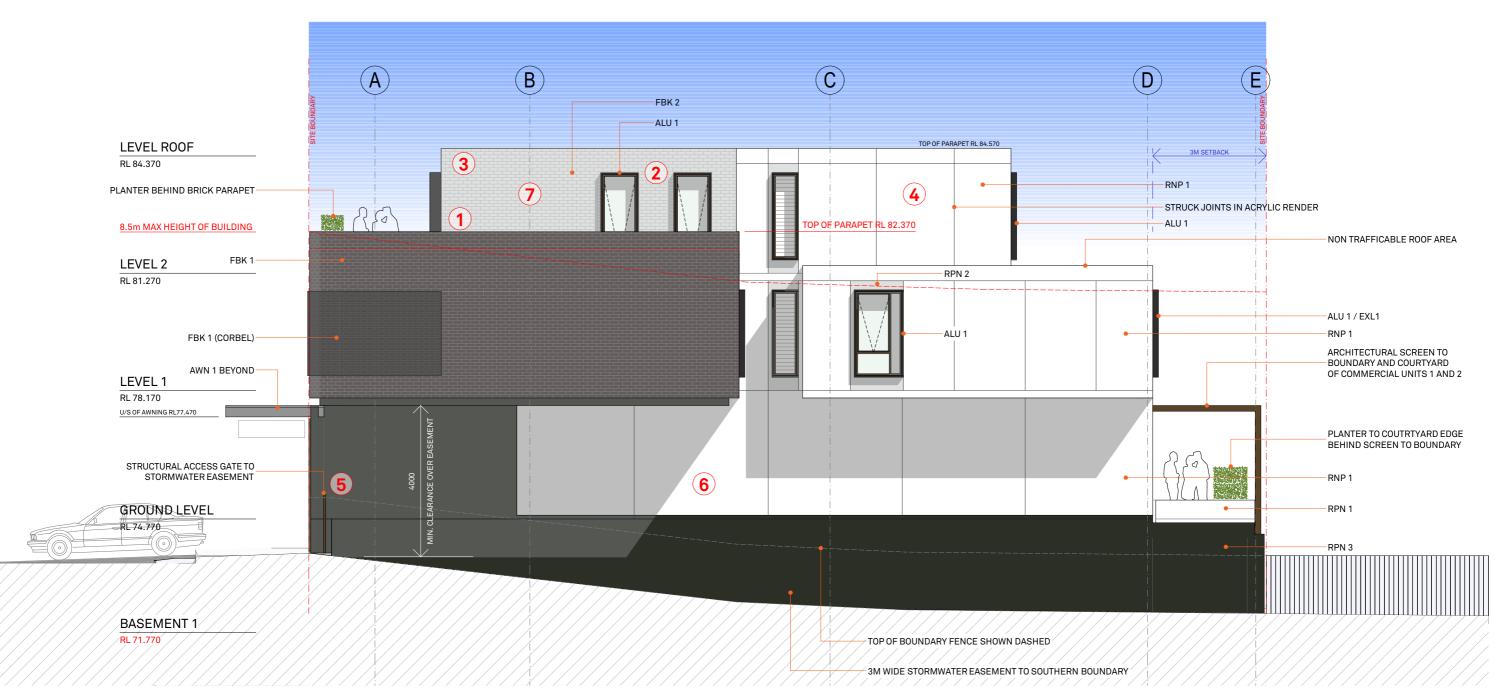



BUILTFORM MATERIAL

91M

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09.18 DA ISSUE 01 А AMMENDMENTS AS NOTED R 02.19 AND REISSUED TO COUNCIL С 04.19 AMMENDMENTS AS NOTED

REV DATE ISSUE

AND REISSUED TO COUNCIL

91M

CLIENT DREAMBUILD 6/37A KING ROAD HORNSBY NSW 2077

PROJECT DETAILS

91-93 MCINTOSH ROAD NARRAWEENA NSW 2099

PROJECT NORTH


SCALE	PROJECT NO.	DRAWING NO.	DRAWING	
1:100 @ A3	1816A	A-0204	SOUTH ELEVATION	

SCHEDULE OF CHANGES

- 1. BRICK PARAPET RAISED TO 1100MM ABOVE TERRACE AT LEVEL 2
- 2. EXTERNAL ALUMINIUM SURROUNDS ADDED TO OPENINGS AT LEVEL 2
- **3. CONTINIOUS AWNING TO LEVEL 2 REMOVED**
- 4.2 X COLOURED ACRYLIC RENDER ADDED. RENDER TO HAVE STRUCK JOINTS AS INDICATED.
- 5. STRUCTURAL ACCESS GATE TO STORMWATER EASEMENT ADDED
- 6. ELEVATIONAL CHANGES TO SOUTHERN FACADE AT GROUND LEVEL TO ACCOMDATE REVISED PLANNING DUE TO INCREASE IN WIDTH OF EASEMENT
- 7. FACEBRICK ADDED TO LEVEL 2. REFER REVISED FINISHES SCHEDULE.

S 1:

CALE	PROJECT NO.	DRAWING NO.	DRAWING
100 @ A3	1816A	A-0204	SOUTH ELEVATIO

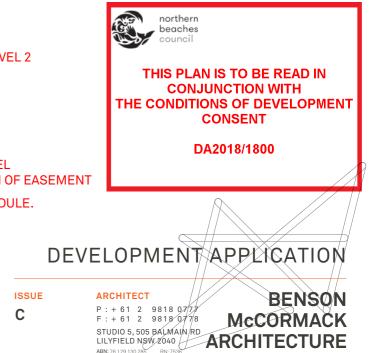



ALU 1 ALUMINIUM - WINDOW/BALCONY SURROUNDS, FINISH SIM/EQ TO DULUX POWDERCOAT 'MONUMENT'



AWN 1 AWNING

ALUMINIUM FASCIA COLOUR SIM/EQ TO DULUX 'EARTHEN POT' AWNING SOFFIT IN FC SHEET PAINT FINISH DULUX 'NARROW NECK'



EXL 1 EXTERNAL LOUVERS FIXED ON WINDOW LOUVERS FINISH SIM/EQ TO DULUX POWDERCOAT 'EARTHEN POT'



FINISH - AUSTRAL BOWRAL BRICKS 'BRAHMAN GRANITE'



FBK 2 FACE BRICKWORK FINISH - AUSTRAL BOWRAL BRICKS 'CHILLINGHAM WHITE'

RNP 1 COLOURED ACRYLIC RENDER COLOUR FINISH DULUX 'SNOWY MOUNTAINS'

RNP 2 COLOURED ACRYLIC RENDER COLOUR FINISH DULUX 'NARROW NECK



ALUMINIUM - BALUSTRADE, BAL 1 FINISH SIM/EQ TO DULUX POWDERCOAT 'MONUMENT' 91M



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SCR 1 ALUMINIUM LOUVERED SCREENS FINISH SIM/EQ TO DULUX DESIGN 'EARTHEN POT'



PROJECT NO. DRAWING NO. DRAWING

A-1301

FINISHES & MATERIALS

PROJECT DETAILS DREAMBUILD 91M 6/37A KING ROAD HORNSBY 91-93 MCINTOSH ROAD NARRAWEENA NSW 2099

CLIENT

NSW 2077


PROJECT NORTH

SCALE

1816A



GLZ 1 CLEAR GLAZED ALUMINIUM FRAMED WINDOWS/DOORS FRAME FINISH SIM/EQ TO DULUX POWDERCOAT 'EARTHEN POT'

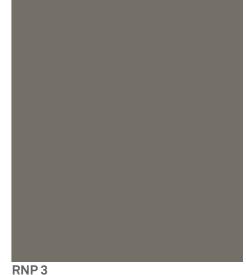

COLOURED ACRYLIC RENDER COLOUR FINISH DULUX 'ORGANIC'

DEVELOPMENT APPLICATION

LILYFIELD NSW 2040

BENSON

McCORMACK


ARCHITECT

ABN: 76 129 130 28

P:+61 2 9818 0777 F:+61 2 9818 0778

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ISSUE С



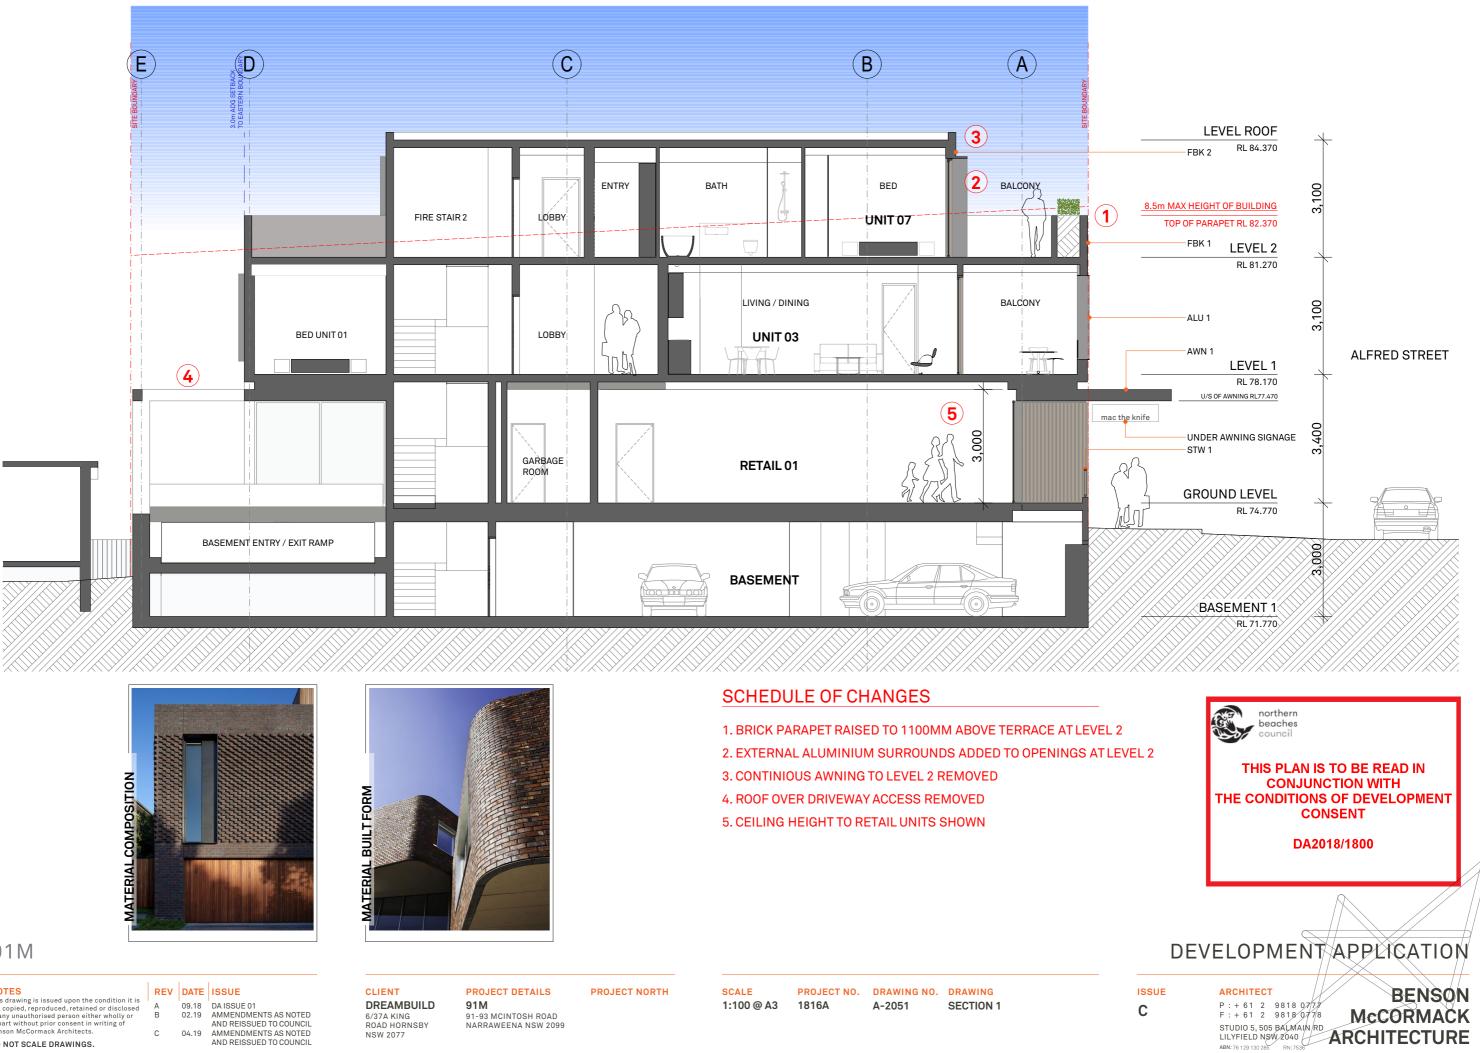

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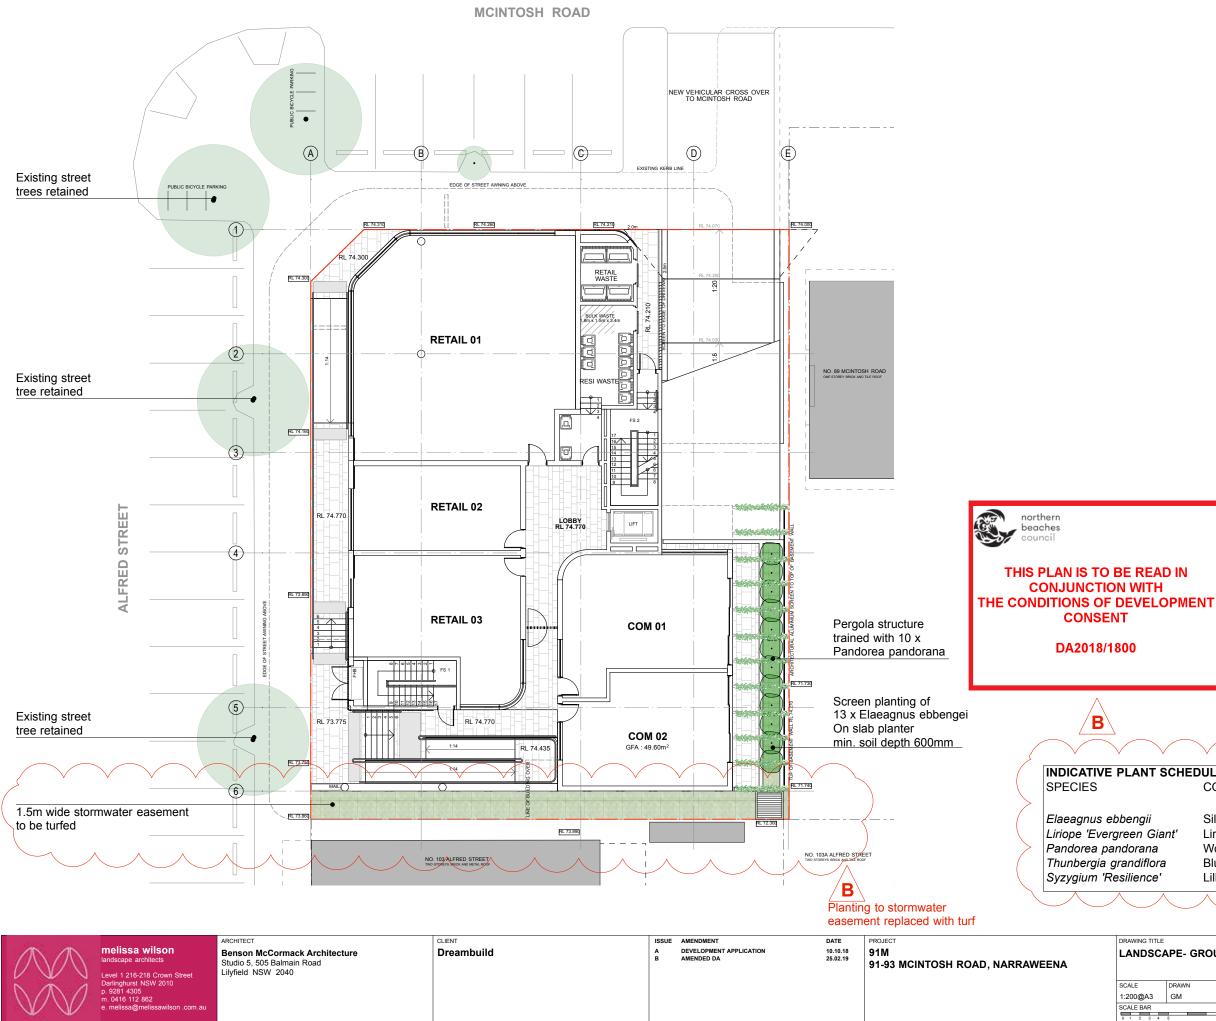




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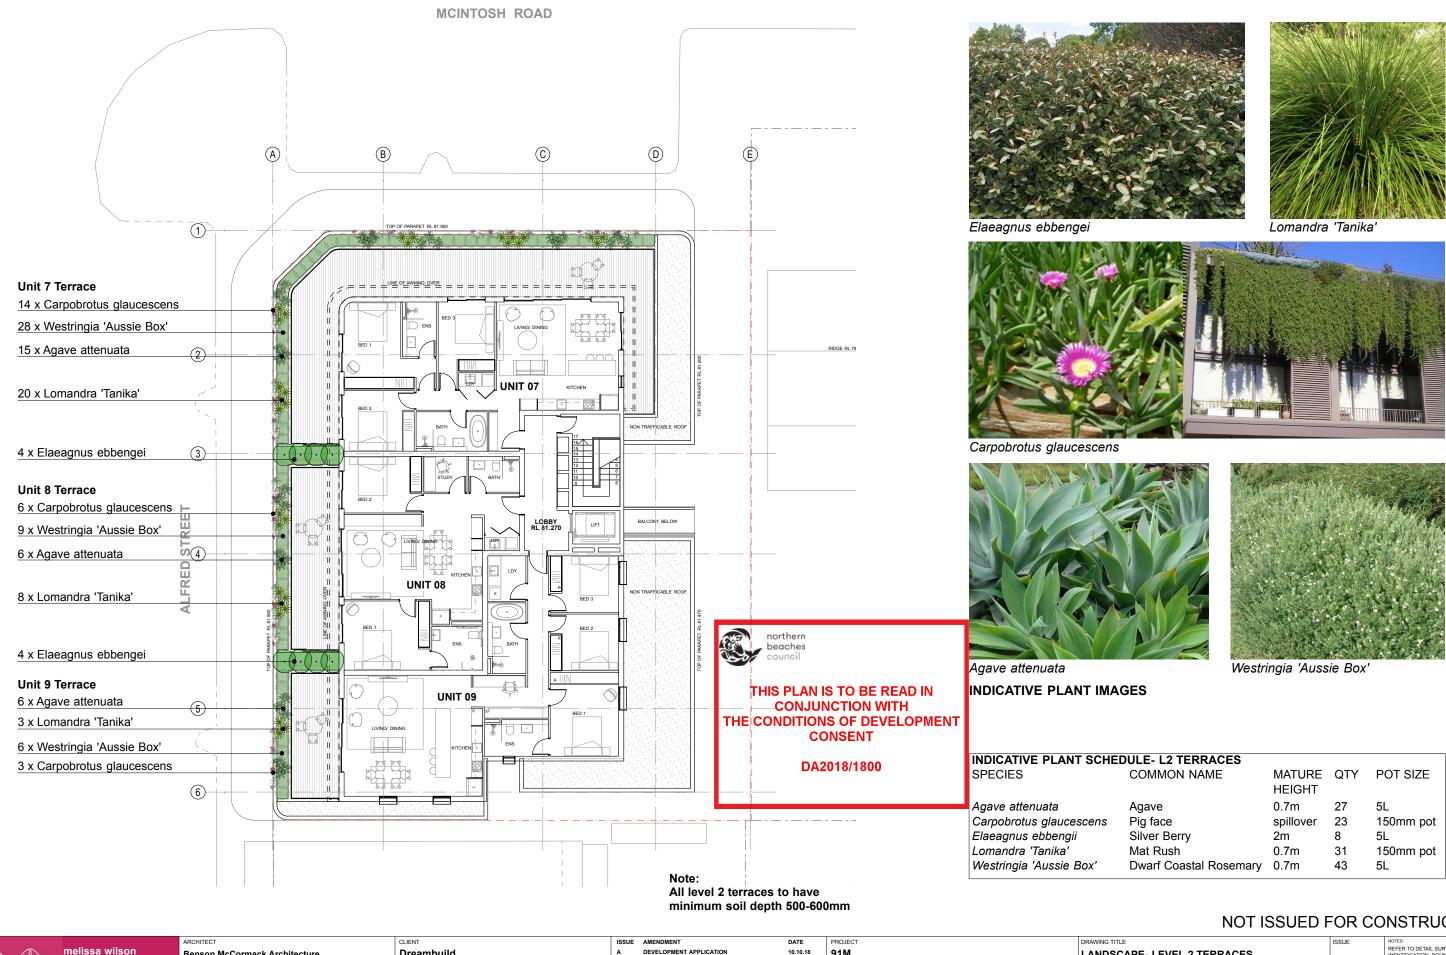


Elaeagnus ebbengei



Pandorea pandorana INDICATIVE PLANT IMAGES

	\bigvee			\checkmark				
CHE	DULE- GRO	JND LEV	EL			٦)		
	COMMON	NAME	MATUF HEIGH		POT SIZE			
	Silver Berry	/	2m	13	5L			
nt'	Liriope		0.7m	0	150mm pot			
	Wonga Wo	nga Vine	climber	10	150mm pot			
	Blue Trump	et Vine	climber	0	150mm pot			
	Lilli Pilli		5m	0	45L			
	NOT ISSUED FOR CONSTRUCTION							
PE- GROUND FLOOR ISSUE ISSUE ISSUE ISSUE INFORMATION BOUNDARY INFORMATION & LEVELS. ALL LEVELS AND DIMENSIONS TO BE CONFINED ON SITE. IF ANY DISCREPENCIES OCUR PLEASE								
DRAWN	PROJECT NO.	DWG NO.	SHEET	TN MN Hacorest	NOTIFY THE LANDSCAPE A	RCHITECT		
GM	1858	LS01	1 OF 3					
5	1	5	25					



$/ \setminus / / \setminus \rangle$	melissa wilson landscape architects Level 1 216-218 Crown Street	ARCHITECT Benson McCormack Architecture Studio 5, 505 Balmain Road Lilyfield NSW 2040	CLIENT Dreambuild	ISSUE AMENDMENT A DEVELOPMENT APPLICATION	PROJECT 91M 91-93 MCINTOSH ROAD, NARRAWEENA	DRAWING TITLE	APE- LEV	EL 2 TERR	ACES		A	NOTES: REFER TO DETAIL SURVEY FOR SITE IDENTIFICATION, BOUNDARY INFORMATION & LEVELS. ALL LEVELS AND DIMENSIONS TO BE CONFIRMED ON SITE. IF ANY
	Darlinghurst NSW 2010 p. 9281 4305 m. 0416 112 862 e. melissa@melissawilson .com.au					SCALE 1:200@A3 SCALE BAR	DRAWN GM	PROJECT NO. 1858	DWG NO.	SHEET 2 OF 3	TN MN MARCOTAR	DISCREPENCIES OCCUR PLEASE NOTIFY THE LANDSCAPE ARCHITECT
						0 1 2 3 4	5		15	25		





JLE- L2 TERRACES			
COMMON NAME	MATURE	QTY	POT SIZE
	HEIGHT		
Agave	0.7m	27	5L
Pig face	spillover	23	150mm pot
Silver Berry	2m	8	5L
Mat Rush	0.7m	31	150mm pot
Owarf Coastal Rosemary	0.7m	43	5L

NOT ISSUED FOR CONSTRUCTION

LANDSCAPE CONSTRUCTION NOTES

GENERAL

- Landscape documentation is to be read in conjunction with consultant team documentation for the project particularly architectural and engineering drawings

SUBSOIL

Excavate to bring the subsoil to a minimum of 300mm below finished design levels, to allow for infilling with topsoil mix. Break up the soil to a further depth of 100mm.

Remove all building rubble, waste oil, cement and other material harmful to plant growth from planting beds prior to placement of topsoil.

Cultivate to a minimum depth of 100 mm over areas to be planted or grassed. Do not disturb services or tree roots; if necessary, cultivate these areas by hand. During cultivation, thoroughly mix in materials required to be incorporated into the subsoil. Remove stones exceeding 25 mm, clods of earth exceeding 50 mm, and weeds, rubbish or other deleterious material brought to the surface during cultivation. Trim the surface to the required design levels after cultivation.

Confirm that the planting beds are free draining, if not install sub-soil drainage lines and connect to stormwater system

Apply additives after ripping or cultivation and incorporate into the upper 100 mm layer of the subsoil

TOPSOIL

Where possible use site topsoil and compost mixed at a rate of 4 soil:1 compost, thoroughly mixed before placement. If imported soil is required soil shall be same or similar to Benedicts Sand and Gravel Organic Garden mix M13 for garden bed areas.

Spread the topsoil on the prepared subsoil and grade evenly, making the necessary allowances so that required finished levels and contours are achieved after light compaction

Compact lightly and uniformly in 150 mm layers. Avoid differential subsidence and excess compaction and produce a finished topsoil surface which is ready for planting.

Spread topsoil to the following typical depths:

Planting beds: 300 mm

ON SLAB CONSTRUCTION- PLANTER BOXES

Ensure all slabs are water proofed by others and that drainage outlets are supplied to engineer's requirements, advise the builder if not acceptable. Supply and lay 30mm Atlantis drainage cell same or equal to as supplied by Atlantis Corporation over slab and connect to stormwater. Overlay the drainage cell with Geofabric PGM 14 as made by Polyfelt, run polyfelt up the sides of planters to within 40mm of the finished surface level.

For garden beds on slab: Supply and install to a depth of 50mm washed river sand on top of geofabric. Refer to typical detail for soil layering. Topsoil Types A and B shall be a light weight planter box mix and subsoil mix respectively and same or similar to Benedicts SmartMix No.4 and No. 5 respectively. Both are supplied by Benedicts Sand and Gravel. ph: 9986 3500.

DRAINAGE

- Drainage of all landscape areas is to be in accordance is to comply with requirements of Civil/ Stormwater Engineer's documentation

- All proposed finished levels to be approved by project civil/ stormwater engineer
- Drainage outlets to be provided to all 'on slab' planters to satisfaction of project civil/ stormwater engineer - All paved areas to fall to drainage outlets
- Confirm that deep soil garden beds are free draining, if not then install sub-soil drainage lines as
- requiredand connect to stormwater system

COMPOST

Well rotted vegetative material or animal manure, or other approved material, free from harmful chemicals, grass and weed growth, and with a neutral pH value.

PI ANTING

Trees: Excavate a plant hole to twice the diameter of the root ball and at least 100mm deeper than the root ball. Break up the base of the hole to a further depth of 100mm, and loosen the compacted sides of the hole.

Shrubs/groundcovers: Excavate a hole big enough for the plant plus 100 mm all round.

Provide plants which have large healthy root systems, with no evidence of root curl, restriction or damage are vigorous, well established, free from disease and pests, of good form consistent with the species or variety; and are hardened off, not soft or forced, and suitable for planting in the natural climatic conditions prevailing at the site.

Trees: Provide trees which, unless required to be multi-stemmed, have a single leading shoot. Trees: All trees of 25L or greater container size are to be grown and planted in accordance with: Clarke, R 1996 Purchasing Landscape Trees: A guide to assessing tree quality. NATSPEC Guide No.2

Label at least one plant of each species or variety in a batch using a durable, readable tag.

melissa wilsor

evel 1 216-218 Crown Stree

Do not plant in unsuitable weather conditions such as extreme heat, cold, wind or rain. In other than sandy soils, suspend excavation when the soil is wet, or during frost periods.

When the hole is of the correct size, remove the plant from the container with minimum disturbance to the root ball. Ensure that the root ball is moist and place in the final position, in the hole and plumb, with the top soil level of the plant root ball level with the finished surface of the surrounding soil, or 75 mm below paving level to allow placement of mulch

Backfill with topsoil mixture. Lightly tamp and water to eliminate air pockets. Ensure that topsoil is not placed over the top of the rootball, so that the plant stem is the same height as in the container. Thoroughly water plants before planting and immediately after planting.

In planting beds and individual plantings, place slow release fertiliser pellets around plants at the time of planting at the rate recommended by the manufacturer.

> Benson McCormack Architecture Studio 5, 505 Balmain Road Lilvfield NSW 2040

MULCH

All garden bed areas are to be mulched to 75mm depth with same or similar to Forest Blend as supplied by Benedict Sand and Gravel. Provide mulch which is free of deleterious and extraneous matter such as stones, soil, weeds and sticks.

Place mulch clear of plant stems, and rake to an even surface flush with the surrounding finished levels

IRRIGATION

Design, supply and install an automatic irrigation system that will deliver evenly, sufficient water to the trees, shrubs, groundcovers, turf and other planting on the site to maintain healthy growth continuously throughout the year.

The contractor shall be responsible for establishing the numbers and locations of emitters, spray heads. solenoid valves, filters etc required to provide a satisfactory performance of the system. Spray heads shall be directed away from seating, walls, paving, paths and steps.

Provide an automatic irrigation system with drippers/ microsprays to all garden beds. Ensure the pipework is installed in the least visible position possible. The detailed layout of all irrigation is to be approved prior to installation.

Connection to rainwater tank: Connection to rainwater retention tanks to be by way of an approved pump system meeting pressure requirements of proposed irrigation system. An approved filter system will be required to prevent algae and/or silt clocking effective operation of the irrigation system.

Drippers: Drippers shall deliver 2.3 litres per hour, at 400mm spacing or to base of individual plants as required and should be pressure compacted drippers.

Spray heads: To meet requirements of trees and lawn areas.

Valves: Richdel or similar approved 24 volt solenoid valves to be installed in Brookes or approved equal valve boxes. Top of box to be installed flush with finished soil level and covered with mulch laver.

Controller: Richdel or similar approved with numbers of stations required to isolate each area. Contractor is to allow for Controller in lockable metal cabinet in a location to the direction of the Architect. Power outlet for the operation of this unit to be supplied by others.

Pipework: Class HDPE pipe with pressure rating PN12.5 to be used for main lines. Copper pipework under paving and through masonry is to be installed. Drip lines will be LDPE laid on the surface of the soil under the mulch laver.

Cabling: 24 volt cabling to be enclosed in conduit in all areas. All wire must be installed in an unbroken length from the controller to the solenoid valve. All wires to be multistrand multicore and manufactured to AS 1125 and have polyethylene protective coating. All wire connectors must be waterproof. Cable to be minimum 1.0m2.

Rain sensor: A "mini clik" or similar or approved device to be supplied and installed to the approval of the superintendent. This unit is to be set to turn the system off after 3mm of rain has occurred.

The irrigation contractor shall check and monitor the system performance; once per month throughout the planting establishment period. The contractor shall provide the client with a recommended watering schedule for summer and winter that includes the dates to change the operation.

MAINTENANCE/ ESTABLISHMENT

Throughout the planting establishment period (12 weeks), carry out maintenance work including, watering, mowing, weeding, rubbish removal, fertilising, pest and disease control, reseeding, returfing, staking and tying, replanting, cultivating, pruning, hedge clipping, aerating, reinstatement of mulch, renovating, top dressing, and keeping the site neat and tidy. Continue to replace failed, damaged or stolen plants.

LANDSCAPE STATEMENT

The landscape design scheme contributes to the external amenity of the architectural scheme in a way that both aesthetically compliments the building design and provides a planted buffer to adjoining properties. The landscape areas comprise:


- Ground level deep soil southern boundary setback
- Ground level eastern terrace
- Level 2 private terrace planters

Ground level southern boundary planting provides screening to the neighbouring retail premises through a combination of columnar tree species and vertical tensioned cables trained with vines. Plants species have been selected for shade tolerance

Ground level eastern terrace provides outdoor space for two commercial premises. An on slab boundary planter is planted with screen planting to approx. 2m high and vines are proposed to be trained to the pergola covering the area. Planters will have 600mm soil depth in accordance with Apartment Design Guide (ADG) guidelines

The Level 2 private terraces incorporate perimeter planters and are proposed to be planted with predominately low, drought and heat tolerant plants that will compliment the building facade and anable views over when residents are on their terraces. Talling planting is proposed to screen between terraces. Planters will have 600mm soil depth in accordance with ADG guidelines.

										01100	
CLIENT	ISSUE	AMENDMENT	DATE	PROJECT	DRAWING TITLE					ISSUE	NOTES:
Dreambuild	A	DEVELOPMENT APPLICATION	10.10.18	91M 91-93 MCINTOSH ROAD, NARRAWEENA	LANDSC	SCAPE- NOTES & DETAILS				Α	REFER TO DETAIL SURVEY FOR SITE IDENTIFICATION, BOUNDARY INFORMATION & LEVELS. ALL LEVELS AND DIMENSIONS TO BE CONFIRMED ON SITE. IF ANY
					SCALE	DRAWN GM	PROJECT NO. 1858	DWG NO. LS03	SHEET 3 OF 3		DISCREPENCIES OCCUR PLEASE NOTIFY THE LANDSCAPE ARCHITECT
					SCALE BAR						

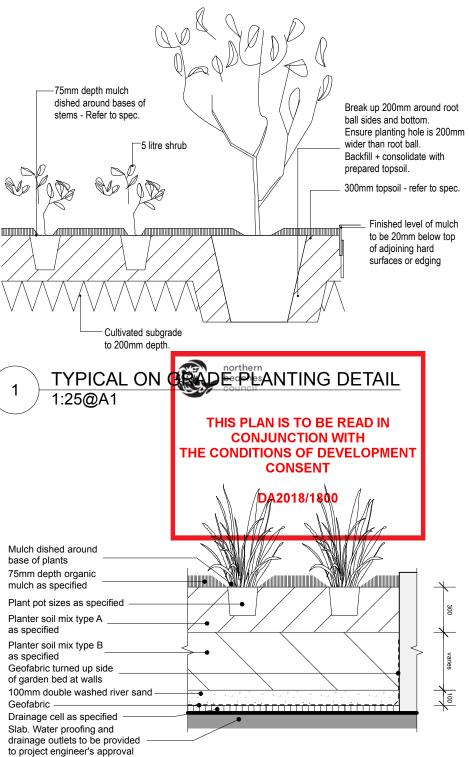



Mulch dished around base of plants 75mm depth organic

Planter soil mix type B

of garden bed at walls

Drainage cell as specified Slab. Water proofing and


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2 }	1:25@A
	-

AL ON SLAB PLANTING DETAIL

NOT ISSUED FOR CONSTRUCTION

PLAN FORM 1 (A3)

WARNING: CREASING OR FOLDING WILL LEAD TO REJECTION

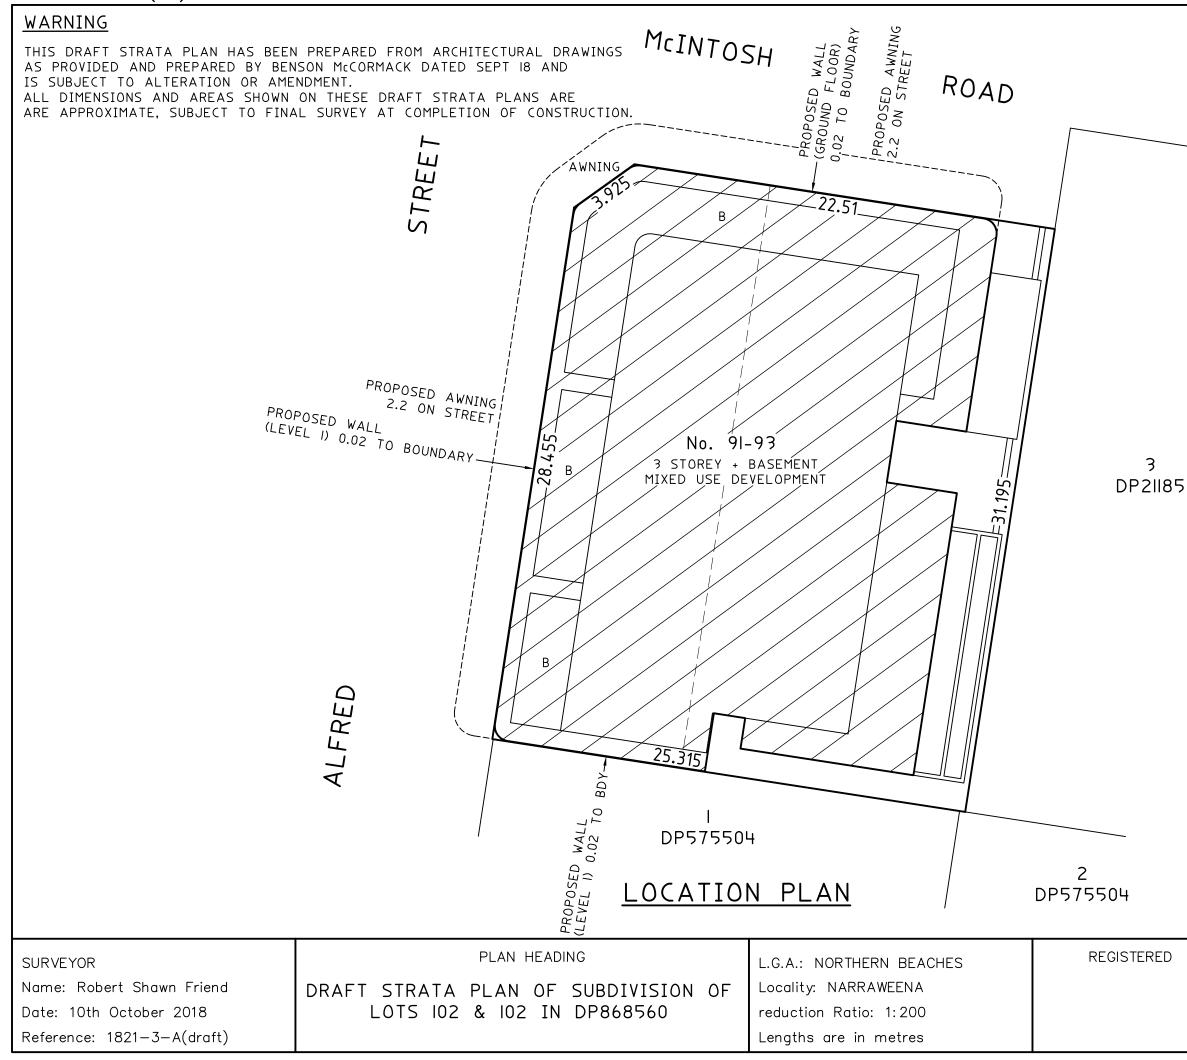

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B = BALCONY



THIS PLAN IS TO BE READ IN CONJUNCTION WITH THE CONDITIONS OF DEVELOPMENT CONSENT

DA2018/1800

SP DRAFT


PLAN FORM 1 (A3)


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WARNING

THIS DRAFT STRATA PLAN HAS BEEN PREPARED FROM ARCHITECTURAL DRAWINGS AS PROVIDED AND PREPARED BY BENSON MCCORMACK DATED SEPT 18 AND IS SUBJECT TO ALTERATION OR AMENDMENT. ALL DIMENSIONS AND AREAS SHOWN ON THESE DRAFT STRATA PLANS ARE ARE APPROXIMATE, SUBJECT TO FINAL SURVEY AT COMPLETION OF CONSTRUCTION.

ALL AREAS ARE APPROXIMATE.



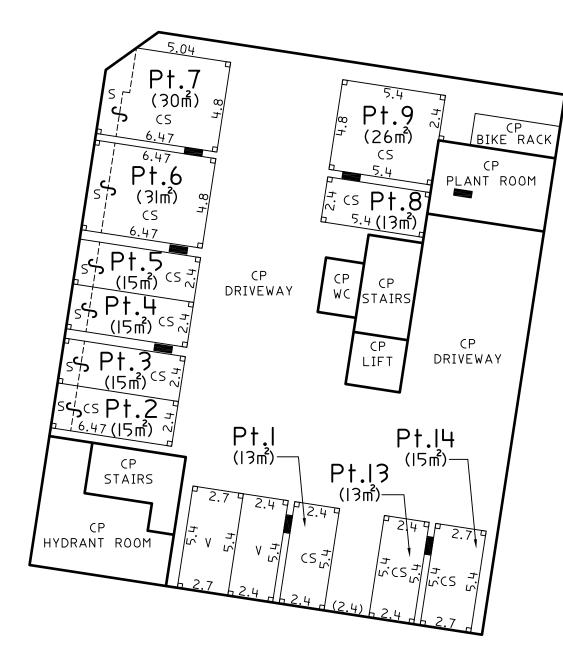

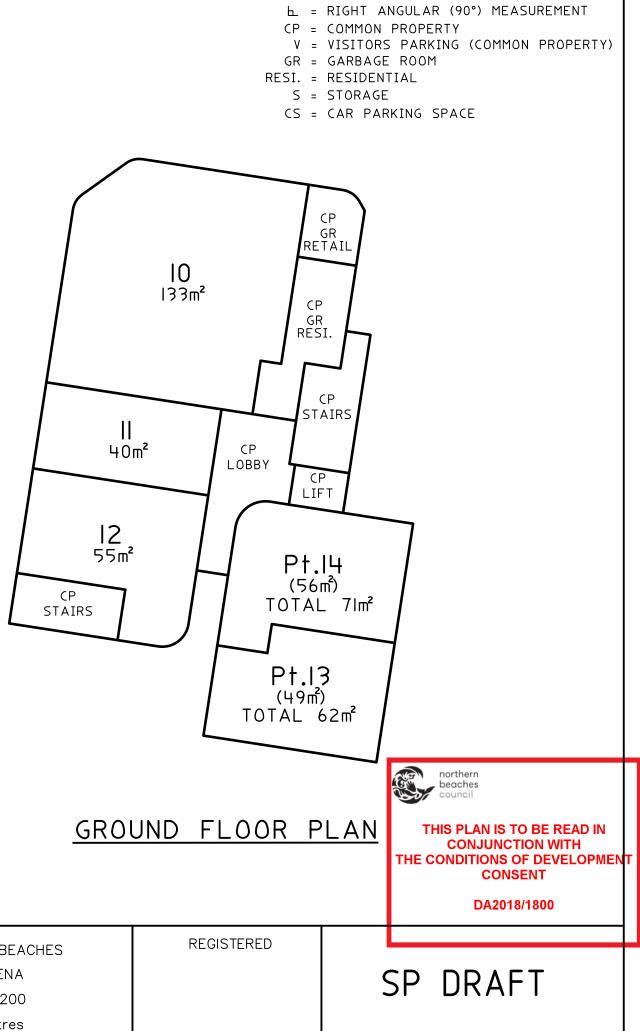BASEMENT FLOOR PLAN

SURVEYOR	PLAN HEADING	L.G.A.: NORTHERN BEACHES	REGISTERED
Name: Robert Shawn Friend	DRAFT STRATA PLAN OF SUBDIVISION OF	Locality: NARRAWEENA	
Date: 10th October 2018	LOTS 102 & 102 IN DP868560	reduction Ratio: 1:200	
Reference: 1821-3-A(draft)		Lengths are in metres	

SHEET 2 OF 3 SHEETS


PLAN FORM 1 (A3)


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ALL AREAS ARE APPROXIMATE.





FIRST FLOOR PLAN

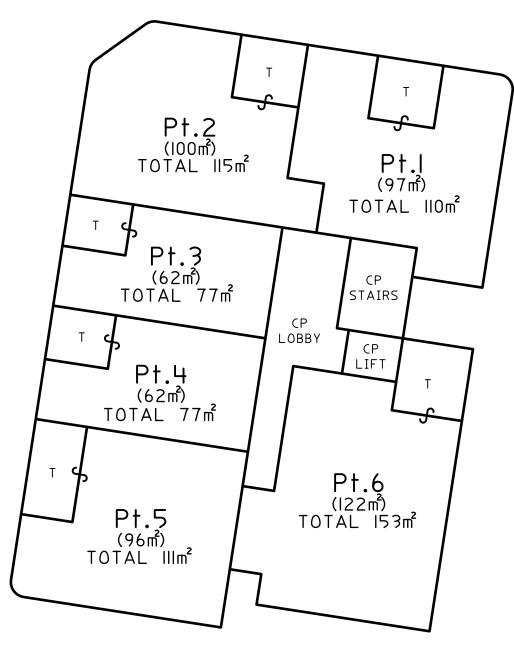THE HEIGHT OF ALL BALCONIES AND TERRACES ARE LIMITED TO 3 ABOVE THE UPPER SURFACE OF THEIR FINISHED FLOOR LEVEL, EXCEPT WHERE COVERED WITHIN THAT LIMIT.

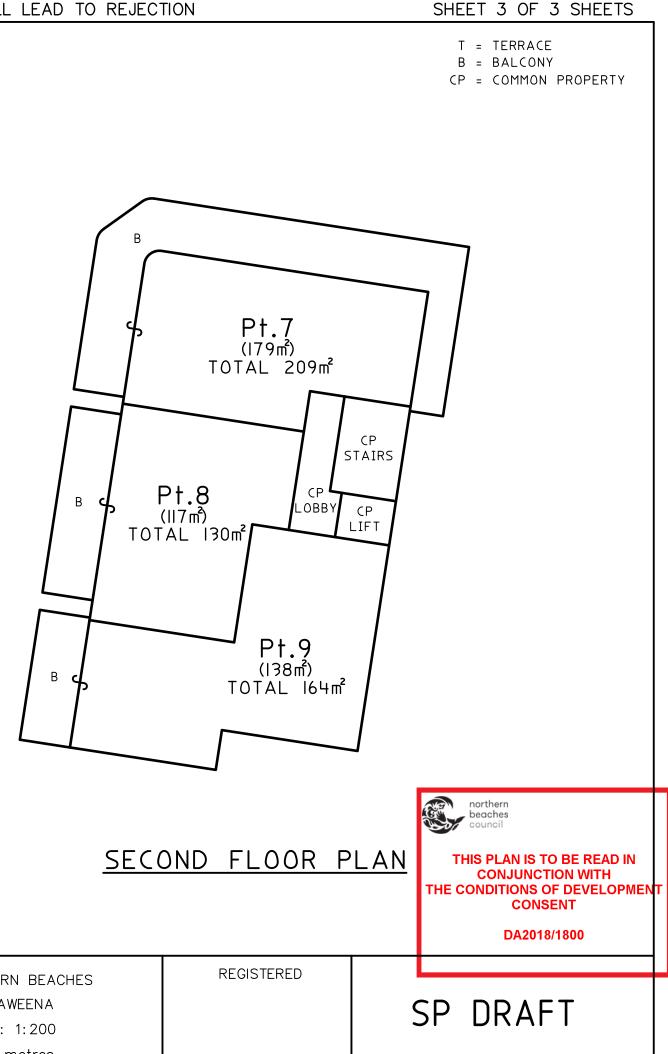SURVEYOR	PLAN HEADING	L.G.A.: NORTHERN BEACHES	REGISTERED
Name: Robert Shawn Friend	DRAFT STRATA PLAN OF SUBDIVISION OF	Locality: NARRAWEENA	
Date: 10th October 2018	LOTS 102 & 102 IN DP868560	reduction Ratio: 1:200	
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