

Warriewood Bazem

Lot 10 Warriewood

Drawings

No Rev Drawing A0000 Perspective Views, Notes, Areas A1000 Site Plan A1001 Site Plan - Landscape A2100 Ground Floor Plan A2101 First Floor Plan Roof Plan A2102 A2400 Electrical Plans A2401 Lighting Calculation A2500 **Shadow Diagrams** A3000 Elevations A3001 Elevations A3100 Sections

D & W Window Schedule - Doors

D & W Window Schedule - Windows

Sections

General Notes



Resene Foggy Grey

Render 2

Cladding Resene Nocturnal

Garage Monument Roof Monument

Note: colours indicative only and should not be used as a true representation of the product

Areas (for Building Permit purposes only)

	Lot 10		
Unit	Area	Measured Area	
L10-1	01 GF Living Area	50.68	
L10-1	02 FF Living Area	60.82	
L10-1	03 Garage	22.18	H
L10-1	05 Porch	1.97	
		135.65 m²	L
L10-2	01 GF Living Area	50.70	
L10-2	02 FF Living Area	60.82	
L10-2	03 Garage	22.14	
L10-2	05 Porch	1.97	
		135.63 m²	
		271.28 m²	V

A3101

A6000

A6000

Builder/Contractor shall verify job dimensions before any job commences Figured dimensions take precedence over drawings and job dimensions. All shop drawings shall be submitted to the Architect/Consultant, and manufacture shall not commence prior to return of inspected shop drawings by the Architect/Consultant. Architect

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Rev Description

Client Details client

Project Warriewood Bazem

Lot 10 Warriewood


Drawing Cover Sheets Perspective Views, Notes, Areas

Project Status PRELIMINARY - not for construction

Scale Drawn BK Checked ML

Drawing Number A0000

Project Number 11268

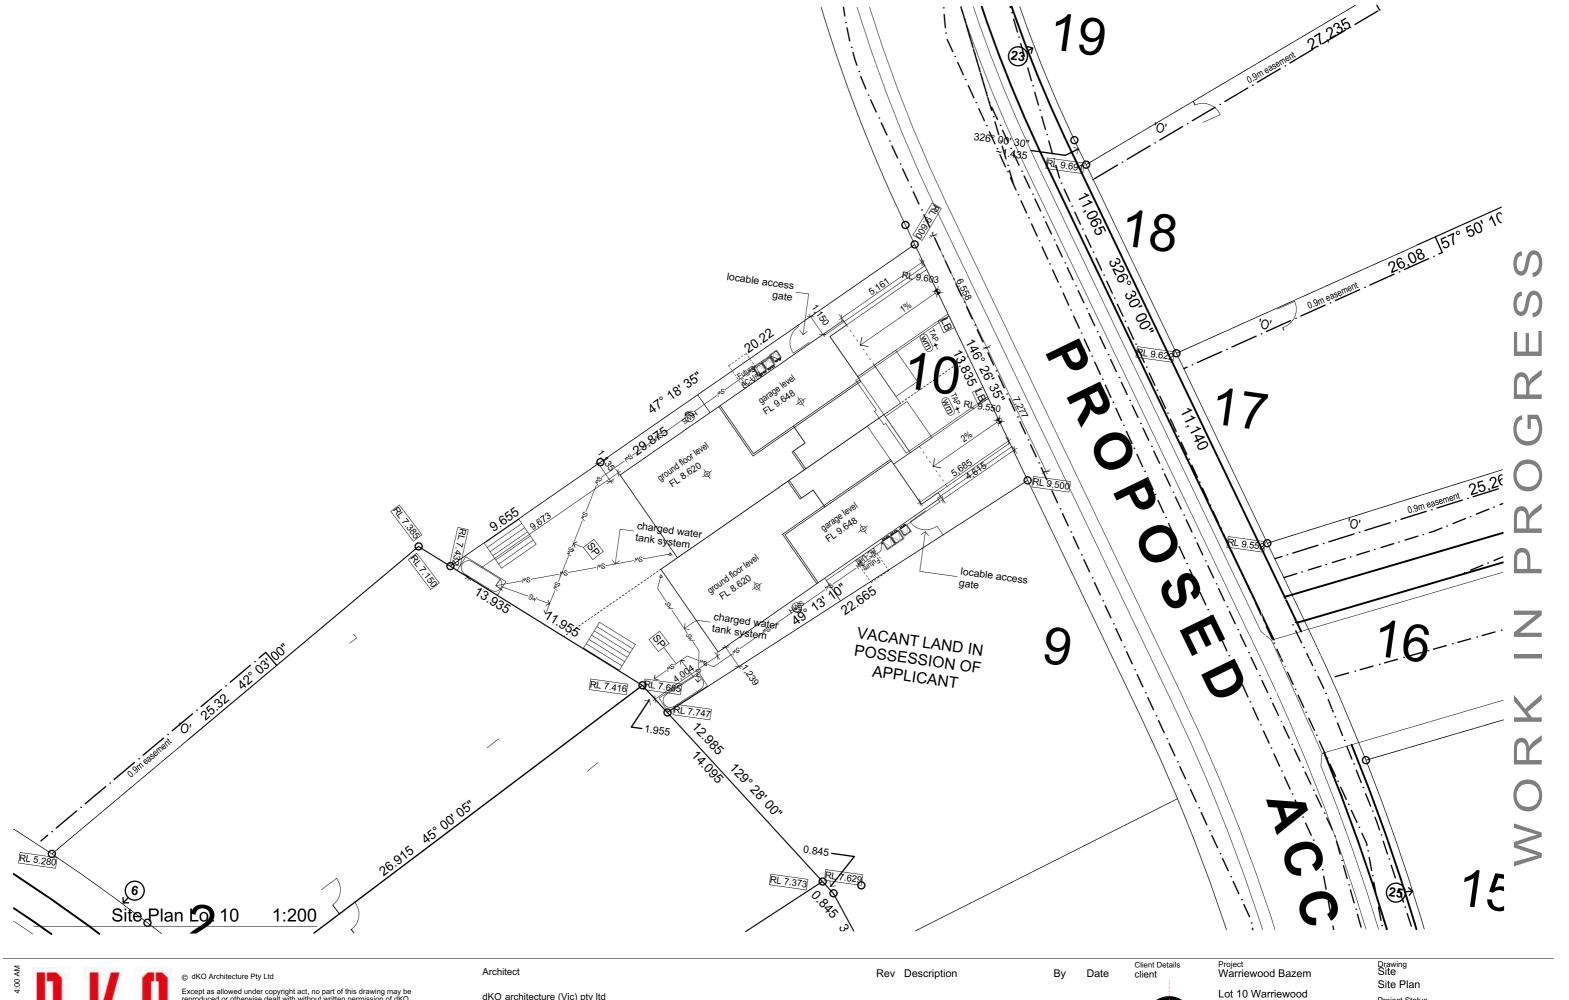

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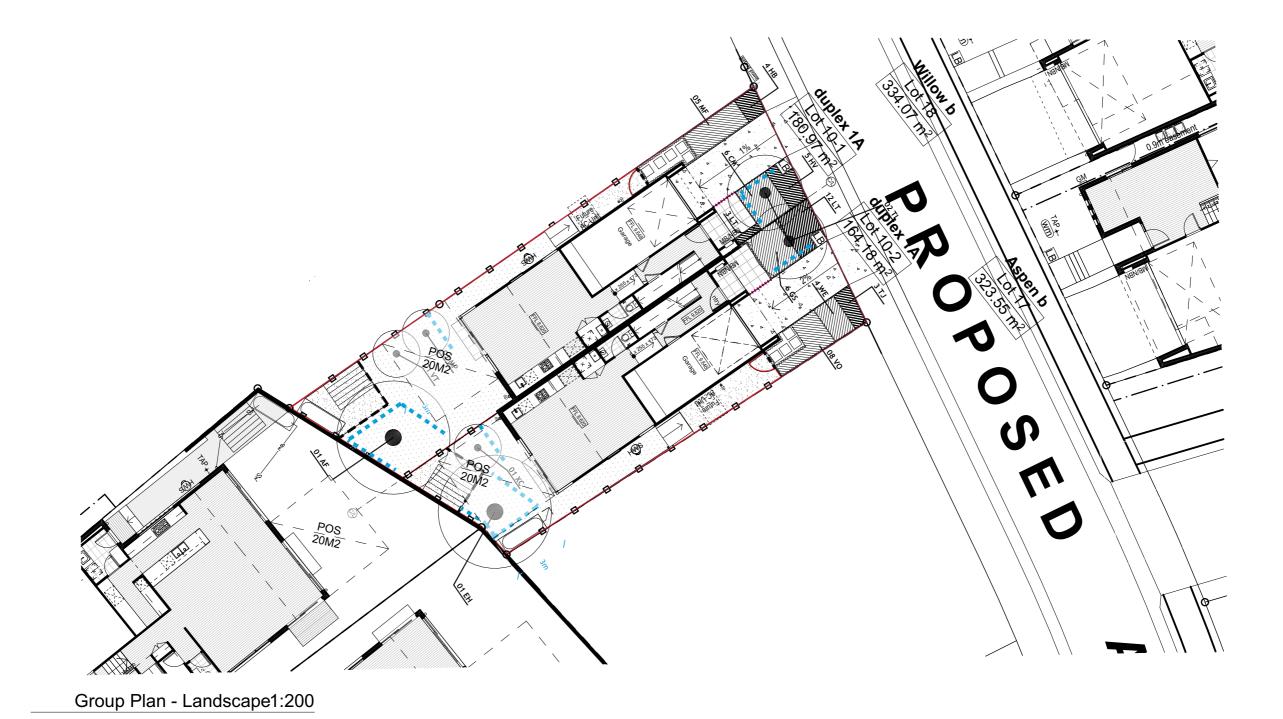
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Project Number 11268

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Drawing Number A1000 Revision



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Rev Description

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Project Warriewood Bazem

Lot 10 Warriewood

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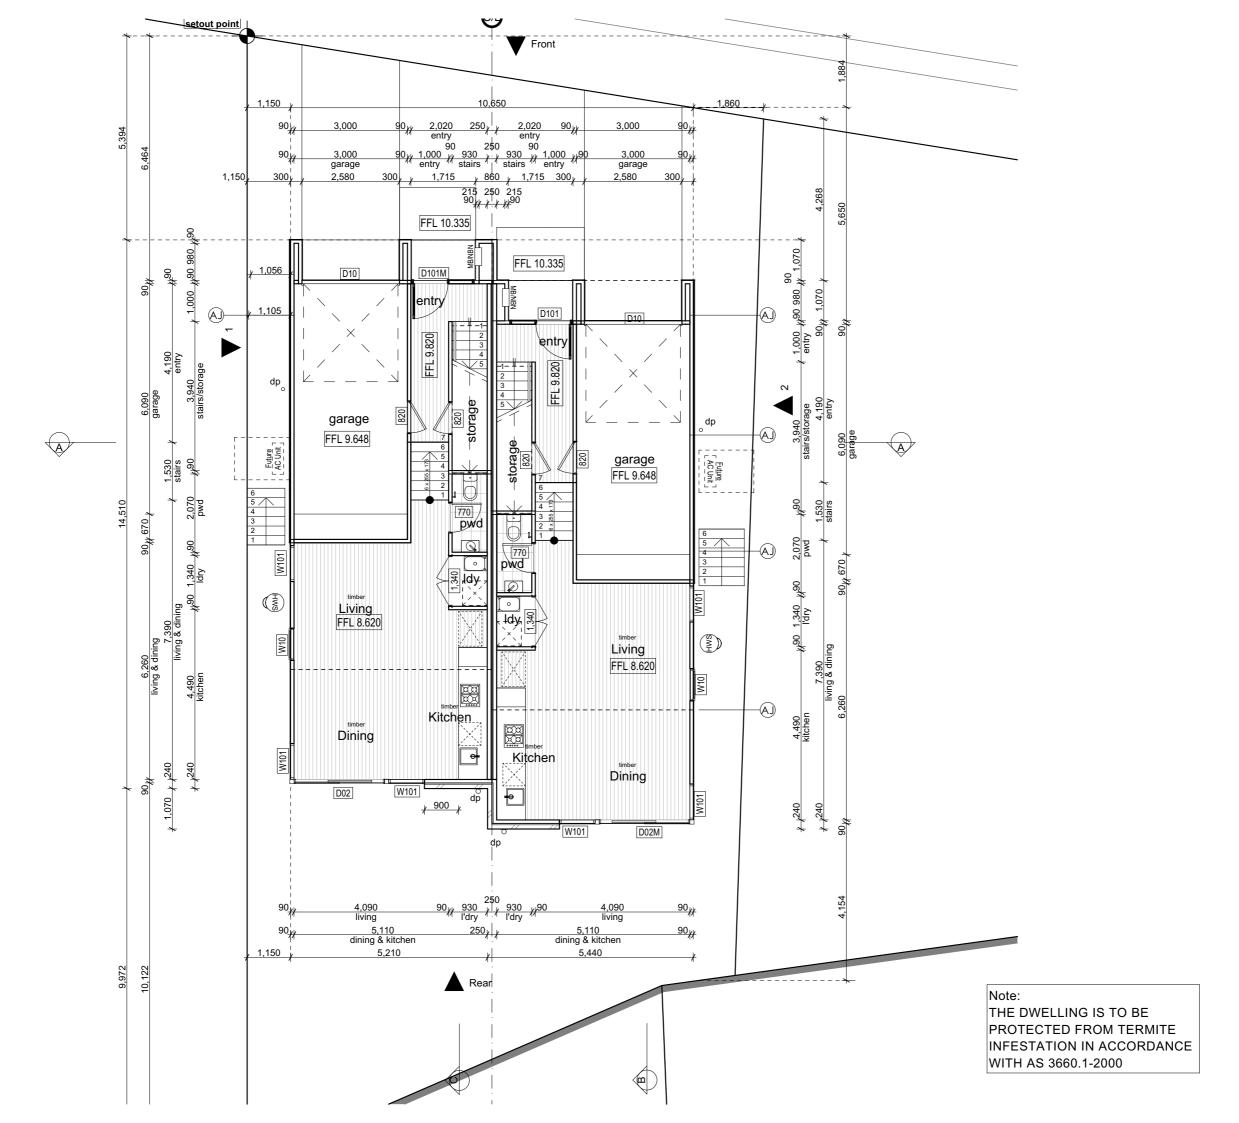
Site Plan - Landscape

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Drawing Number A1001 Revision







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Project Warriewood Bazem

Lot 10 Warriewood

Project Number 11268

Drawing General Arrangement Plans Ground Floor Plan

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Drawing Number A2100





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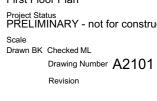
Project Warriewood Bazem


Lot 10 Warriewood


Project Number 11268

Drawing General Arrangement Plans First Floor Plan

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Rev Description

Project Warriewood Bazem

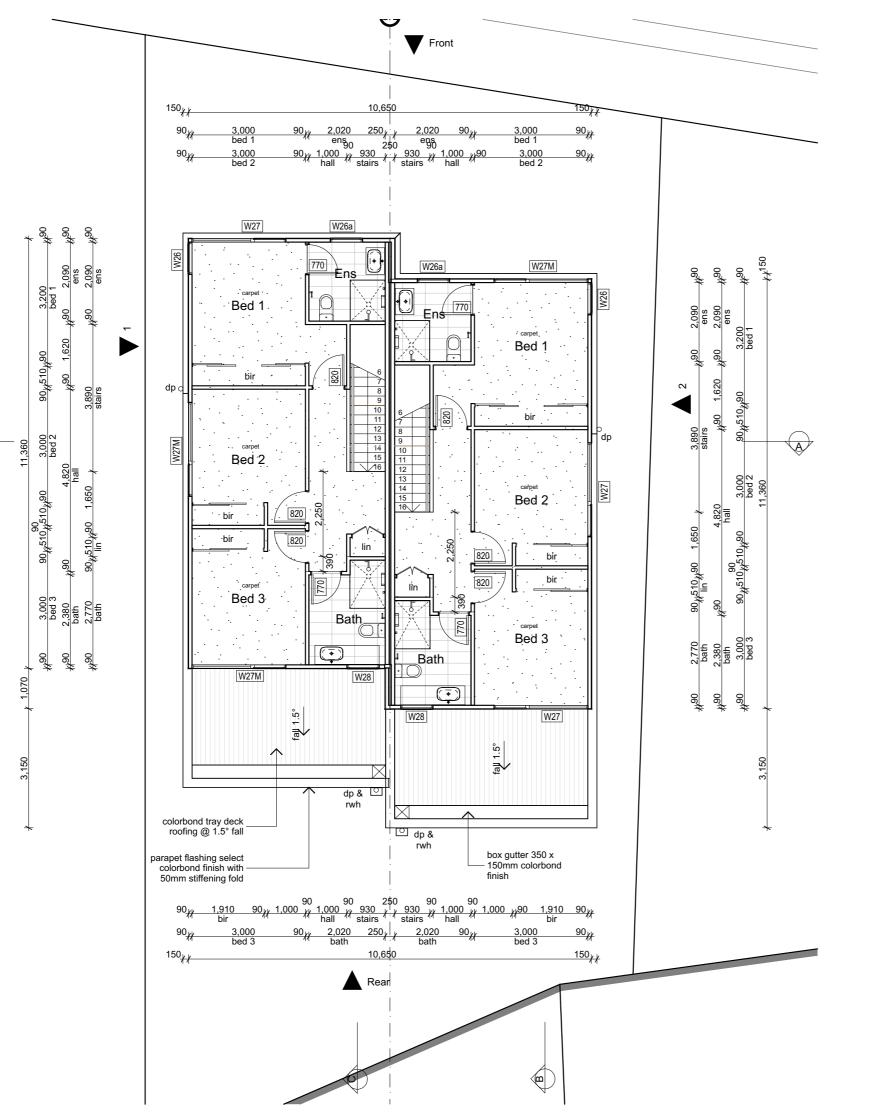Lot 10 Warriewood

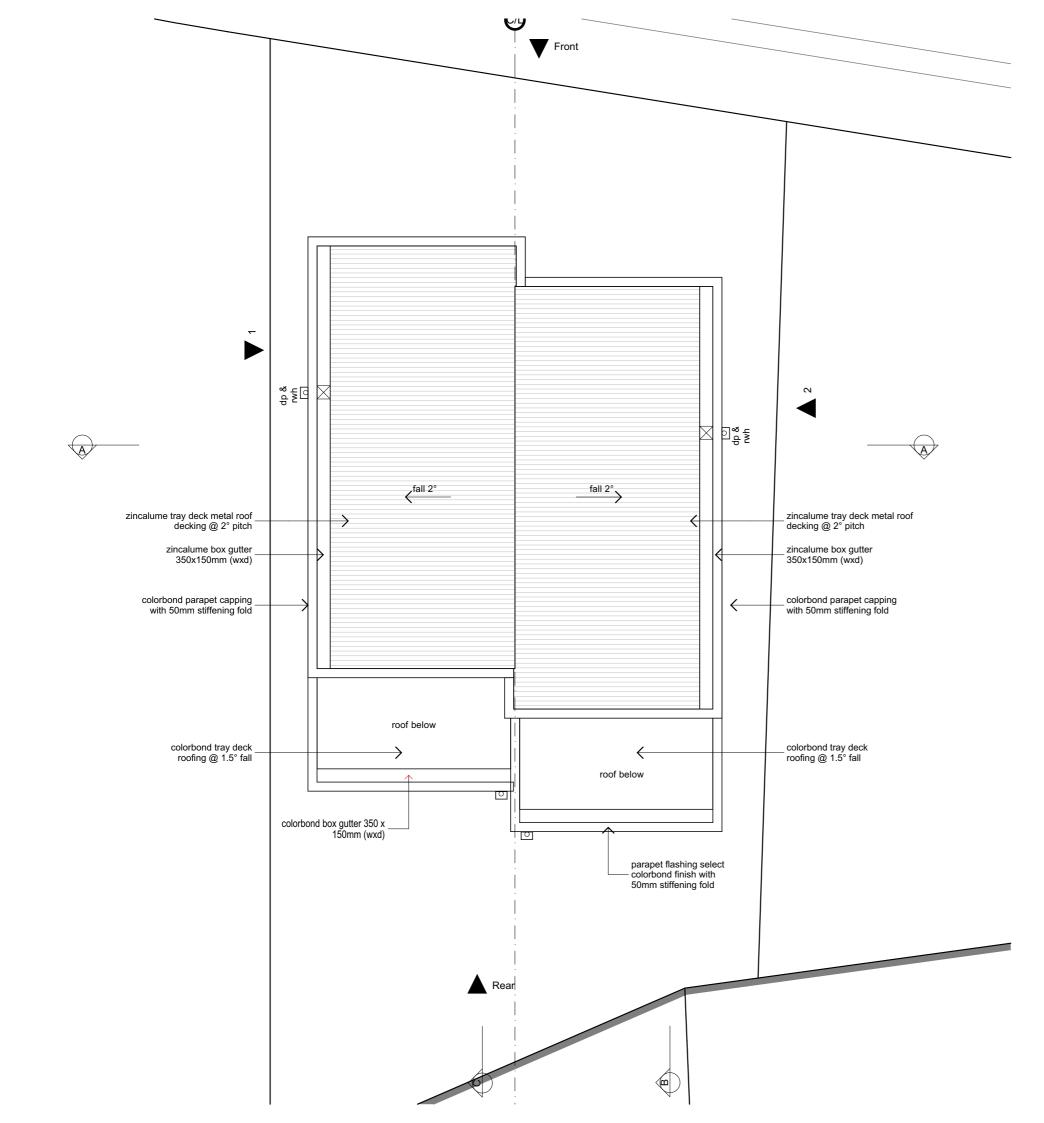Project Number 11268


Drawing General Arrangement Plans


Roof Plan

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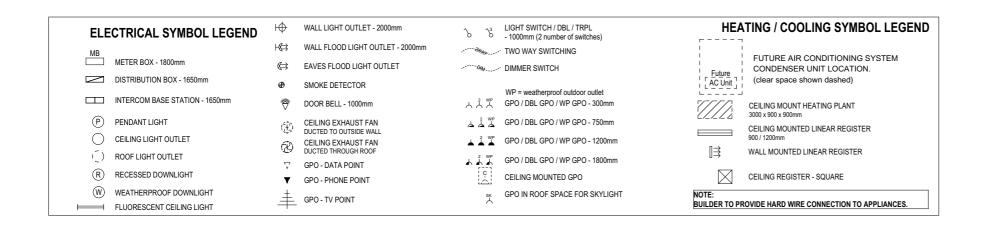
Scale Drawn BK Checked ML

Drawing Number A2102



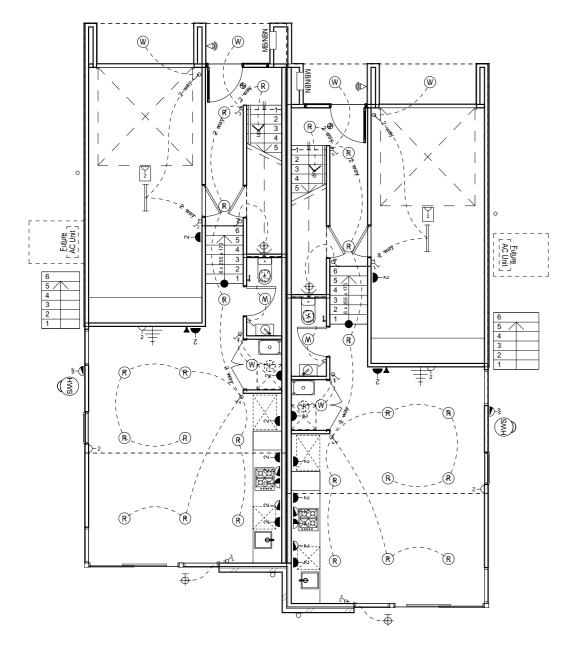

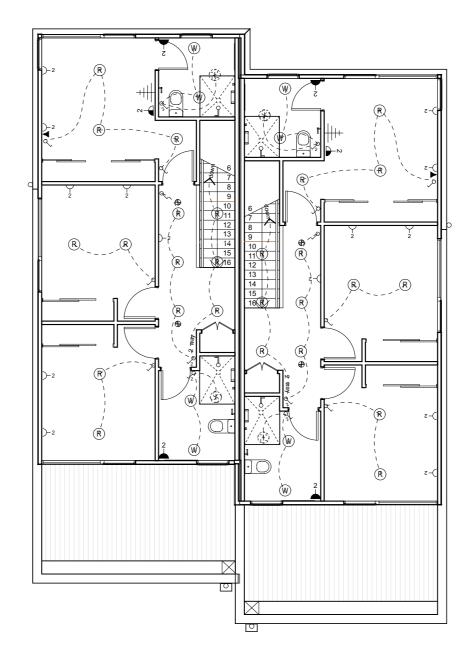Ground Floor Electrical 1:100 First Floor Electrical 1:100







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Rev Description

Project Warriewood Bazem

Lot 10 Warriewood

Project Number 11268

Drawing Electrical Plans Electrical Plans

Project Status PRELIMINARY - not for construction

Scale Drawn BK Checked ML

Drawing Number A2400

				Design Lamp or Illumination Power Load		Adjustment Factor One				Adjustment Fac	a for C	Class 1)	OVERALL DESIGN PASSES			
	Description	Type of space			Location	Adjustment Factor One		ming ntages	Design Lumen	Adjustment Factor Two	Dimmin Percentag	g ges	Design Lumen	Lamp or Illum Den		System Share of
ID					Location	Adjustment Factors	% Area	% of full power	Depreciation Factor	Adjustment Factors	% Area ^{% o'} pov	f full Di	Depreciation Factor	System Allowance	System Design	% of Aggregate Allowance Used
1	Entry, corridor, stairs	Corridor	8.9 m²	52 W	Class 1 building									5.0 W/m²	5.8 W/m ²	8% of 84%
2	living & dining	Living room	22.3 m²	78 W	Class 1 building									5.0 W/m ²	3.5 W/m ²	5% of 84%
3	wc	Toilet	1.9 m²	13 W	Class 1 building									5.0 W/m²	6.7 W/m ²	9% of 84%
4	storage	Other	2.7 m²	13 W	Class 1 building									5.0 W/m²	4.8 W/m ²	7% of 84%
5	kitchen	Kitchen	7.9 m²	26 W	Class 1 building									5.0 W/m ²	3.3 W/m ²	5% of 84%
6	laundry	Laundry	1.4 m²	13 W	Class 1 building									5.0 W/m ²	9.5 W/m ²	13% of 84%
7	garage	Other	20.3 m ²	13 W	Class 10a building									3.0 W/m ²	0.6 W/m ²	100% of 20%
8	porch	Other	1.8 m²	13 W	Class 1 building									5.0 W/m ²	7.3 W/m ²	10% of 84%
9	outside garage	Other	3.0 m ²	13 W	Class 1 building									5.0 W/m ²	4.3 W/m ²	6% of 84%
10	backyard - SPOS	Verandah or balcony	20.0 m²	13 W	Verandah or balcony									4.0 W/m²	0.7 W/m²	100% of 18%
11	Stairs & corridor	Corridor	10.1 m ²	78 W	Class 1 building									5.0 W/m ²	7.7 W/m ²	11% of 84%
12	bed 1	Bedroom	13.2 m²	39 W	Class 1 building									5.0 W/m ²	3.0 W/m ²	4% of 84%
13	bed 2	Bedroom	10.8 m²	26 W	Class 1 building									5.0 W/m²	2.4 W/m²	3% of 84%
14	bed 3	Bedroom	10.8 m²	26 W	Class 1 building									5.0 W/m ²	2.4 W/m ²	3% of 84%
	Ensuite	Bathroom	4.2 m²	26 W	Class 1 building									5.0 W/m ²	6.2 W/m ²	9% of 84%
16	bath	Bathroom	5.2 m ²	26 W	Class 1 building									5.0 W/m ²	5.0 W/m ²	7% of 84%

144.4 m² 468 W Verandah or balcony

CLAIMER IN RESPECT OF THE LIGHTING CALCULATOR ator has been developed by the ABCB to assist in developing a better understanding of lighting energy efficiency parameters. While the the Lighting Calculator, if used correctly, will produce accurate results, the calculator is provided "as is" and without any representation or t, including that it is fit for any purpose or of merchantable quality, or functions as intended or at all. Your use of the Lighting Calculator is risk and the ABCB accepts no liability of any kind. if inputs are valid

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Main Menu LIGHTING CALCULATOR FOR USE WITH J6.2(a) VOLUME O	NE AND 3.12.5.5 VOLUME TWO (First issued with NCC 2014) Help screen
Building name/description Job No 11268 Lot 10-2	Classification Class 1
Number of rows preferred in table below 16 (as currently displayed)	Separate aggregate allowances are calculated for Class 1, 2 or 4 cases; for a verandah or balcony; or for a Class 10 building. The % of Allowance Used outcomes refer to these aggregate

				Danis		Adjustment Factor One				Adjustment Factor Two (n/a for Class 1)				OVERALL DESIGN PASSES				
	Description	Type of space	Floor area of the space	Design Lamp or Illumination Power Load	or	the or	Location	Adjustment Factor One	Dimming Percentages		Design Lumen	Adjustment Factor Two	Dimming Percentages		Design Lumen	Lamp or Illum Den		System Share of % of Aggregate Allowance Used
ID		Space				Adjustment Factors	% Area	% of full power	Depreciation Factor	Adjustment Factors	% Area	% of full power	Depreciation Factor	System Allowance	System Design			
1	Entry, corridor, stairs	Corridor	8.9 m²	52 W	Class 1 building									5.0 W/m²	5.8 W/m²	8% of 84%		
2	living & dining	Living room	22.3 m ²	78 W	Class 1 building									5.0 W/m ²	3.5 W/m ²	5% of 84%		
3	wc	Toilet	1.9 m²	13 W	Class 1 building									5.0 W/m²	6.7 W/m ²	9% of 84%		
4	storage	Other	2.7 m ²	13 W	Class 1 building									5.0 W/m ²	4.8 W/m ²	7% of 84%		
5	kitchen	Kitchen	7.9 m²	26 W	Class 1 building									5.0 W/m ²	3.3 W/m ²	5% of 84%		
6	laundry	Laundry	1.4 m²	13 W	Class 1 building									5.0 W/m ²	9.5 W/m ²	13% of 84%		
7	garage	Other	20.3 m ²	13 W	Class 10a building									3.0 W/m ²	0.6 W/m ²	100% of 20%		
8	porch	Other	1.8 m²	13 W	Class 1 building									5.0 W/m ²	7.3 W/m ²	10% of 84%		
9	outside garage	Other	3.0 m ²	13 W	Class 1 building									5.0 W/m ²	4.3 W/m ²	6% of 84%		
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14	bed 3	Bedroom	10.8 m²	26 W	Class 1 building									5.0 W/m²	2.4 W/m ²	3% of 84%		
15	Ensuite	Bathroom	4.2 m²	26 W	Class 1 building									5.0 W/m ²	6.2 W/m ²	9% of 84%		
16	bath	Bathroom	5.2 m ²	26 W	Class 1 building									5.0 W/m ²	5.0 W/m ²	7% of 84%		

144.4 m² 468 W Verandah or balco Class 10a building (associated with a Class 1 building) 3.0 W/m²

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are valid

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Rev Description

Project Number 11268

Project Warriewood Bazem Lot 10 Warriewood

Drawing Electrical Plans Lighting Calculation

Project Status PRELIMINARY - not for construction

Scale Drawn BK Checked ML

Drawing Number A2401







Shadows @ 9am June 21

Shadows @ 12pm June 21

Shadows @ 3pm June 21

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Rev Description

Project Warriewood Bazem

Lot 10 Warriewood

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11268

Drawing Shadow Diagram Shadow Diagrams Project Status PRELIMINARY - not for construction

Drawing Number A2500



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Rev Description

Project Warriewood Bazem


Lot 10 Warriewood

Project Number 11268

Drawing Elevations Elevations

Project Status PRELIMINARY - not for construction

Scale Drawn BK Checked ML Drawing Number A3000

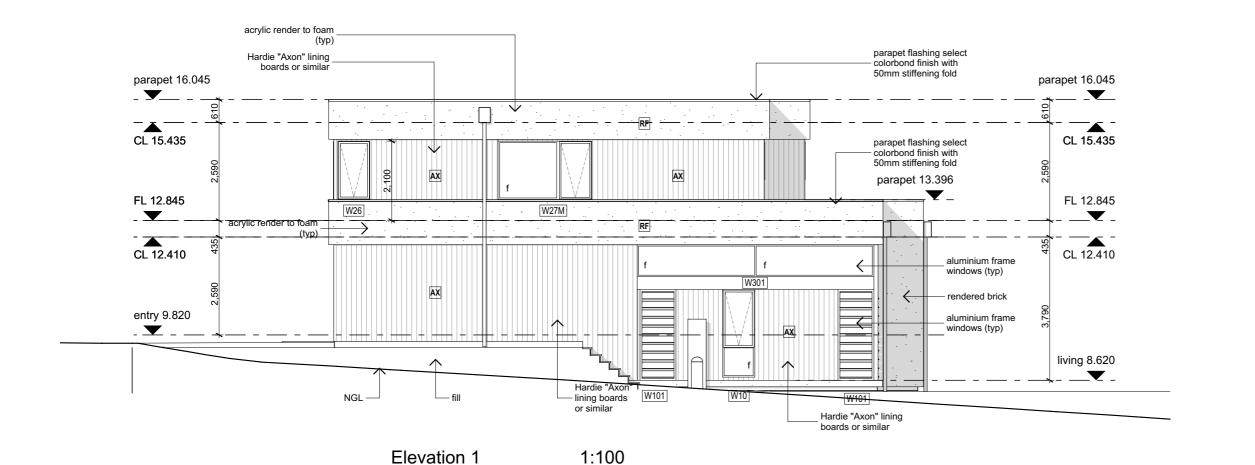



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Rev Description

Project Warriewood Bazem Lot 10 Warriewood


Project Number 11268

Drawing Elevations Elevations

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Drawing Number A3001



Section A-A 1:100
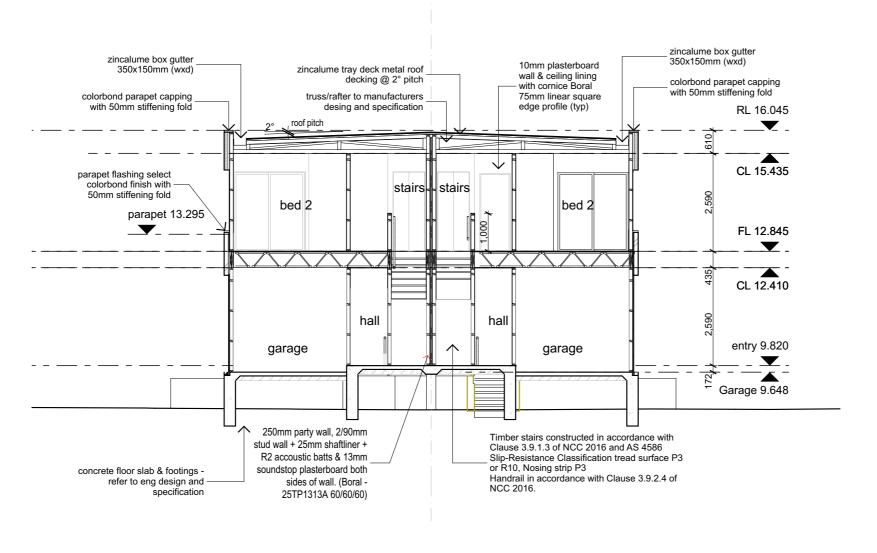
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Rev Description

By Date

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Project Warriewood Bazem

Lot 10 Warriewood


Lot 10 Project Number 11268 Drawing Sections

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Checked ML

Drawing Number Revision A3100



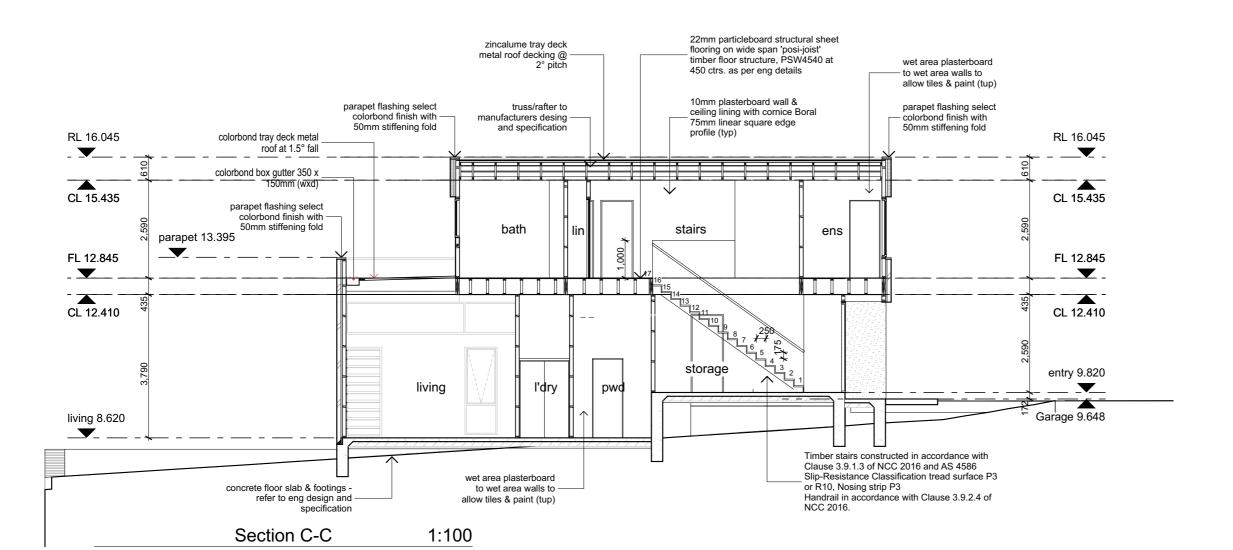

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Lot 10 Warriewood


Project Number 11268

Drawing Sections Sections

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Drawn BK Checked ML

Drawing Number A3101



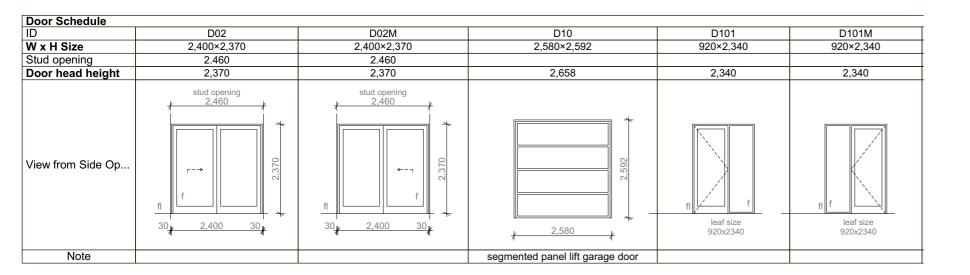

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Rev Description

By Date

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Project Warriewood Bazem

Lot 10 Warriewood

D & W Window Schedule - Doors Project Status PRELIMINARY - not for construction


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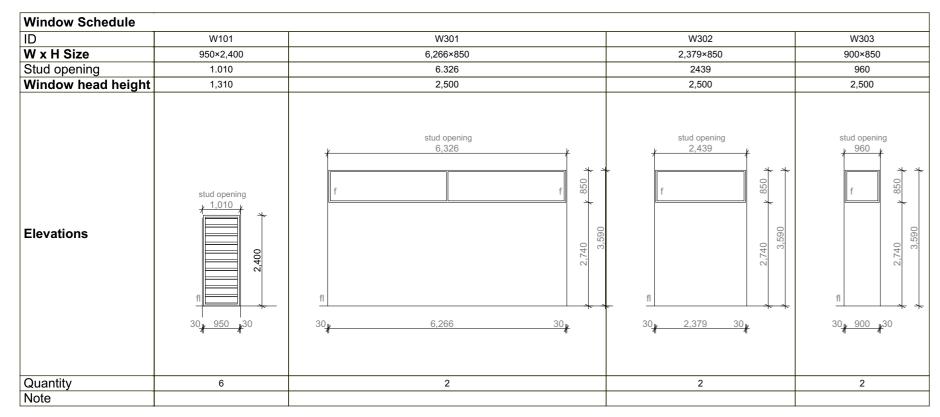
Drawing D & W Schedule

Drawing Number A6000 Revision

11268

Project Number



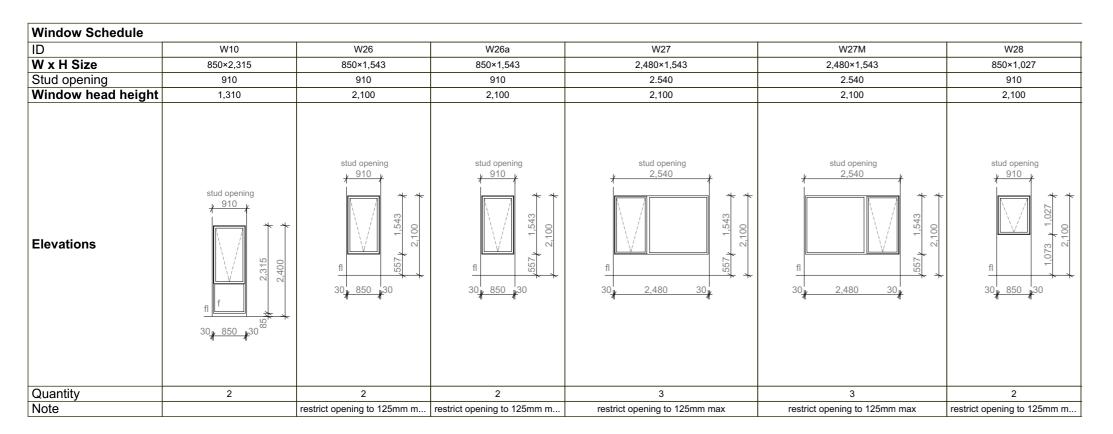



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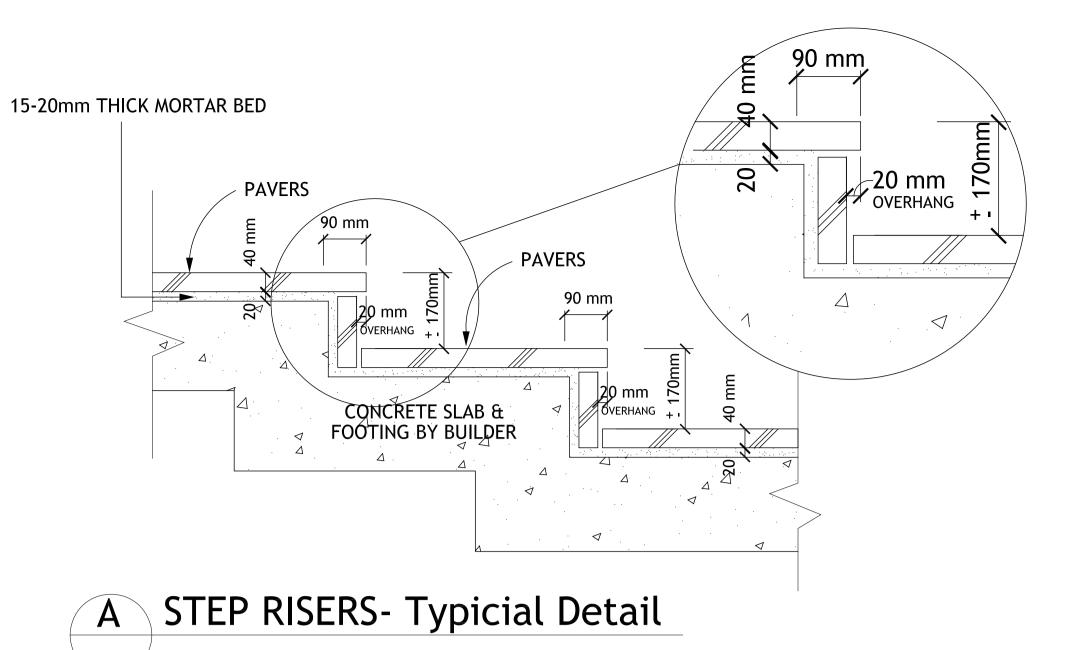
D & W Window Schedule - Windows Project Status PRELIMINARY - not for construction

Scale Drawn BK Checked ML

Drawing D & W Schedule

Drawing Number A6000 Revision

Project Number 11268



NOT TO SCALE SURFACE FINISHES SCHEDULE

PLAN SYMBOL

SECTION


DESCRIPTION






A. NOTE: CONCRETE FOOTINGS FOR FRONT STEPS TO BE DOWELLED INTO HOUSE SLAB & CONCRETE DRIVEWAY. CONFIRM & OBTAIN APPROVAL ON-SITE WITH BUILDER, THE DOWELLING METHOD, PRIOR TO WORKS BEING UNDERTAKEN.

B. NOTE: EXPANSION & CONTROL JOINTS TO ALL ADJOINING CONCRETE WORKS. CORKING TO BE INSTALLED AT ALL CONNECTIONS TO THE HOUSE, PATHS & DRIVEWAYS.

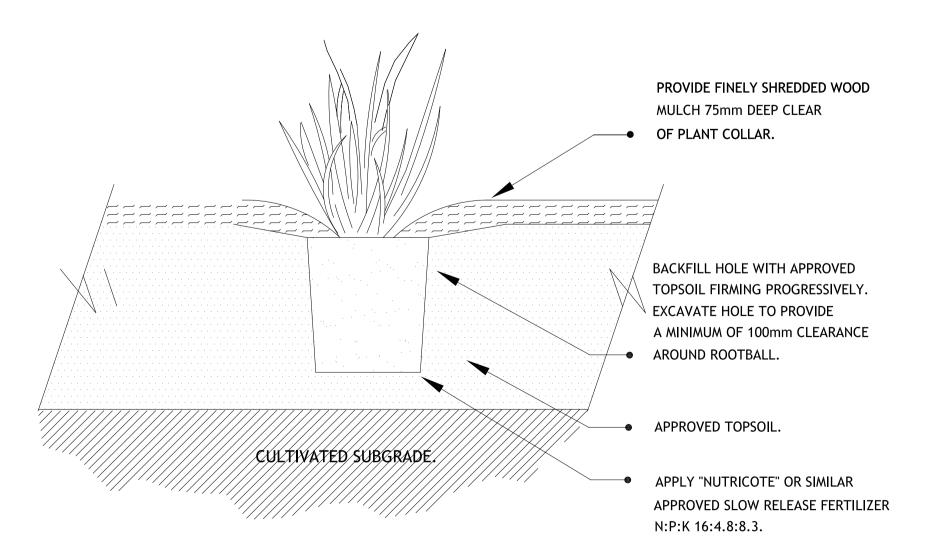



NOT TO SCALE

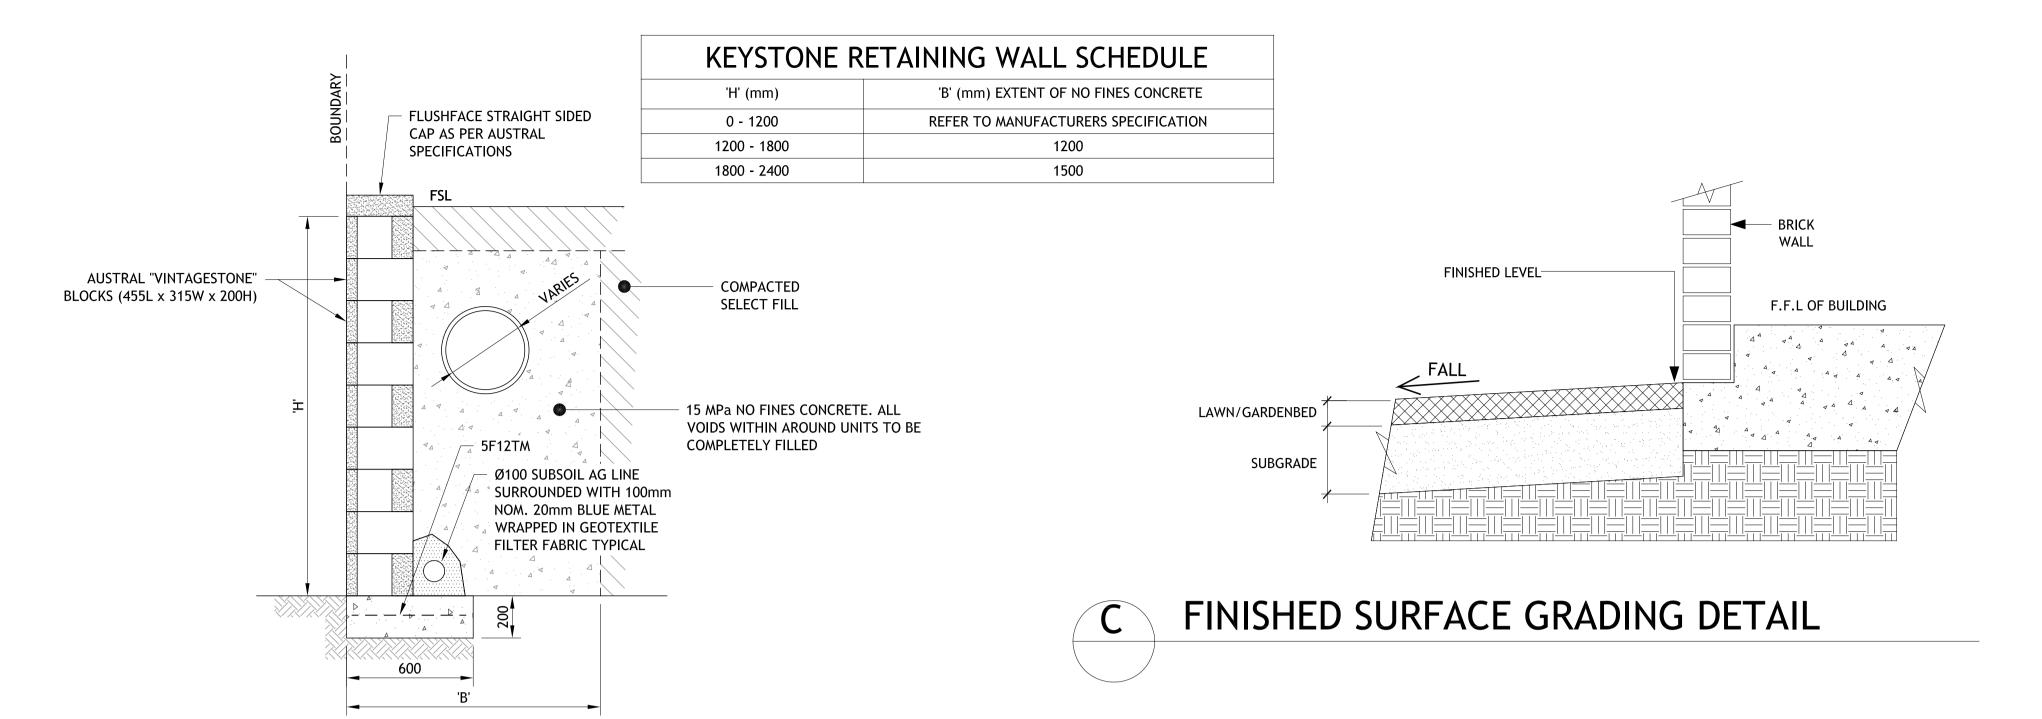




TYPICAL KEYSTONE BLOCK

RETAINING WALL

NOTE: THE ABOVE DETAIL HAS BEEN PREPARED AND PROVIDED BY CRAIG & RHODES ENGINEERS & HAS BEEN APPROVED BY COUNCIL AS PART OF THE CIVIL ENGINEERING WORKS.

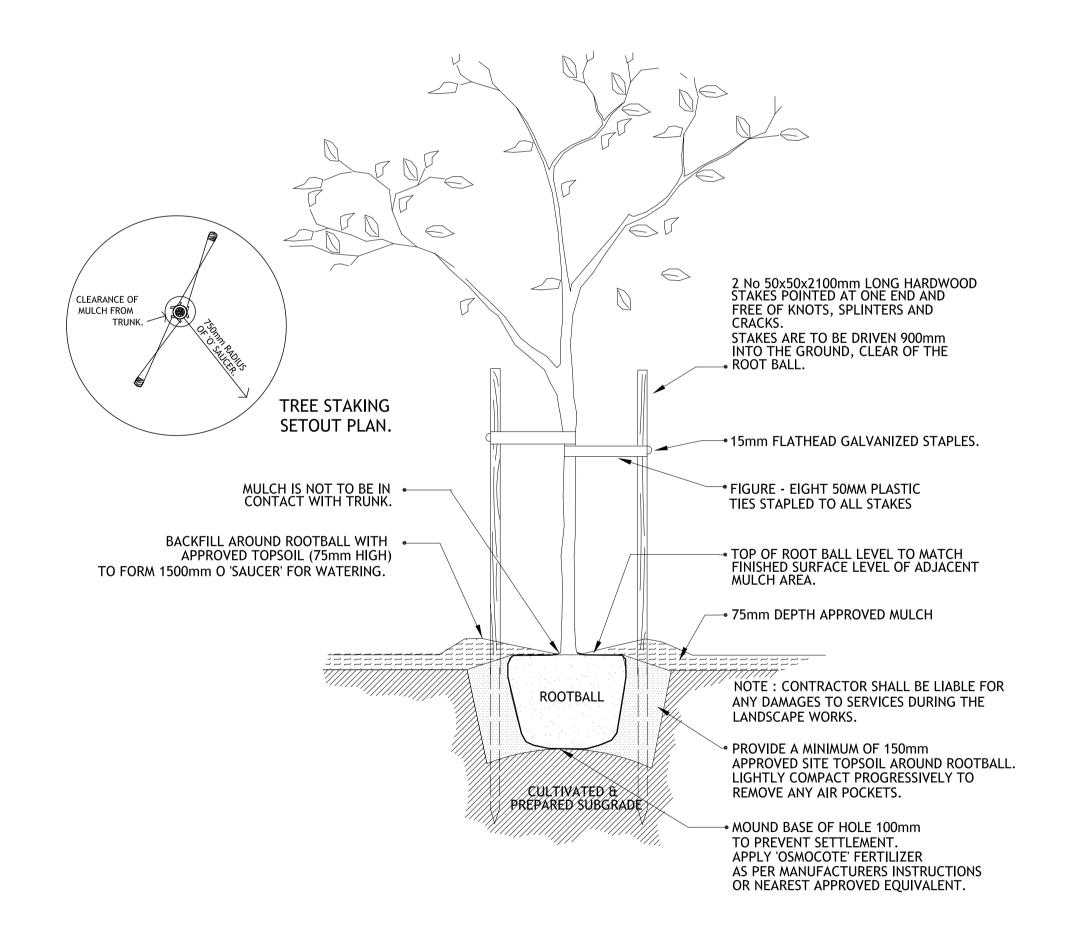

ADVANCED TREE PLANTING DETAIL- 45 Litres Tree NOTE: CONTRACTOR SHALL BE LIABLE FOR ANY DAMAGES TO SERVICES DURING THE

LANDSCAPE WORKS.

HAMILTON LANDSCAPE ARCHITECTS PTY LTD Site Planning | Urban Design | Landscape Architecture 1 York Place, Carlton VIC 3053 - Australia | Tel: +61 03 9348 2800 E-mail: office@hla.net.au | http://www.hla.net.au

MAINTENANCE & ESTABLISHMENT PERIOD

THE WHOLE OF THE WORKS SHALL BE UPHELD AGAINST ANY DEFECTS DUE TO FAULTY AND/OR POOR WORKMANSHIP AND MAINTAINED FOR A PERIOD OF 12 MONTHS.

THE FOLLOWING IS A BREAKDOWN OF ALL MAINTENANCE ITEMS INCLUDING WATERING TO BE COMPLETED.

TREES: ALL TREE STAKING TO BE MAINTAINED AS PER THE TREE PLANTING DETAILS AT ALL TIMES. STAKES & TIES TO BE STRAIGHTENED AND REPLACED TO ENSURE STABILITY. ALL TREES ARE TO BE OF SOUND STRUCTURE AND DISPLAY GOOD HEALTH AND ARE FREE OF DISEASE AND PESTS. IF ANY SPRAYING OR TREATMENT FOR PEST AND DISEASE CONTROL IS REQUIRED, THESE SHOULD BE COMPLETED AS PER MANUFACTURER'S INSTRUCTIONS.

ANY DEAD OR POOR PERFORMING TREES SHALL BE REPLACED IMMEDIATELY. TREE STAKES NEED TO BE REGULARLY MONITORED AND RELOCATED AWAY FROM TREE BRANCHES IF THEY ARE DAMAGING THE TREES. MULCH BOWLS AT THE BASE OF EACH TREE ARE TO BE WEED-FREE AT ALL TIMES AND MULCH DEPTHS REGULARLY MAINTAINED AS PER INSTALLATION TREE DETAIL.

GARDEN BEDS & PLANTING: HERBICIDE SPRAY & REMOVE ALL WEEDS, ROCKS AND RUBBISH FROM THE SITE ON A MONTHLY BASIS. FULL COVERAGE OF PLANTS TO BE REQUIRED AT THE END OF THE MAINTENANCE PERIOD. ALL MULCHED AREAS TO BE MAINTAINED AT THE NOMINATED DEPTHS AS PER THE INSTALLATION DETAILS. ANY DEAD OR POOR PERFORMING PLANTS WITHIN THE GARDEN BEDS SHALL BE REPLACED IMMEDIATELY, AT THE EXPENSE OF THE CONTRACTOR. SPRAYING OF ALL PLANTS FOR PEST AND DISEASE CONTROL TO COMPLETED ON AN 'AS NEEDS' BASIS. ANY SPRAYING OF PLANTS SHALL BE COMPLETED IN ACCORDANCE WITH THE MANUFACTURERS INSTRUCTIONS. THE SAFETY AND PRECAUTION INSTRUCTIONS ARE TO BE READ, UNDERSTOOD AND APPLIED.

GRASS SEEDED LAWNS: ALL LAWN AREAS ARE TO BE HERBICIDED ONCE PER MONTH, WITH ALL WEEDS, ROCKS AND RUBBISH REMOVED OFF-SITE. A RED-DYE IS TO BE MIXED WITH THE HERBICIDE TREATMENT TO CONFIRM A MONTHLY APPLICATION. MOW ALL AREAS & BRUSH-CUT ALL ADJOINING EDGES - 12 TIMES PER YEAR . THE HEIGHT OF GRASS IS NOT TO EXCEED 120MM HIGH. THE AVERAGE GRASS HEIGHT OF 40-60MM HIGH IS REQUIRED AT ALL TIMES. THE TIMES OF THE YEAR REQUIRING MOWING MAY VARY DEPENDING ON THE SEASON, HOWEVER THE NOMINATED HEIGHT OF GRASS IS TO BE ADHERED TOO. TOP-SOILING AND RE-SEEDING OF BARE AREAS IS TO BE COMPLETED. REGULAR FERTILIZING OF SEEDED LAWNS SHALL BE COMPLETED AS PER THE MANUFACTURERS INSTRUCTIONS. THE OWNER IS TO REGULARLY MONITOR THE IRRIGATION SYSTEM, ENSURING THE CORRECT QUANTITY AND DISTRIBUTION OF WATER TO ALL PLANTS IS BEING UNDERTAKEN. ADJUSTMENTS TO THE WATERING REGIME WILL NEED TO BE REGULATED THROUGHOUT THE YEAR, DEPENDING ON THE SEASON.

IRRIGATION SYSTEM: THE OWNER IS TO REGULARLY MONITOR THE IRRIGATION SYSTEM. ENSURING THE CORRECT QUANTITY AND DISTRIBUTION OF WATER TO ALL PLANTS IS BEING UNDERTAKEN. ADJUSTMENTS TO THE WATERING REGIME WILL NEED TO BE REGULATED THROUGHOUT THE YEAR, DEPENDING ON THE SEASON.

REGULAR MONITORING AND ASSESSMENT OF ALL IRRIGATION MATERIALS AND FIXTURES IS TO BE COMPLETED, ENSURING WATER IS BEING DISTRIBUTED TO ALL PLANTS AND TURF AREAS. REGULAR MONITORING OF THE CONTROL BOX TIMER IS TO BE COMPLETED.

> DA APPROVAL DRAWING No.


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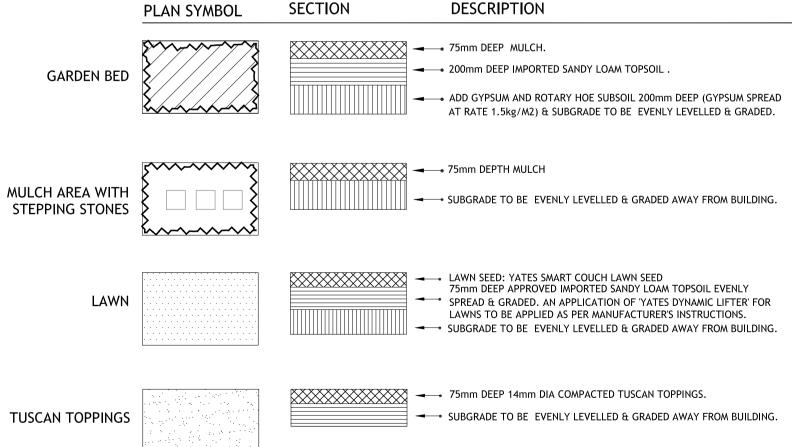
WARRIEWOOD LOT 10


DRAWING LANDSCAPE DETALS

FOR: E & P COMELLI PTY LTD FILE NAME SCALE 1:100 @ A1 DRAWN GVS DATE 01/07/2019 JOB NUMBER 19-028 A2100 Ground Floor Plan_Ground Floor

REVISION



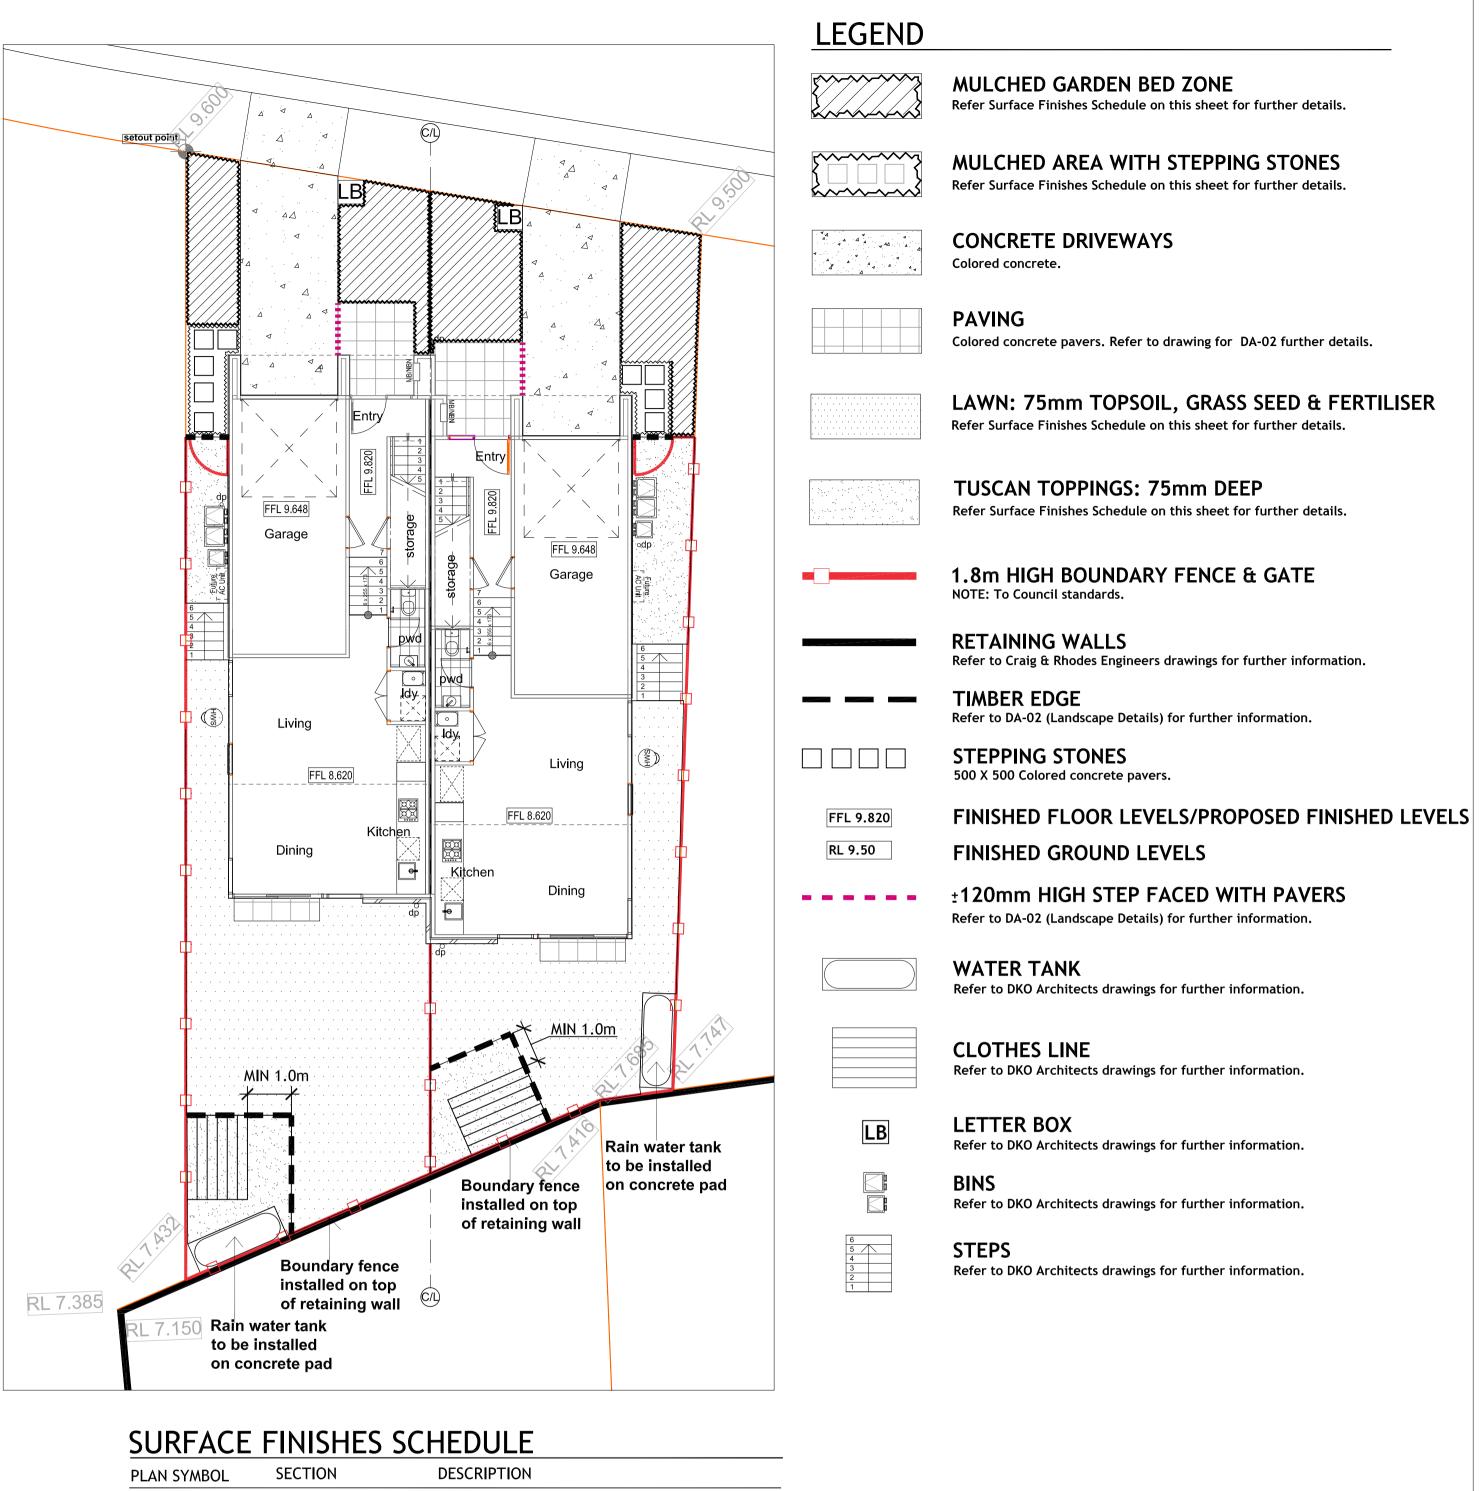

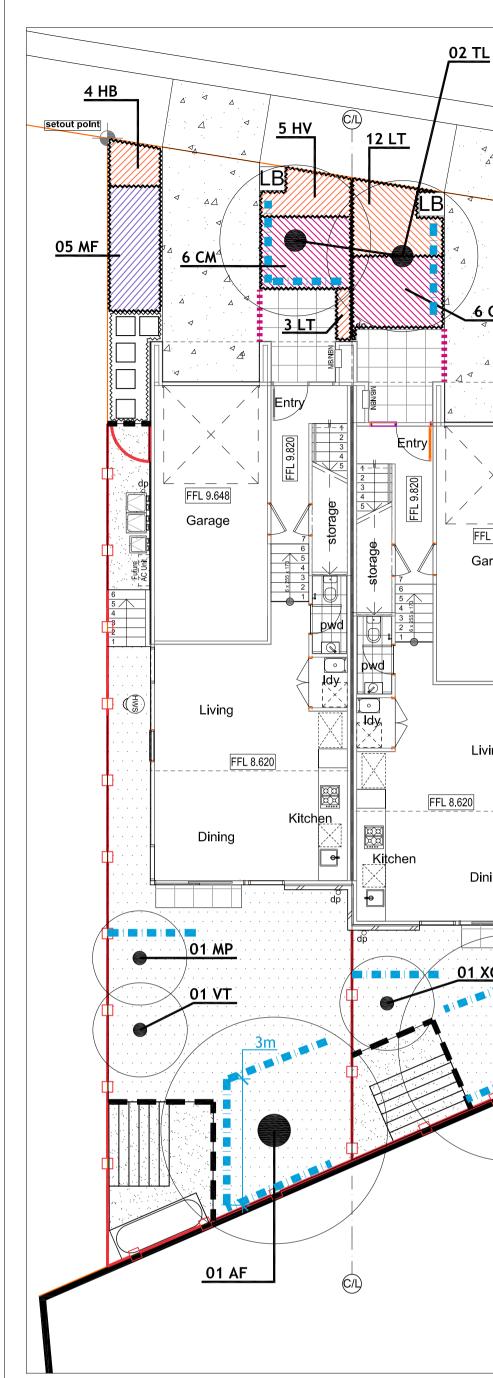

GROVE EXTENS! SITE CONTEXT PLAN

LEGEND

4_AWE

FFL 9.648

Dining

PROPOSED PLANTING

Refer to Plant Schedule on this sheet for further details.

ROOT CONTROL BARRIER

TYPE: Rootstop

SIZE: 1000mm (DEEP) x 50mm (THICK) x 3000mm (MIN. LENGTH) SUPPLIER/MANUFACTURER: ARBORGREEN-TEL. 1300 760 642 NOTES: Installed as per supplier/manufacturer instructions. Contractor to provide written confirmation stating all Root control



PROPOSED TREES


Refer to Plant Schedule on this sheet for further details.

PLANT SCHEDULE

Code	Botanical Name	Common Name	Height & Width	Spacing	Pot Size/ Bag Size	Quantity
	TREES (REAR YARDS)					
**AF	ANGOPHORA floribunda	Rough-barked Apple	18m x 8m	As shown	1.8m/45 Litre	01
**EH	EUCALYPTUS haemastoma	Broad leaved Scribbly gum	12-15m x 5m	As shown	1.8m/45 Litre	01
·	TREES (FRONT GARDENS &	SIDE OF HOUSE)				
**TL	TRISTANIOPSIS laurina	Kanooka Gum	12m x 4-6m	As shown	1.8m/45 Litre	02
**XC	XANTHOSTEMON chrysanthus	Golden Penda	6-10m x 3-4m	As shown	1.8m/45 Litre	01
**MP	MURRAYA paniculata	Orange Jessamine	2m x 2.5m	As shown	1.8m/45 Litre	01
**VT	VIBURNUM tinus	Laurustinus	3m x 2.5m	As shown	1.8m/45 Litre	e 01
	LARGE SHRUBS					_
MF	MICHELIA figo	Port Wine Magnolia	2.5m x 2m	As shown	200mm	05
VO	VIBURNUM odoratissimum	Sweet Viburnum	4-6m x 4m	As shown	200mm	08
	MEDIUM SHRUBS AND TUFTI	ED PLANTS				
WE	WESTRINGIA 'Wynyabbie gem'	Westringia Wynyabbie Gem	1.5m x 1.2m	As shown	200mm	04
CM	CORREA 'Marians Marvel"	Correa	1.5x 1.5m	As shown	200mm	06
GS	GREVILLEA sericea	Pink Spider Flower	1.5x 1.5m	As shown	200mm	06
	GROUNDCOVERS & TUFTED	PLANTS				
ĹŢ	TRACHELOSPERMUM jasminoides	Star Jasmine	0.5m x 1m	As shown	200mm	03
LT	LOMANDRA 'Tanika'	Tanika	0.7m x 0.7m	As shown	200mm	15
HV	HARDENBERGIA violacea 'Meema'	Native Sarsparilla	0.5x 1.0m	As shown	200mm	05
НВ	HIBBERTIA scandens	Golden Guinea Flower	1.3x 1.0m	As shown	200mm	04

NOTES: All 45 Litre Trees planted in the rear of lots to have Root control barriers.

- All large shrubs planted down the side of houses to have Root control barriers.
- ** All Trees to be Planted as 45 Litre container. Refer to installation detail on DA-02.
- # Plant Species have been selected from the following sources:
- 1. PDCP 21 Control D16.5 Landscaped Areas for Newly Created Individual Allotments-Plant lists;
- 2. Warriewood Valley Landscape Masterplan and Urban Design Guidelines-Plant List 3. Pittwater Council-Native Plants for Your Garden-Lowlands Plant List;
- 4. Pittwater Council-Prelodgement Report-Recommended Plants; # Less than 20% of the shrub species are exotic species and within the 30% allowable range.

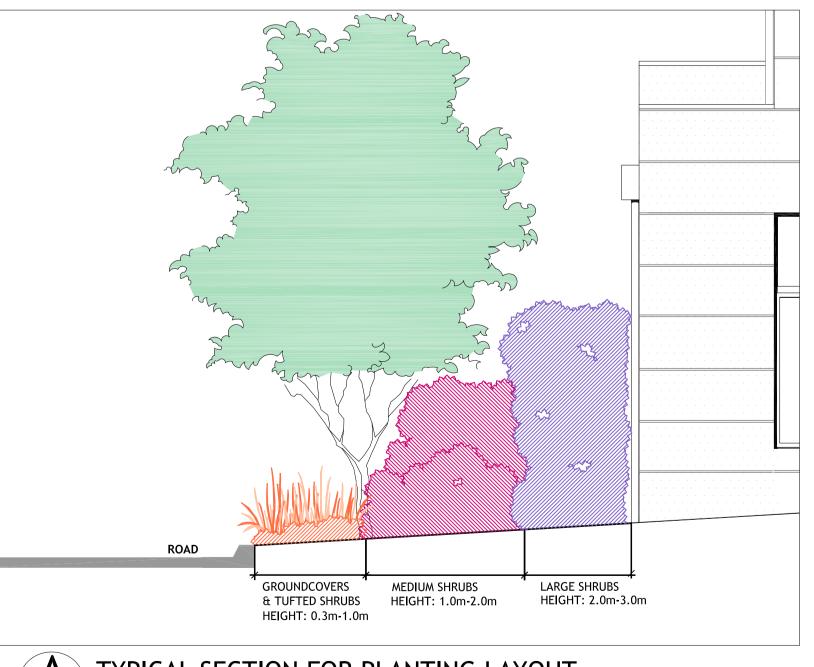

A TYPICAL SECTION FOR PLANTING LAYOUT

DA APPROVAL



HAMILTON LANDSCAPE ARCHITECTS PTY LTD

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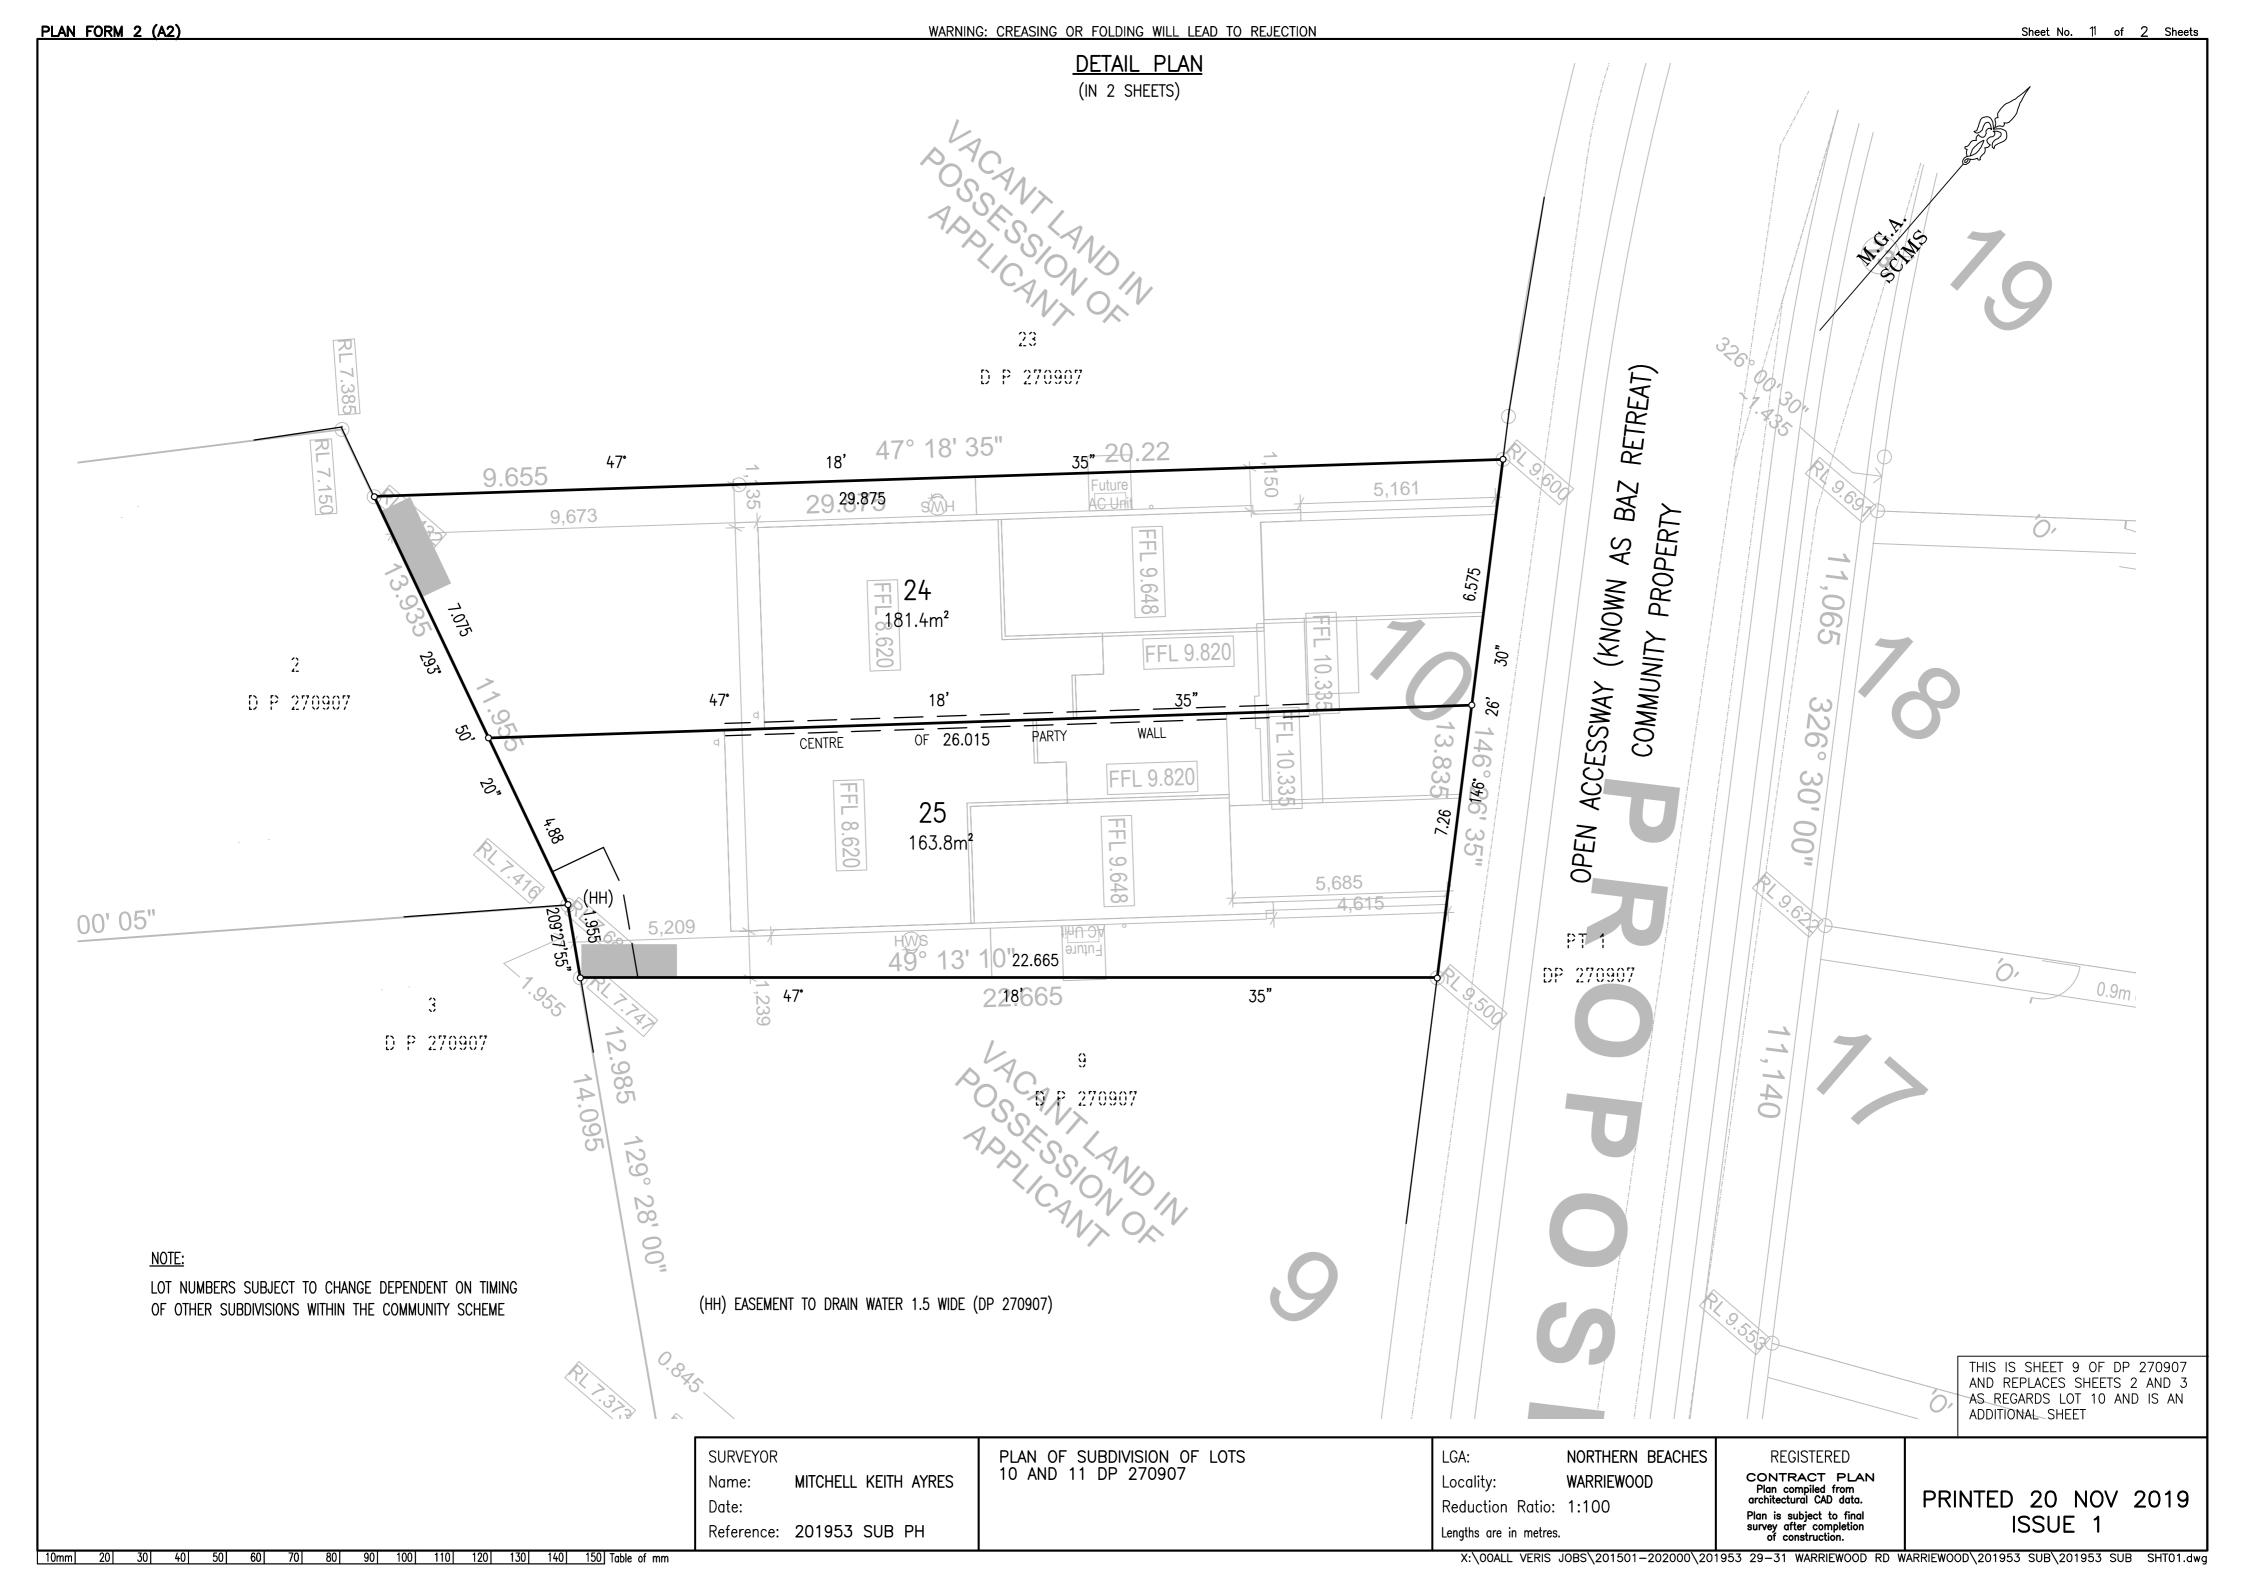
WARRIEWOOD LOT 10



DA-01 REVISION

DRAWING No.

FOR: E & P COMELLI PTY LTD FILE NAME DRAWING SURFACE FINISHES & PLANTING PLAN SCALE 1:100 @ A1 DRAWN GVS DATE 01/07/2019 JOB NUMBER 19-028 A2100 Ground Floor Plan_Ground Floor



- (0) EASEMENT FOR ACCDESS CONSTRUCTION & MAINTENANCE 0.9 WIDE (DP 270907)
- (W) EASEMENT FOR ACCESS, MAINTENANCE & SUPPORT 0.9 WIDE (DP 1206507)

THIS IS SHEET 10 OF DP 270907 AND REPLACES SHEETS 2 AND 4 AS REGARDS LOT 11 AND IS AN ADDITIONAL SHEET

SURVEYOR

Name: MITCHELL KEITH AYRES

Date:

Reference: 201953 SUB PH

PLAN OF SUBDIVISION OF LOTS 10 AND 11 DP 270907

LGA: NORTHERN BEACHES
Locality: WARRIEWOOD

Reduction Ratio: 1:100

Lengths are in metres.

REGISTERED

CONTRACT PLAN
Plan compiled from architectural CAD data.

Plan is subject to final survey after completion of construction.

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