



### GENERAL:

BUILD NEW TIMBER FRAME WALLS IN 90 BY 45 H2 MPG10 PINE TO A.S LINE WALLS IN 10mm GYPROCK & VILLABOARD TO BATHROOM AND LAUNDRY WALLS WATER PROOF BATHROOM AND LAUNDRY TO A.S

 $_{\oplus}^{\mathsf{SA}}$  smoke alarm to as

HW INSTATANIOUS HOT WATER SYSTEM

### **NOTES:**

PLANS TO BE READ IN CONJUNCTION WITH STRUCTURAL ENGINEERS PLANS AND DETAILS PLANS ARE FOR APPROVALS ONLY & NOT TO BE USED FOR CONSTRUCTION OR TENDER PERPOSES. DO NOT SCALE DRAWING. VERIFY ALL SETTING OUT DIMENSIONS ON SITE.


DRAWING TITLE: PLAN VIEW SHOWING: PROPOSED GROUND FLOOR

PROJECT: 1 COTENTIN ROAD BELROSE

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A06

LOT 1 DP237435

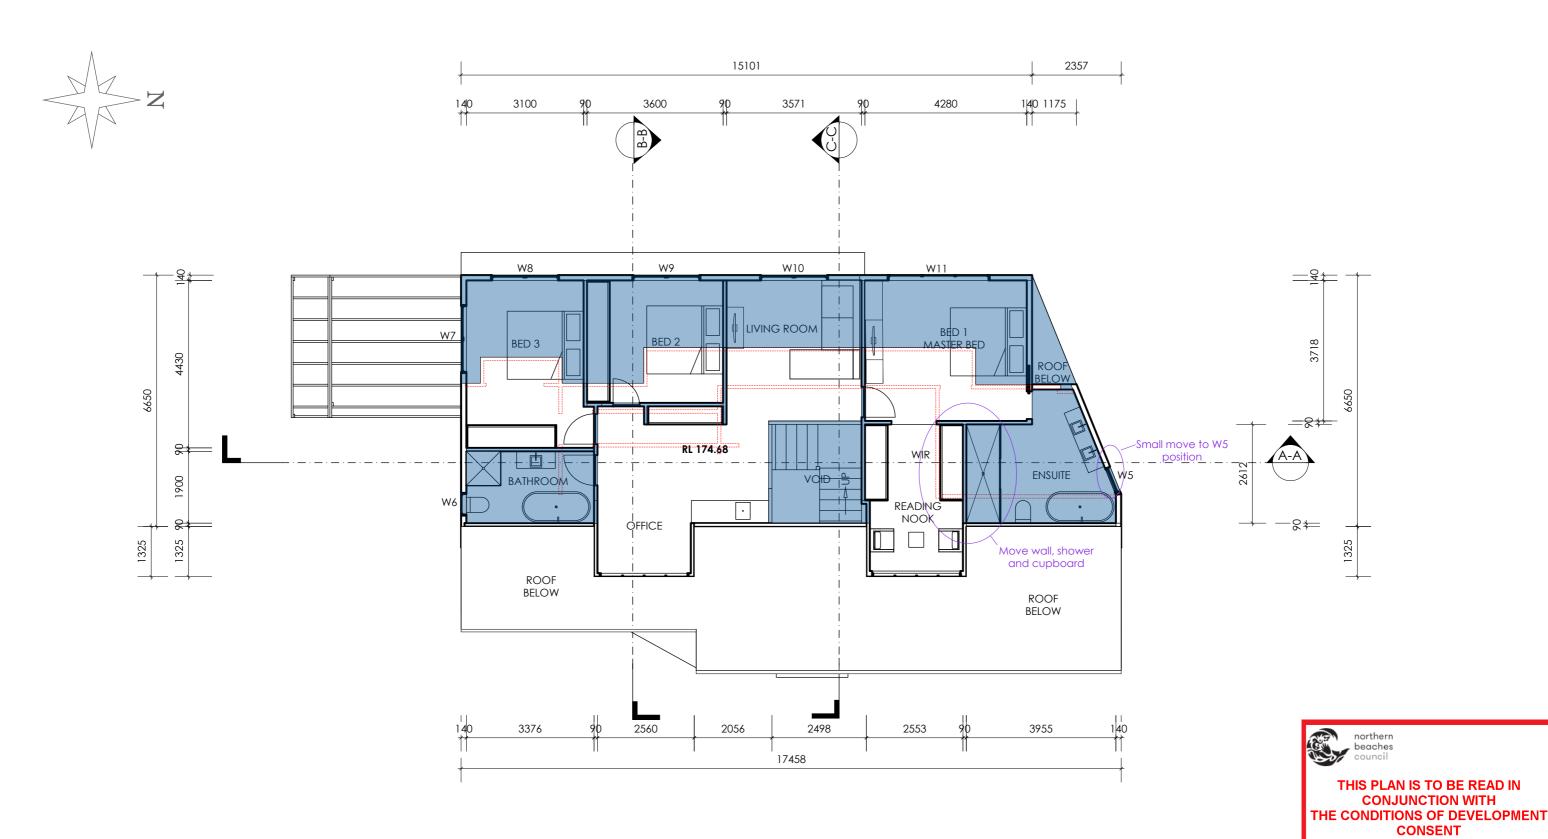

# **PLAN VIEW PROPOSED**



#### GENERAL:

BUILD NEW TIMBER FRAME WALLS IN 90 BY 45 H2 MPG10 PINE TO A.S LINE IN 10mm GYPROCK & VILLABOARD TO BATHROOMAND LAUNDRY WALLS WATER PROOF BATHROOM AND LAUNDRY TO A.S

 $^{\mathsf{SA}}_{\oplus}$  hardwired interconnected smoke alarm to as

# NOTES:

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DRAWING TITLE: PLAN VIEW

SHOWING: PROPOSED FIRST FLOOR EXTENSION


PROJECT: 1 COTENTIN ROAD BELROSE

LOT 1 DP237435

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MOD2020/0263

**80A** 



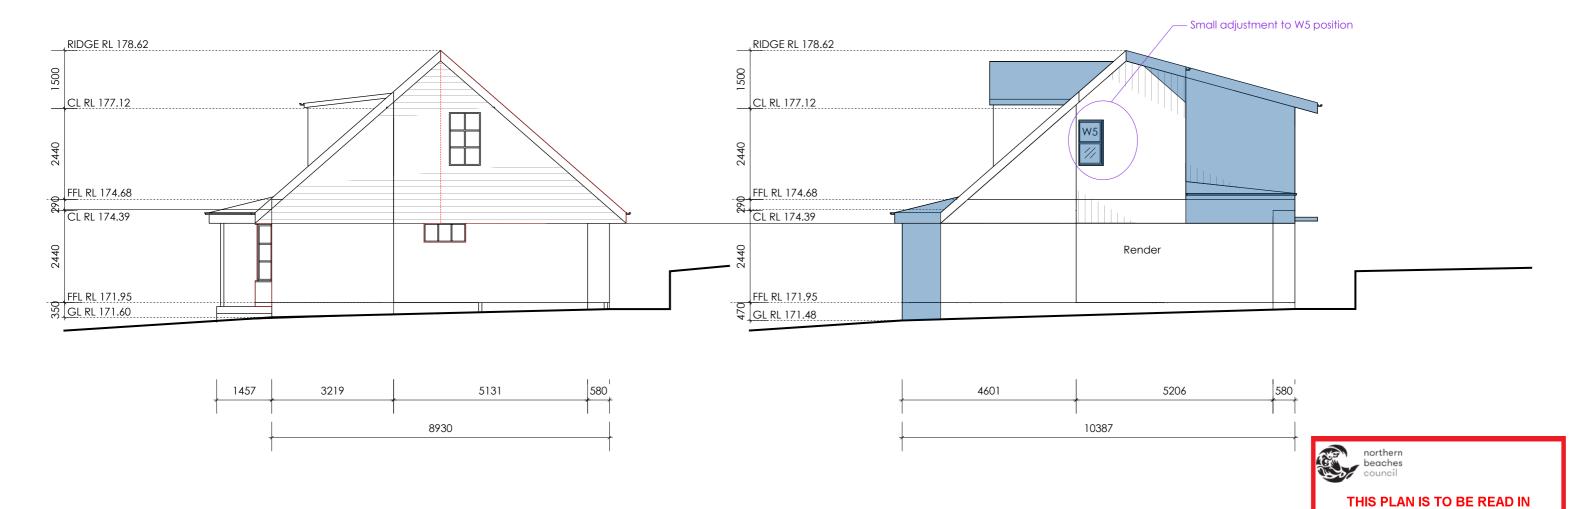





# NOTES:

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DRAWING TITLE:	NORTH ELEVA	ΓΙΟΝ
SHOWING: EXISTIN	NG AND PROPOSE	D

PROJECT: 1 COTENTIN ROAD BELROSE

LOT 1 DP237435

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CONJUNCTION WITH
THE CONDITIONS OF DEVELOPMENT
CONSENT

MOD2020/0263

**A09** 

24/02/2020 SCALE:1:100

ENSIONS 24/02/2020

### DEMOLITION

IN ACCORDANCE WITH AS 2601-2001 THE DEMOLITION OF STRUCTURES


Machine only needed for minor trim and edge thicknings to slab area


Bin to be placed after entry for spoil


### DEMOLITION

Rear of building to be hand demolition sorted in rear yard and placed in appropriate recycling bins

A small trailor pump will be placed on the drive and small concrete truck used on drive. All works will be within the property boundaries.

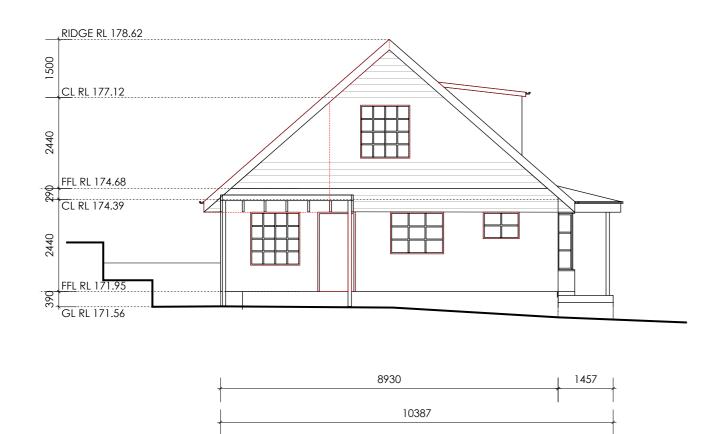

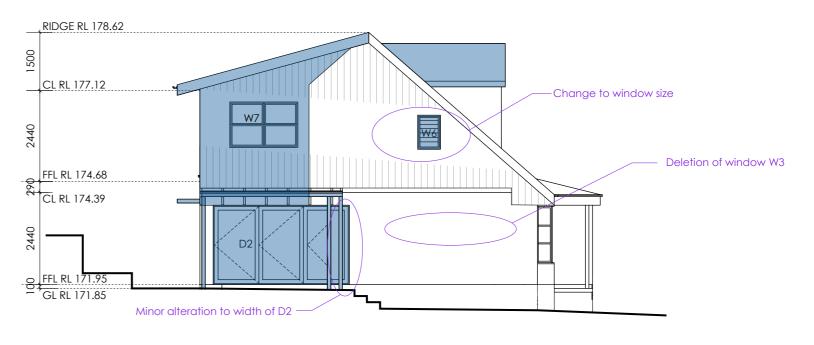

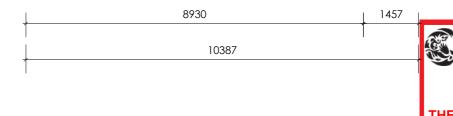

THIS PLAN IS TO BE READ IN **CONJUNCTION WITH** THE CONDITIONS OF DEVELOPMENT CONSENT MOD2020/0263

northern

# **SOUTH ELEVATION EXISTING DEMOLITION PLAN**

# **SOUTH ELEVATION PROPOSED**



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DRAWING TITLE: SOUTH ELEVATION SHOWING: EXISTING WITH DEMOLITION & PROPOSED

PROJECT: 1 COTENTIN ROAD BELROSE LOT 1 DP237435

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**A12** 

SCALE:1:100

24/02/2020

### ROOFING

'COLOURBOND' METAL ROOFING, CAPPINGS AND FLASHINGS STANDARD 115 QUAD GUTTER 90mm PVC DOWNPIPE

### PROPOSED EXTENSION FRAMING TIMBER FRAME TO A.S 1684.2 -2010

RESIDENTIAL TIMBER FRAMED
CONSTRUCTION
WALL FRAME
H2/T2 90 BY 45 MPG 10 STUDS NOGGINS AND PLATES
ROOF FRAME
H2/T2 200 BY 45 LVL RAFTERS & CEILING JOISTS
22mm LSOP FASCIA BOARD





THIS PLAN IS TO BE READ IN
CONJUNCTION WITH
THE CONDITIONS OF DEVELOPMENT
CONSENT

MOD2020/0263

# WEST ELEVATION PROPOSED



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DRAWING TITLE: **WEST ELEVATION** SHOWING: ALTERATIONS AND ADDITIONS

PROJECT: 1 COTENTIN ROAD BELROSE
LOT 1 DP237435

**A14** 

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90 BY 45 H2 STUDS @ 600c 90 BY 45 H2 NOGGINS @ 1.200c MAX 90 BY 45 H2 PLATES/ 2 TOP 1 BOTTOM **EXTERIOR WALLS CLAD IN Weathertex** Eaves 4.5mm fibro, H mold

19 LOSP fascia board

T2 pine 19 by 45 wall batten between sarking and cladding Insulation and sarking to BASIX requirements

Tie down and bracing to AS NCC and BCA requirements

### Concrete

WALL FRAMES

Raft slab to engineers design Blob and strip footing to engineers design



THIS PLAN IS TO BE READ IN **CONJUNCTION WITH** THE CONDITIONS OF DEVELOPMENT CONSENT

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**A15** 

# SECTION A-A SCALE1:100



TIMBER FRAME TO A.S 1684.2 -2010 RESIDENTIAL TIMBER FRAMED CONSTRUCTION TIMBER FRAME H2 MINIMUM TREATMENT CONCRETE TO ENGINEERS DESIGN LVL BEAMS, RAFTERS & LINTEL SPANS TO BE PROVIDED

# NOTES:

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DRAWING TITLE: SECTION A-A


SHOWING: SECTION CUT OF PROPOSED EXTENSION


PROJECT: 1 COTENTIN ROAD BELROSE


LOT 1 DP237435


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SCALE:1:100 24/02/2020



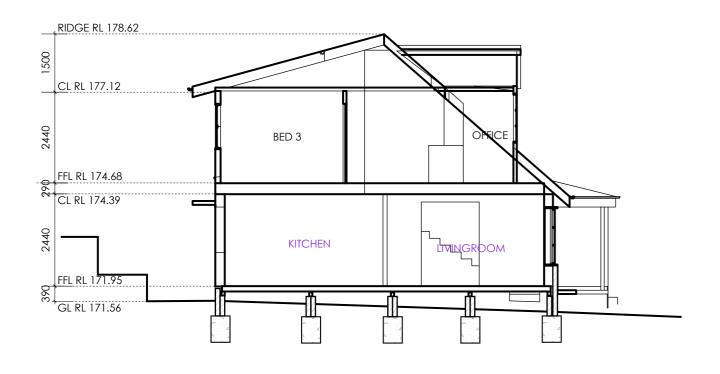

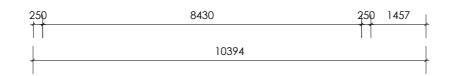

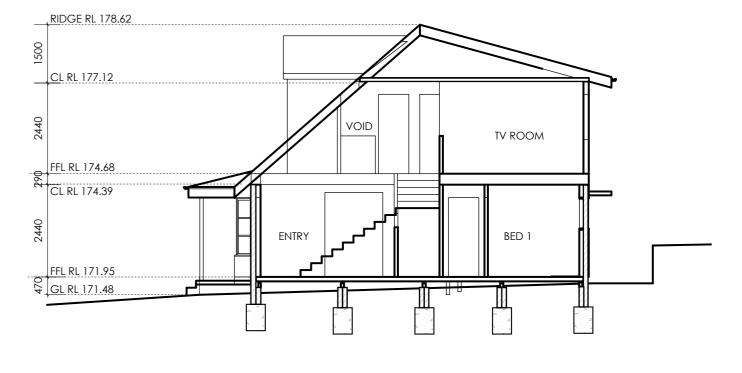

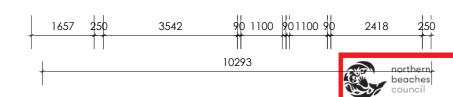THIS PLAN IS TO BE READ IN
CONJUNCTION WITH
THE CONDITIONS OF DEVELOPMENT
CONSENT

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**A16** 

# SECTION B-B SCALE1:100



#### GENERAL

TIMBER FRAME TO A.S 1684.2 -2010
RESIDENTIAL TIMBER FRAMED CONSTRUCTION
TIMBER FRAME H2 MINIMUM TREATMENT
CONCRETE TO ENGINEERS DESIGN
LVL BEAMS, RAFTERS & LINTEL SPANS TO BE PROVIDED

# NOTES:

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SECTION C-C SCALE1:100

DRAWING TITLE: SECTION B-B, C-C SHOWING: SECTION CUT OF PROPOSED EXTENSION

SHOWING: SECTION CUT OF PROPOSED EXTENSION

PROJECT: 1 COTENTIN ROAD BELROSE LOT 1 DP237435

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24/02/2020 SCALE:1:100 & 1:50