

## CARPORT AND FRONT YARD PLAN



John Wright

**NETWORK DESIGN**

a.b.n.52 057 985 118

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**ALTERATIONS AND ADDITIONS**

77A MYOLA ROAD  
NEWPORT LOT 1 DP715601

**CLIENT**

JON MILLIGAN

**CARPORT AND FRONT YARD PLAN**

**DATE**

NOVEMBER 2018

**DRAWN**

J.WRIGHT

**DRG. NO.**

11-18-MYO

**SCALE**


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**ISSUE:**


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**SHEET NO.**


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**SOUTH ELEVATION**






**WEST ELEVATION**

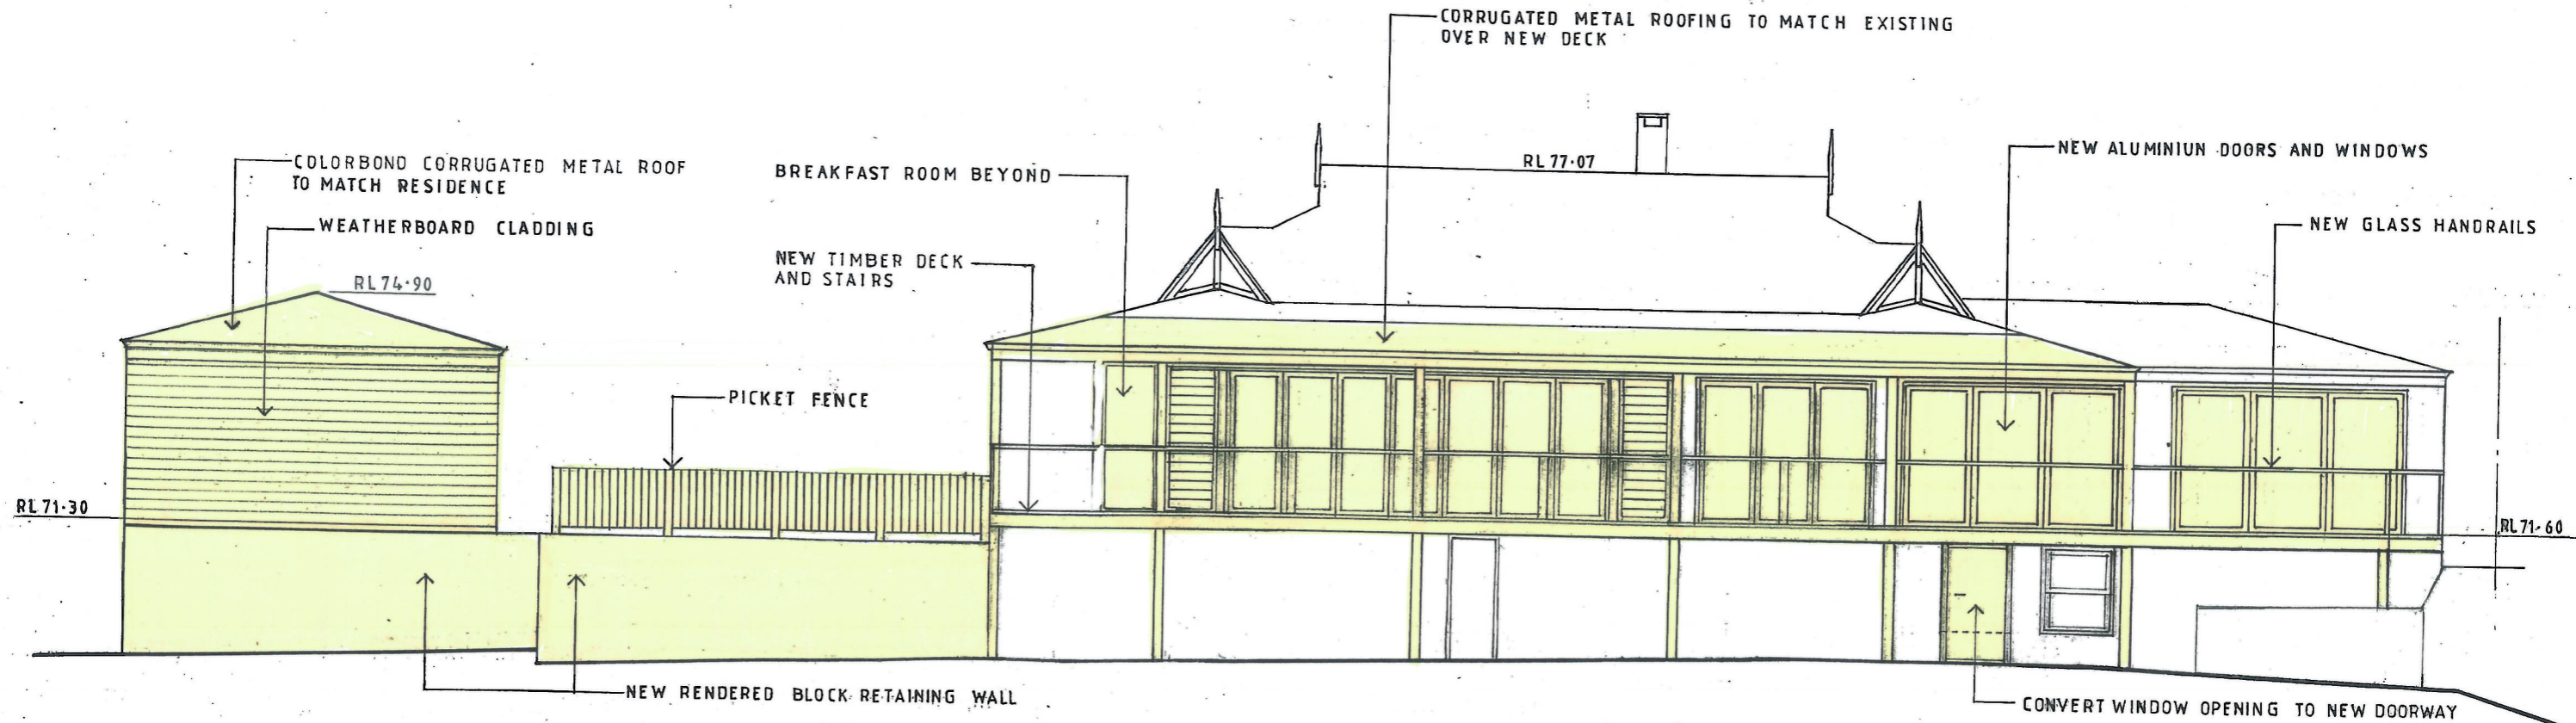

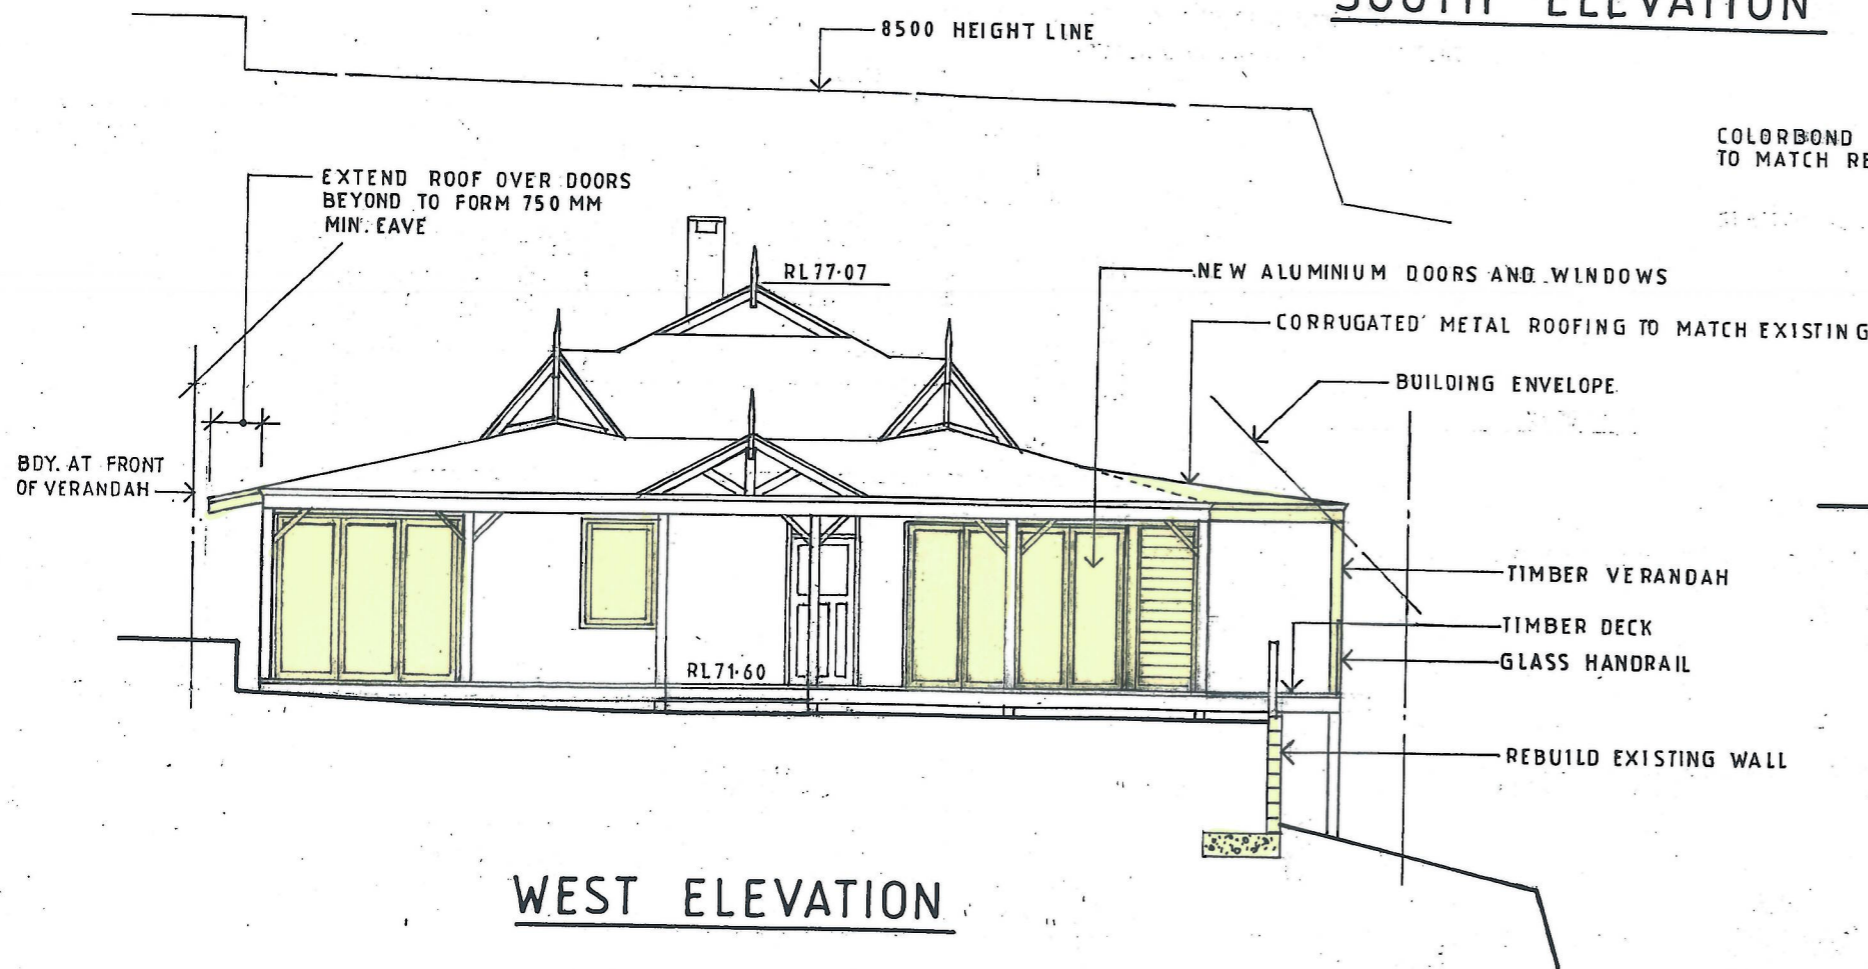**CARPORT WEST ELEVATION**

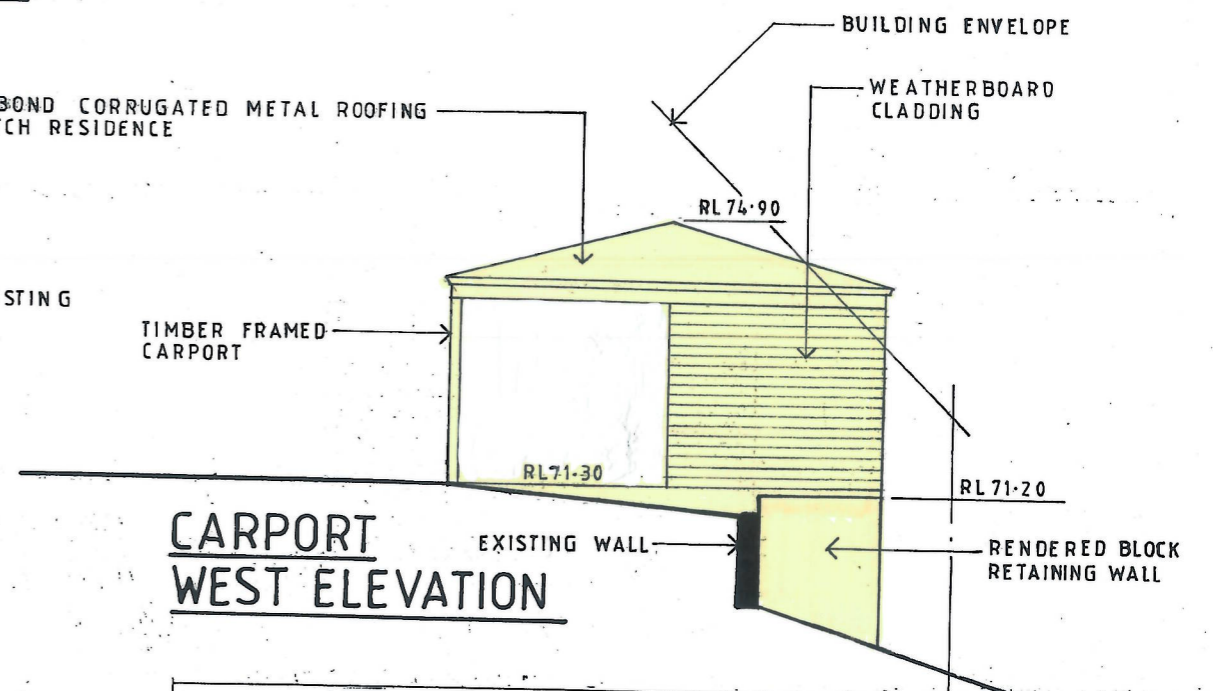 <p>John Wright</p> <p><b>NETWORK DESIGN</b> a.b.n.52 057 985 118 37 McKillop Road Beacon Hill 2100 M. 0417 459 596 alwayswright@optusnet.com.au</p>	<p><b>ALTERATIONS AND ADDITIONS</b> 77A MYOLA ROAD NEWPORT LOT 1 DP715601</p> <p>CLIENT JON MILLIGAN</p>		
	<p><b>SOUTH AND WEST ELEVATION</b></p>		
<p>DATE NOVEMBER 2018</p>	<p>DRAWN J.WRIGHT</p>	<p>DRG. NO. 11-18-MYO</p>	
<p>SCALE 1:100</p>	<p>ISSUE: DA</p>	<p>SHEET NO. 4</p>	

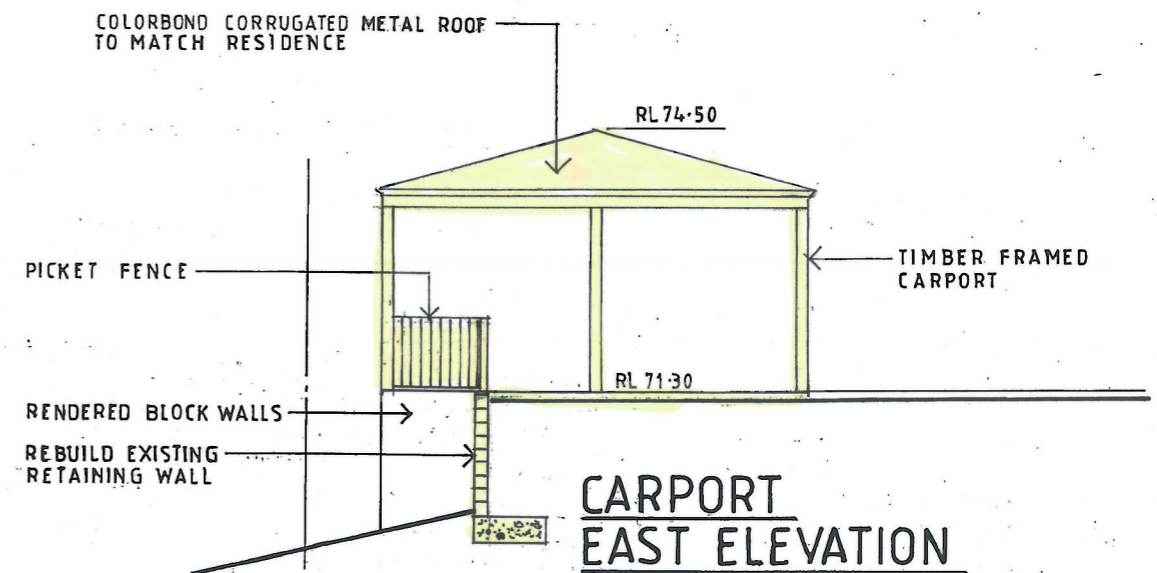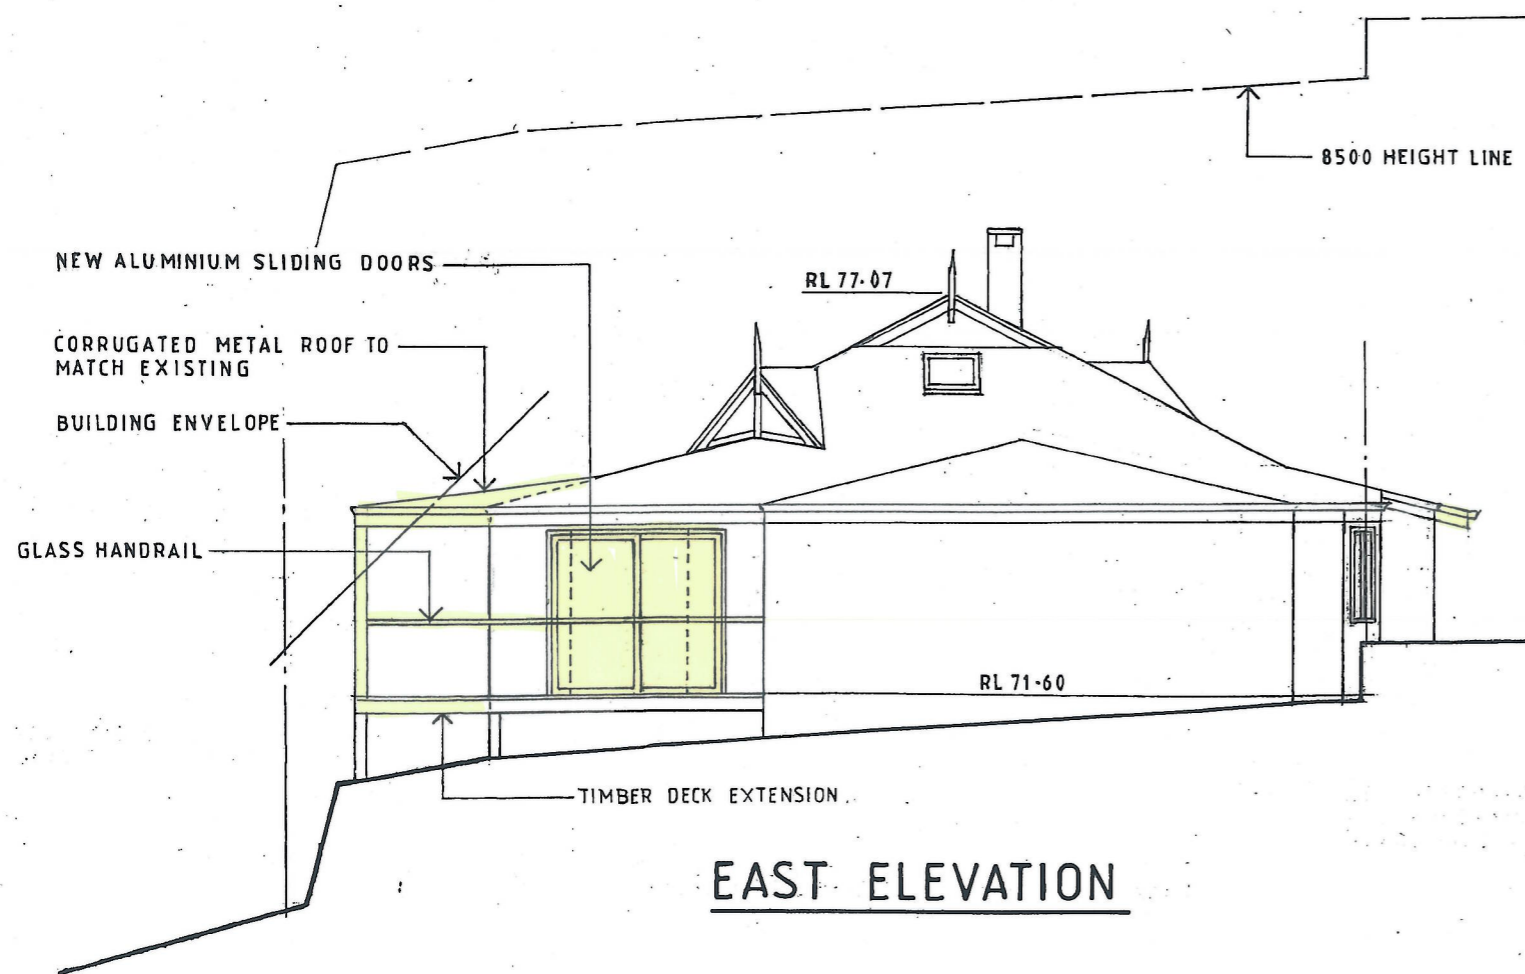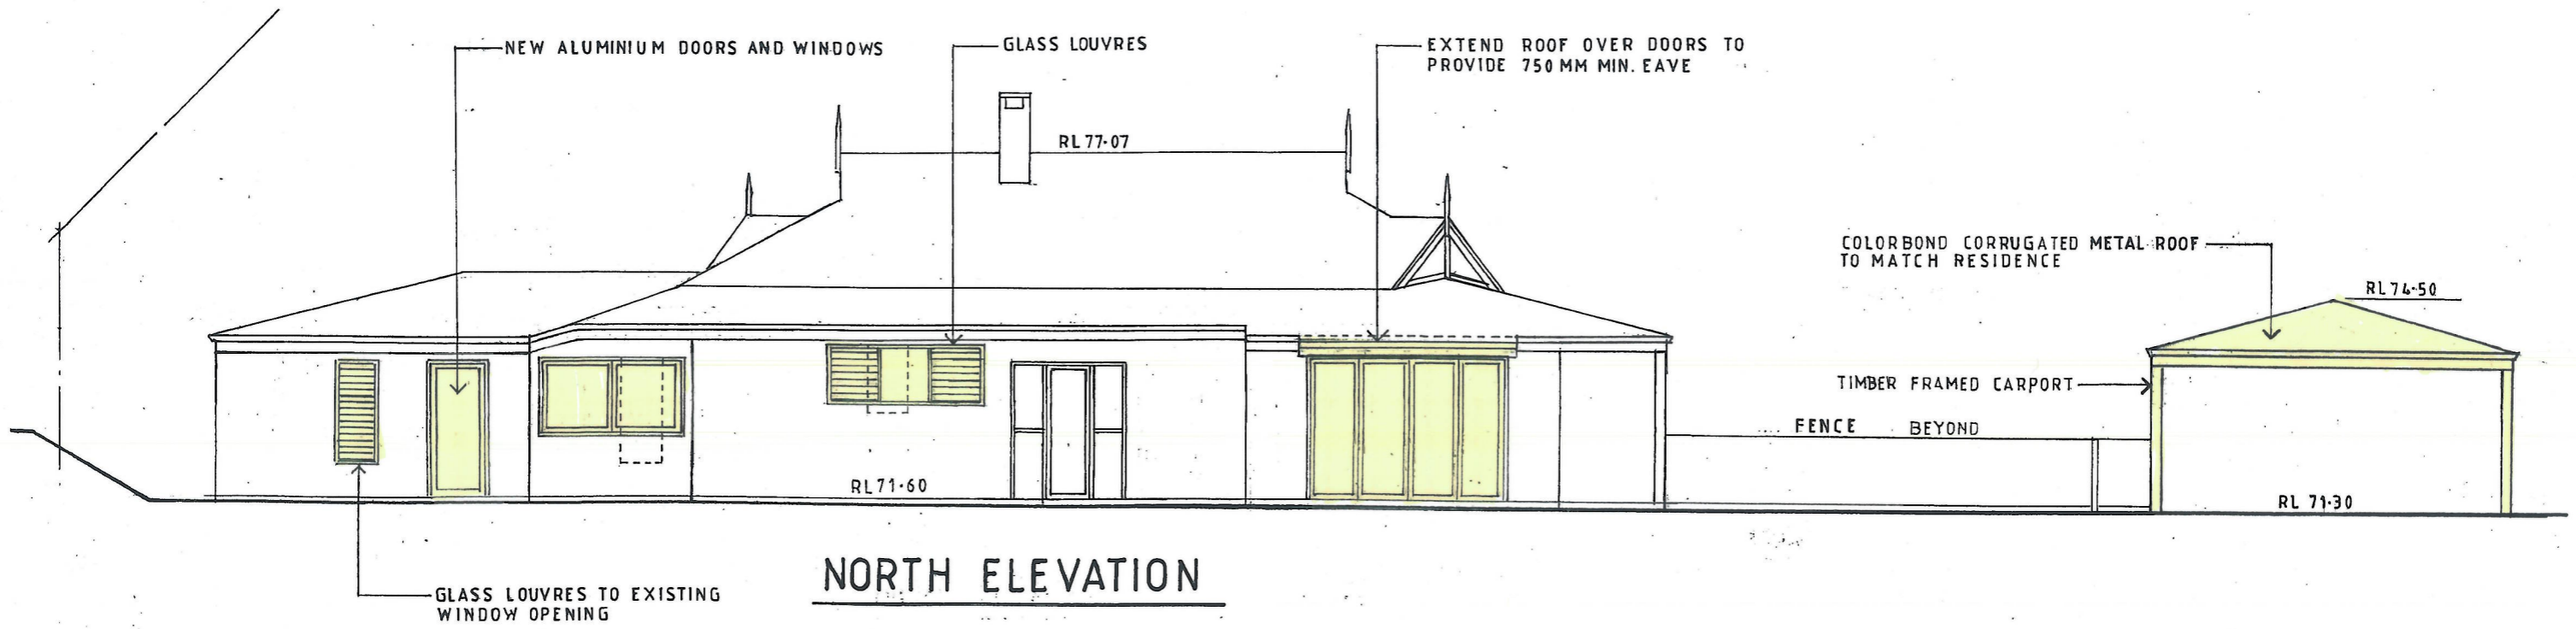


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<b>ALTERATIONS AND ADDITIONS</b>		
77A MYOLA ROAD NEWPORT LOT 1 DP715601		
CLIENT JON MILLIGAN		
<b>NORTH AND EAST ELEVATION</b>		
DATE NOVEMBER 2018	DRAWN J.WRIGHT	DRG. NO. 11-18-MYO
SCALE 1:100	ISSUE: DA	SHEET NO. 5

BUNGAN HEAD ROAD

DRIVEWAY TO MYOLA ROAD

SHARED

**Site Calculations m<sup>2</sup>**

Site Area .....	851.8
<b>Landscaped Area</b>	
Proposed vegetated area (44.5%).....	379.3
Required (60%).....	511.1
Increase in BUA.....	19.2


EXTEND ROOF

TN


**SITE PLAN**

**Sediment and Erosion Control**

- Install 600 high silt fence as shown.
- Clear fences of sediment periodically and after periods of heavy rain.
- Repair any damage to silt fence immediately.
- Brush clean truck tyres before leaving site.
- Clean up spillages outside silt fence immediately.
- Sediment control measures to be left in place until boundary fences and landscaping works commence.

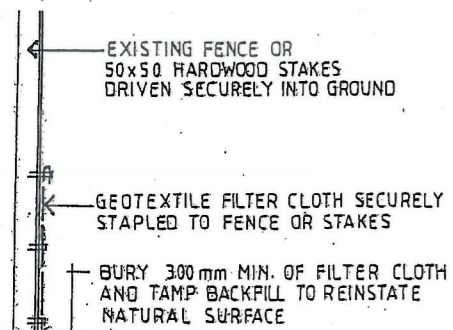

**SILT FENCE  
DETAIL**

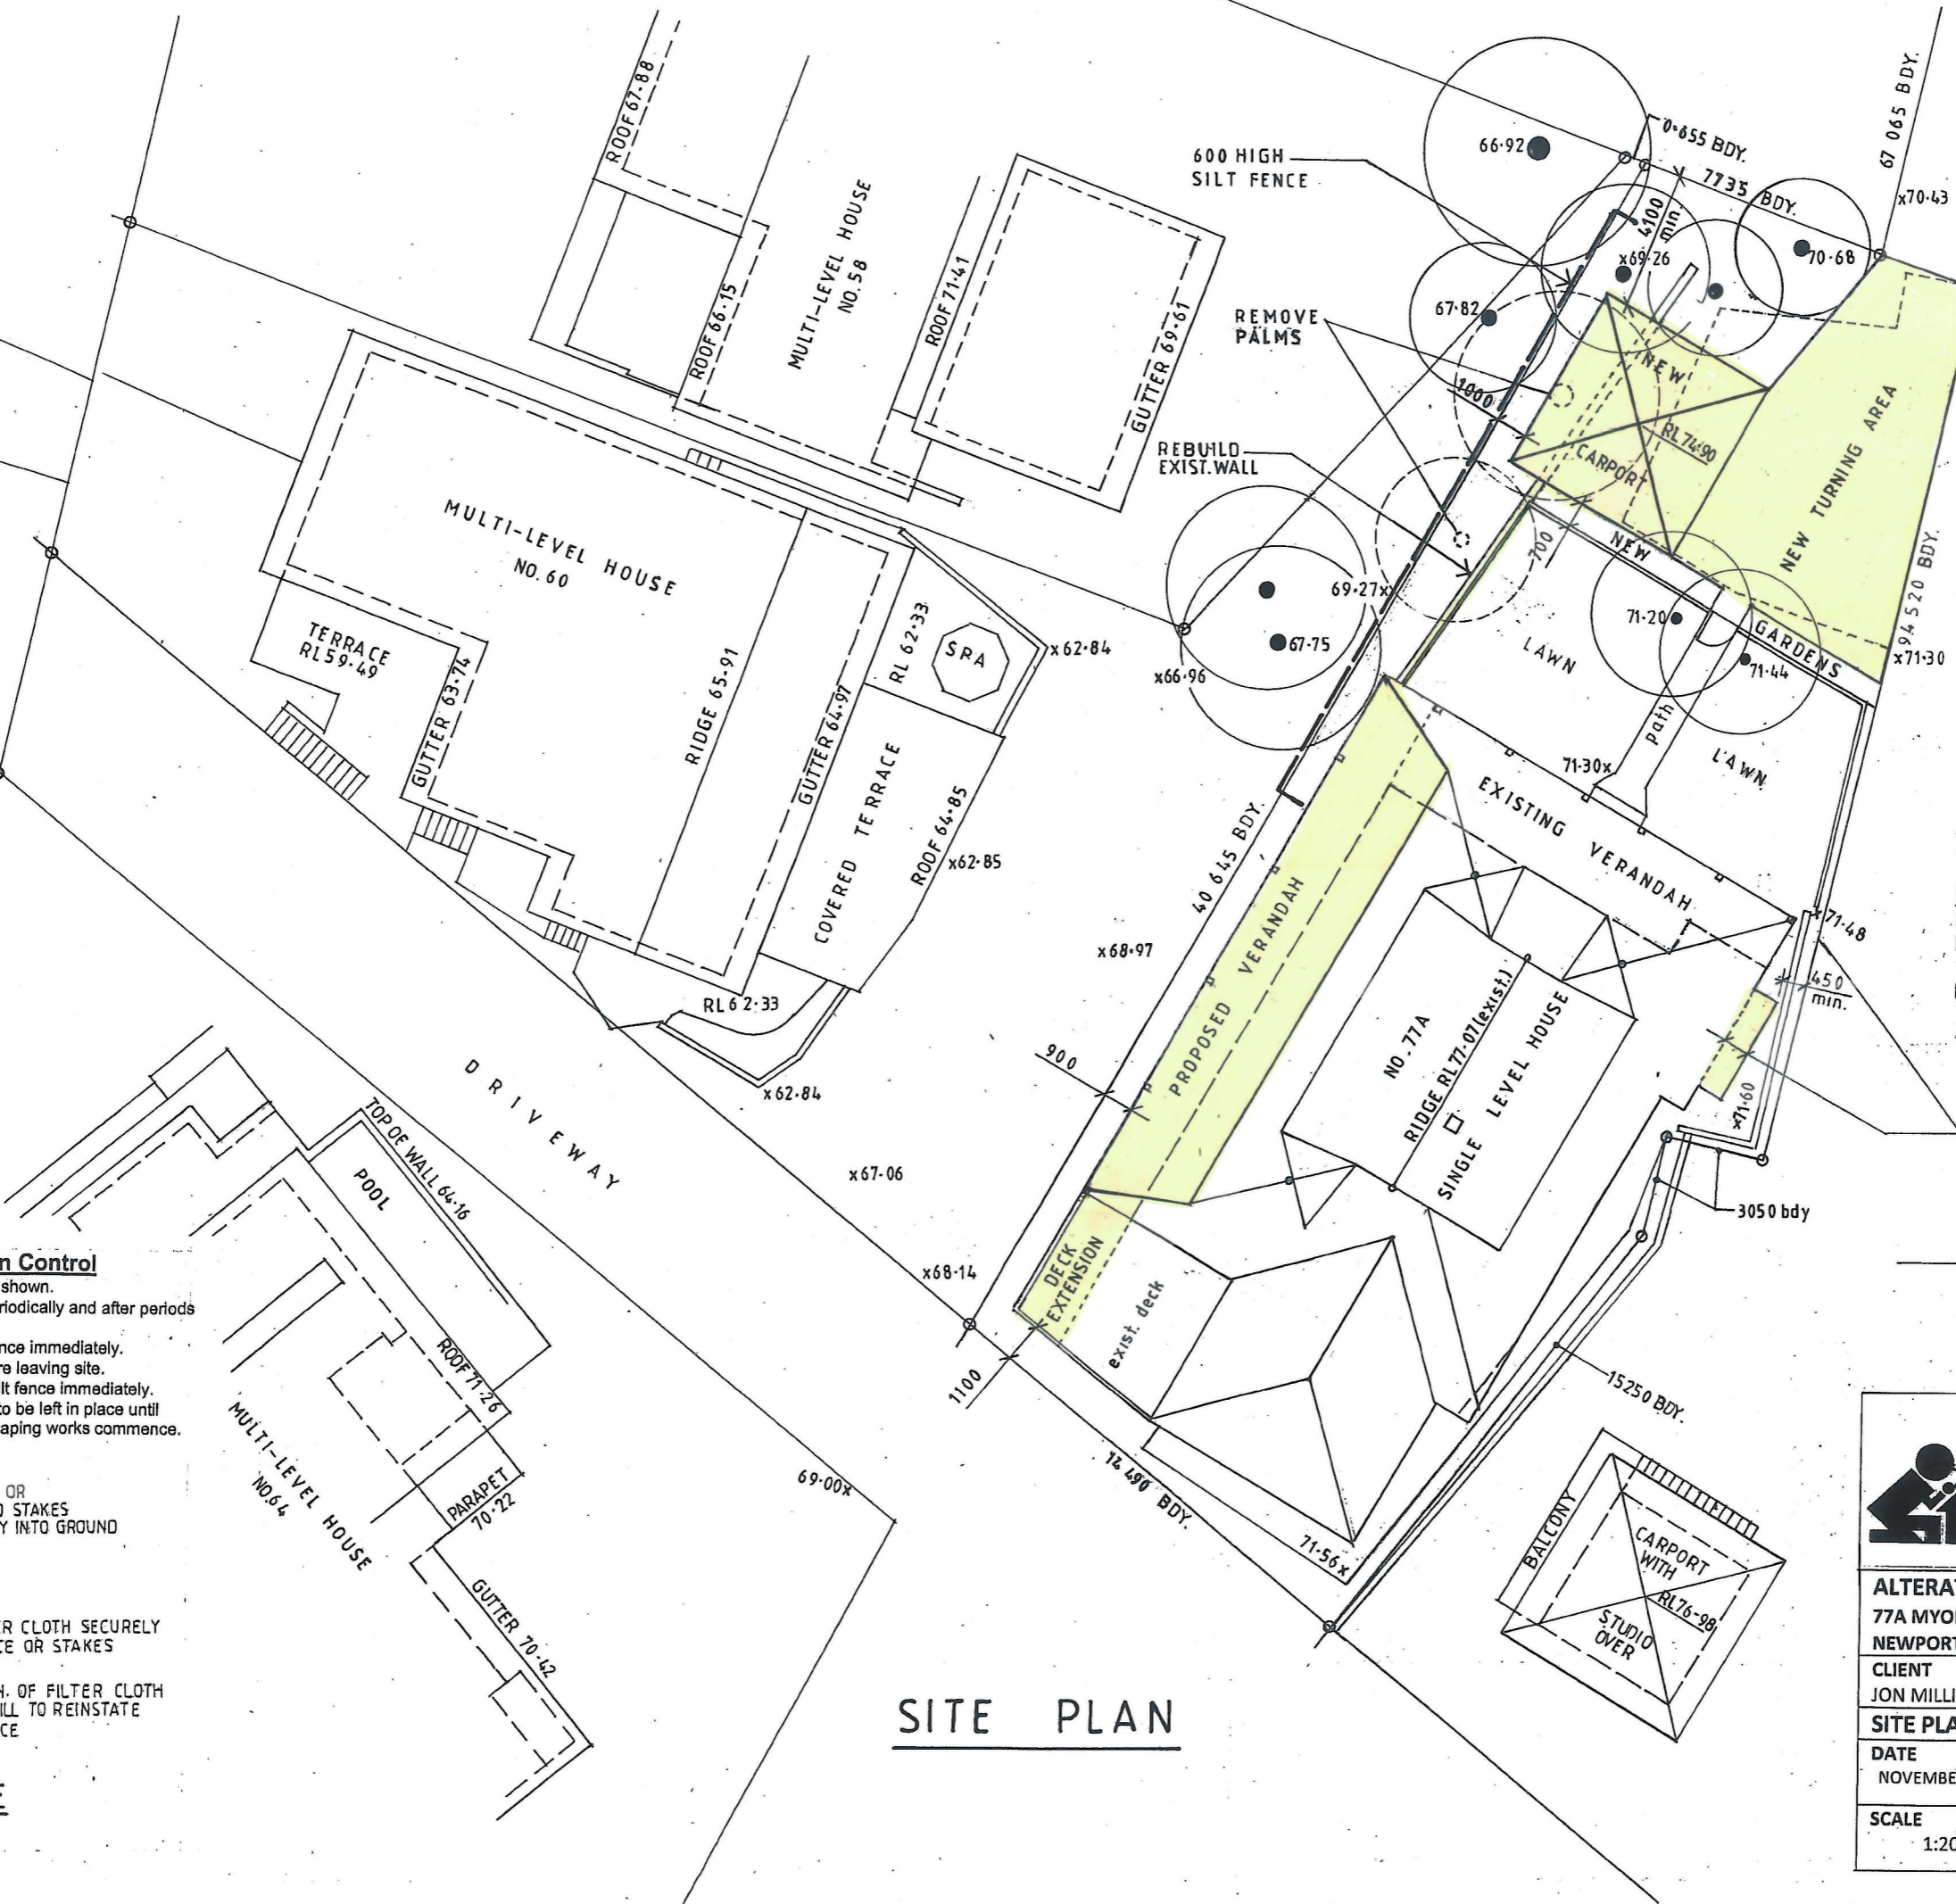

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**ALTERATIONS AND ADDITIONS**  
77A MYOLA ROAD  
NEWPORT LOT 1 DP715601

CLIENT  
JON MILLIGAN

**SITE PLAN AND CALCULATIONS**

DATE NOVEMBER 2018	DRAWN J.WRIGHT	DRG. NO. 11-18-MYO
SCALE 1:200	ISSUE: DA	SHEET NO. 7

# BASIX Certificate

Building Sustainability Index www.basix.nsw.gov.au

## Alterations and Additions

Certificate number: A348164\_02

This certificate confirms that the proposed development will meet the NSW government's requirements for sustainability, if it is built in accordance with the commitments set out below. Terms used in this certificate, or in the commitments, have the meaning given by the document entitled "BASIX Alterations and Additions Definitions" dated 06/10/2017 published by the Department. This document is available at www.basix.nsw.gov.au

Secretary  
Date of issue: Thursday, 12, December 2019  
To be valid, this certificate must be lodged within 3 months of the date of issue.



### Description of project

Project address	
Project name	77A Myola Road, Newport_02
Street address	77A Myola Road Newport 2106
Local Government Area	Northern Beaches Council
Plan type and number	Deposited Plan 715601
Lot number	1
Section number	
Project type	
Dwelling type	Separate dwelling house
Type of alteration and addition	My renovation work is valued at \$50,000 or more, and does not include a pool (and/or spa).

### Fixtures and systems

#### Lighting

The applicant must ensure a minimum of 40% of new or altered light fixtures are fitted with fluorescent, compact fluorescent, or light-emitting-diode (LED) lamps.

#### Fixtures

The applicant must ensure new or altered showerheads have a flow rate no greater than 9 litres per minute or a 3 star water rating.

The applicant must ensure new or altered toilets have a flow rate no greater than 4 litres per average flush or a minimum 3 star water rating.

The applicant must ensure new or altered taps have a flow rate no greater than 9 litres per minute or minimum 3 star water rating.

### Construction

#### Insulation requirements

The applicant must construct the new or altered construction (floor(s), walls, and ceilings/roofs) in accordance with the specifications listed in the table below, except that a) additional insulation is not required where the area of new construction is less than 2m<sup>2</sup>, b) insulation specified is not required for parts of altered construction where insulation already exists.

Construction	Additional insulation required (R-value)	Other specifications
external wall: framed (weatherboard, fibro, metal clad)	R1.30 (or R1.70 including construction)	

### Glazing requirements

#### Windows and glazed doors

The applicant must install the windows, glazed doors and shading devices, in accordance with the specifications listed in the table below. Relevant overshadowing specifications must be satisfied for each window and glazed door.

The following requirements must also be satisfied in relation to each window and glazed door:

Each window or glazed door with improved frames, or pyrolytic low-e glass, or clear/air gap/clear glazing, or toned/air gap/clear glazing must have a U-value and a Solar Heat Gain Coefficient (SHGC) no greater than that listed in the table below. Total system U-values and SHGCs must be calculated in accordance with National Fenestration Rating Council (NFRC) conditions. The description is provided for information only. Alternative systems with complying U-value and SHGC may be substituted.

For projections described in millimetres, the leading edge of each eave, pergola, verandah, balcony or awning must be no more than 500 mm above the head of the window or glazed door and no more than 2400 mm above the sill.

Pergolas with polycarbonate roof or similar translucent material must have a shading coefficient of less than 0.35.

Pergolas with fixed battens must have battens parallel to the window or glazed door above which they are situated, unless the pergola also shades a perpendicular window. The spacing between battens must not be more than 50 mm.

Overshadowing buildings or vegetation must be of the height and distance from the centre and the base of the window and glazed door, as specified in the 'overshadowing' column in the table below.

#### Windows and glazed doors glazing requirements

Window / door no.	Orientation	Area of glass inc. frame (m <sup>2</sup> )	Overshadowing		Shading device	Frame and glass type
			Height (m)	Distance (m)		
D1	NW	6.75	0	0	eave/verandah/pergola/balcony >=900 mm	improved aluminium, single clear, (U-value: 6.44, SHGC: 0.75)
W2	NW	1.28	0	0	eave/verandah/pergola/balcony >=900 mm	improved aluminium, single clear, (U-value: 6.44, SHGC: 0.75)
W3	SW	2.03	0	0	eave/verandah/pergola/balcony >=900 mm	improved aluminium, single clear, (U-value: 6.44, SHGC: 0.75)
D4	NW	5.67	0	0	eave/verandah/pergola/balcony >=900 mm	improved aluminium, single clear, (U-value: 6.44, SHGC: 0.75)
D5	NE	7.43	0	0	eave/verandah/pergola/balcony >=750 mm	improved aluminium, single pyrolytic low-e, (U-value: 4.48, SHGC: 0.46)
W6	NE	2.25	1.9	1.4	none	improved aluminium, single pyrolytic low-e, (U-value: 4.48, SHGC: 0.46)
W7	NE	2.64	2.2	0.9	none	improved aluminium, single pyrolytic low-e, (U-value: 4.48, SHGC: 0.46)
D8	NE	1.81	2.7	1.55	none	improved aluminium, single pyrolytic low-e, (U-value: 4.48, SHGC: 0.46)
D9	SW	8.78	0	0	eave/verandah/pergola/balcony >=900 mm	improved aluminium, single clear, (U-value: 6.44, SHGC: 0.75)
D10	SE	5.4	0	0	eave/verandah/pergola/balcony >=900 mm	improved aluminium, single clear, (U-value: 6.44, SHGC: 0.75)
D11	SW	7.92	0	0	eave/verandah/pergola/balcony >=900 mm	improved aluminium, single clear, (U-value: 6.44, SHGC: 0.75)
D12	SW	6.71	0	0	eave/verandah/pergola/balcony >=900 mm	improved aluminium, single clear, (U-value: 6.44, SHGC: 0.75)
W13	SW	1.8	0	0	eave/verandah/pergola/balcony >=900 mm	improved aluminium, single clear, (U-value: 6.44, SHGC: 0.75)
D14	SW	13.75	0	0	eave/verandah/pergola/balcony >=900 mm	improved aluminium, single clear, (U-value: 6.44, SHGC: 0.75)
W15	SW	1.8	0	0	eave/verandah/pergola/balcony >=900 mm	improved aluminium, single clear, (U-value: 6.44, SHGC: 0.75)
W16	NW	1.8	0	0	eave/verandah/pergola/balcony >=900 mm	improved aluminium, single clear, (U-value: 6.44, SHGC: 0.75)
W17	NW	1.11	2.2	1.2	none	improved aluminium, single pyrolytic low-e, (U-value: 4.48, SHGC: 0.46)



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### ALTERATIONS AND ADDITIONS

77A MYOLA ROAD  
NEWPORT LOT 1 DP715601

#### CLIENT

JON MILLIGAN

#### BASIX COMMITMENTS

DATE	DRAWN	DRG. NO.
NOVEMBER 2018	J. WRIGHT	11-18-MYO
SCALE	ISSUE:	SHEET NO.
1:100	DA	8

BUNGAN HEAD ROAD

PROPOSED ADDITIONAL SHADOW STRIKES ROOFS

PROPOSED ADDITIONAL SHADOW FALLS WITHIN EXISTING TREE SHADOW

9AM WINTER SHADOW PLAN

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**ALTERATIONS AND ADDITIONS**  
 77A MYOLA ROAD  
 NEWPORT LOT 1 DP715601


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**CLIENT**  
 JON MILLIGAN

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**9AM WINTER SHADOW PLAN**

<b>DATE</b> NOVEMBER 2018	<b>DRAWN</b> J.WRIGHT	<b>DRG. NO.</b> 11-18-MYO
<b>SCALE</b> 1:200	<b>ISSUE:</b> DA	<b>SHEET NO.</b> 9



BUNGAN HEAD ROAD

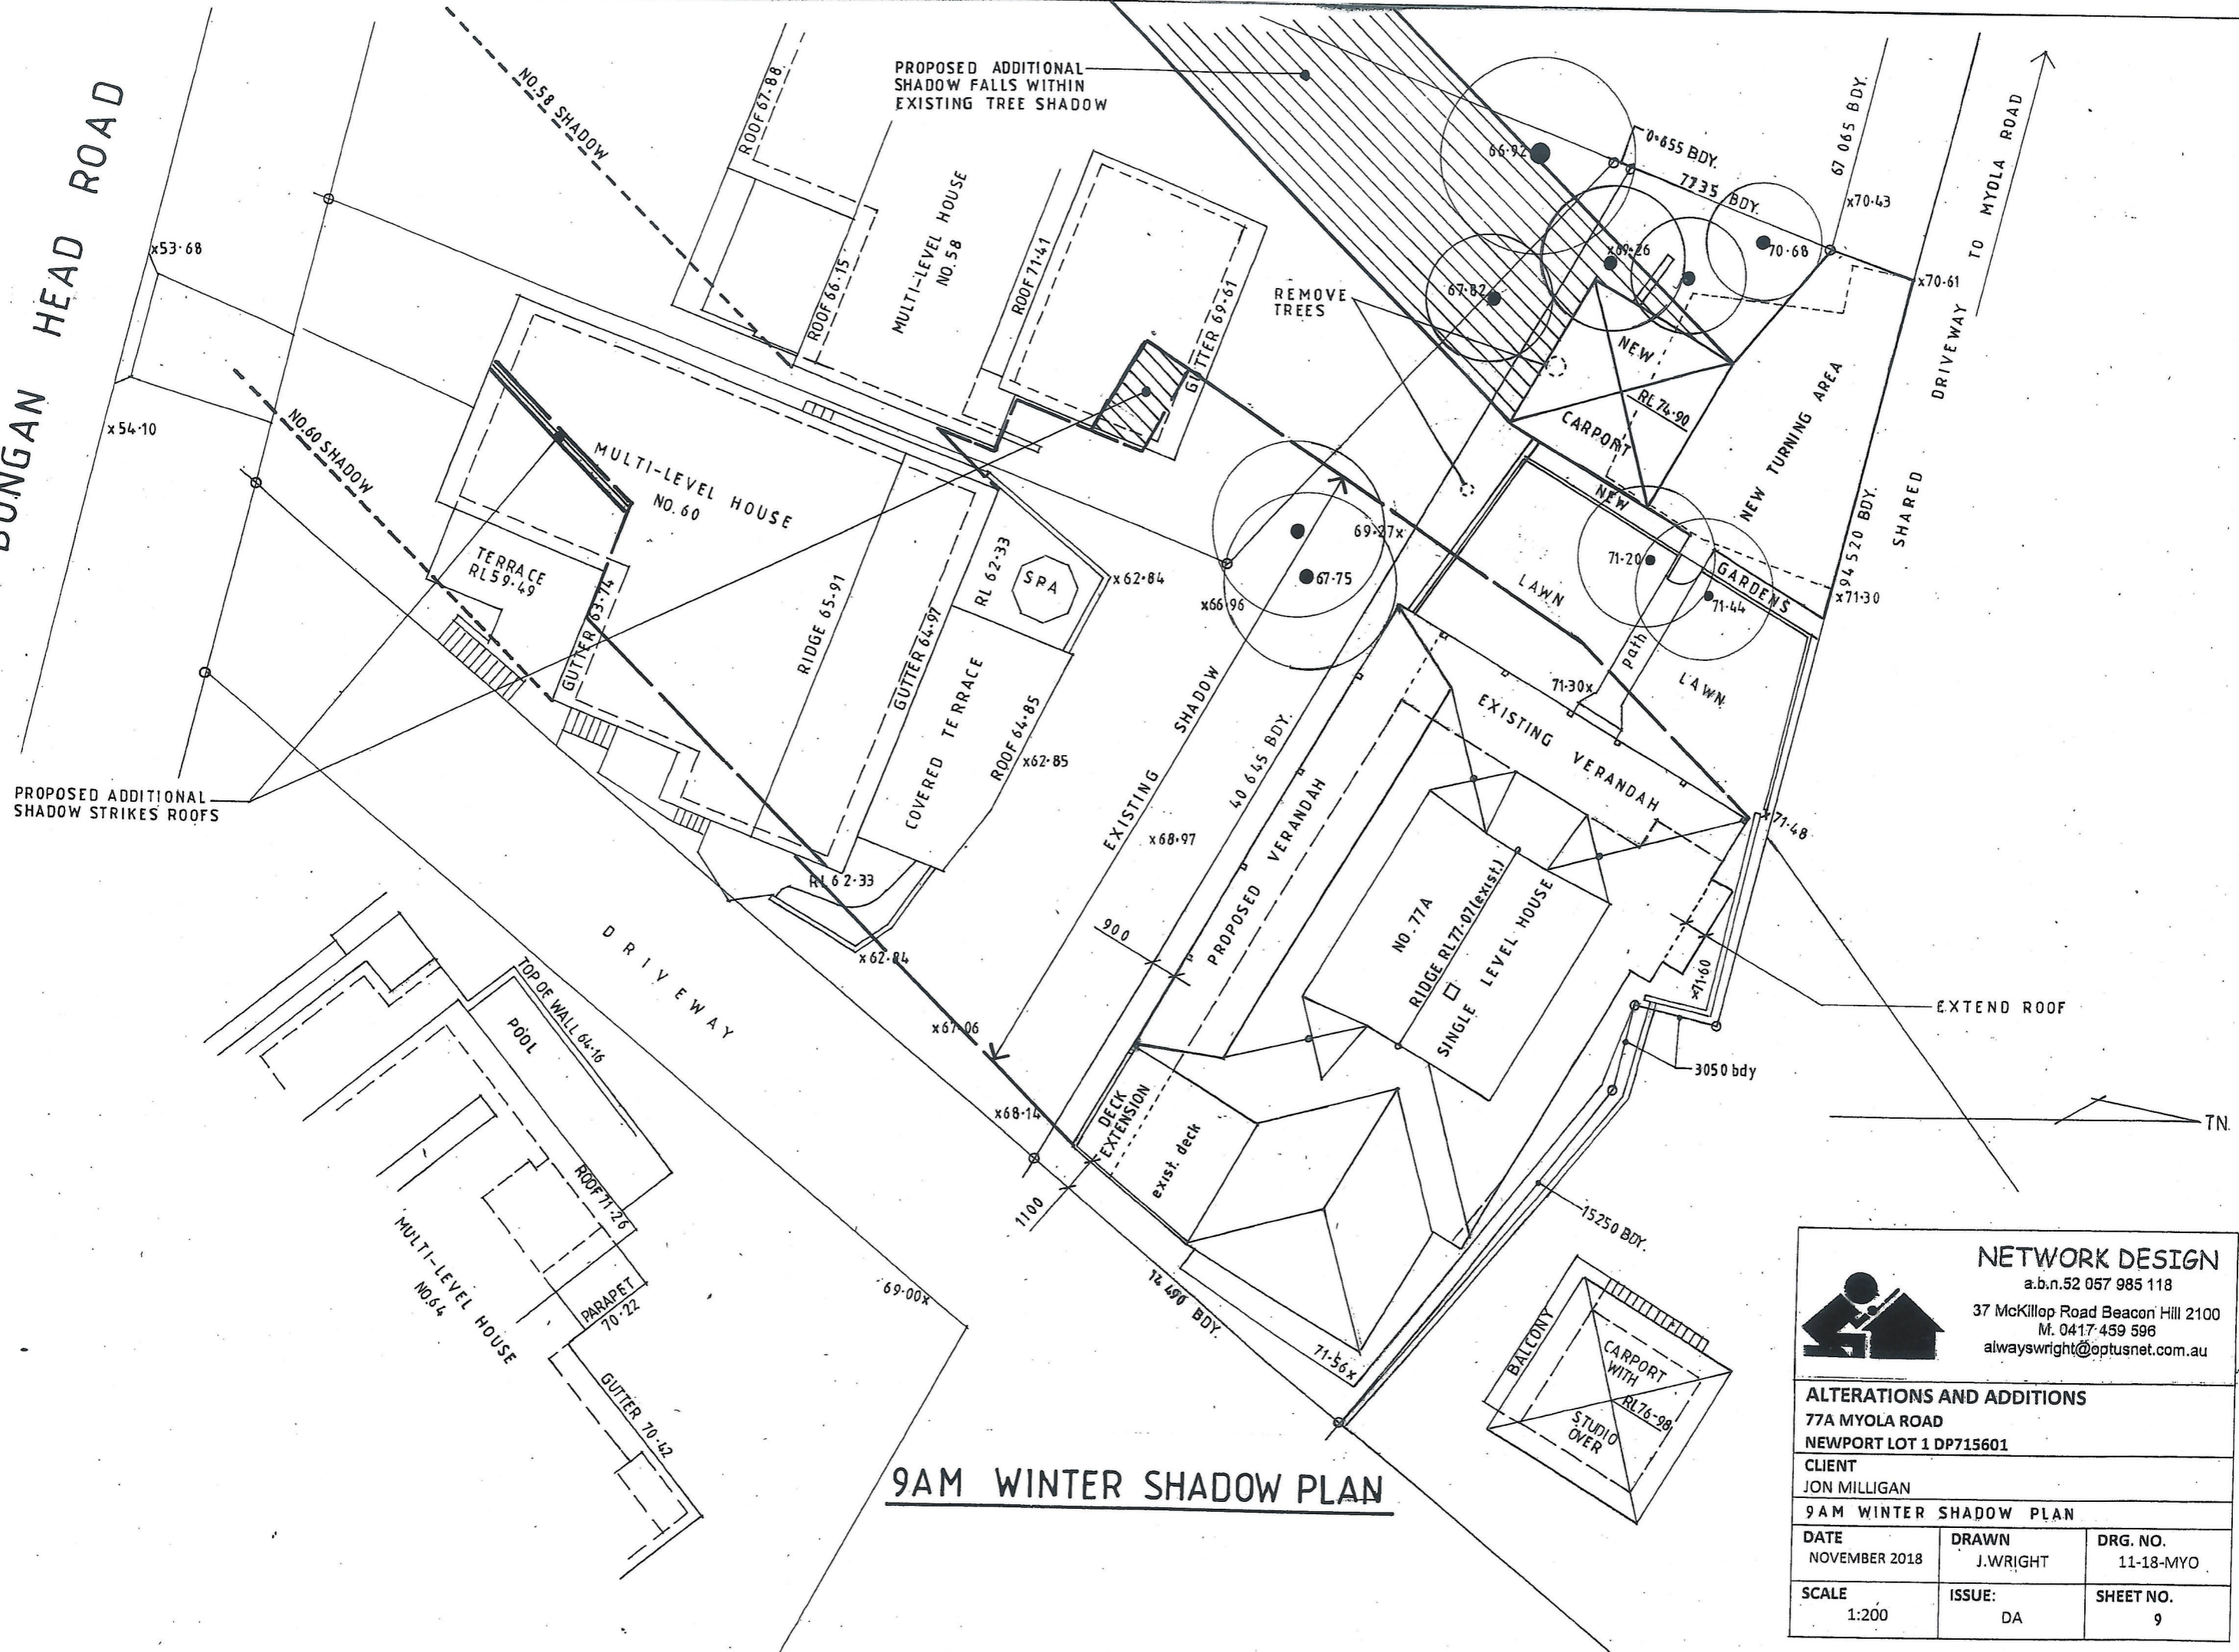DRIVEWAY TO MYOLA ROAD

SHARED

NEW TURNING AREA


MULTI-LEVEL HOUSE  
NO. 58

MULTI-LEVEL HOUSE  
NO. 60

MULTI-LEVEL HOUSE  
NO. 64

NO. 77A  
RIDGE RL77-01(exst.)  
SINGLE LEVEL HOUSE

**NOON WINTER SHADOW PLAN**

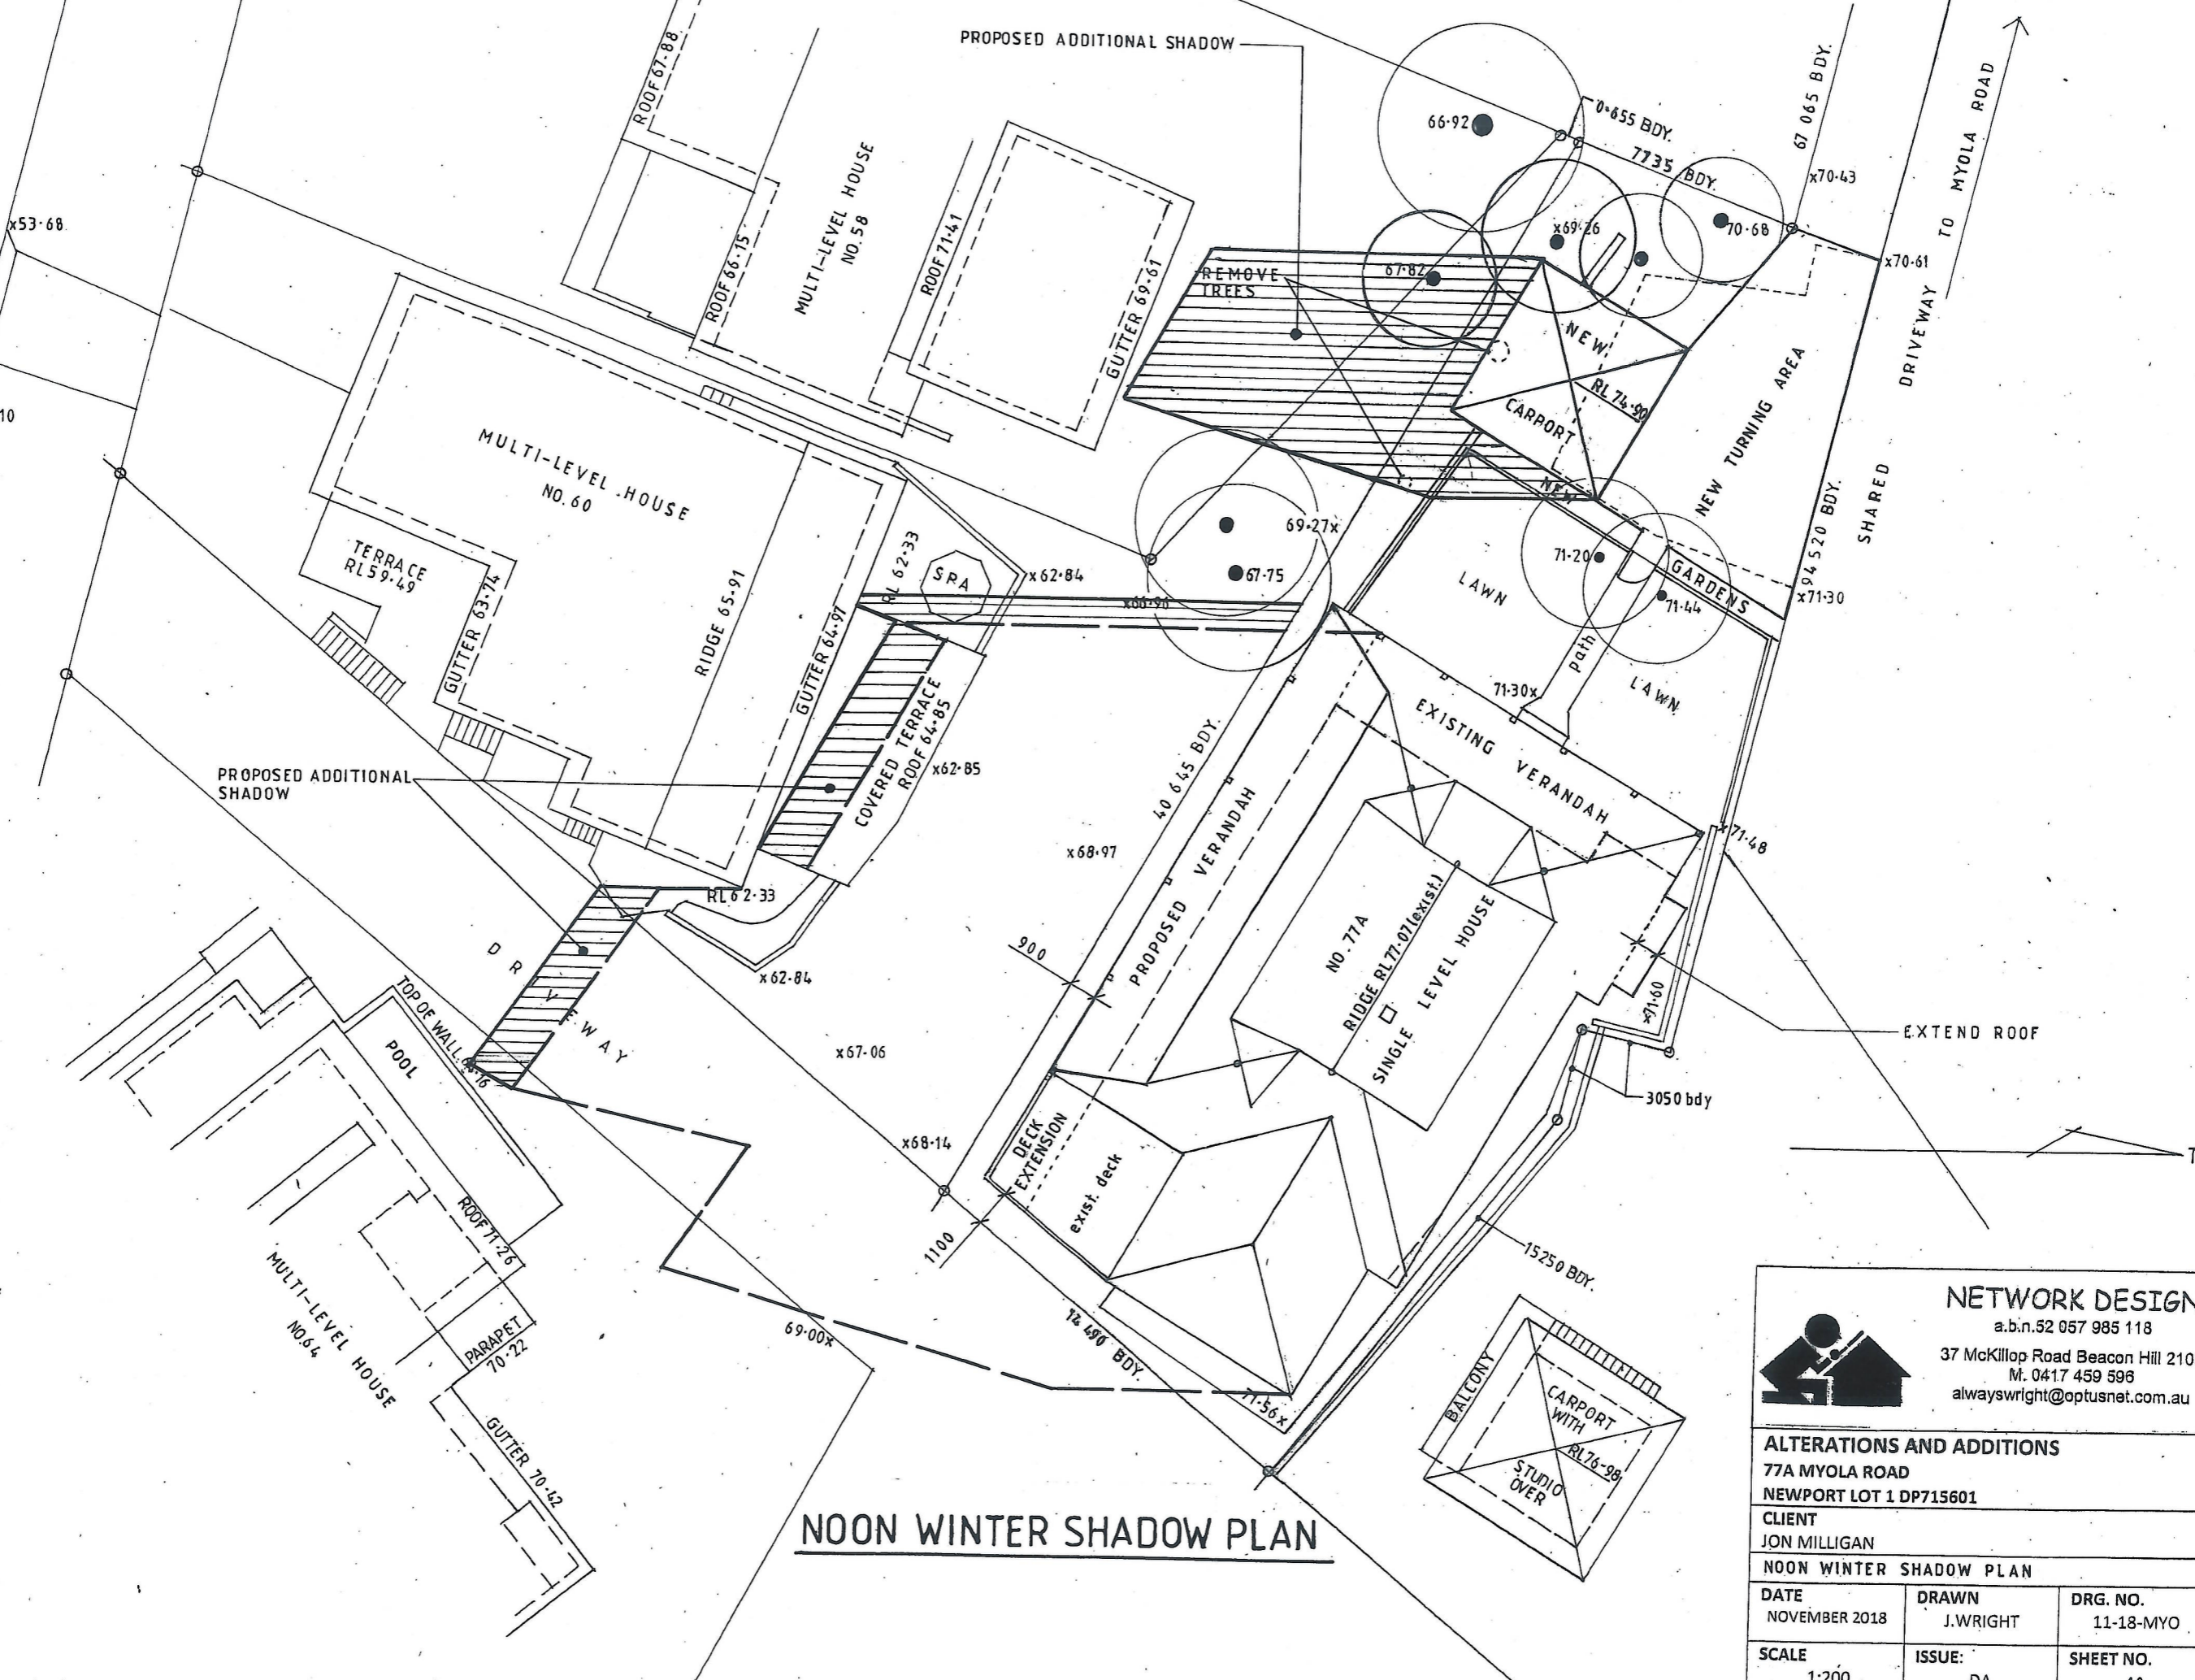

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NEWPORT LOT 1 DP715601

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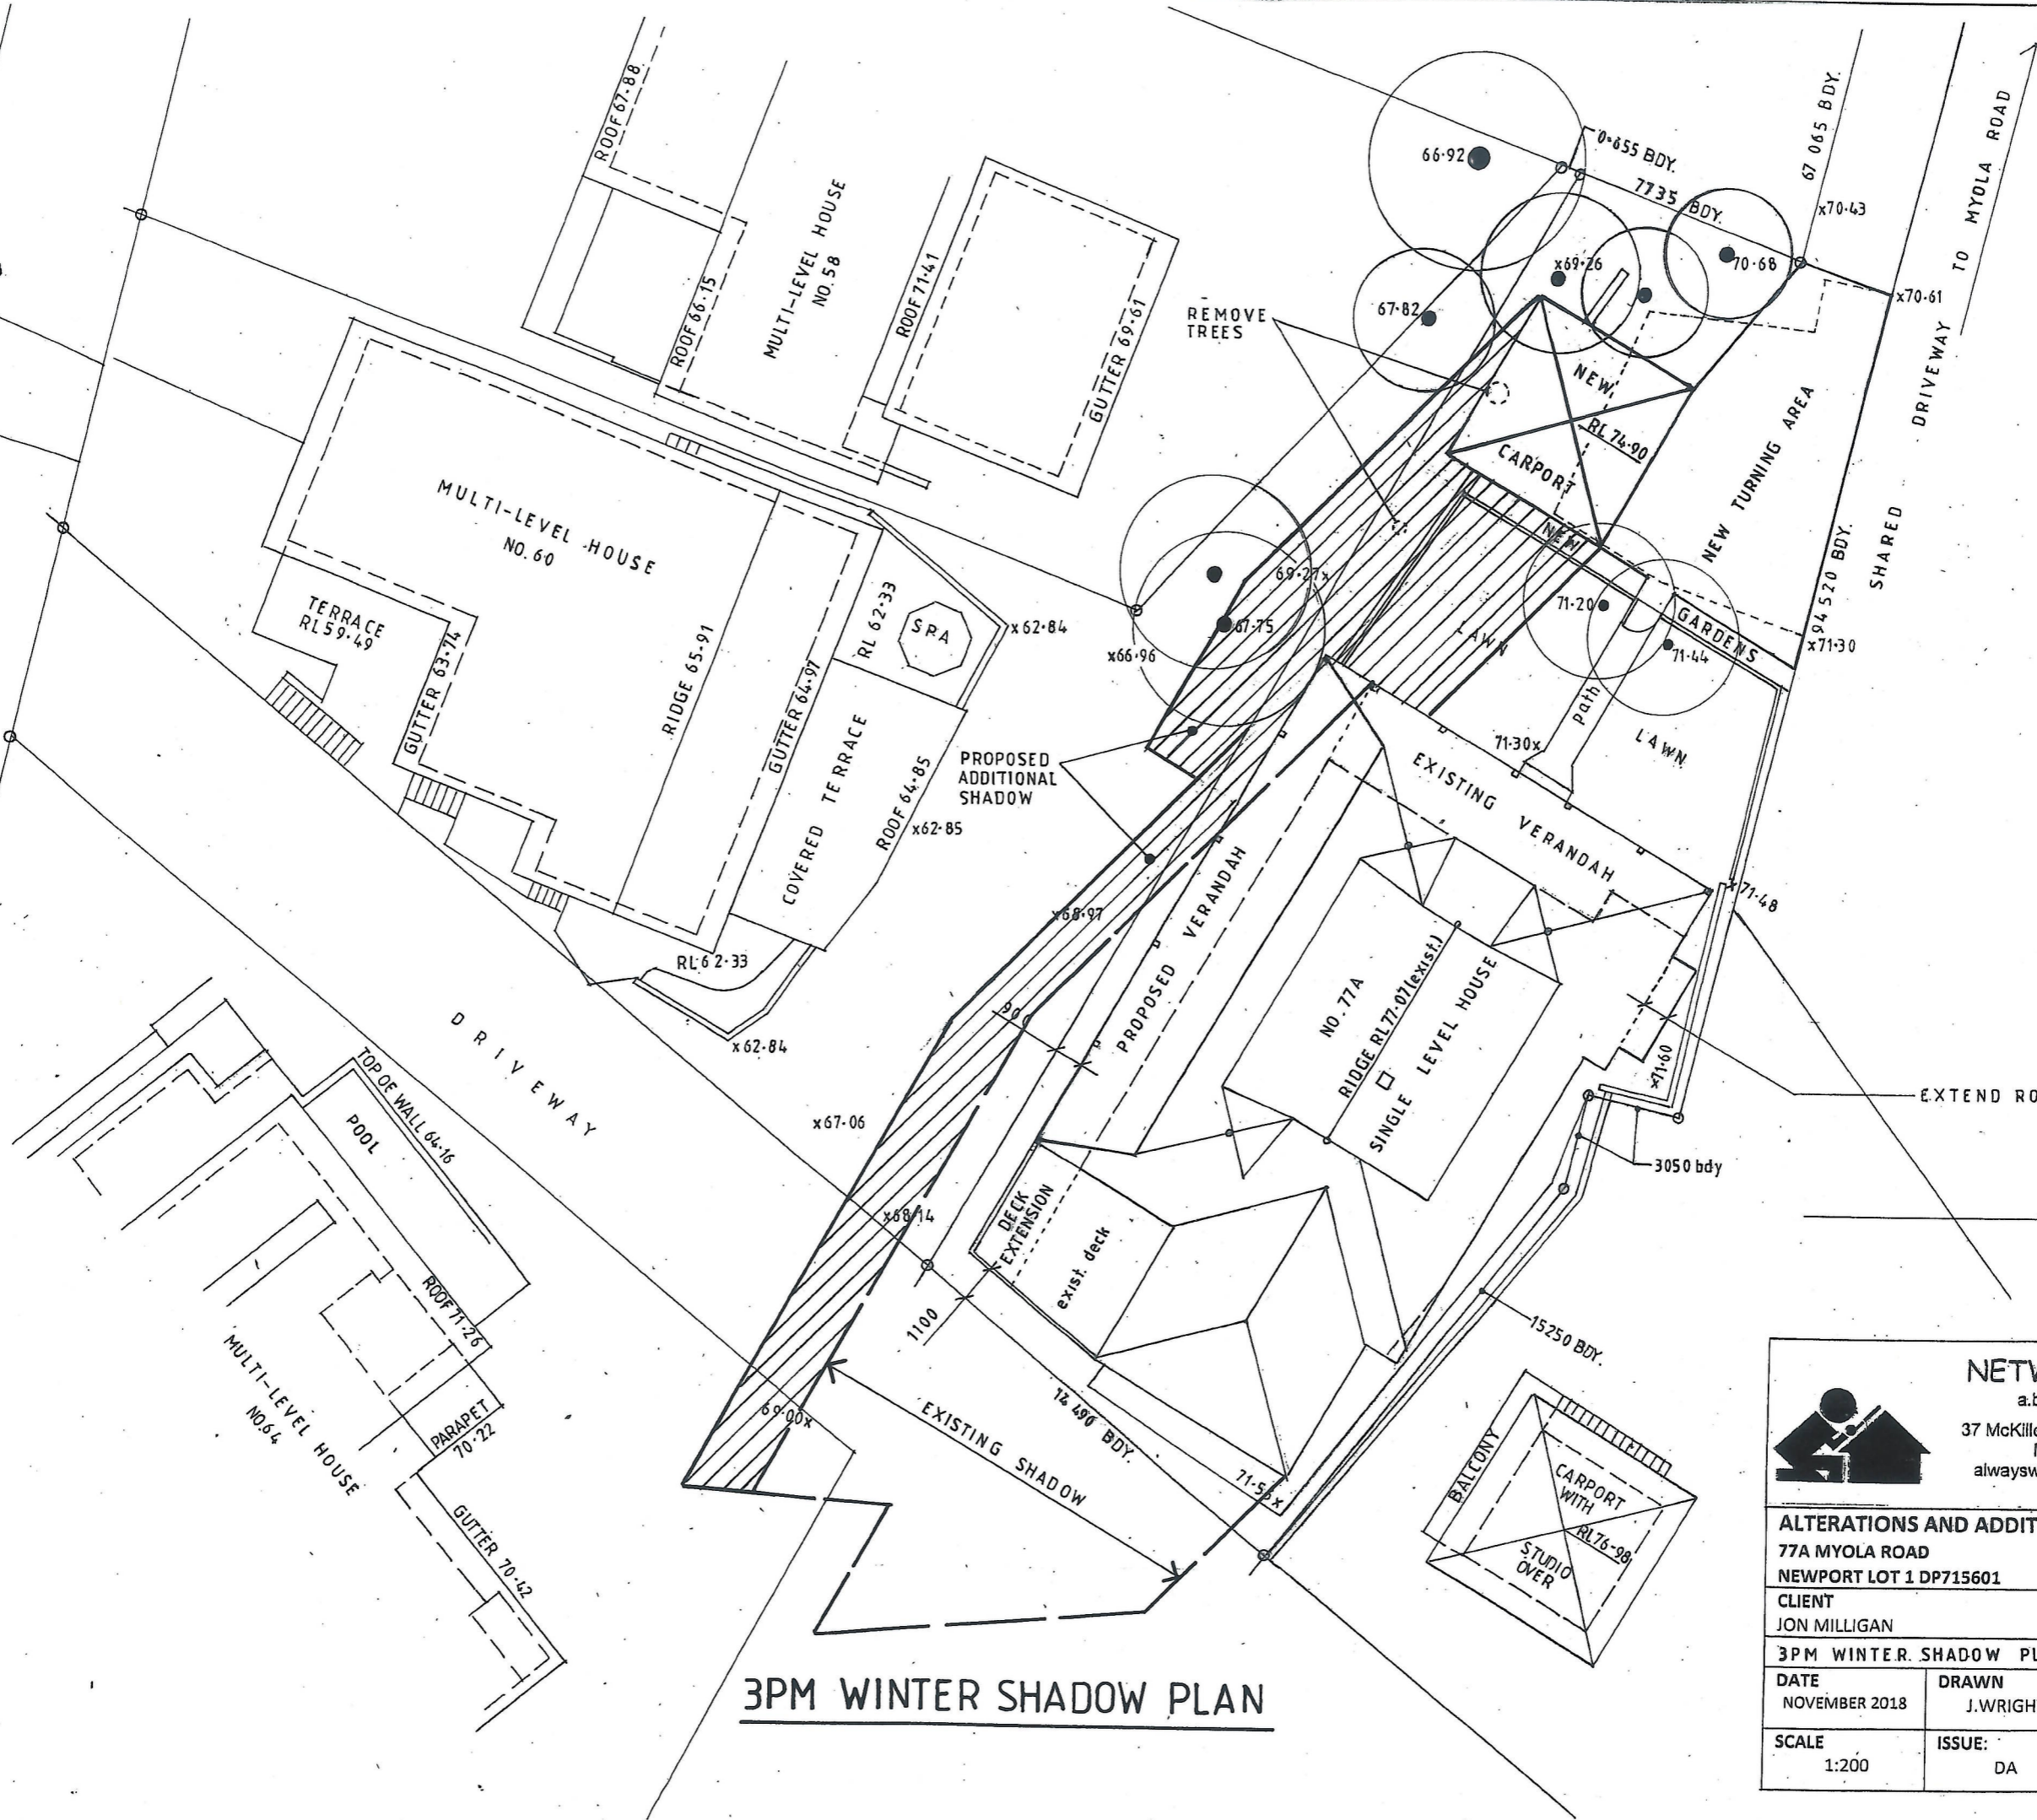
NOON WINTER SHADOW PLAN

DATE NOVEMBER 2018	DRAWN J.WRIGHT	DRG. NO. 11-18-MYO
SCALE 1:200	ISSUE: DA	SHEET NO. 10


BUNGAN HEAD ROAD

x53.68

x54.10



**3PM WINTER SHADOW PLAN**



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**ALTERATIONS AND ADDITIONS**  
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NEWPORT LOT 1 DP715601

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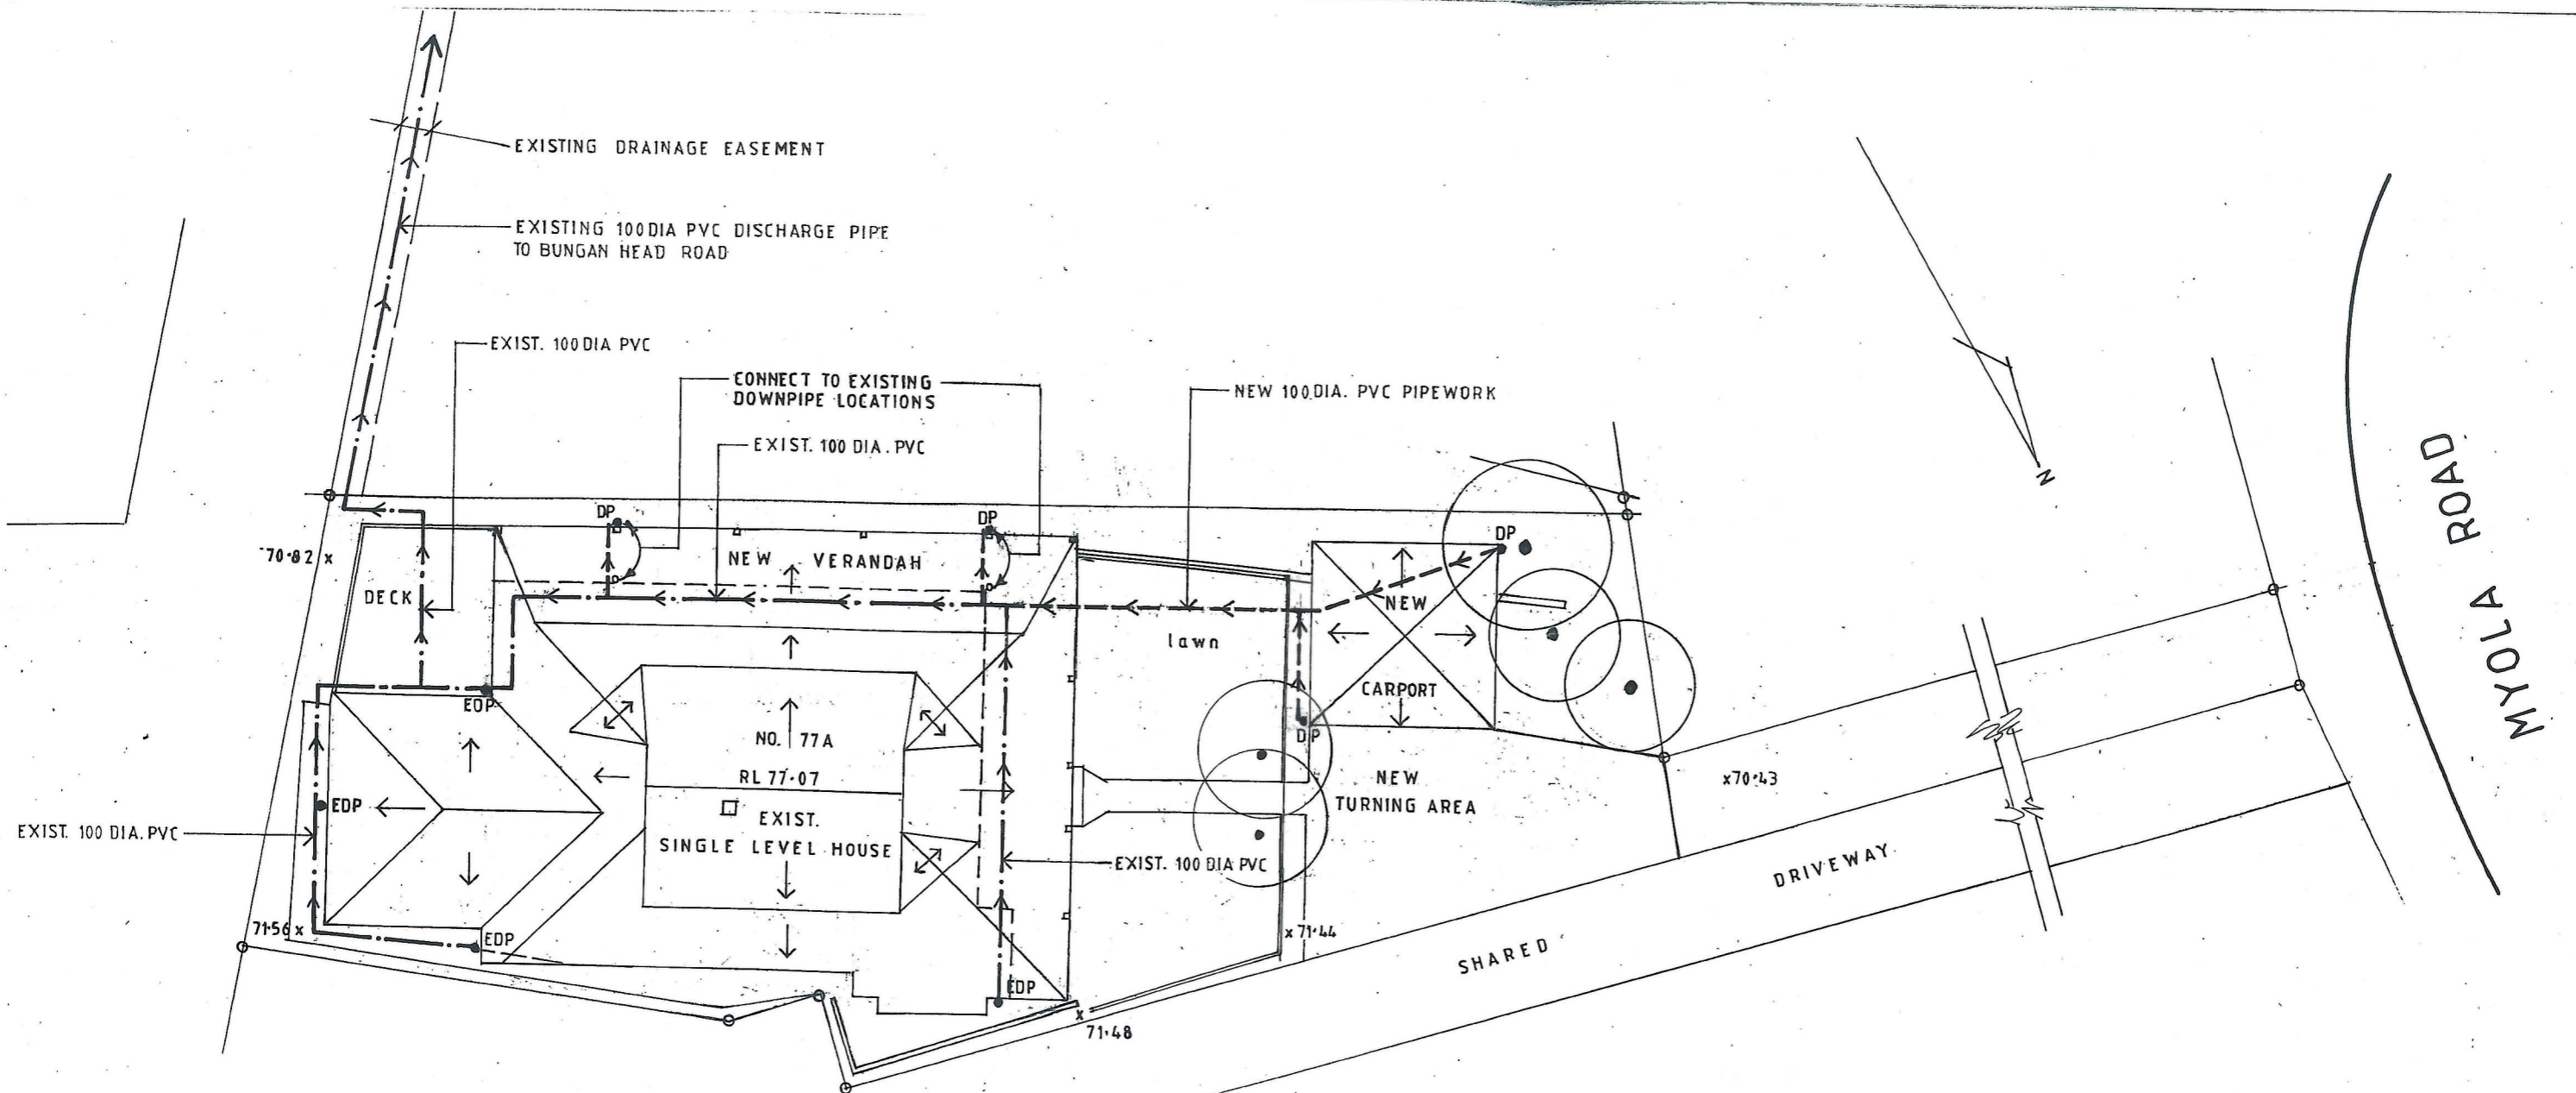
CLIENT  
JON MILLIGAN

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3PM WINTER SHADOW PLAN

DATE NOVEMBER 2018	DRAWN J.WRIGHT	DRG. NO. 11-18-MYO
SCALE 1:200	ISSUE: DA	SHEET NO. 11





## WATER MANAGEMENT PLAN

### Stormwater Notes

- EDP denotes existing downpipe
- DP denotes new downpipe
- New pipework to be 100mm UPVC to AS 1254 -1973
- New pipework to be laid at 1% minimum grade
- All downpipes to be 90mm. Locations to be confirmed on site.
- Provide cleaning eyes at all down pipes.
- All work to be in accordance with local council standards and specifications.
- All levels shown are to AHD.
- Ensure all stormwater pipes are located clear from tree root systems.
- All works to be in accordance with AS 3500 -1990 National Plumbing and Drainage Code Part 3 - Stormwater Drainage.

Proposed Increase in BUA..... 19.0



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### **WATER MANAGEMENT PLAN**

DATE NOVEMBER 2018	DRAWN J.WRIGHT	DRG. NO. 11-18-MYO
SCALE 1:200	ISSUE: DA	SHEET NO. 12

# Schedule of Colours and and Finishes

Alterations and Additions at  
77A Myola Road, Newport



NEW VERANDAH FRAMING AND ROOF TO MATCH EXISTING  
NEW VERANDAH DECK TO MATCH EXISTING  
NEW VERANDAH HANDRAIL – GLASS

NEW ALUMINIUM WINDOWS AND DOORS - WHITE

NEW CARPORT FRAMING AND ROOF TO MATCH EXISTING VERANDAH  
CARPORT WEATHERBOARD CLADDING – LIGHT BLUE TO MATCH EXISTING TRIM