

REV.	DATE	DESCRIPTION	CHECKED		END REVIATIONS			MAT	ERIALS AND FINISHES		
В	16.08.2023 20.09.2023	ISSUED TO PLANNER FOR REVIEW ISSUED FOR DEVELOPMENT APPLICATION	KM KM	AC AHD AS AW BF CS DB DP (E) FF FFL GF	AIR CONDITIONING AUSTRALIAN HEIGHT DATUM AUSTRALIAN STANDARD AWNING WINDOW BI-FOLD CASEMENT WINDOW DOUBLE DOWNPIPE EXISTING EQUAL FIXED FINISHED CEILING LEVEL FINISHED FLOOR LEVEL FINISHED FLOOR LEVEL FINISHED REDUCED LEVEL GROUND FLOOR	JN LFW LGF (N) NCC NGL NTS PV RT SKL SL SMK TOG V VOS	JOINERY LINEAR FLOOR WASTE LOWER GROUND FLOOR NEW NATIONAL CONSTRUCTION CODE (BCA) NATURAL GROUND LEVEL NOT TO SCALE PHOTO VOLTAICS ROOF TILE SKYLIGHT SLIDING DOOR SMOKE ALARM TOP OF GUTTER VENT VERIFY ON SITE	AD AL AW BB BK BMR CA CCL CR FB FC G GD MRS P PAV	ALUMINIUM DOOR ALUMINIUM WINDOW BARCE BOARD BRICK BITUMINOUS MEMBRANE ROOFING CARPET CLEAR FINISH CEMENT RENDER FASCIA BOARD FIBRE CEMENT GLAZED GLAZED TIMBER DOOR METAL ROOF SHEETING PANTING	PB R RC S ST T TB TD TDK T & G	PLASTERBOARD RENDERED REINFORCED CONCRETE SLATE STONE TIMBER BATTEN TIMBER DOOR TIMBER DOCKING TIMBER TONGUE & GROOVE TILE - TERRACOTTA TIMBER WINDOW TILE - TLOOR WEATHERBOARD VITRIPIED TILE ZINC ROOF SHEETING

two form pty ltd Nominated Architect Kristina Mitkovski NSW Reg No. 7998


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CLIENT STEPHEN AND SUSAN JONES	N	date AUG 2023
PROJECT ALTERATIONS AND ADDITION TO EXISTING DWELLING 3 WARATAH ROAD, PALM BEACH LOT 15 DP 651513	DEVELOPMENT APPLICATION	scale 1:100 AT A2
DEMOLITION PLAN -	DRAWING NUMBER	REVISION
GROUND FLOOR	22 026 AR <b>DA 02</b>	В





REV.	DATE	DESCRIPTION	CHECKED	LEG	END						
Α	16.08.2023	ISSUED TO PLANNER FOR REVIEW	км Т	ABB	REVIATIONS			MAT	ERIALS AND FINISHES		
В	20.09.2023	ISSUED FOR DEVELOPMENT APPLICATION	КМ	AC AHD AS AW BF CS DB DP (E) EQ F FCL FRL GF	AIR CONDITIONING AUSTRALIAN HEIGHT DATUM AUSTRALIAN STANDARD AWNING WINDOW BI-FOLD CASEMENT WINDOW DOUBLE DOWNPIPE EXISTING EQUAL FIXED FIXED FIXED FIXED FIXED FINISHED CELLING LEVEL FIRIST FLOOR FINISHED REDUCED LEVEL GROUND FLOOR	JN LFW LGF (N) NCC NGL NTS PV RT SKL SKL SL SMK TOG V VOS	JOINERY LINEAR FLOOR WASTE LOWER GROUND FLOOR NEW NATIONAL CONSTRUCTION CODE (BCA) NATURAL GROUND LEVEL NOT TO SCALE PHOTO VOLTAICS ROOF TILE SKYLIGHT SLIDING DOOR SMOKE ALARM TOP OF GUTTER VENT VENTY VERIFY ON SITE	AD AL AW BB BK BMR CA CL CR FB FC G GD MRS P PAV	ALUMINIUM DOOR ALUMINIUM ALUMINIUM WINDOW BARGE BOARD BRICK BITUMINOUS MEMBRANE ROOFING CARPET CLEAR FINISH CEMENT RENDER FASCIA BOARD FIBRE CEMENT GLAZED GLAZED TIMBER DOOR METAL ROOF SHEETING PAINTED PAINTED	PB RC S ST T TB TD TDK T & G TL/TC TW TL/F WB VT ZRS	PLASTERBOARD RENDERED RENDERED CONC SLATE STONE TIMBER BATTEN TIMBER BATTEN TIMBER DECKING TIMBER DECKING TIMBER DECKING TIMBER WINDOW TILE - FLOOR WEATHERBOARD VITRIFIED TILE ZINC ROOF SHEETIN


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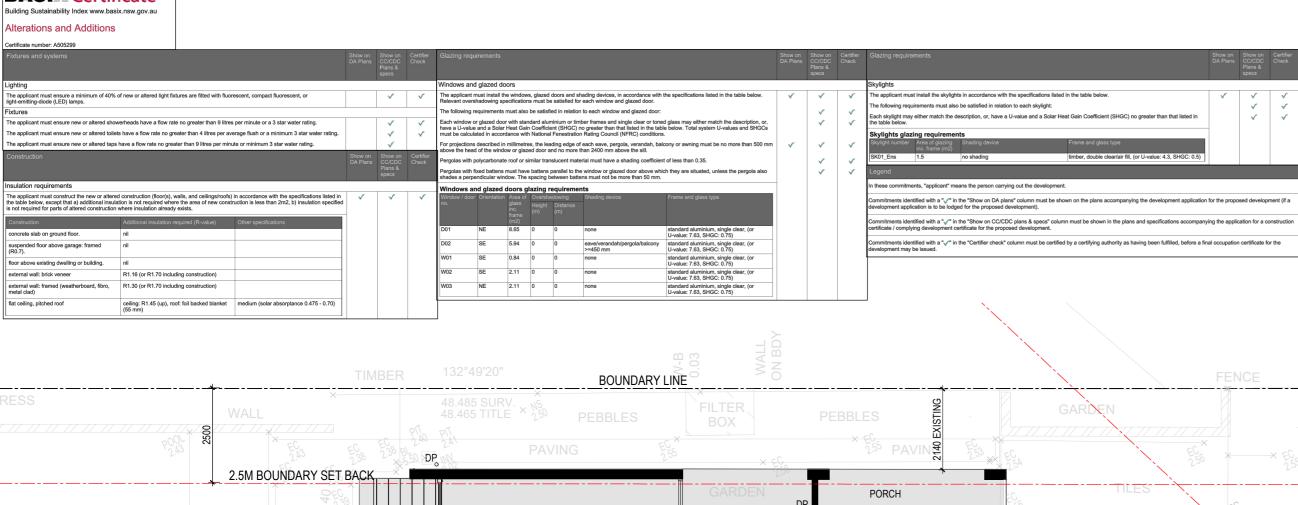
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N	dati AUG 2023
DEVELOPMENT APPLICATION	scal 1:100 AT A2
DRAWING NUMBER 22 026 AR <b>DA 03</b>	REVISION B
	DEVELOPMENT APPLICATION  DRAWING NUMBER

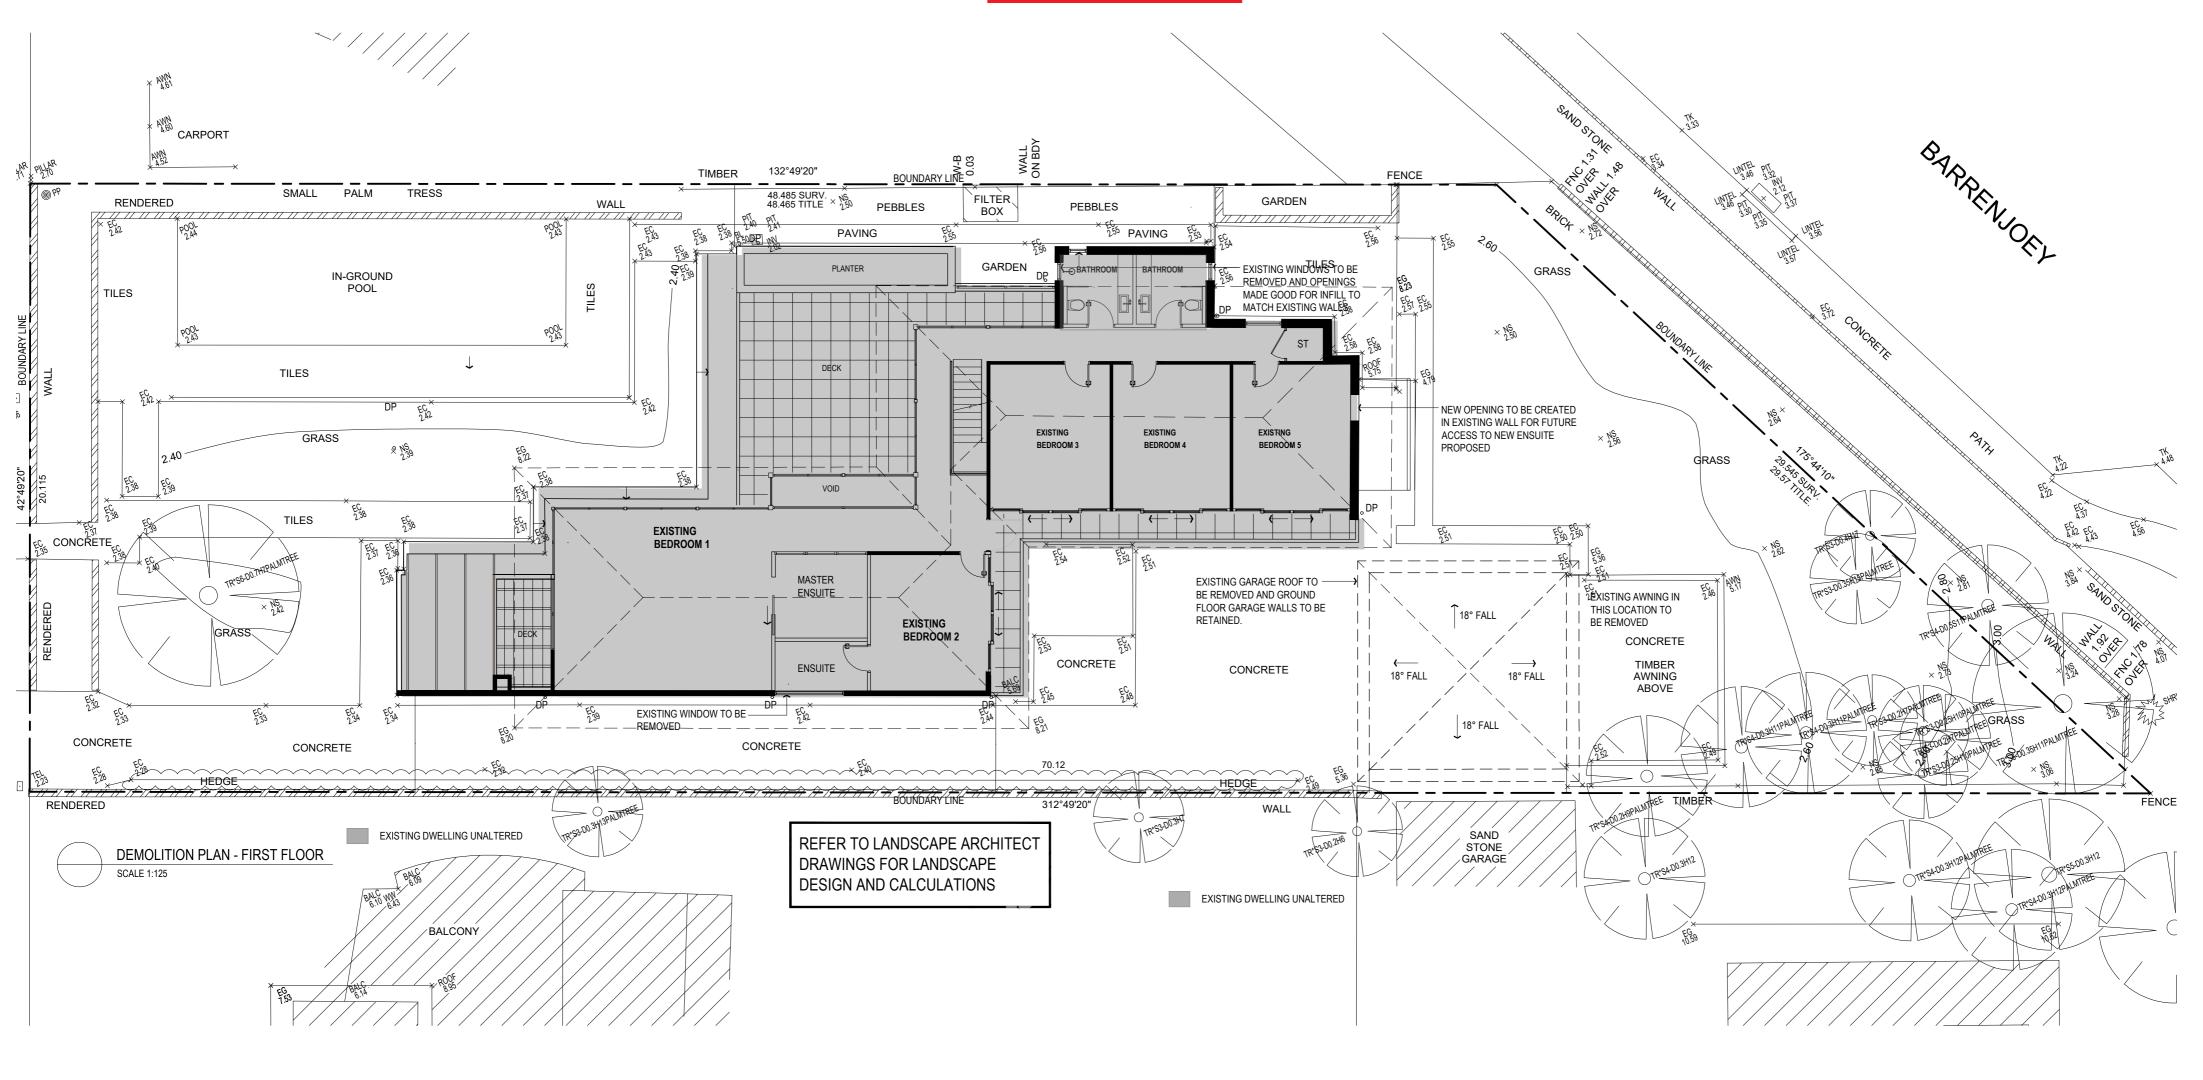

# **BASIX** Certificate



#### LAND ZONE E4 ENVIRONMENTAL LIVING DEVELOPMENT DCP CLAUSE DEVELOPMENT CONTROL DEVELOPMENT PROPOSAL LANDSCAPED AREA D12.10 - LANDSCAPED AREA THE TOTAL LANDSCAPED AREA ON LAND ZONED REFER ALSO TO LANDSCAPE ARCHITECT DRAWINGS PREPARED BY SITE DESIGN + STUDIO - ENVIRONMENTALLY E4 ENVIRONMENTAL LIVING SHALL BE 60% OF SENSITIVE LAND SITE AREA = 1192M2 THE SITE AREA

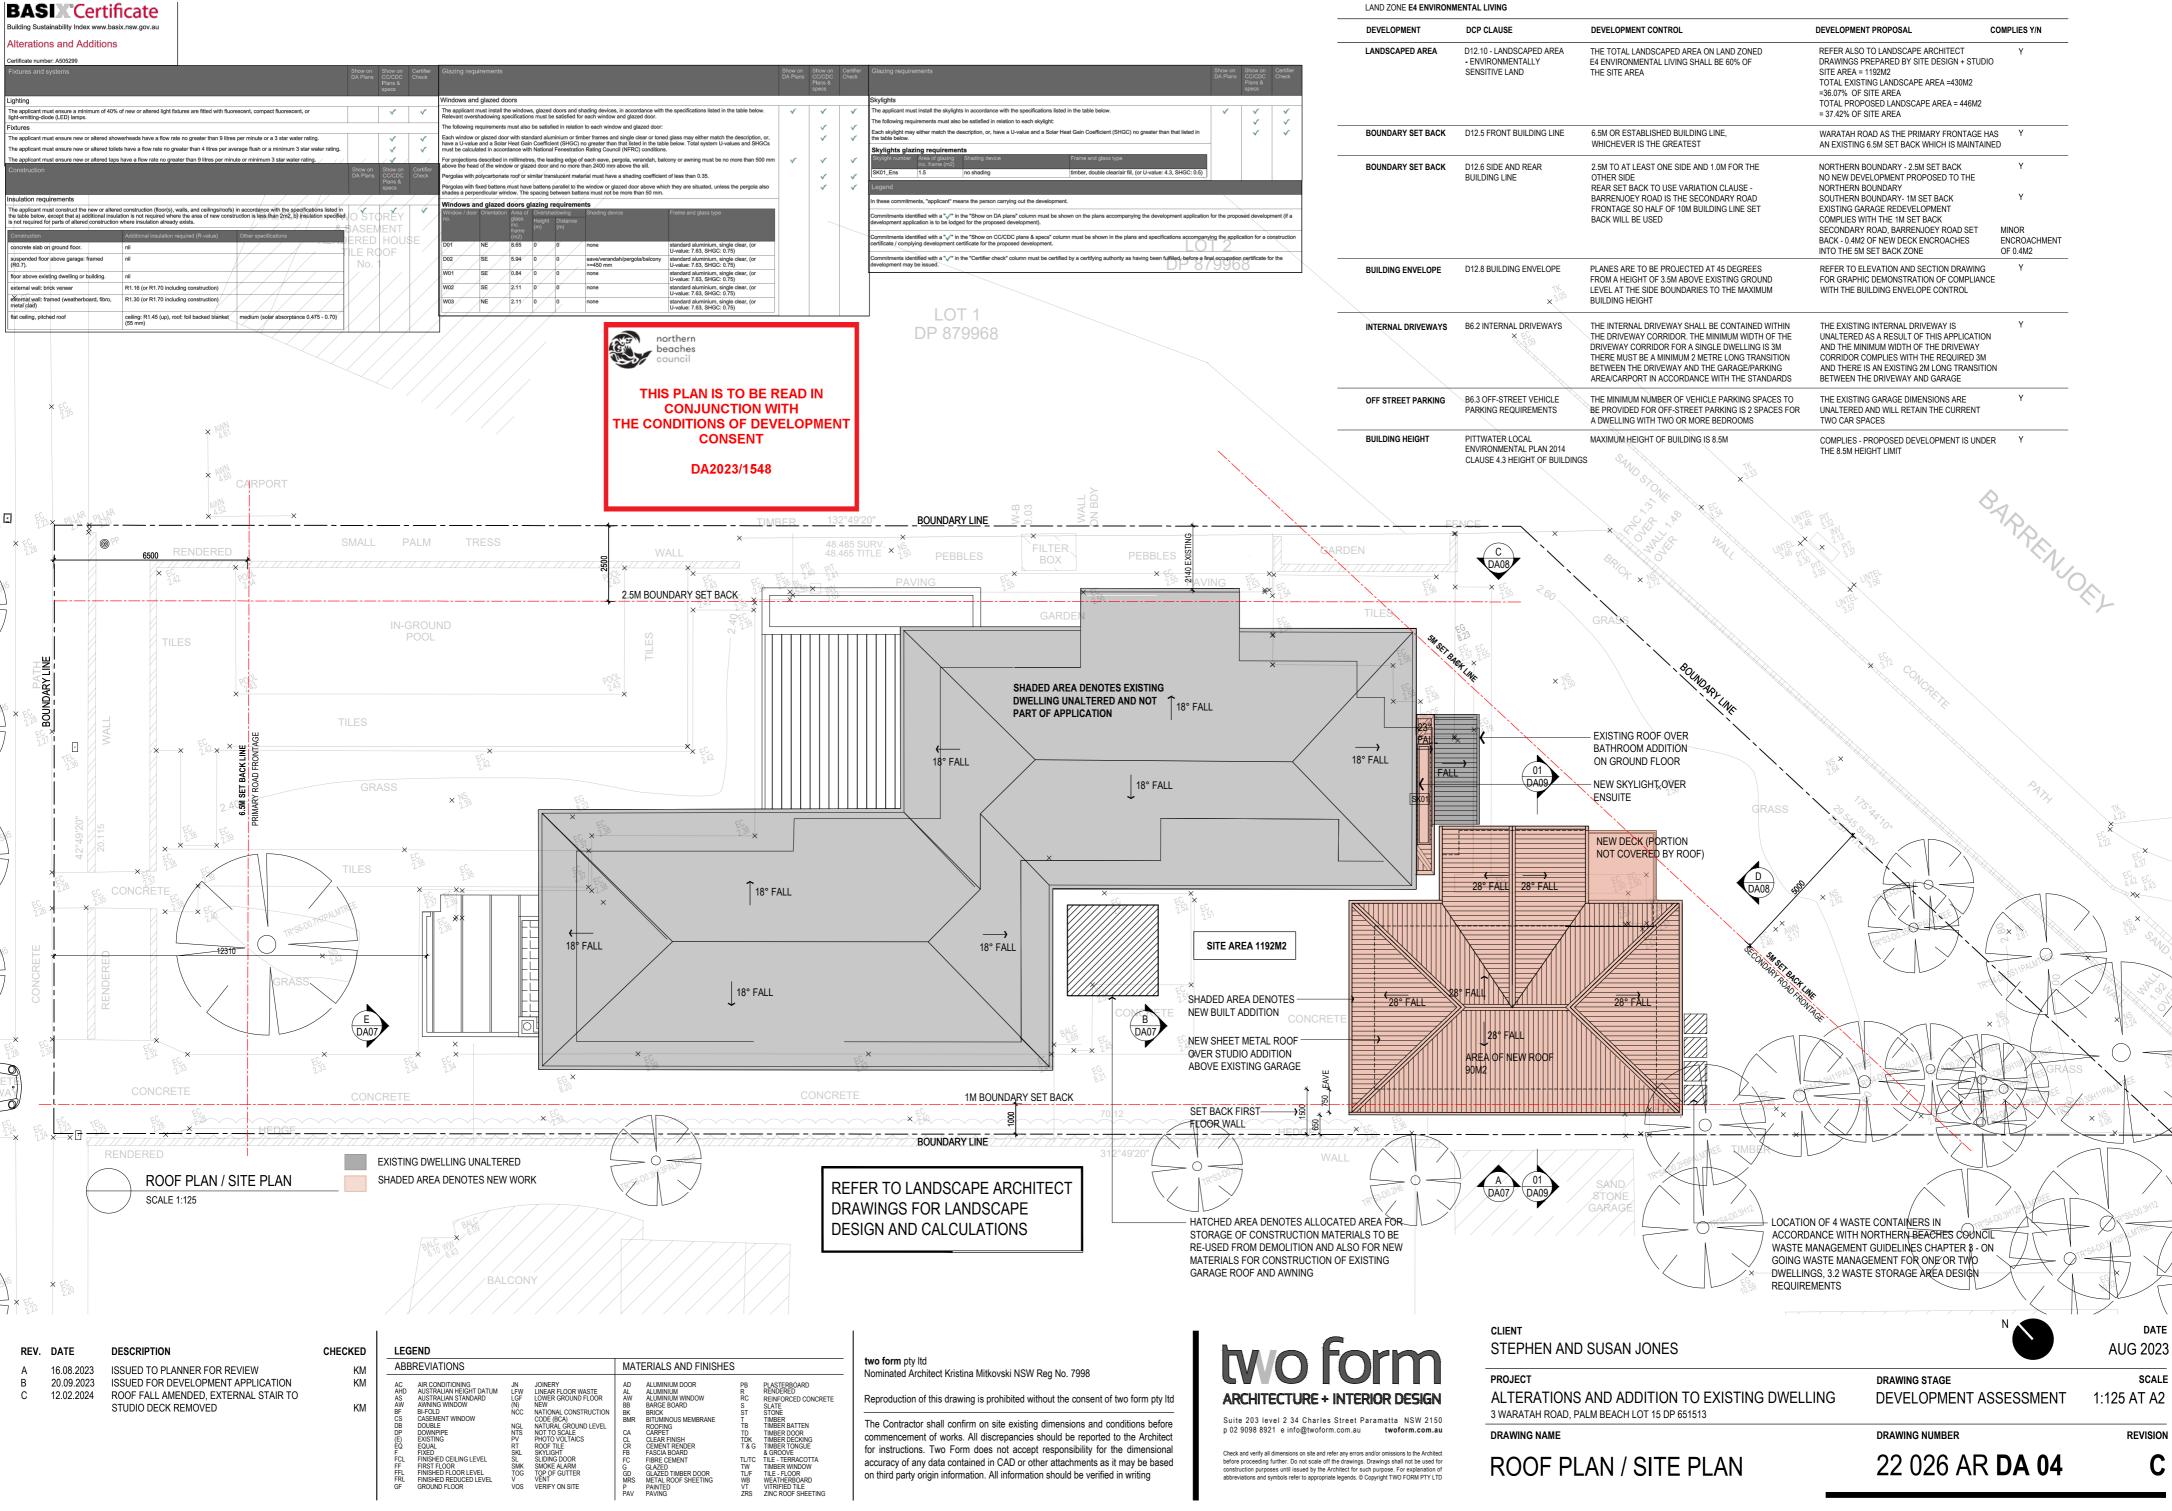TOTAL EXISTING LANDSCAPE AREA =430M2 =36.07% OF SITE AREA TOTAL PROPOSED LANDSCAPE AREA = 446M2 = 37.42% OF SITE AREA BOUNDARY SET BACK D12.5 FRONT BUILDING LINE 6.5M OR ESTABLISHED BUILDING LINE, WARATAH ROAD AS THE PRIMARY FRONTAGE HAS WHICHEVER IS THE GREATEST AN EXISTING 6.5M SET BACK WHICH IS MAINTAINED  $2.5\mbox{M}$  TO AT LEAST ONE SIDE AND  $1.0\mbox{M}$  FOR THE NORTHERN BOUNDARY - 2.5M SET BACK BUILDING LINE OTHER SIDE NO NEW DEVELOPMENT PROPOSED TO THE REAR SET BACK TO USE VARIATION CLAUSE -NORTHERN BOUNDARY BARRENJOEY ROAD IS THE SECONDARY ROAD SOUTHERN BOUNDARY- 1M SET BACK FRONTAGE SO HALF OF 10M BUILDING LINE SET EXISTING GARAGE REDEVELOPMENT BACK WILL BE USED COMPLIES WITH THE 1M SET BACK SECONDARY ROAD BARRENJOEY ROAD SET BACK - 0.4M2 OF NEW DECK ENCROACHES ENCROACHMENT

REFER TO ELEVATION AND SECTION DRAWING BUILDING ENVELOPE D12.8 BUILDING ENVELOPE PLANES ARE TO BE PROJECTED AT 45 DEGREES FROM A HEIGHT OF 3.5M ABOVE EXISTING GROUND FOR GRAPHIC DEMONSTRATION OF COMPLIANCE LEVEL AT THE SIDE BOUNDARIES TO THE MAXIMUM BUILDING HEIGHT WITH THE BUILDING ENVELOPE CONTROL THE INTERNAL DRIVEWAY SHALL BE CONTAINED WITHIN THE DRIVEWAY CORRIDOR. THE MINIMUM WIDTH OF THE INTERNAL DRIVEWAYS B6.2 INTERNAL DRIVEWAYS THE EXISTING INTERNAL DRIVEWAY IS UNALTERED AS A RESULT OF THIS APPLICATION DRIVEWAY CORRIDOR FOR A SINGLE DWELLING IS 3M AND THE MINIMUM WIDTH OF THE DRIVEWAY

THERE MUST BE A MINIMUM 2 METRE LONG TRANSITION CORRIDOR COMPLIES WITH THE REQUIRED 3M BETWEEN THE DRIVEWAY AND THE GARAGE/PARKING AND THERE IS AN EXISTING 2M LONG TRANSITION AREA/CARPORT IN ACCORDANCE WITH THE STANDARDS BETWEEN THE DRIVEWAY AND GARAGE THE MINIMUM NUMBER OF VEHICLE PARKING SPACES TO THE EXISTING GARAGE DIMENSIONS ARE OFF STREET PARKING

BE PROVIDED FOR OFF-STREET PARKING IS 2 SPACES FOR A DWELLING WITH TWO OR MORE BEDROOMS PARKING REQUIREMENTS UNALTERED AND WILL RETAIN THE CURRENT TWO CAR SPACES PITTWATER LOCAL MAXIMUM HEIGHT OF BUILDING IS 8.5M COMPLIES - PROPOSED DEVELOPMENT IS UNDER **ENVIRONMENTAL PLAN 2014** THE 8.5M HEIGHT LIMIT CCLAUSE 4.3 HEIGHT OF BUILDINGS

LIVING STUDY 1265 DASHED LINE INDICATES EXISTING ROOF OUTLINE RUMPUS ROOM OVER FRAMED GLAZED BI FOLD DOORS SHADED AREA DENOTES EXTENSION TO EXISTING BATHROOM 58 DINING COVERED AREA KITCHEN EXISTING GARAGE ROOF TO BE REMOVED AND NEW LEVEL BUILT ABOVE. THE EXTENT OF THE OUTDOOR! LIMING GARAGE STRUCTURE ON GROUND **FAMILY** LEVEL TO REMAIN UNALTERED LAUNDRY PANTRY EXISTING GARAGE DASHED LINE INIDICATES NEW FLOOR ABOVE FOR STUDIO AND

1M BOUNDARY SET BACK

DA08 NEW MASONRY WALLS TO BE BUILT ON EXISTING GROUND FLOOR GARAGE WALLS.

DECK. 800MM EXISTING GROUND FLOOR GARAGE WALL SET

BACK (UNALTERED) -

DATE AUG 2023

REV. DATE DESCRIPTION ISSUED TO PLANNER FOR REVIEW 16.08.2023 ISSUED FOR DEVELOPMENT APPLICATION 20.09.2023 12.02.2024 ROOF FALL AMENDED, EXTERNAL STAIR TO STUDIO DECK REMOVED

SCALE 1:100

1M BOUNDARY SET BACK

**GROUND FLOOR PLAN** 

CHECKED LEGEND MATERIALS AND FINISHES **ABBREVIATIONS** PB PLASTERBOARD
R RENDERED
RC REINFORCED CONCRETE
S SLATE
ST STONE
T IMBER BATTEN
TD TIMBER BOOR
TOK TIMBER DECKING
T & G TIMBER TONGUE
& GROOVE
TUTT
TUT TILE - TERRACOTTA
TW TIMBER WINDOW
TUF TILE - TERRACOTTA
TW TIMBER TONGUE
WB WEATHERBOARD
VT VITRIFIED TILE
ZRS ZINC ROOF SHEETING ALUMINIUM DOOR
ALUMINIUM WINDOW
BARCE BOARD
BRICK
BITUMINOUS MEMBRAN
ROOFING
CARPET
CLEAR FINISH
CEMENT BENDER
FASCIA BOARD
FIBRE CEMENT
GLAZED
GLAZED
GLAZED TIMBER DOOR
METAL ROOF SHEETING
PAVING NEW NATIONAL CONSTRUCTION CODE (BCA)
NATURAL GROUND LEVEL NOT TO SCALE PHOTO VOLTAICS ROOF TILE SKYLIGHT SLIDING DOOR SMOKE ALARM TOP OF GUTTER VENT

EXISTING DWELLING UNALTERED

SHADED AREA DENOTES NEW WORK

**BOUNDARY LINE** 

two form pty ltd Nominated Architect Kristina Mitkovski NSW Reg No. 7998

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Check and verify all dimensions on site and refer any errors and/or omissions to the Archite Crieck and vering a funderson on sale and refer any errors amount of many consistence of the property of the p STEPHEN AND SUSAN JONES

**PROJECT** ALTERATIONS AND ADDITION TO EXISTING DWELLING 3 WARATAH ROAD, PALM BEACH LOT 15 DP 651513

DRAWING NAME

SHADED AREA DENOTES

EXTENDED GARAGE AREA

**GROUND FLOOR PLAN** 

DRAWING STAGE SCALE DEVELOPMENT APPLICATION 1:100 AT A2 DRAWING NUMBER REVISION


COMPLIES Y/N

INTO THE 5M SET BACK ZONE

22 026 AR **DA 05** 

## **BASIX** Certificate

Alterations and Additions

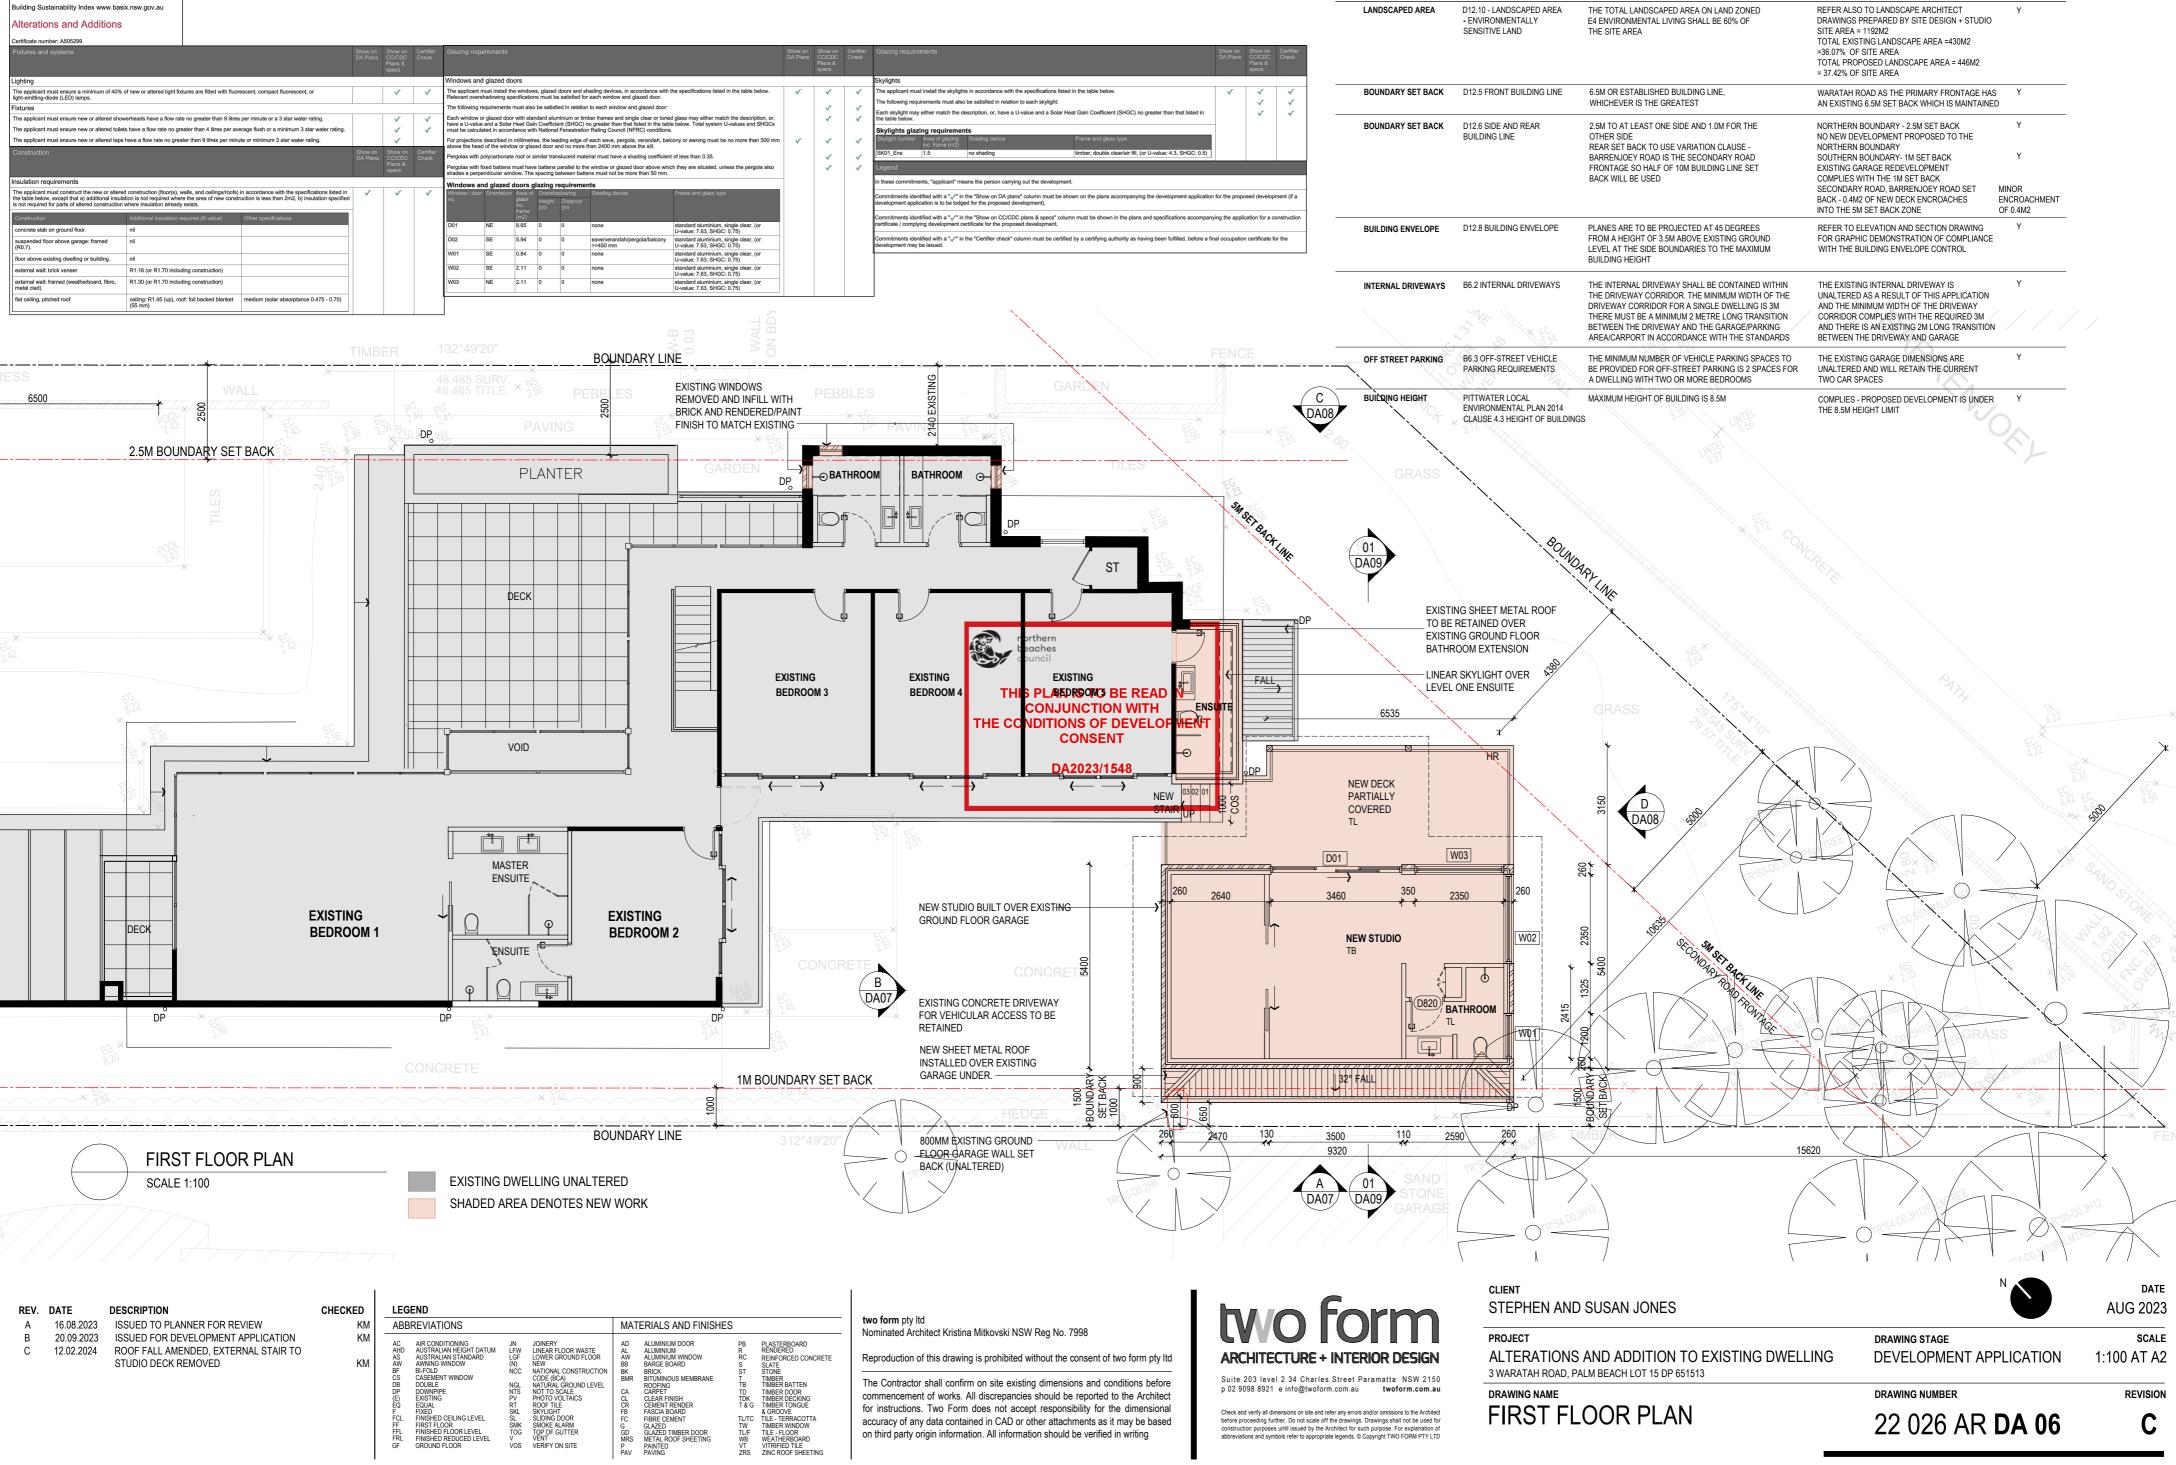

for instructions. Two Form does not accept responsibility for the dimensional

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LAND ZONE E4 ENVIRONMENTAL LIVING

DCP CLAUSE

DEVELOPMENT CONTROL

FIRST FLOOR PLAN

Check and verify all dimensions on site and refer any errors and/or omissions to the Architec


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DEVELOPMENT PROPOSAL


COMPLIES Y/N


22 026 AR **DA 06** 

DEVELOPMENT




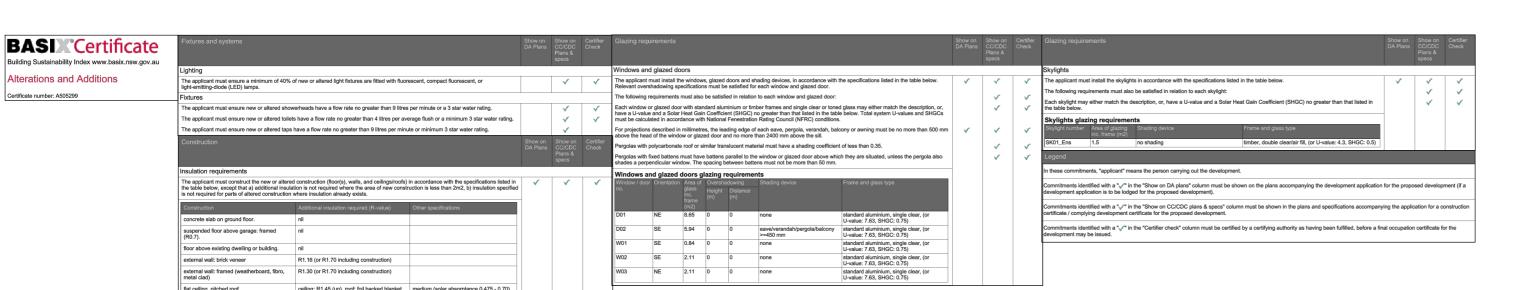

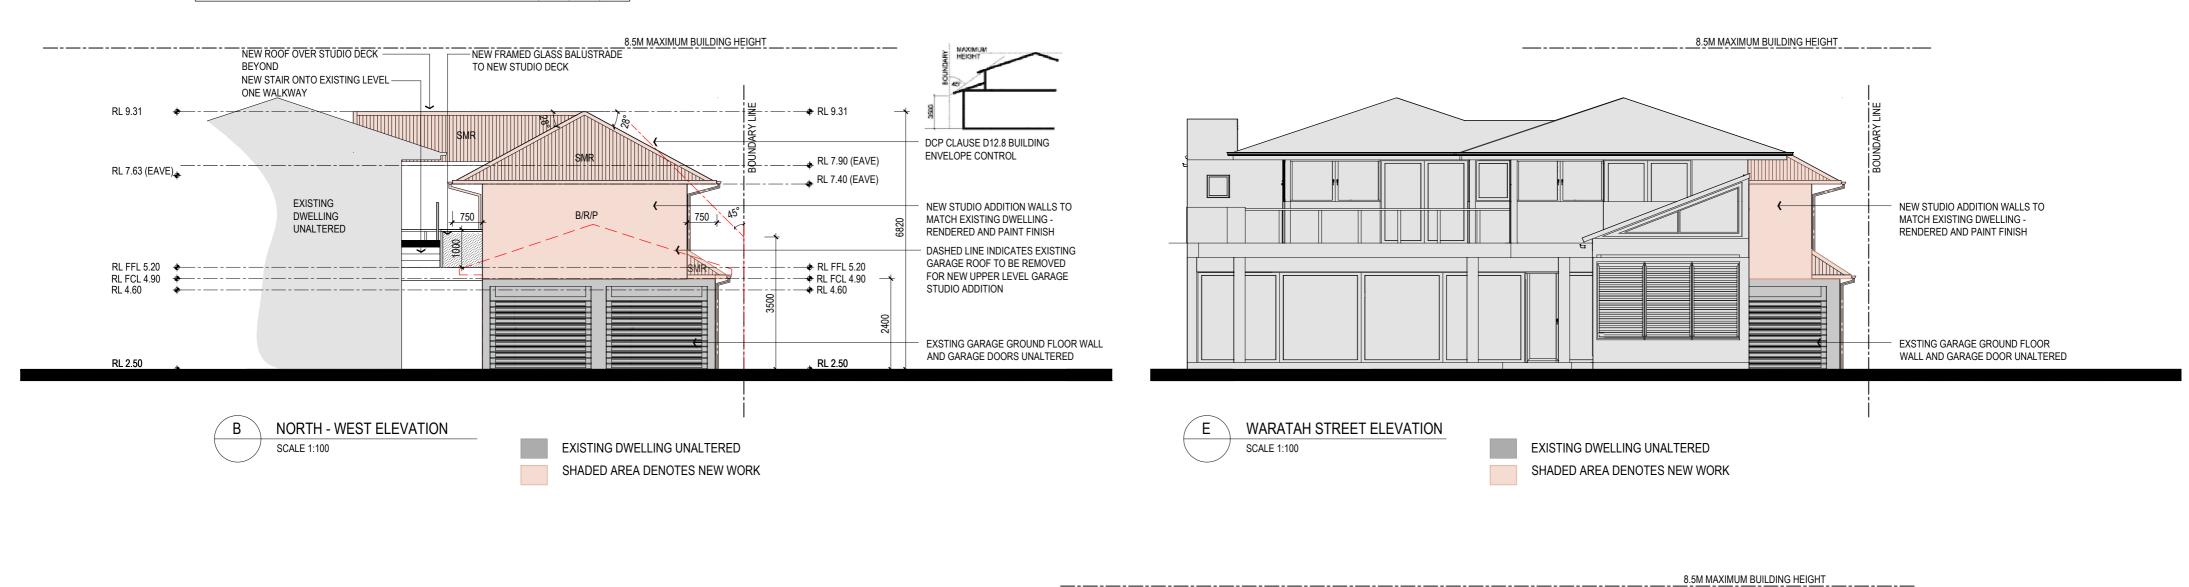

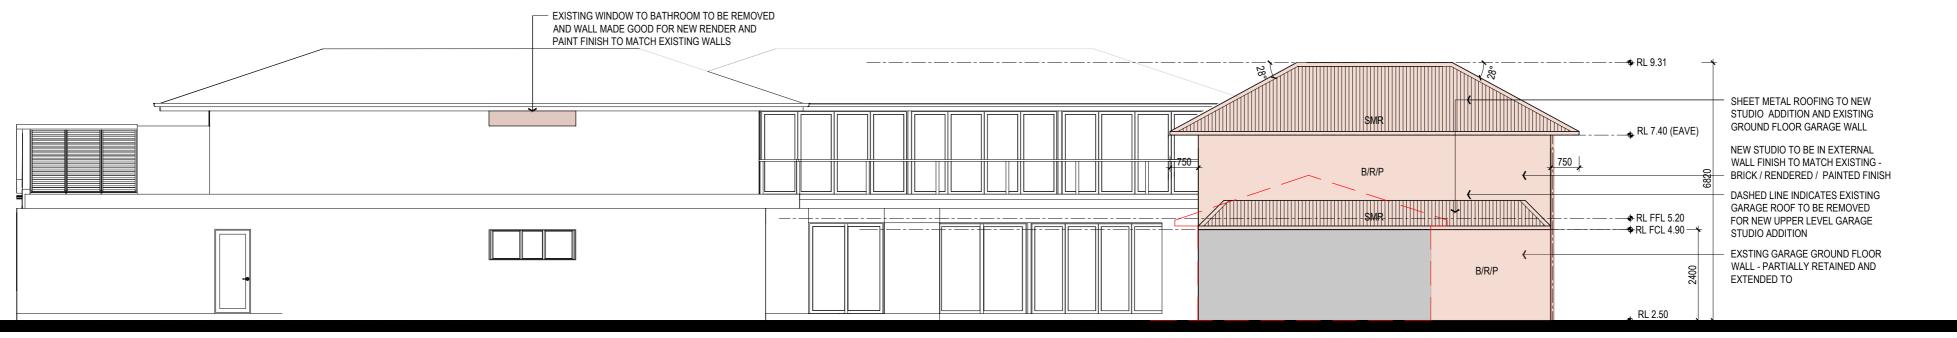

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REV.	DATE	DESCRIPTION	CHECKED	LEGEND ABBREVIATIONS MATERIALS AND FINISHES										
A B C	16.08.2023 20.09.2023 12.02.2024	ISSUED TO PLANNER FOR REVIEW ISSUED FOR DEVELOPMENT APPLICATION ROOF PITCH AMENDED, EXTERNAL STAIR TO STUDIO DECK REMOVED	KM KM	AC DA AND AND BE COME FOR	AIR CONDITIONING AUSTRALIAN HEIGHT DATUM AUSTRALIAN STANDARD AWNING WINDOW BI-FOLD CASEMENT WINDOW DOUBLE DOWNPIPE EXISTING EQUAL FIXED FINISHED CEILING LEVEL FINISHED FLOOR LEVEL FINISHED FLOOR LEVEL FINISHED REDUCED LEVEL GROUND FLOOR	JN LFW LGF (N) NCC NGL NTS PV RT SKL SL SMK TOG V	JOINERY LINEAR FLOOR WASTE LOWER GROUND FLOOR NEW NATIONAL CONSTRUCTION CODE (BCA) NATURAL GROUND LEVEL NOT TO SCALE PHOTO VOLTAICS ROOF TILE SKYLIGHT SLIDING DOOR SMOKE ALARM TOP OF GUTTER VENT VERIFY ON SITE	AD AL AW BB BK BMR CA CL CR FB FC G GD MRS P PAV	ALUMINIUM DOOR ALUMINIUM ALUMINIUM ALUMINIUM ALUMINIUM ALUMINIUM BARGE BOARD BRICK BITUMINOUS MEMBRANE ROOFING CARPET CLEAR FINISH CEMENT RENDER FASCIA BOARD FIBRE CEMENT GLAZED TIMBER DOOR METAL ROOF SHEETING PANINE	PB R RC S ST T B TD TDK T & G TL/TC TW TL/F WB VT ZRS	& GROOVE			

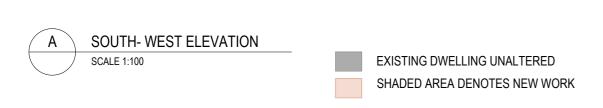two form pty ltd Nominated Architect Kristina Mitkovski NSW Reg No. 7998 Reproduction of this drawing is prohibited without the consent of two form pty Itd Suite 203 level 2 34 Charles Street Parama The Contractor shall confirm on site existing dimensions and conditions before p 02 9098 8921 e info@twoform.com.au commencement of works. All discrepancies should be reported to the Architect for instructions. Two Form does not accept responsibility for the dimensional Check and verify all dimensions on site and refer any errors and/or on before proceeding further. Do not scale off the drawings. Drawings construction purposes until issued by the Architect for such purpos abbreviations and symbols refer to appropriate legends. © Copyright

rbo	CLIENT STEPHEN AND SUSAN JONES		date AUG 2023
OR DESIGN	PROJECT ALTERATIONS AND ADDITION TO EXISTING DWELLING 3 WARATAH ROAD, PALM BEACH LOT 15 DP 651513	DEVELOPMENT APPLICATION	scale 1:100 AT A2
twoform.com.au or omissions to the Architect wings shall not be used for uppose. For explanation of rright TWO FORM PTY LTD	NORTH WEST AND SOUTH WEST ELEVATION	DRAWING NUMBER 22 026 AR <b>DA 07</b>	REVISION

#### **IASIX** Certificate terations and Additions he following requirements must also be satisfied in relation to each skylight: tificate number: A505299 The following requirements must also be satisfied in relation to each window and glazed door: Each skylight may either match the description, or, have a U-value and a Solar Heat Gain Coefficient (SHGC) no greater than that listed in the table below. Each window or glazed door with standard aluminium or timber frames and single clear or toned glass may either match the description, or, have a U-value and a Solar Heat Gain Coefficient (SHGC) no greater than that listed in the table below. Total system U-values and SHGCs must be calculated in accordance with National Fenseration Rating Council (NFRC) conditions. The applicant must ensure new or altered toilets have a flow rate no greater than 4 litres per average flush or a minimum 3 star water rating. golas with fixed battens must have battens parallel to the window or glazed door above which they are situated, unless the pergola also des a perpendicular window. The spacing between battens must not be more than 50 mm.

concrete slab on ground floor. suspended floor above garage: framed (R0.7).

external wall: brick veneer

floor above existing dwelling or building.

R1.16 (or R1.70 including construction


external wall: framed (weatherboard, fibro, metal clad)

R1.30 (or R1.70 including construction)

Windows and glazed doors glazing requirements

SE 2.11 0 0 none

NE 2.11 0 0

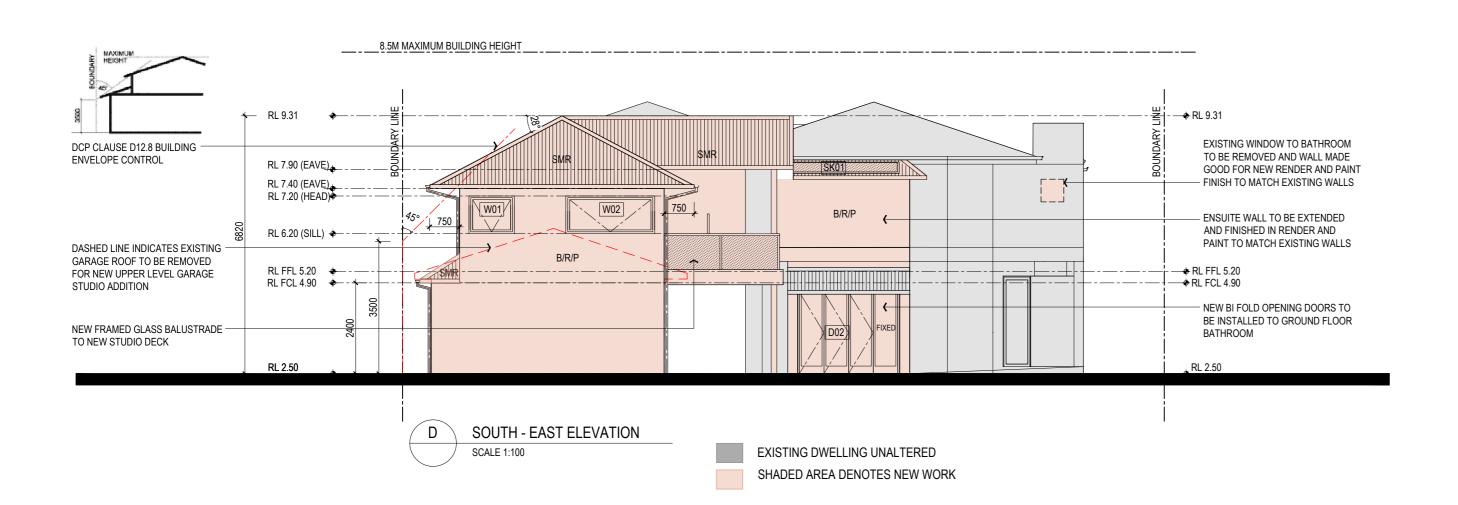


standard aluminium, single clear, (or U-value: 7.63, SHGC: 0.75) standard aluminium, single clear, (or U-value: 7.63, SHGC: 0.75)


standard aluminium, single clear, (or U-value: 7.63, SHGC: 0.75)

standard aluminium, single clear, (or U-value: 7.63, SHGC: 0.75)

standard aluminium, single clear, (or U-value: 7.63, SHGC: 0.75)



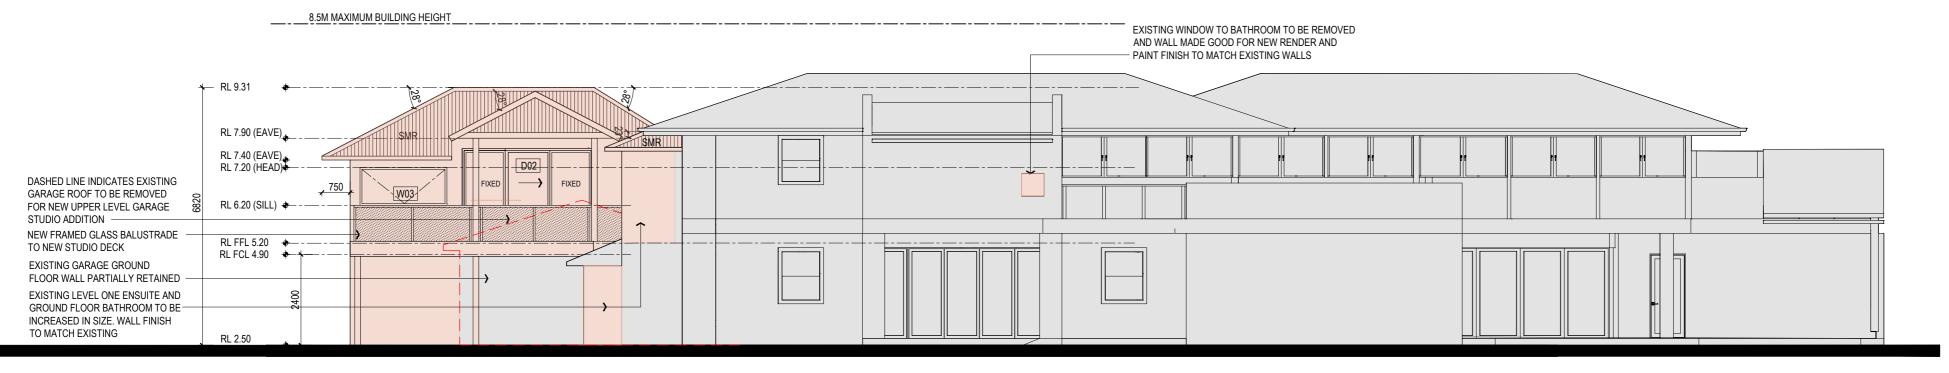

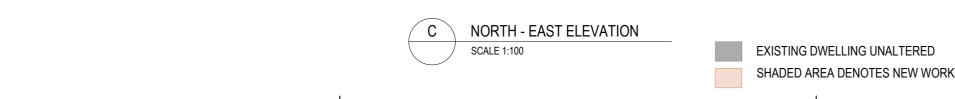

REV.	<b>DATE</b> 16.08.2023	DESCRIPTION ISSUED TO PLANNER FOR REVIEW	CHECKED KM	LEGEND  ABBREVIATIONS  MATERIALS AND FINISHES	
A B C	20.09.2023 12.02.2024	ISSUED FOR DEVELOPMENT APPLICATION ROOF PITCH AMENDED, EXTERNAL STAIR TO STUDIO DECK REMOVED	KM KM	AC AIR CONDITIONING AHD AUSTRALIAN HEIGHT DATUM AS AUSTRALIAN STANDARD BY AUSTRALIAN STANDARD COPE (BCA) WAY AWAYING WINDOW COPE (BCA) DB DOUBLE P DOWNING DP DOWNING	TE .


two form pty ltd Nominated Architect Kristina Mitkovski NSW Reg No. 7998  Reproduction of this drawing is prohibited without the consent of two form pty ltd	TWO FOR ARCHITECTURE + INTERIOR DES
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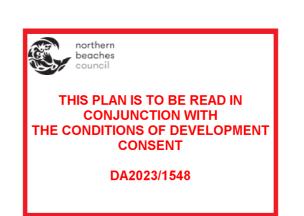
~	CLIENT STEPHEN AND SUSAN JONES		date AUG 2023
ESIGN NSW 2150	PROJECT ALTERATIONS AND ADDITION TO EXISTING DWELLING 3 WARATAH ROAD, PALM BEACH LOT 15 DP 651513	DEVELOPMENT APPLICATION	scale 1:100 AT A2
s to the Architect not be used for r explanation of FORM PTY LTD	NORTH EAST AND SOUTH EAST ELEVATIONS	DRAWING NUMBER 22 026 AR <b>DA 08</b>	REVISION


## **BASIX** Certificate Building Sustainability Index www.basix.nsw.gov.au

Alterations and Additions Certificate number: A505299

Fixtures and systems			Show on Certific CC/CDC Check Plans & specs	Glazing	requirements					Show on DA Plans	Show on CC/CDC Plans & specs	Certifier Check	Glazing requirements		Show on Certifier CC/CDC Check Plans & specs
Lighting				Windows	and glazed de	oors							Skylights		
The applicant must ensure a minimum of 40% of new or altered light fixtures are fitte light-emitting-diode (LED) lamps.	d with fluorescent, compact fluorescent, or		✓ V	The applic	cant must install to overshadowing sp	he windows, pecifications	glazed do nust be s	oors and shading devices, in accordance with satisfied for each window and glazed door.	the specifications listed in the table below.	√	√	√	The applicant must install the skylights in accordance with the specifications listed in the table below.	✓	V V
Fixtures				The follow	ing requirements	must also be	satisfied	d in relation to each window and glazed door:			V	V	The following requirements must also be satisfied in relation to each skylight:		v   v
The applicant must ensure new or altered showerheads have a flow rate no greater	than 9 litres per minute or a 3 star water rating.		V V	Each wind	low or glazed doo	or with standa	ırd alumi	nium or timber frames and single clear or tone t (SHGC) no greater than that listed in the table	d glass may either match the description, or,		1	~	Each skylight may either match the description, or, have a U-value and a Solar Heat Gain Coefficient (SHGC) no greater than that listed in the table below.		✓
The applicant must ensure new or altered toilets have a flow rate no greater than 4 I	itres per average flush or a minimum 3 star water rating.		v   v	have a U- must be c	value and a Solar alculated in accor	r Heat Gain ( rdance with N	oefficien lational F	t (SHGC) no greater than that listed in the table enestration Rating Council (NFRC) conditions	le below. Total system U-values and SHGCs				Skylights glazing requirements		
The applicant must ensure new or altered taps have a flow rate no greater than 9 litr	es per minute or minimum 3 star water rating.		✓	For project	tions described in	n millimetres,	the lead	ing edge of each eave, pergola, verandah, bald d no more than 2400 mm above the sill.	cony or awning must be no more than 500 mm	✓	✓	✓	Skylight number Area of glazing Shading device Frame and glass type inc, frame (m2)		
Construction		Show on	Show on Certi	ier		•		ucent material must have a shading coefficien	t of less than 0.35.		1	5	SK01_Ens 1.5 no shading timber, double clear/air fill, (or U-value: 4.3, SHGC: 0.5)		
			Plans & specs	Pergolas	with fixed battens	must have b	attens pa	arallel to the window or glazed door above white			V	V	Legend		
Insulation requirements					s and glazed		-			1			In these commitments, "applicant" means the person carrying out the development.		
The applicant must construct the new or altered construction (floor(s), walls, and cei the table below, except that a) additional insulation is not required where the area of is not required for parts of altered construction where insulation already exists.	lings/roofs) in accordance with the specifications listed in new construction is less than 2m2, b) insulation specified	n 🗸	✓ V		door Orientation		vershad		Frame and glass type				Commitments identified with a "v" in the "Show on DA plans" column must be shown on the plans accompanying the development application development application is to be lodged for the proposed development).	for the propos	ed development (if a
Construction Additional insulation required (R-vs concrete slab on ground floor.	Other specifications	I		D01	NE	(m2) 8.65		0 none	standard aluminium, single clear, (or Ll-value: 7 63, SHGC: 0.75)				Commitments identified with a "v" in the "Show on CCiCDC plans & specs" column must be shown in the plans and specifications accompany certificate / complying development certificate for the proposed development.	ing the applica	tion for a construction
suspended floor above garage: framed (R0.7).				D02	SE	5.94		eave/verandah/pergola/balcony >=450 mm	standard aluminium, single clear, (or U-value: 7.63, SHGC: 0.75)				Commitments identified with a "\" in the "Certifier check" column must be certified by a certifying authority as having been fulfilled, before a fit development may be issued.	al occupation of	certificate for the
floor above existing dwelling or building.		11		W01	SE	0.84		0 none	standard aluminium, single clear, (or U-value: 7.63, SHGC: 0.75)						
external wall: brick veneer R1.16 (or R1.70 including constructions)	tion)			W02	SE	2.11		0 none	standard aluminium, single clear, (or U-value: 7.63, SHGC: 0.75)						
external wall: framed (weatherboard, fibro, metal clad)  R1.30 (or R1.70 including construct metal clad)	tion)			W03	NE	2.11		0 none	standard aluminium, single clear, (or U-value: 7.63, SHGC: 0.75)						



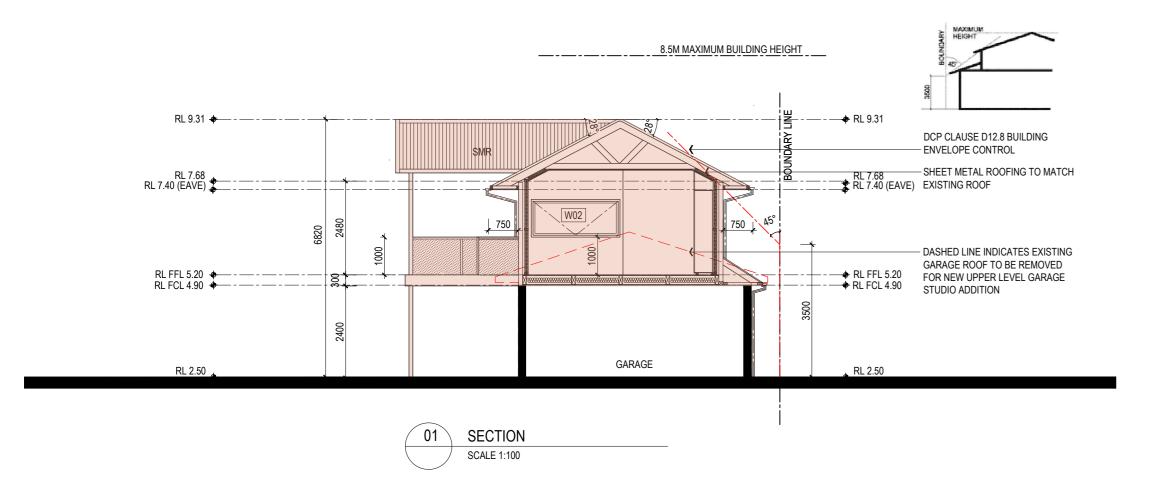

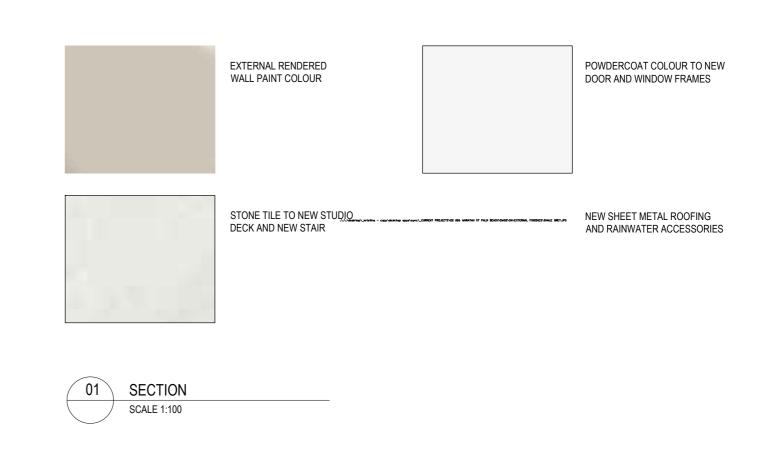

٧.	DATE	DESCRIPTION	CHECKED
	16.08.2023	ISSUED TO PLANNER FOR REVIEW	KM
	20.09.2023	ISSUED FOR DEVELOPMENT APPLICATION	KM
	12.02.2024	ROOF PITCH AMENDED, EXTERNAL STAIR TO	
		STUDIO DECK REMOVED	KM

ABBF	REVIATIONS			MAT	ERIALS AND FINISHE	S	
AC AHD AS AW BF CS DB DP (E) EQ F FCL FFF FFFL FRL FFF	AIR CONDITIONING AUSTRALIAN HEIGHT DATUM AUSTRALIAN STANDARD AWNING WINDOW BI-FOLD CASEMENT WINDOW DOUBLE DOWNPIPE EXISTING EQUAL FIXED FIXED FINISHED CEILING LEVEL FINISHED FLOOR LEVEL GROUND FLOOR	JN LFW LGF (N) NCC NGL NTS PV RT SKL SKL SL SMK TOG V VOS	JOINERY LINEAR FLOOR WASTE LOWER GROUND FLOOR NEW NATIONAL CONSTRUCTION CODE (BCA) NATURAL GROUND LEVEL NOT TO SCALE PHOTO VOLTAICS ROOF TILE SKYLIGHT SLIDING DOOR SMOKE ALARM TOP OF GUITTER VENIT VERIFY ON SITE	AD AL AW BB BK BMR CA CL CR FC G GD MRS P	ALUMINIUM DOOR ALUMINIUM ALUMINIUM WINDOW BARGE BOARD BRICK BITUMINOUS MEMBRANE ROOFING CARPET CLEAR FINISH CEMENT RENDER FASCIA BOARD FIBRE CEMENT GLAZED GLAZED TIMBER DOOR METAL ROOF SHEETING PANITED PAVING	PB R RC S ST TD TDK T & G TL/TC TW TL/F WB VT ZRS	PLASTERBOARD RENDERED REINFORCED CONCRETE SLATE STONE STONE TIMBER TIMBER BATTEN TIMBER BECKING TIMBER DECKING TIMBER BECKING TIMBER TONGUE & GROOVE TILE - TERRACOTTA TIMBER WINDOW TILE - FLOOR WEATHERBOARD VITRIFIED TILE ZINC ROOS SHEETING

two form pty ltd Nominated Architect Kristina Mitkovski NSW Reg No. 7998


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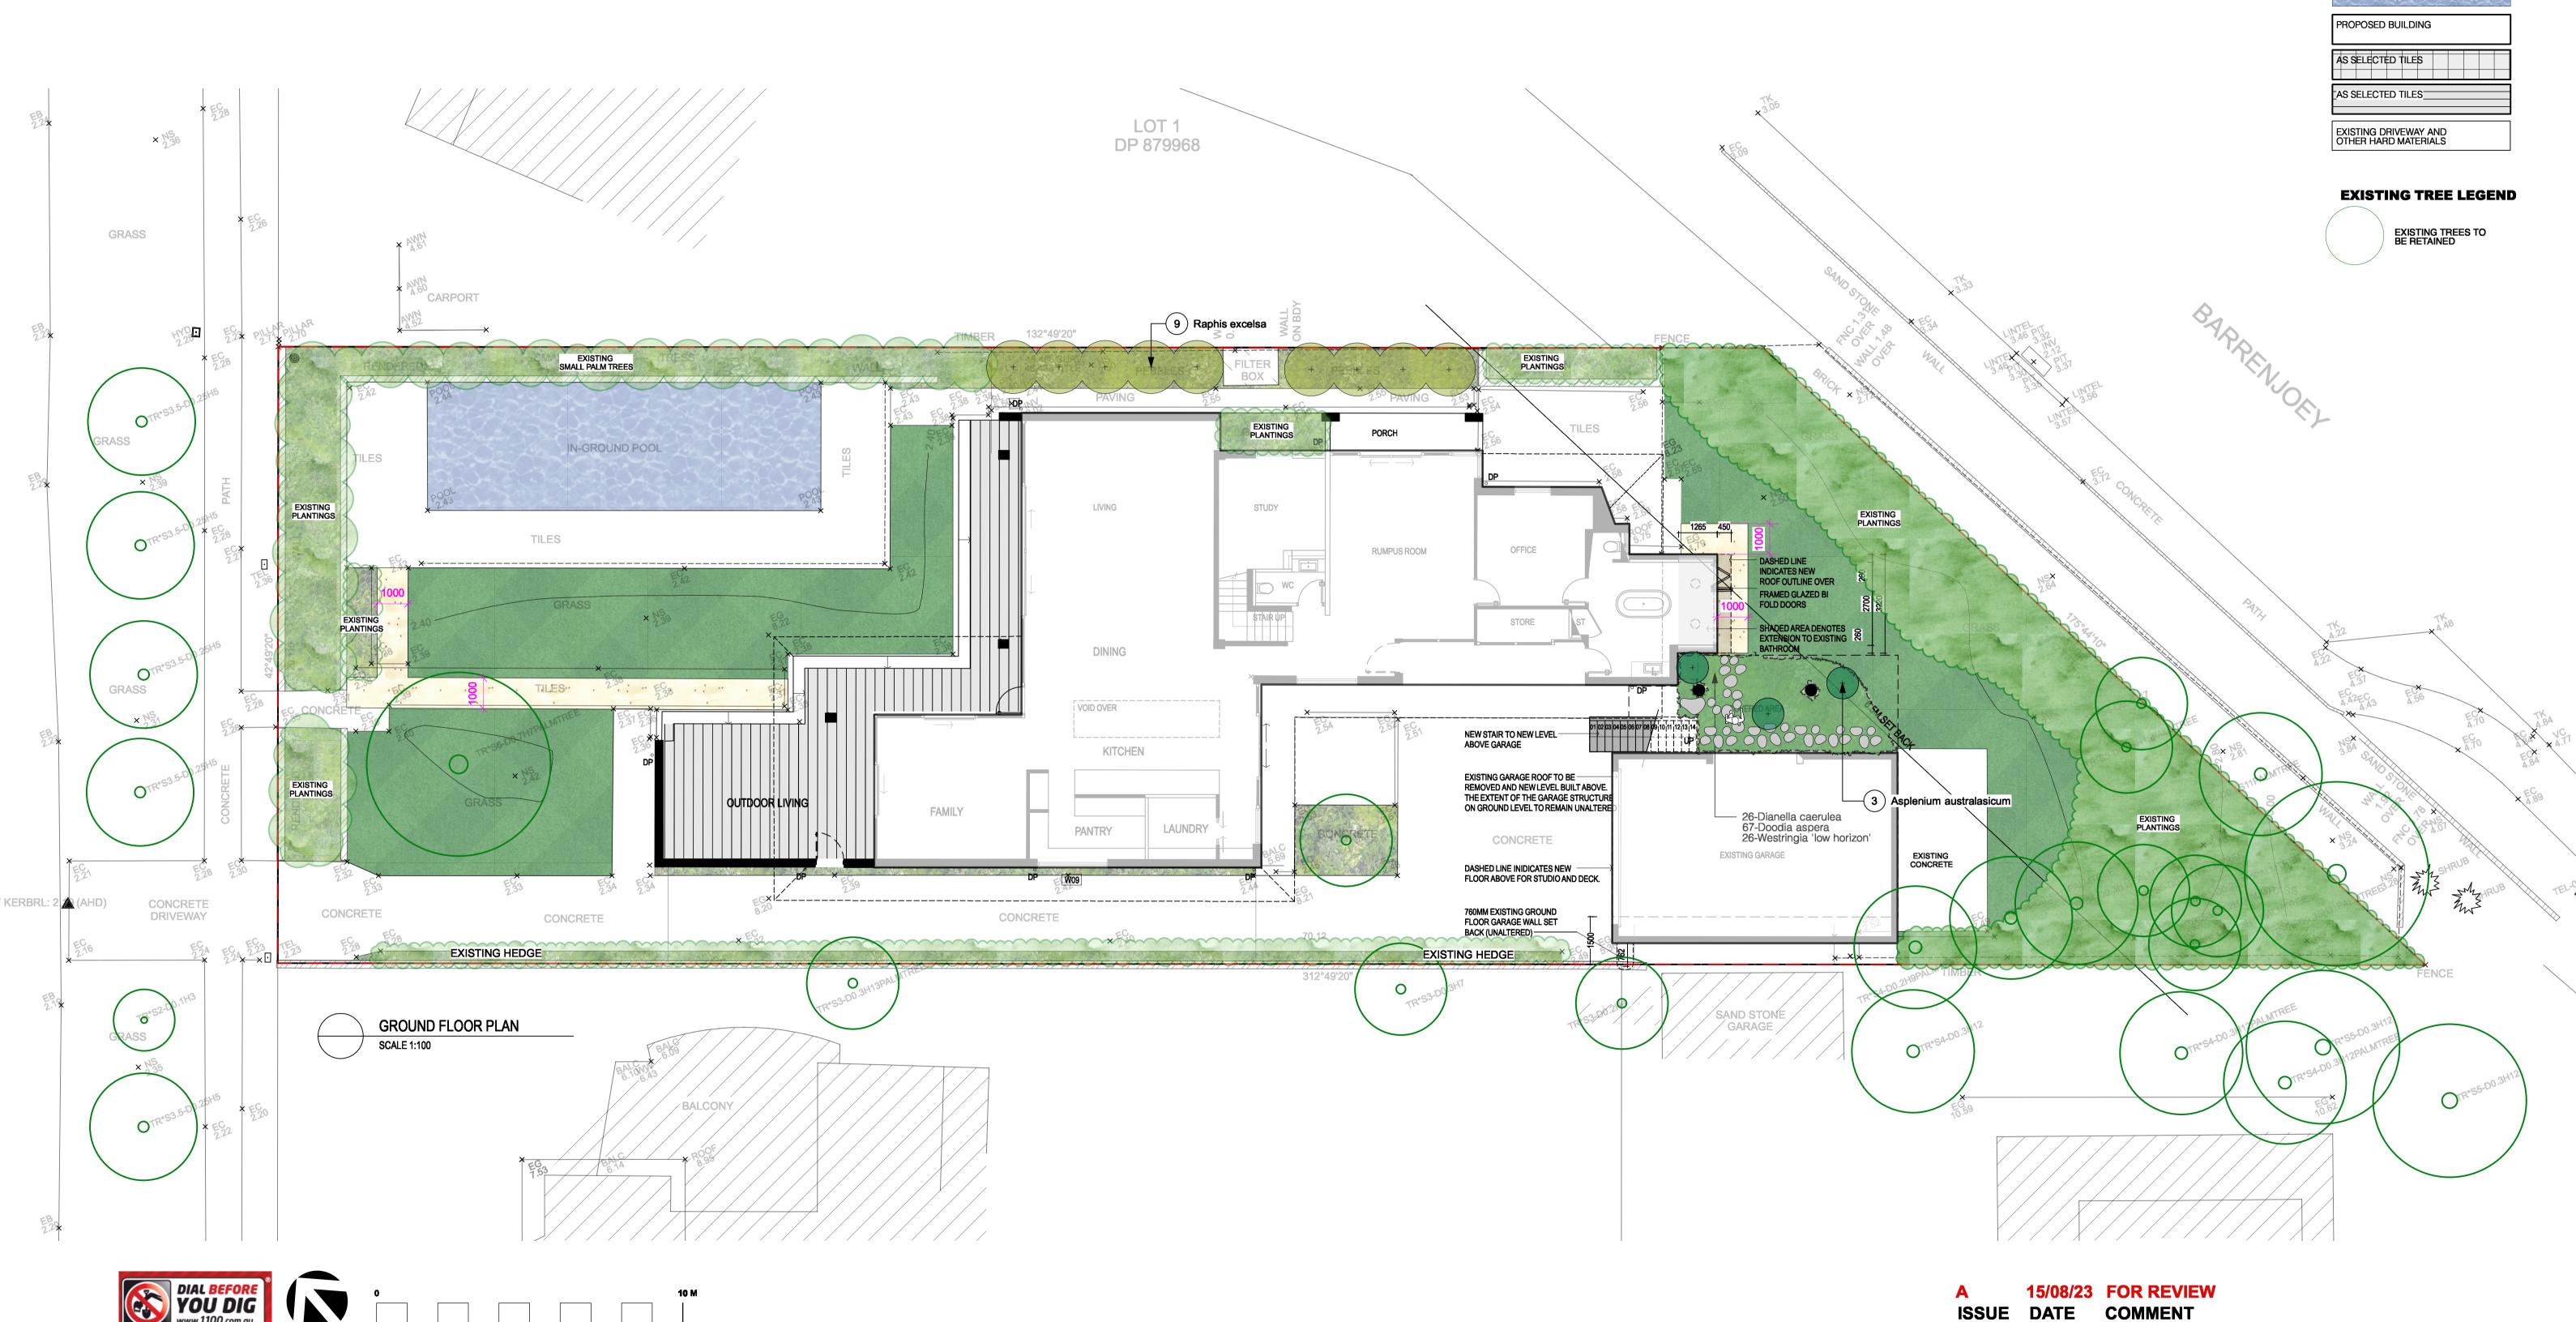
The Contractor shall confirm on site existing dimensions and conditions before commencement of works. All discrepancies should be reported to the Architect for instructions. Two Form does not accept responsibility for the dimensional accuracy of any data contained in CAD or other attachments as it may be based on third party origin information. All information should be verified in writing

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STEPHEN AND SUSAN JONES		date AUG 2023
PROJECT ALTERATIONS AND ADDITION TO EXISTING DWELLING 3 WARATAH ROAD, PALM BEACH LOT 15 DP 651513	DRAWING STAGE DEVELOPMENT APPLICATION	scale 1:100 AT A2
SECTION 01 AND EXTERNAL FINISHES	DRAWING NUMBER 22 026 AR <b>DA 09</b>	REVISION





GENERAL NOTES

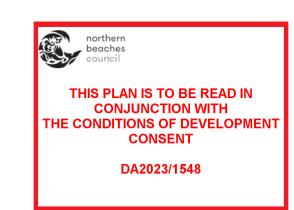All work to be carried out in accordance with the Building Code of Australia, all Local and State Government Ordinances, relevant Australian Standards, Local Authorities Regulations and all other relevant Authorities concerned.

All structural work and site drainage to be subject to Engineer's details or certification where required by Council. This shall include r.c. slabs and footings, r.c. and steel beams & columns, wind bracing to AS 1170 and AS4055, anchor rods or bolts, tie downs, fixings etc., driveway slabs and drainage to Council's satisfaction. All timbers to be in accordance with SAA Timber Structure Code AS1720 and SAA Timber Framing Code AS 1684. All work to be carried out in a professional and workman-shiplike manner according to the plans and specification.

NOTE

Do not scale off the drawings unless otherwise stated and use figured dimensions in preference.

All dimensions are to be checked and verified on site before the commencement of any work, all dimensions and levels are subject to final survey and set-out

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Project
Address

ct PROPOSED ALTERATIONS AND ADDITION TO EXISTING DWELLING

3 WARATAH ROAD, PALM BEACH LOT 15 DP 651513

Drawing Title GROUND FLOOR LANDSCAPE PLAN

Date 15/08/23

**Drawing No. 1489** 

Scale 1:100@A1

**AMENDMENTS** 

Page


**LEGEND** 


AS SELECTED PAVING

DEEP SOIL GARDENS

EXISTING PLANTING

EXISTING POOL

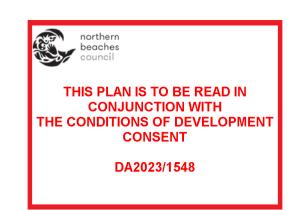

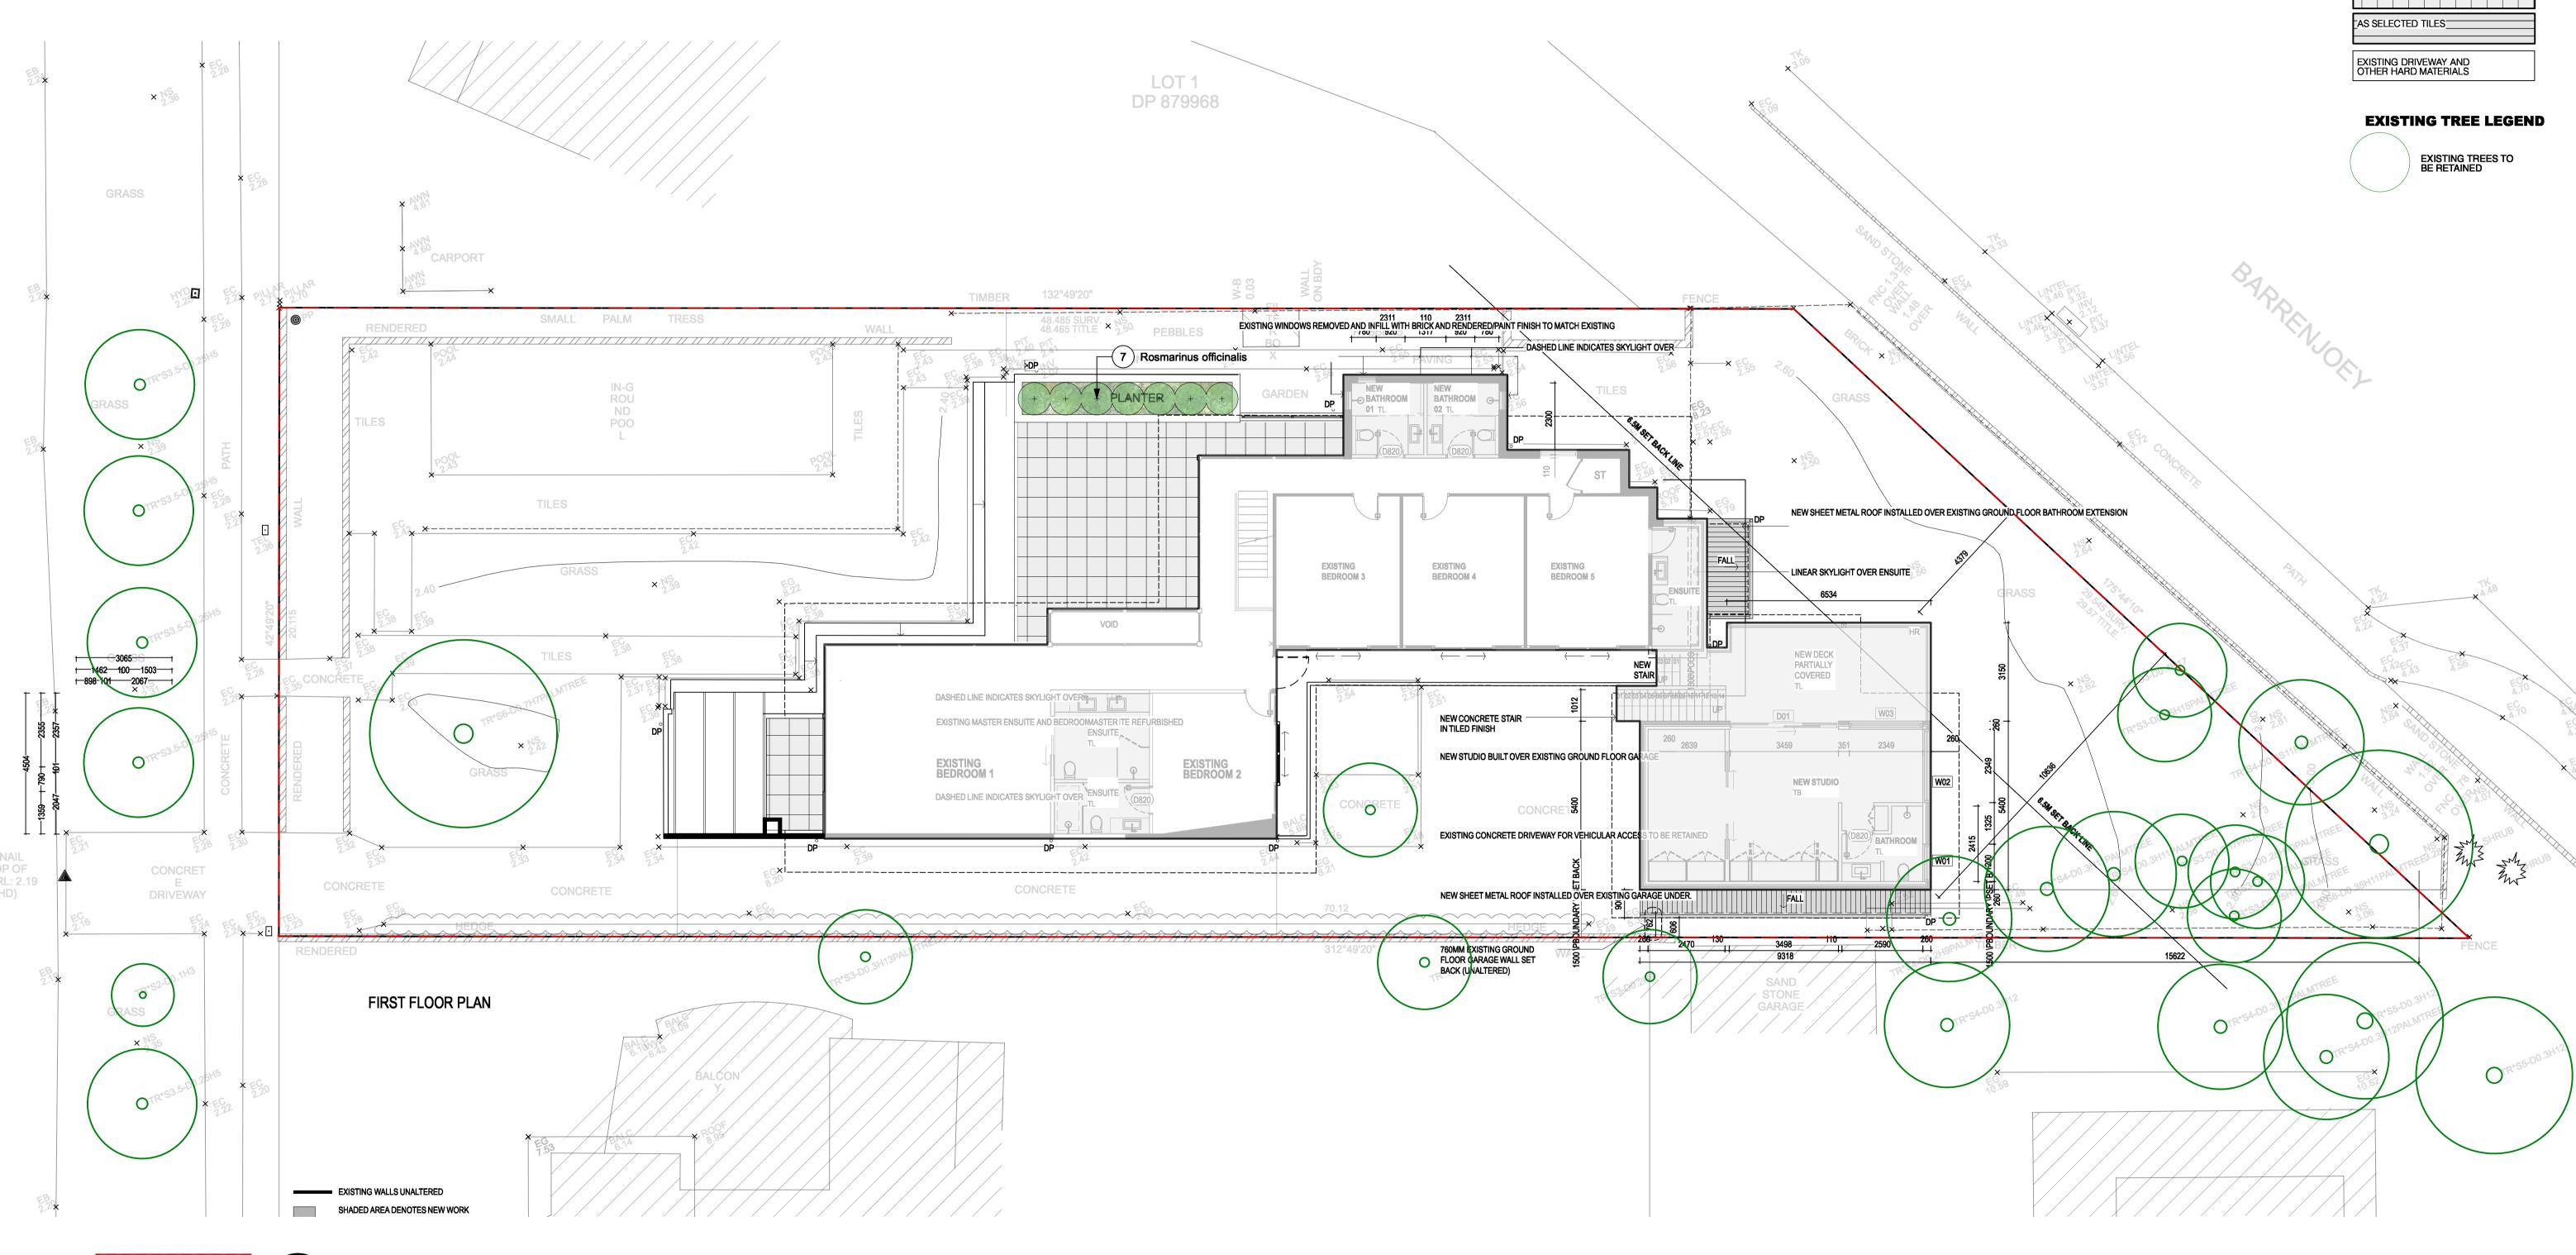

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A 15/08/23 FOR REVIEW ISSUE DATE COMMENT

**AMENDMENTS** 

ENERAL NOTES

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ect PROPOSED ALTERATIONS AND ADDITION TO EXISTING DWELLING
ess 3 WARATAH ROAD, PALM BEACH LOT 15 DP 651513
Date

Drawing Title FIRST FLOOR LANDSCAPE PLAN

Date **15/08/23** 

Scale 1:100@A1

8/23 L-O

Page

**LEGEND** 

AS SELECTED PAVING

DEEP SOIL GARDENS

EXISTING PLANTING

PROPOSED BUILDING

AS SELECTED TILES

EXISTING POOL

Drawing No.1489


Plant List						
ID	Botanical Name	Common Name	Scheduled Size	<b>Mature Height</b>	<b>Mature Spread</b>	Qty
Trees					_	
Shrubs						
rap-exc	Raphis excelsa	Lady Palm	300mm	3 - 5m	2.0 - 3.5m	9
Ros-off	Rosmarinus officinalis	Rosemary	200mm	1.5 - 3m	1.2 - 2.0m	7
<b>Ground Covers</b>						
wes-lh'	Westringia 'low horizon'	coastal rosmary	200mm	0.4m	0.8m	26
Grasses						
Dia-cae	Dianella caerulea	Blue Flax-lily	150mm	0.4m	0.6m	26
asp-aus	Asplenium australasicum	Birds Nest Fern	150mm	1m	1.2m	3
doo-asp	Doodia aspera	Rasp Fern	150mm	0.3	1m	67








Doodia aspera Dianella caerulea Westringia low horizon Rosemarinus officinalis Crow's nest fern Coastal rosemary **Lady Palm** Flax Lilly Rosemary

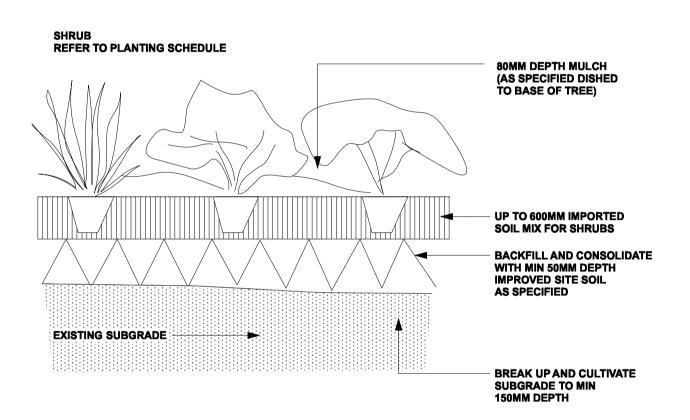



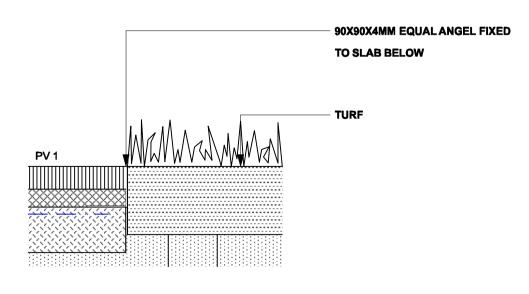





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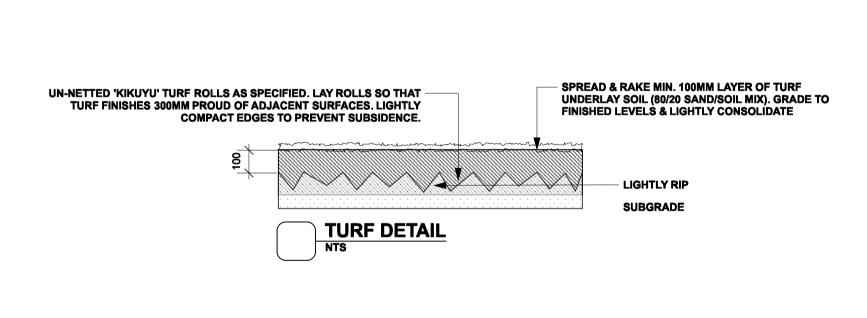
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LANDSCAPE MAINTENANCE NOTES

COMPLETION AND THE DATE OF FINAL COMPLETION. MAINTENANCE/ ESTABLISHMENT PERIOD: 12 MONTHS.

PLANT REPLACEMENT REQUIREMENTS.

OF THE PLANTING ESTABLISHMENT PERIOD.

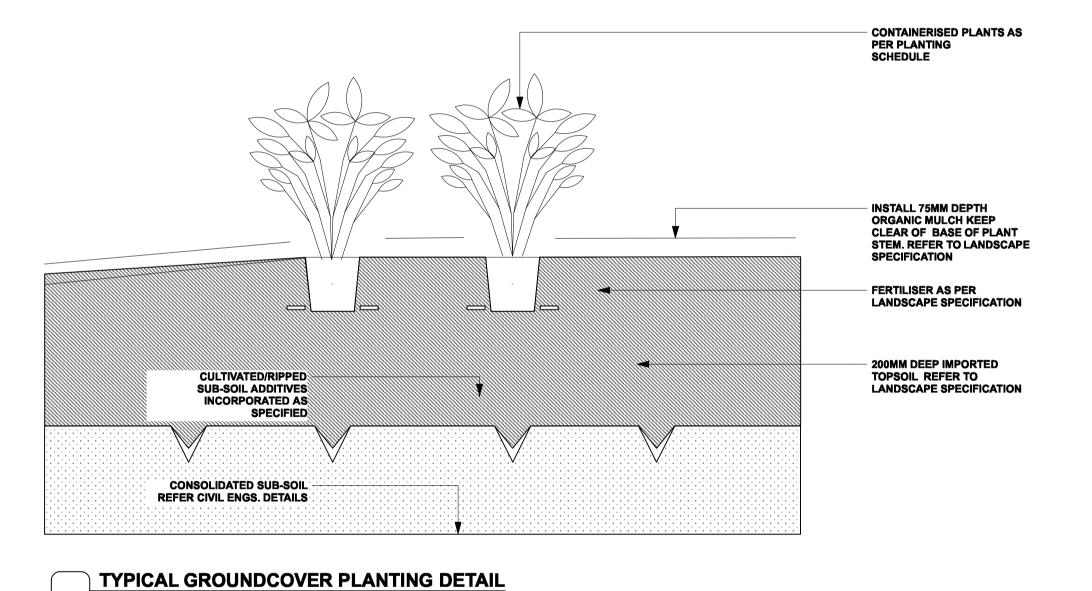\* REPAIRS TO PLANTING MEDIA COMPLETED.

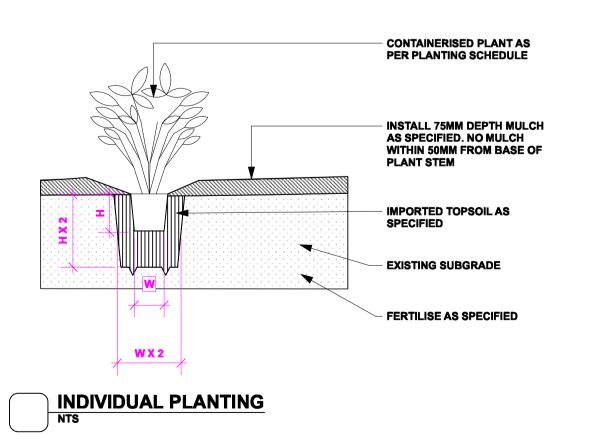CONDITION AND TO THE SPECIFIED DEPTH.

\* PLANTS HAVE HEALTHY ROOT SYSTEMS.

\* VEGETATION IS ESTABLISHED AND WELL FORMED.

\* COLLECTION AND REMOVAL OF LITTER COMPLETED.

\* ALL DEFECTS NOTIFICATIONS HAVE BEEN CLOSED OUT.

THE CONTRACTOR SHALL CONTINUOUSLY MAINTAIN ALL AREAS OF THE CONTRACT DURING THE PROGRESS

SITE CONTROL: REPORT TO THE PRINCIPAL'S DESIGNATED REPRESENTATIVE ON ARRIVING AT AND BEFORE LEAVING THE SITE. PLANT ESTABLISHMENT PERIOD: THE PERIOD BETWEEN THE DATE OF PRACTICAL

PLANT ESTABLISHMENT: MAINTAIN THE CONTRACT AREA DURING THE PLANT ESTABLISHMENT PERIOD. ENSURE THE GENERAL APPEARANCE AND PRESENTATION OF THE LANDSCAPE AND THE QUALITY OF PLANT MATERIAL AT DATE OF PRACTICAL COMPLETION IS MAINTAINED FOR THE FULL PLANTING ESTABLISHMENT PERIOD. EXISTING PLANT MATERIAL: MAINTAIN EXISTING PLANTING WITHIN THE LANDSCAPE CONTRACT AREA AS SPECIFIED

REPLACEMENTS: REPLACE FAILED, DEAD AND/OR DAMAGED PLANTS AT MINIMUM 3 WEEK INTERVALS AS NECESSARY THROUGHOUT THE FULL PLANT ESTABLISHMENT PERIOD. REPORTING: SUBMIT REGULAR REPORTS BY THE LAST FRIDAY OF EACH MONTH SUMMARISING THE GENERAL STATUS OF WORKS. INCLUDE A MAINTENANCE SCHEDULE, A LOG BOOK OF MAINTENANCE ACTIVITY, SOIL TEST RESULTS AS REQUIRED FOR ANY FERTILISING PROGRAMS, AND

WATER RESTRICTIONS: COORDINATE THE WATER SUPPLY AND CONFIRM THE WATERING REGIME AGAINST RELEVANT

GOVERNMENT LEGISLATION AND RESTRICTIONS AT THE TIME. STAKES AND TIES: REMOVE AT THE END OF THE PLANTING ESTABLISHMENT PERIOD. TEMPORARY FENCES: REMOVE TEMPORARY PROTECTIVE FENCES AT THE END


COMPLIANCE: PLANT ESTABLISHMENT SHALL BE DEEMED COMPLETE, SUBJECT TO THE FOLLOWING:

\* PESTS, DISEASE, OR NUTRIENT DEFICIENCIES OR TOXICITIES ARE NOT EVIDENT. \* MULCHED SURFACES HAVE BEEN MAINTAINED IN A WEED FREE AND TIDY

\* VEGETATION IS NOT RESTRICTING ESSENTIAL SIGHT LINES AND SIGNAGE.

\* REMOVAL OF MULCH FROM DRAINAGE AND ACCESS AREAS COMPLETED.

OF THE WORKS. THE CONTRACTOR SHALL COMMENCE AND FULLY IMPLEMENT THE SHORT-TERM MAINTENANCE AND ESTABLISHMENT AFTER PRACTICAL COMPLETION HAS BEEN CONFIRMED.

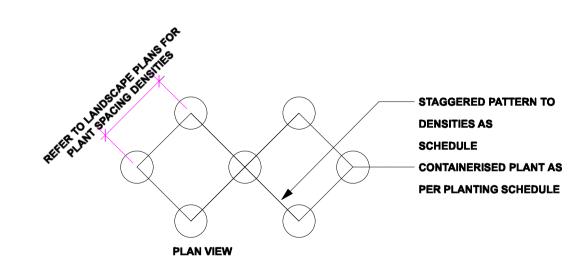

ISSUE DATE COMMENT

## **AMENDMENTS**

**Project** PROPOSED ALTERATIONS AND ADDITION TO EXISTING DWELLING

**3 WARATAH ROAD, PALM BEACH LOT 15 DP 651513 Address** 

Date 15/08/23

Page

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Drawing Title **PLANTING DETAILS** 

**CONJUNCTION WITH** 

THE CONDITIONS OF DEVELOPMENT

CONSENT

DA2023/1548

Drawing No.1489

Scale N.T.S@A1

# **ALTERATIONS & ADDITIONS** AT 3 WARATAH ROAD, PALM BEACH

#### GENERAL

- These drawings shall be read in conjunction with all architectural and other consultants drawings and specifications and with such other written instructions and sketches as may be issued during the course of the Contract. Any discrepancies shall be referred to the Superintendent before proceeding with any related works. Construction from these drawings, and their associated consultant's drawings is not to commence until approved by the Local Authorities.
- G2 All materials and workmanship shall be in accordance with the relevant and current Standards Australia codes and with the By-Laws and Ordinances of the relevant building authorities except where varied by the project specification.
- G3 All set out dimensions shall be obtained from Architect's and Engineer's details. All discrepancies shall be referred to the Architect and Engineer for decision before proceeding with related work.
- G4 During construction the structure shall be maintained in a stable condition and no part shall be overstressed Temporary bracing shall be provided by the builder/subcontractor to keep the works and excavations stable at all times.
- G6 The alignment and level of all services shown are approximate only. The contractor shall confirm the position and level of all services prior to commencement of construction. Any damage to services shall be rectified at
- G7 Any substitution of materials shall be approved by the Engineer and included in any tender.
- G8 All services or conduits for servicing shall be installed prior to commencement of pavement construction
- G10 The structural components detailed on these drawings have been designed in accordance with the relevant Standards Australia codes and Local Government Ordinances for the following loadings. Refer to the Architectural drawings for proposed floor usage. Refer to drawings for live loads and superimposed dead loads.

#### DRAINAGE NOTES

- D1 All drainage levels to be confirmed on site, prior to any construction commencing.
- D2 All pipes within the property to be a minimum of 100 dia upyc @ 1% minimum grade, uno.
- D3 All pits within the property are to be fitted with "weldlok" or approved equivalent grates:
   Light duty for landscaped areas leavy duty where subjected to vehicular traffic
- D4 All pits within the property to be constructed as one of the following:
- Precast stormwater pils
   Comment of the standard standard
- D5 Ensure all grates to pits are set below finished surface level within the property. Top of pit RL's are approximate only and may be varied subject to approval of the engineer. All invert levels are to be achieved.

- D8 Provide step irons to stormwater pits greater than 1200 in depth.
- D9 Trench back fill in roadways shall comprise sharp, clean granular back fill in accordance with the relevant local authority specification to non-trafficable areas to be compacted by rodding and tamping using a flat plate vibrator.
- D10 Where a high early discharge (hed) pit is provided all pipes are to be connected to the hed pit, uno.
- D11 Down pipes shall be a minimum of dn100 sw grade upvc or 100 x100 colorbond/zincalume steel, uno.
- D12 Colorbond or zincalume steel box gutters shall be a minimum of 450 wide x 150 deep.
- D14 Subsoil drainage shall be provided to all retaining walls & embankments, with the lines feeding into the stormwater drainage system, uno.

#### **EROSION AND SEDIMENT CONTROL NOTES**

- E1 These notes are to be read in conjunction with erosion and sediment control details in this drawing set.
- E2 The contractor shall implement all soil erosion and sediment control measures as necessary and to the is a continuous shall mislement as see devision and seminor control measures as incessary and to are satisfaction of the relevant lead authority prior to the commencement of and during construction. No disturbance to the site shall be permitted other than in be immediate area of rows and no material shall be removed from the site without the relevant local authority approval. All erosion and sediment control devices to be installed and maintained in accordance within standards outlined in new department of housing's "managing urban stormwater" soils and construction's and accordance within standards outlined in new department of housing's "managing urban stormwater" soils and constructions.
- E3 Place straw bales length wise in a row as parallel as possible to the site contours, uno. Bale ends to be tightly butted. Bales are to be placed so that straws are parallel to the row. Bales are to be placed 1.5m to 2m downslope from the toe of the disturbed batter, uno.
- Council approved filter fabric to be entrenched 150mm deep upslope towards disturbed surface. Fabric to be a minimum SF2000 or better. Fix fabric to posts with wire ties or as recomended with manufacturer's specifications. Pathoric joints to have a minimum of 150mm overlap. Wire to be strung between posts with filter fabric overlap to prevent sagging.
- Stabalised entry/exit points to remain intact until finished driveway is complete. Construction of entry/exit points to be maintained and repaired as required so that it's function is not compromised. Construction of entry/exit point to be in accordance with the detail contained within this drawing set.
- E6 All drainage pipe inlets to be capped until:
- E6 Provide and maintain silt traps around all surface inlet pits until catchment is revegetated or paved.
- The contractor shall regularly maintain all erosion and sediment control devices and remove accumulated sit
- Topsoil shall be stripped and stockpiled outside hazard areas such as drainage lines. This topsoil shall be respread later on areas to be revegetated and stabilised only, (i.e. all footpaths, batters, site regarding areas, basins and catchdrains). Topsoil shall not be respread on any other areas unless specifically instructed by the superintendent. If they are to remain for fonger than one month stockpiles shall be protected from erosion by covering them with a mulch and hydroseeding and, if necessary, by locating banks or drains downstream of a stockpile to retard slit laden runoff.
- E11 The contractor shall grass seed all disturbed areas with an approved mix as soon as practicable after
- E12 Revegetate all trenches immediately upon completion of backfilling.
- E13 When any devices are to be handed over to council they shall be in clean and stable condition

STANDARD LINE TYPES AND SYMBOLS				
	PROPOSED KERB & GUTTER			
	EXISTING KERB & GUTTER			
	PROPOSED BELOW GROUND PIPELINE			
	PROPOSED SUSPENDED PIPELINE			
	EXISTING PIPELINE			
—— ss ——	SUBSOIL DRAINAGE LINE			
	PROPOSED KERB INLET PIT			
	EXISTING KERB INLET PIT			
	PROPOSED JUNCTION OR INLET PIT			
	EXISTING JUNCTION OR INLET PIT			
	DESIGN CENTRELINE			
	EXISTING EDGE OF BITUMEN			
— т —	TELECOMUNICATION CONDUIT			
—— G ——	GAS MAIN			
— w —	WATER MAIN			
—— s ——	SEWER MAIN			
v	UNDERGROUND ELECTRICITY CABLES			
0	PERMANENT MARK & S.S.M.			
Δ Δ	BENCH MARK, SURVEY STATION			

	STANDARD LINE TYPES AND SYMBOLS						
1							
	$\Rightarrow \Rightarrow \Rightarrow$	OVERLAND FLOW PATH					
	<del></del>	GUTTER DRAINAGE DIRECTION					
	O&	DOWNPIPE					
	<b>∂</b> <sup>3</sup>	DOWNPIPE WITH SIDE OVERFLOW					
	* * * * *	PERVIOUS (GRASSED) AREAS					
	x RL= ??	EXISTING (PRE-DEVELOPMENT) RL					
	x RL= ??	POST DEVELOPMENT RL					
	FALL	GRADED IMPERVIOUS AREA (ROOF, CONC SLABS ETC)					
		SEDIMENT FENCE					
		CROSSING PIPES					
	1	NODE POINT					

LEGEND					
AHD	Australian height datum	SS	Stainless steel		
AG	Ag-pipe (Sub soil drainage)	SU	Box gutter sump		
ARI	Average recurrence interval	TW	Top of wall		
BG	Box Gutter	TWL	Top water level		
BWL	Bottom water level	U/S	Underside of slab		
CL	Cover level	VG	Vally gutter		
CO	Clean out inspection opening	UNO	Unless noted otherwise		
DCP	Discharge control pit				
DP	Down pipe				
DRP	Dropper pipe				
EBG	Existing box gutter				
EDP	Existing down pipe				
EEG	Existing eaves gutter				
EG	Eaves gutter				
FRC	Fiber reinforced concrete				
FW	Floor waste				
GD	Grated drain				
GSIP	Grated surface inlet pit				
HED	High early discharge				
HP	High point of gutter				
IL.	Invert level				
IO	Inspection opening				
O/F	Overflow				
OSD	On-site detention				
PSD	Permissible site discharge				
P1	Pipe 1				
RCP	Reinforced concrete pipe				
RHS	Rectangular hollow section				
RL	Reduced level				
RRJ	Rubber ring joint				
RRT	Rainwater re-use tank				
RWH	Rain water head				
RWO	Rain water outlet				
SLAP	Sealed lid access pit				
SP	Spreader pipe				
SPR	Spreader				

RECOMMENDED MAINTENANCE SCHEDULE					
DISCHARGE CONTROL PIT (DCP)	FREQUENCY	RESPONSIBILITY	PROCEDURE		
Inspect flap valve and remove any blockage.	Six monthly	Owner	Remove grate. Ensure flap valve moves freely and remove any blockages or debris.		
Inspect screen and clean.	Six monthly	Owner	Revove grate and screen if required and clean it.		
Inspect & remove any blockage of orifice.	Six monthly	Owner	Remove grate & screen to inspect orifice. see plan for location of dcp.		
Inspect dcp sump & remove any sediment-sludge.	Six monthly	Owner	Remove grate and screen. Remove sediment/sludge build-up and check orifice and flap valve clear.		
Inspect grate for damage or blockage.	Six monthly	Owner	Check both sides of grate for corrosion, (especially corners and welds) damage or blockage.		
Inspect return pipe from storage and return any blockage.	Six monthly	Owner	Remove grate and screen. ventilate underground storage if present. open flap valve and remove any blockages in return line. Check for sludge/debris on upstream side of return line.		
Inspect outlet pipe and remove any blockage.	Six monthly	Maintenance Contractor	Remove grate and screen. ventilate underground storage if present. Check orifice and remove any blockages in outlet pipe. Flush outlet pipe to confirm it drains freely. Check for sludge/debris on upstream side of return line.		
Check fixing of step irons is secure.	Six monthly	Maintenance Contractor	Remove grate and ensure fixings secure prior to placing weight on step iron.		
Inspect overflow weir & remove any blockage.	Six monthly	Maintenance Contractor	Remove grate and open cover to ventilate underground storage if present. ensure weir clear of blockages.		
Empty basket at overflow weir (if present).	Six monthly	Maintenance Contractor	Remove grate and ventilate underground storage chamber if present. Empty basket, check fixings secure and not corroded.		
Check attachment of orifice plate to wall of pit (gaps less than 5 mm).	Annually	Maintenance Contractor	Remove grate and screen. ensure plate mounted securely, tighten fixings if required. seal gaps as required.		
Check attachment of screen to wall of pit.	Annually	Maintenance Contractor	Remove grate and screen. ensure screen fixings secure. repair as required.		
Check screen for corrosion.	Annually	Maintenance Contractor	Remove grate and examine screen for rust or corrosion, especially at corners or welds.		
Check attachment of flap valve to wall of .	Annually	Maintenance Contractor	Remove grate. Ensure fixings of valve are secure.		
Check flap valve seals against wall of pit.	Annually	Maintenance Contractor	Remove grate. fill pit with water and check that flap seals against side of pit with minimal leakage.		
Check any hinges of flap valve move freely.	Annually	Maintenance Contractor	Remove grate. Test valve hinge by moving flap to full extent.		
Inspect dcp walls (internal and external, if appropriate) for cracks or spalling.	Annually	Maintenance Contractor	Remove grate to inspect internal walls. Repair as required. Clear vegetation from external walls if necessary and repair as required.		
Check step irons for corrosion.	Annually	Maintenance Contractor	Remove grate. Examine step irons and repair any corrosion or damage.		
Check orifice diameter correct and retains sharp edge.	Five yearly	Maintenance Contractor	Compare diameter to design (see work-as- executed) and ensure edge is not pitted or damaged.		
STORAGE					
Inspect & remove any blockage of orifice.	Six monthly	Owner	Remove grate and screen. remove sediment/sludge build-up.		
Check orifice diameter correct and retains sharp edge.	Six monthly	Owner	Remove blockages from grate and check if pit blocked.		
Inspect screen and clean.	Six monthly	Owner	Remove debris and floatable material likely to be carried to grates.		
Check attachment of orifice plate to wall of pit (gaps less than 5 mm).	Annually	Maintenance	Remove grate to inspect internal walls, repair as required, clear vegetation from external walls if necessary and repair as required.		
Check attachment of screen to wall of pit.	Five yearly	Maintenance Contractor	Compare actual storage available with work-as executed plans. If volume loss is greater than 5%, arrange for reconstruction to replace the volume lost. Council to be notified of the proposal.		
Check attachment of screen to wall of pit.	Five yearly	Maintenance Contractor	Check along drainage lines and at pits for subsidence likely to indicate leakages.		



THIS PLAN IS TO BE READ IN **CONJUNCTION WITH** THE CONDITIONS OF DEVELOPMENT CONSENT

DA2023/1548

NOTE: BUILDER/PLUMBER TO INVESTIGATE SITE CONDITIONS, CONFIRM STORMWATER CONNECTION HEIGHT LEVELS AND LOCATION TO ENSURE CONSISTENCY WITH THE DESIGN. ANY DISCREPANCIES OR CONFLICTS WHICH MAY AFFECT THE PROPOSED DESIGN TO BE REPORTED TO THE ENGINEER PRIOR TO THE COMMENCEMENT OF CONSTRUCTION.

NOTE: DO NOT SCALE OFF DRAWINGS. THE CONTRACTOR SHALL CHECK ALL DIMENSIONS AND LEVELS SHOWN ON ARCHITECTURA AND ENGINEERING DRAWINGS, ANY DISCREPANCIES MUST BE REPORTED PRIOR TO THE COMMENCEMENT OF CONSTRUCTION.

			1
A	25.08.23	ISSUED FOR APPROVAL	S.R.
REV	DATE	DESCRIPTION	BY


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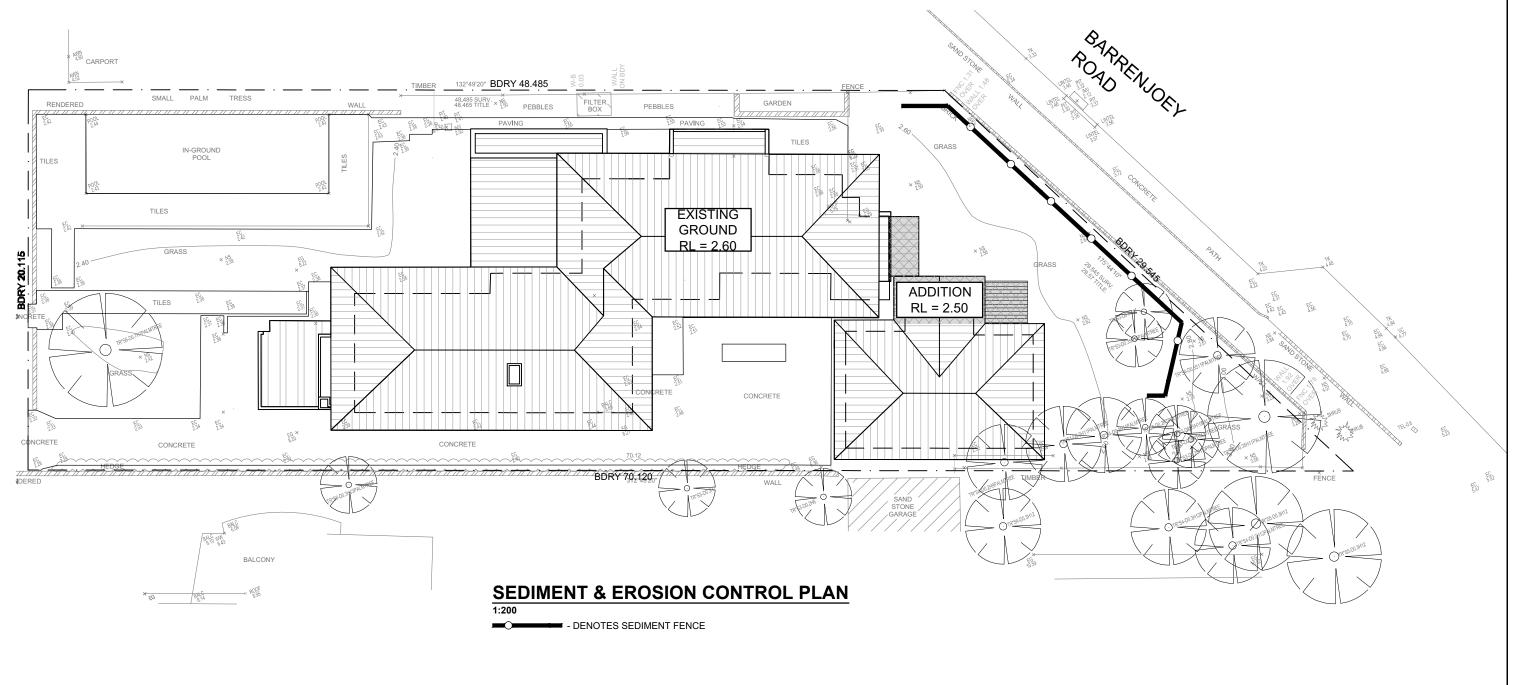
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ALTERATIONS & ADDITIONS AT 3 WARATAH ROAD, PALM BEACH	JOB NUMBER: 230103	
FOR TWO FORM ARCHITECTURE	DESIGNED BY: S.R.	D
CENEDAL NOTES	DRAWN BY:	S
GENERAL NOTES	C D	







NOTE: BUILDER/PLUMBER TO INVESTIGATE SITE CONDITIONS, CONFIRM STORMMATER CONNECTION HEIGHT LEVELS AND LOCATION TO ENSURE CONSISTENCY WITH THE DESIGN. ANY DISCREPANCIES OR CONFLICTS WHICH MAY AFFECT THE PROPOSED DESIGN TO BE REPORTED TO THE ENGINEER PRIOR TO THE COMMENCEMENT OF CONSTRUCTION.

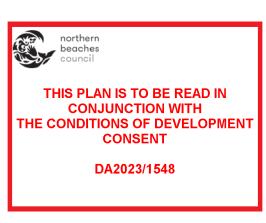NOTE: DO NOT SCALE OFF DRAWINGS. THE CONTRACTOR SHALL CHECK ALL DIMENSIONS AND LEVELS SHOWN ON ARCHITECTURAL AND ENGINEERING DRAWINGS. ANY DISCREPANCIES MUST BE REPORTED PRIOR TO THE COMMENCEMENT OF CONSTRUCTION.

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REV	DATE	DESCRIPTION	BY	

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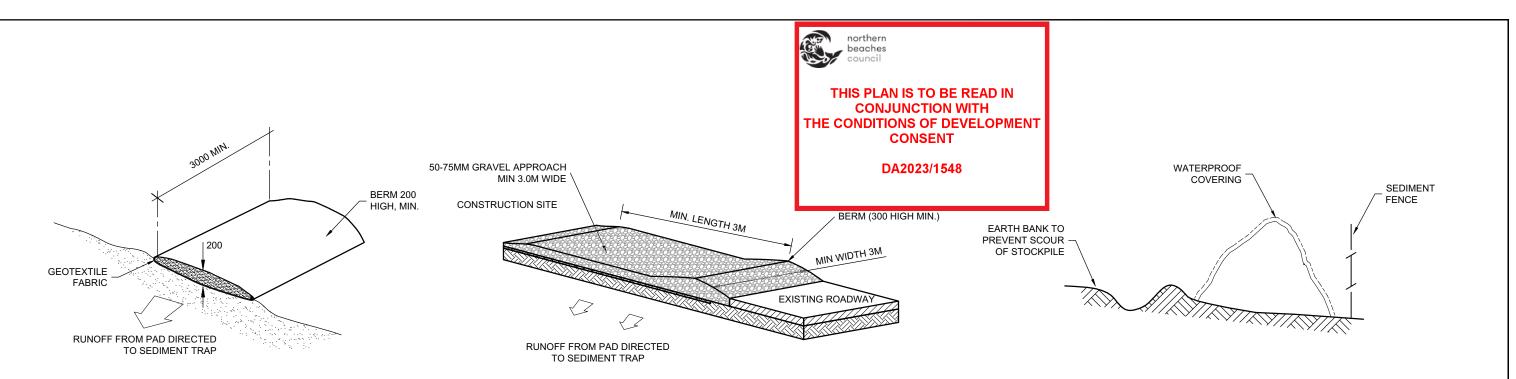
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ALTERATIONS & ADDITIONS AT 3 WARATAH ROAD, PALM BEACH FOR TWO FORM ARCHITECTURE	
SEDIMENT & EROSION	

CONTROL PLAN

JOB NUMBER: 230103	DWG NUMBER: C01.01	ORIGINAL SIZ
DESIGNED BY: S.R.	DATE: AUGUST 2023	
DRAWN BY: S.R.	SCALE: 1:200 U.N.O.	



**OPTION 1 - EXISTING DRIVEWAY TO REMAIN** 

OPTION 2 - DRIVEWAY TO BE RENEWED


#### **VEHICLE ACCESS TO SITE**

VEHICLE ACCESS TO THE BUILDING SITE SHOULD BE RESTRICTED TO A SINGLE POINT SO AS TO REDUCE THE AMOUNT OF SOIL DEPOSITED ON THE STREET PAVEMENT.

### **BUILDING MATERIAL STOCKPILES**

ALL STOCKPILES OF BUILDING MATERIAL SUCH AS SAND AND SOIL MUST BE PROTECTED TO PREVENT SCOUR AND EROSION.

THEY SHOULD NEVER BE PLACED IN THE STREET GUTTER WHERE THEY WILL WASH AWAY WITH THE FIRST RAINSTORM.

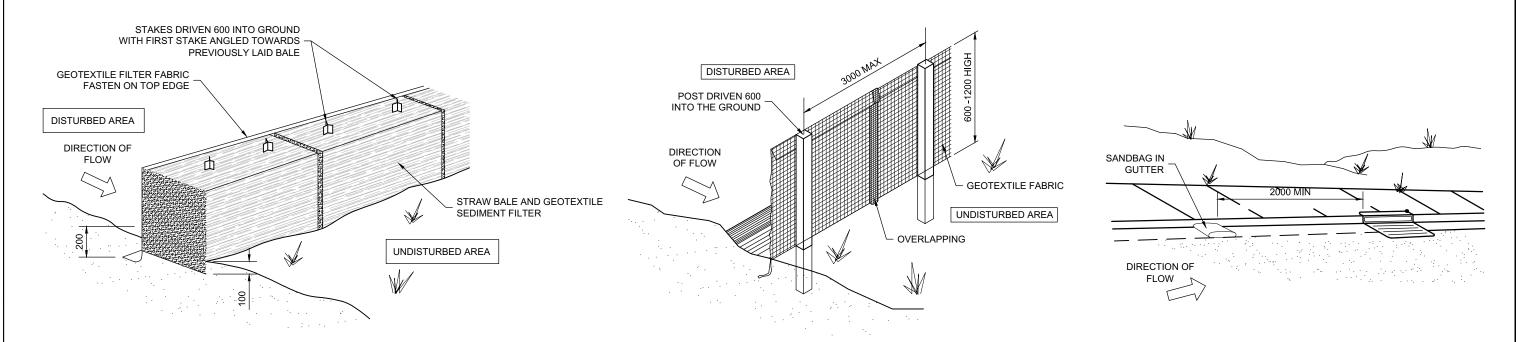

## STRAW BALE DETAIL

## SEDIMENT AND EROSION FENCE DETAIL

### SANDBAG KERB SEDIMENT TRAP

IN CERTAIN CIRCUMSTANCES EXTRA SEDIMENT TRAPPING MAY BE NEEDED IN THE STREET GUTTER.

NOTE: BUILDER/PLUMBER TO INVESTIGATE SITE CONDITIONS, CONFIRM STORMWATER CONNECTION HEIGHT LEVELS AND LOCATION TO ENSURE CONSISTENCY WITH THE DESIGN. ANY DISCREPANCIES OR CONFLICTS WHICH MAY AFFECT THE PROPOSED DESIGN TO BE REPORTED TO THE ENGINEER  $\underline{\text{PRIOR}}$  TO THE COMMENCEMENT OF CONSTRUCTION.

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ALTERATIONS & ADDITIONS
AT 3 WARATAH ROAD, PALM BEACH
FOR TWO FORM ARCHITECTURE
SEDIMENT & EDOSION

**CONTROL DETAILS** 

;	230103	C01.02	ORIGINAL SIZE:
	DESIGNED BY: S.R.	DATE: AUGUST 2023	
	DRAWN BY: S.R.	SCALE: 1:20 U.N.O.	