

ITEM DETAILS ADDRESS

LOT & DP/SF COUNCIL

SITE AREA

FRONTAGE

CONTROLS

HAZARDS

LAND ZONING

MINIMUM LOT SIZE

FLOOR SPACE RATIO

ACID SULFATE SOILS

FLOOD PLANNING

**RIPARIAN LAND &** 

WATERCOURSE

LANDSLIP RISK

WETLANDS

BUSHFIRE

DCP

MAXIMUM BUILDING HEIGHT

TERRESTRIAL BIODIVERSITY

FORESHORE SCENIC PRO. AREA

**RESIDENTIAL OPEN SPACE** 

**TOTAL OPEN SPACE (TOS)** 

OPEN SPACE ABOVE GROUND

SECONDARY FRONT SETBACK

PRINCIPAL PRIVATE OPEN SPACE

LANDSCAPE AREA

FRONT SETBACK

SIDE SETBACKS

**CAR PARKING SPACES** 

LEP

# ACTION PLANS

EXISTING

 $m/m^2/\%$ 

344.7m<sup>2</sup>

8.15m

n/a

n/a

124.28m<sup>2</sup>

6.61m

F: 9.52

S: 0.085m

0.45

0

0.47:1 (162.09m<sup>2</sup>)

145.92m<sup>2</sup> (42.33%)

89.33m<sup>2</sup> (61.21%)

R1

PROPOSED

m / m<sup>2</sup> / %

unchanged

unchanged

0.54 : 1 (186.82m<sup>2</sup>)

108.41m<sup>2</sup> (31.45%)

54.61m<sup>2</sup> (50.37%)

unchanged

unchanged

S: unchanged

86.77m<sup>2</sup>

0.00m

E: 0.20m

R1

n/a

n/a

n/a

n/a

n/a

n/a

n/a

n/a

m: 0426 957 518 e: operations@actionplans.com.au w: www.actionplans.com.au

**DEVELOPMENT APPLICATION** 

NORTHERN BEACHS COUNCIL (MANLY)

LOT 25 SEC D DP 4449

PERMISSIBLE / REQUIRED

R1 – General residentia

0:6:1 (206.82m<sup>2</sup>)

344.7m<sup>2</sup>

 $m/m^2/\%$ 

7.62m

250m<sup>2</sup>

8.5m

Class 5

Not identified

55% of site (189.59m<sup>2</sup>)

Max. 25% of TOS (47.39m<sup>2</sup>)

35% of actual TOS

1/3 wall height

1/3 wall height

required: 2

Area OS3

18m<sup>2</sup>

6m

46 DAINTREY STREET, FAIRLIGHT, NSW 2094

DEVELOPMENT APPLICATION

These plans are for Development Approval only.



### THIS PLAN IS TO BE READ IN **CONJUNCTION WITH** THE CONDITIONS OF DEVELOPMENT CONSENT

## DADA2020/1177

COMPLIANCE

Yes

Yes

Yes

Yes

N/A

N/A

N/A

N/A

N/A

N/A

N/A

N/A

No

Yes

Yes

Yes


Yes

No

No


Yes

# 46 DAINTREY STREET FAIRLIGHT, NSW 2094

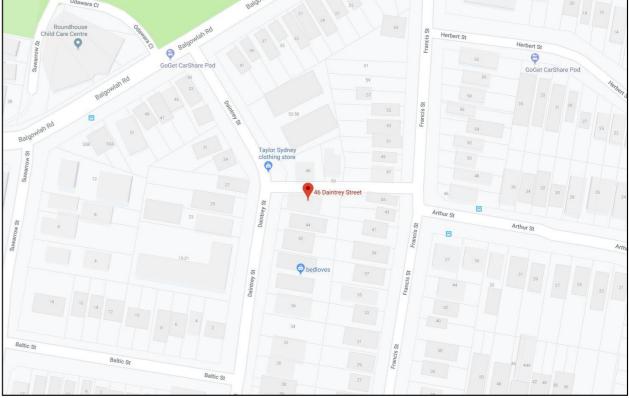


- EARTHWORKS: METHOD OF EXCAVATION AND FILL - PART 3.1.1 OF NCC - SURFACE SUBSOIL-STORMWATER DRAINAGE - PART 3.1.2 OF NCC - TERMITE-RISK MANAGEMENT - PART 3.1.3 OF NCC - FOOTINGS & SLAB - PART 3.2 OF NCC INCLUDING AS2870 - MASONRY CONSTRUCTION - PART 3.3 OF NCC INCLUDING AS3700 - SUB FLOOR VENTILATION - PART 3.4.1 OF NCC - FRAMING - PART 3.4 OF NCC - ROOF, WALL-CLADDING, GUTTERS & DOWNPIPES - PART 3.5 OF NCC - GLAZING - PART 3.6 OF NCC INCLUDING AS1288 - FIRE SEPARATION - PART 3.7.1 OF NCC - SMOKE ALARMS - PART 3.7.2 OF NCC - HEATING APPLIANCES - PART 3.7.3 OF NCC ROTECTION OF WALLS & FLOORS - PART 3.8.1 OF NCC - MINIMUM ROOF HEIGHTS - PART 3.8.3 OF NCC SANITARY DOOR CONSTRUCTION - PART 3.8.3 OF NCC LIGHT: NATURAL AND ARTIFICIAL - PART 3.8.4 OF NCC FILATION & LOCATION OF TOILETS - PART 3.8.5 OF NCC - SOUND INSULATION - PART 3.8.6 OF NCC RUCTION INCLUDING DIMENSIONS - PART 3.9.1 OF NCC ALUSTRADES & OTHER BARRIERS - PART 3.9.2 OF NCC - FENCING & OTHER PROVISIONS - REGS & AS1926 RKS - AS2601-1991 THE DEMOLITION OF STRUCTURES. OF MEMBRANES TO COMPLY WITH WITH AS 3740-2004 JMBING & DRAINAGE WORK TO COMPLY WITH AS 3500 - SITE CLASSIFICATION AS TO AS 2870 PLASTERBOARD WORK TO COMPLY WITH AS 2588-1998 RAL STEEL WORK TO COMPLY WITH AS 4100 & AS 1554 - ALL CONCRETE WORK TO COMPLY WITH AS 3600 OOF SHEETING WORK TO COMPLY WITH AS 1562-1992 ALL SKYLIGHTS TO COMPLY WITH WITH AS 4285-2007 TILING TO COMPLY WITH AS 3958.1-2007 & 3958.2-1992 GLAZING ASSEMBLIES TO COMPLY WITH AS2047 & 1288 TAINING WALLS ARE TO COMPLY WITH AS 1720.1-2010, 2-2006, AS 1720.4-2006, AS 1170.1-1989 & AS 1170.4-1993 ALLS ARE TO COMPLY WITH 3700 - 2011 & AS 3600 -2001 - ALL CONSTRUCTION TO COMPLY TO AS3959- 1991

- WET AREAS-PR	DATE PUBLISHED	SHEET NAME
	8/09/2020	COVER
- FACILITIES REQUIRRED & S/	8/09/2020	SITE ANALYSIS
- VENTII	8/09/2020	SITE / ROOF / SEDIMENT EROSION / WASTE MANAGEMENT / STORMWATER CONCEPT PLAN
	8/09/2020	EXISTING GROUND FLOOR PLAN
- STAIR CONSTRU	8/09/2020	EXISTING FIRST FLOOR PLAN
- BAL	8/09/2020	PROPOSED LOWER GROUND FLOOR PLAN
- DEMOLITION WORK	8/09/2020	PROPOSED GROUND FLOOR PLAN
- ALL WATERPROO	8/09/2020	PROPOSED FIRST FLOOR PLAN
- ALL PLUN	8/09/2020	NORTH / EAST ELEVATION
- ALL PL	8/09/2020	SOUTH / WEST ELEVATION
- ALL STRUCTURA	8/09/2020	WEST ELEVATION - HOUSE
	8/09/2020	LONG / CROSS SECTION
- ALL RO	8/09/2020	AREA CALCULATIONS / SAMPLE BOARD / EXTERNAL WINDOW & DOOR SCHEDULE
/ - ALL CERAMIC T -	8/09/2020	SHADOW DIAGRAM - WINTER SOLSTICE 9AM
- ALL GL	8/09/2020	SHADOW DIAGRAM - WINTER SOLSTICE 12PM
- ALL TIMBER RET	8/09/2020	SHADOW DIAGRAM - WINTER SOLSTICE 3PM
AS 1720.2-2	8/09/2020	DRIVEWAY PLAN AND SECTION
- ALL RETAINING WAL	8/09/2020	BASIX COMMITMENTS

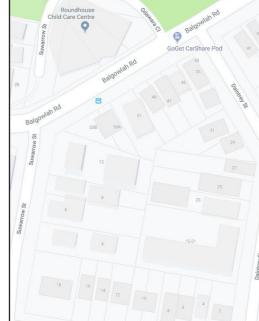

LOCATION VIEW


### **NCC & AS COMPLIANCES SPECIFICATIONS**

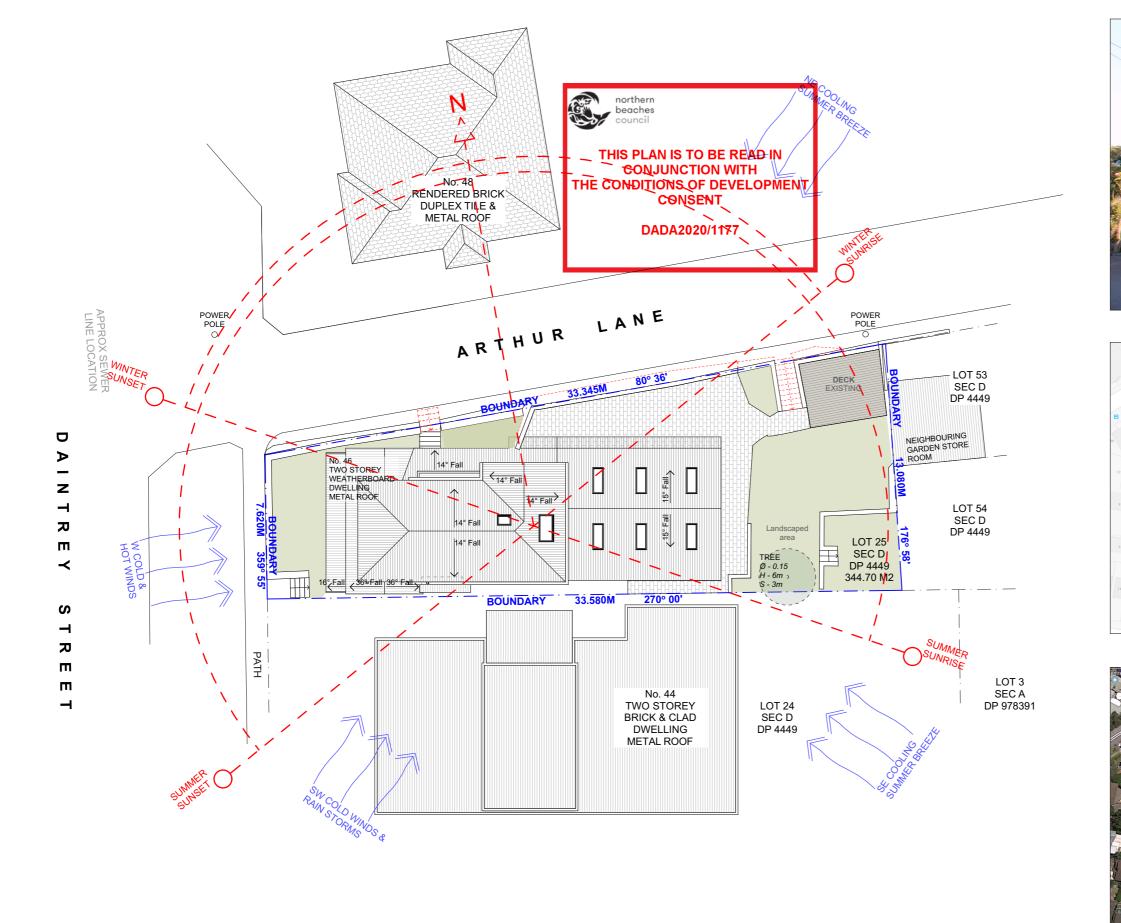

# SITE ANALYSIS

1:200

### NOTE: ALL DEMOLISHED ELEMENTS TO ENG. SPECIFICATIONS AND AS. 2601 - 2001

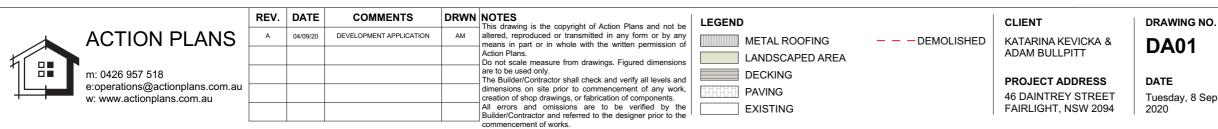



EXTERNAL VIEW






DRAWING NAME SITE ANALYSIS


SCALE 1:200 @A3



Tuesday, 8 September

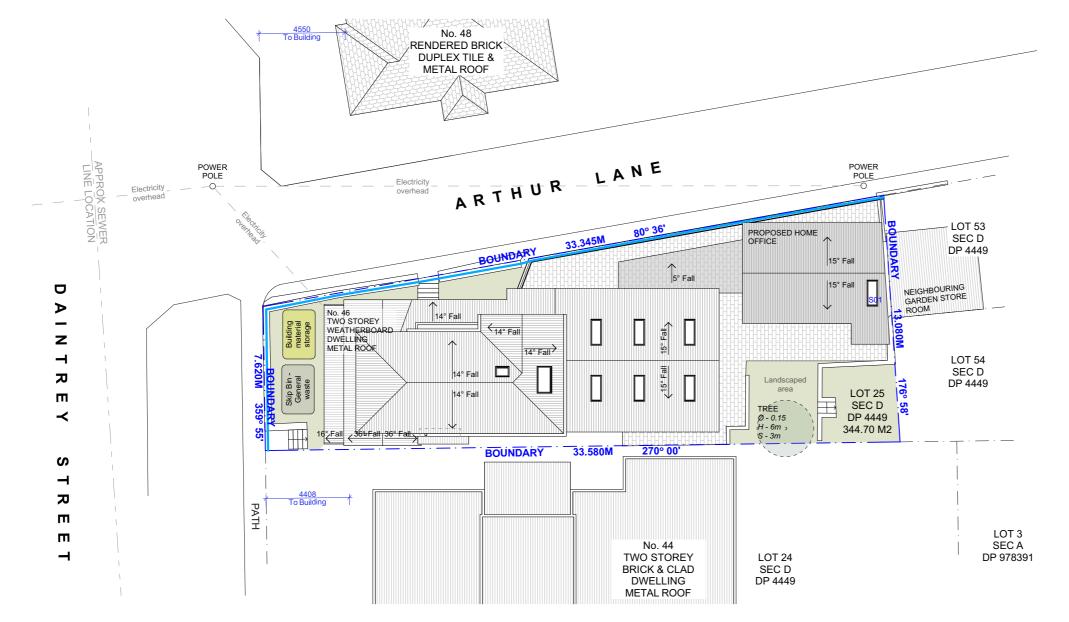

SITE / ROOF / SEDIMENT EROSION / WASTE MANAGEMENT / STORMWATER CONCEPT PLAN 1:200

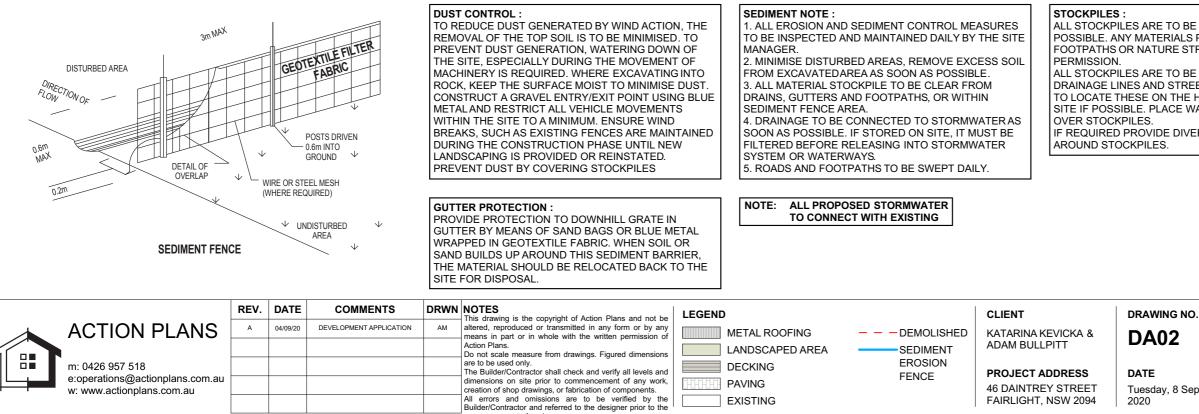

nmencement of works.



### THIS PLAN IS TO BE READ IN **CONJUNCTION WITH** THE CONDITIONS OF DEVELOPMENT CONSENT

DADA2020/1177

ALL STOCKPILES ARE TO BE KEPT ON-SITE WHERE POSSIBLE. ANY MATERIALS PLACED ON THE FOOTPATHS OR NATURE STRIPS REQUIRE COUNCIL'S

ALL STOCKPILES ARE TO BE PLACED AWAY FROM THE DRAINAGE LINES AND STREET GUTTERS. IT IS BEST TO LOCATE THESE ON THE HIGHEST PART OF THE SITE IF POSSIBLE. PLACE WATERPROOF COVERING


IF REQUIRED PROVIDE DIVERSION DRAIN & BANK

### DRAWING NAME

SITE / ROOF / SEDIMENT EROSION / WASTE MANAGEMENT / STORMWATER CONCEPT PLAN SCALE


Tuesday, 8 September

1:200 @A3

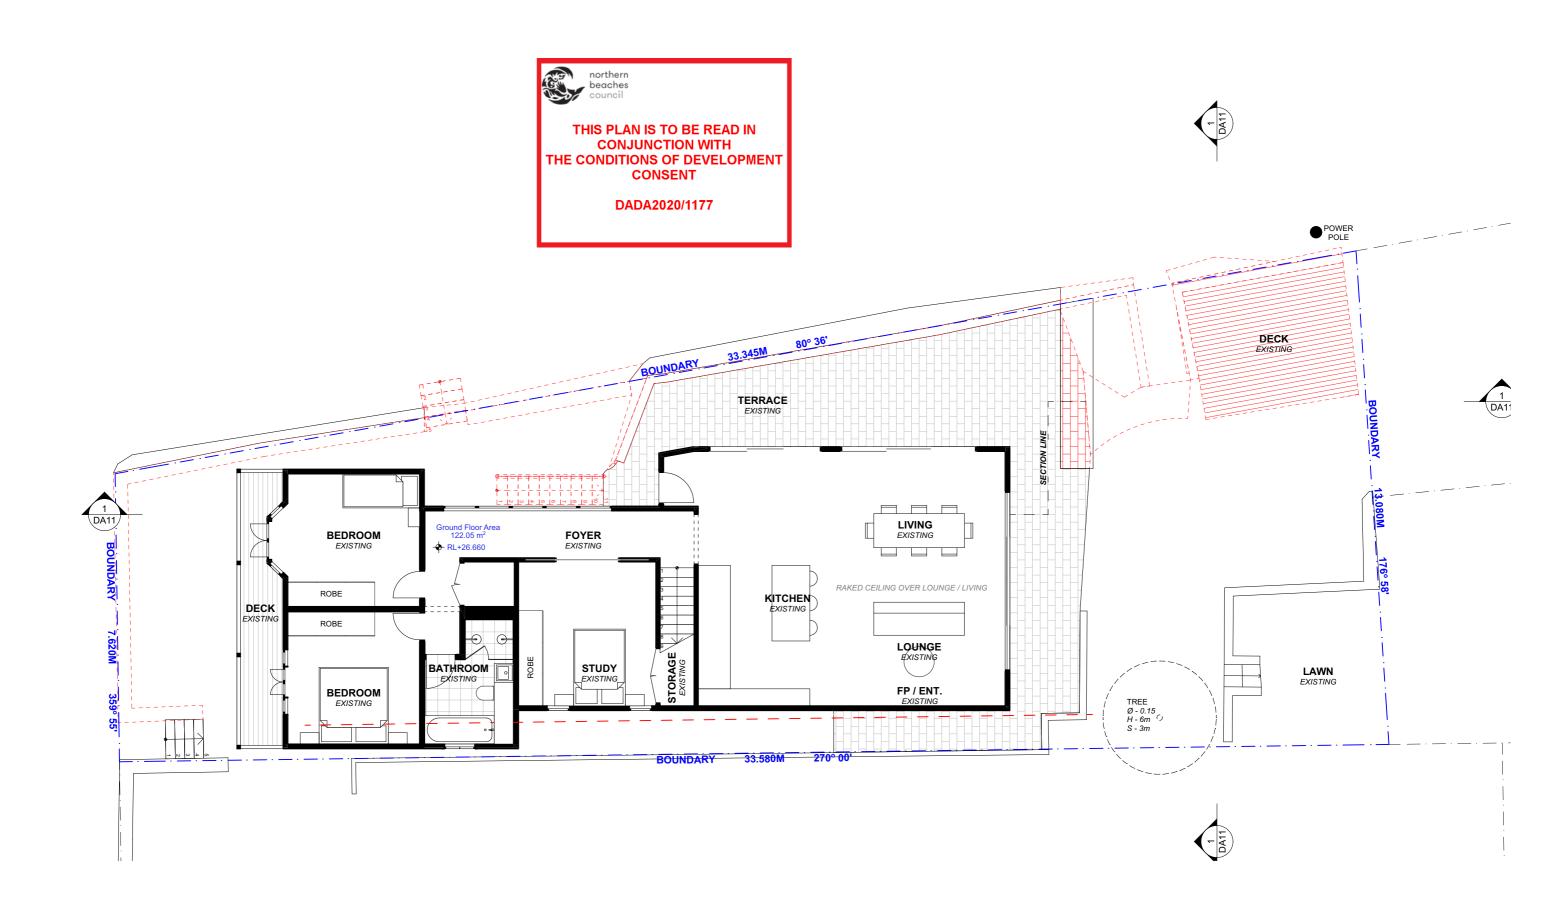

# **EXISTING GROUND FLOOR PLAN**


1:100

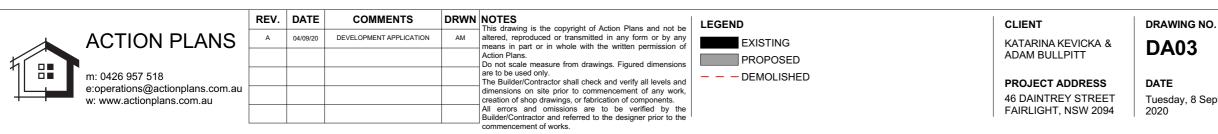


### NOTE: ALL DEMOLISHED ELEMENTS TO ENG. SPECIFICATIONS AND AS. 2601 - 2001

### DRAWING NAME

EXISTING GROUND FLOOR PLAN

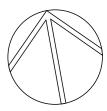


Tuesday, 8 September

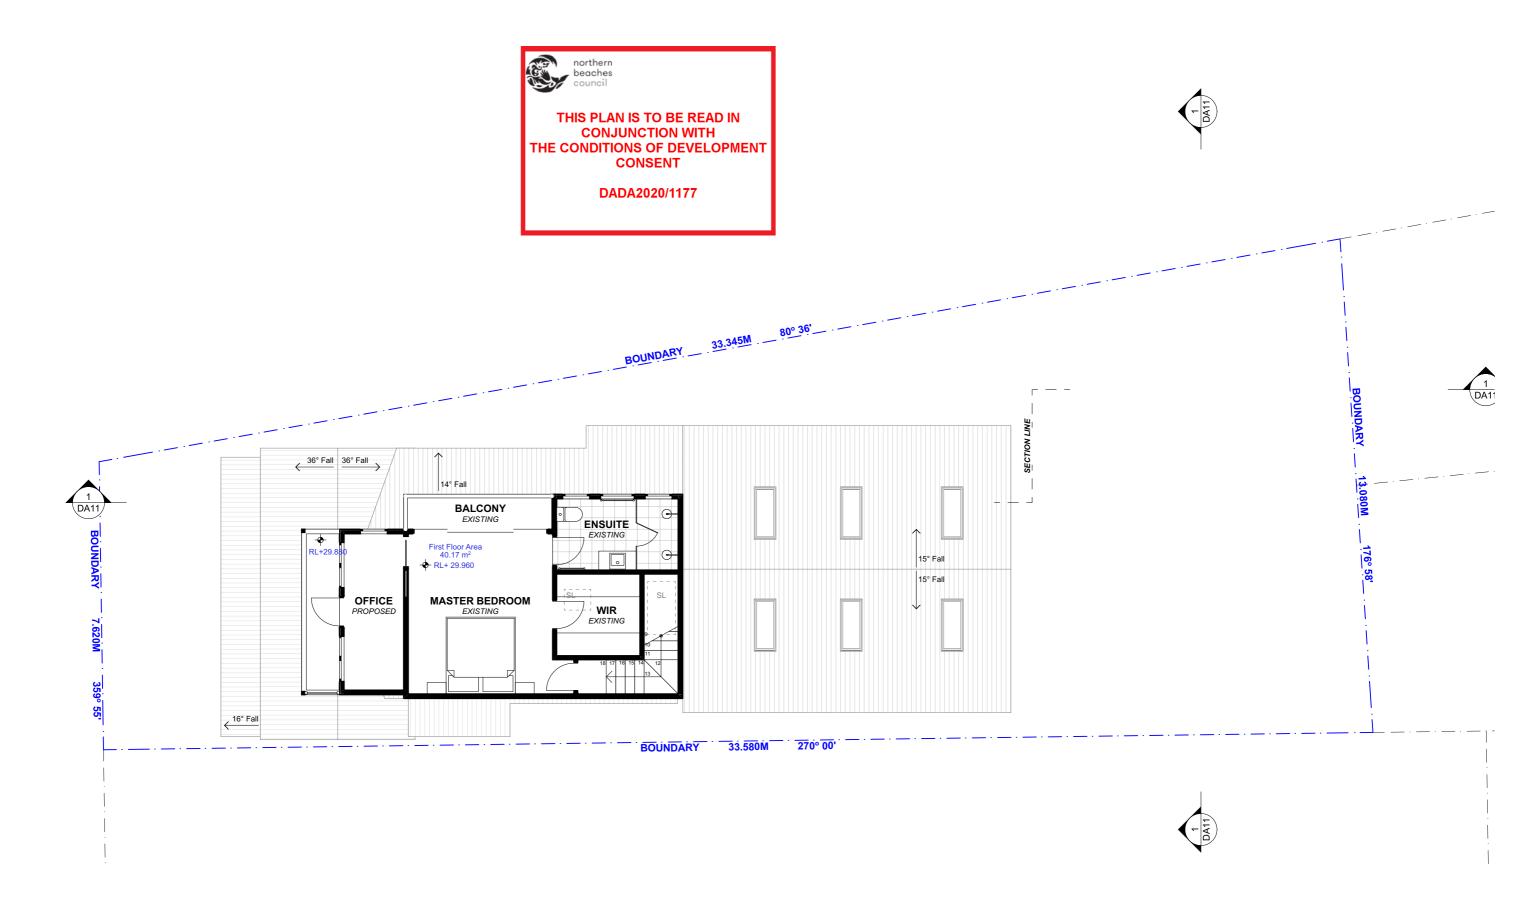


# **EXISTING FIRST FLOOR PLAN**

1:100

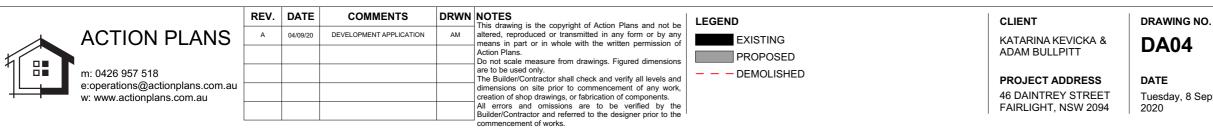



NOTE: NO PROPOSED CHANGES TO THE EXISTING FIRST FLOOR PLAN

DRAWING NAME EXISTING FIRST FLOOR PLAN

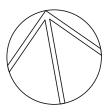

Tuesday, 8 September

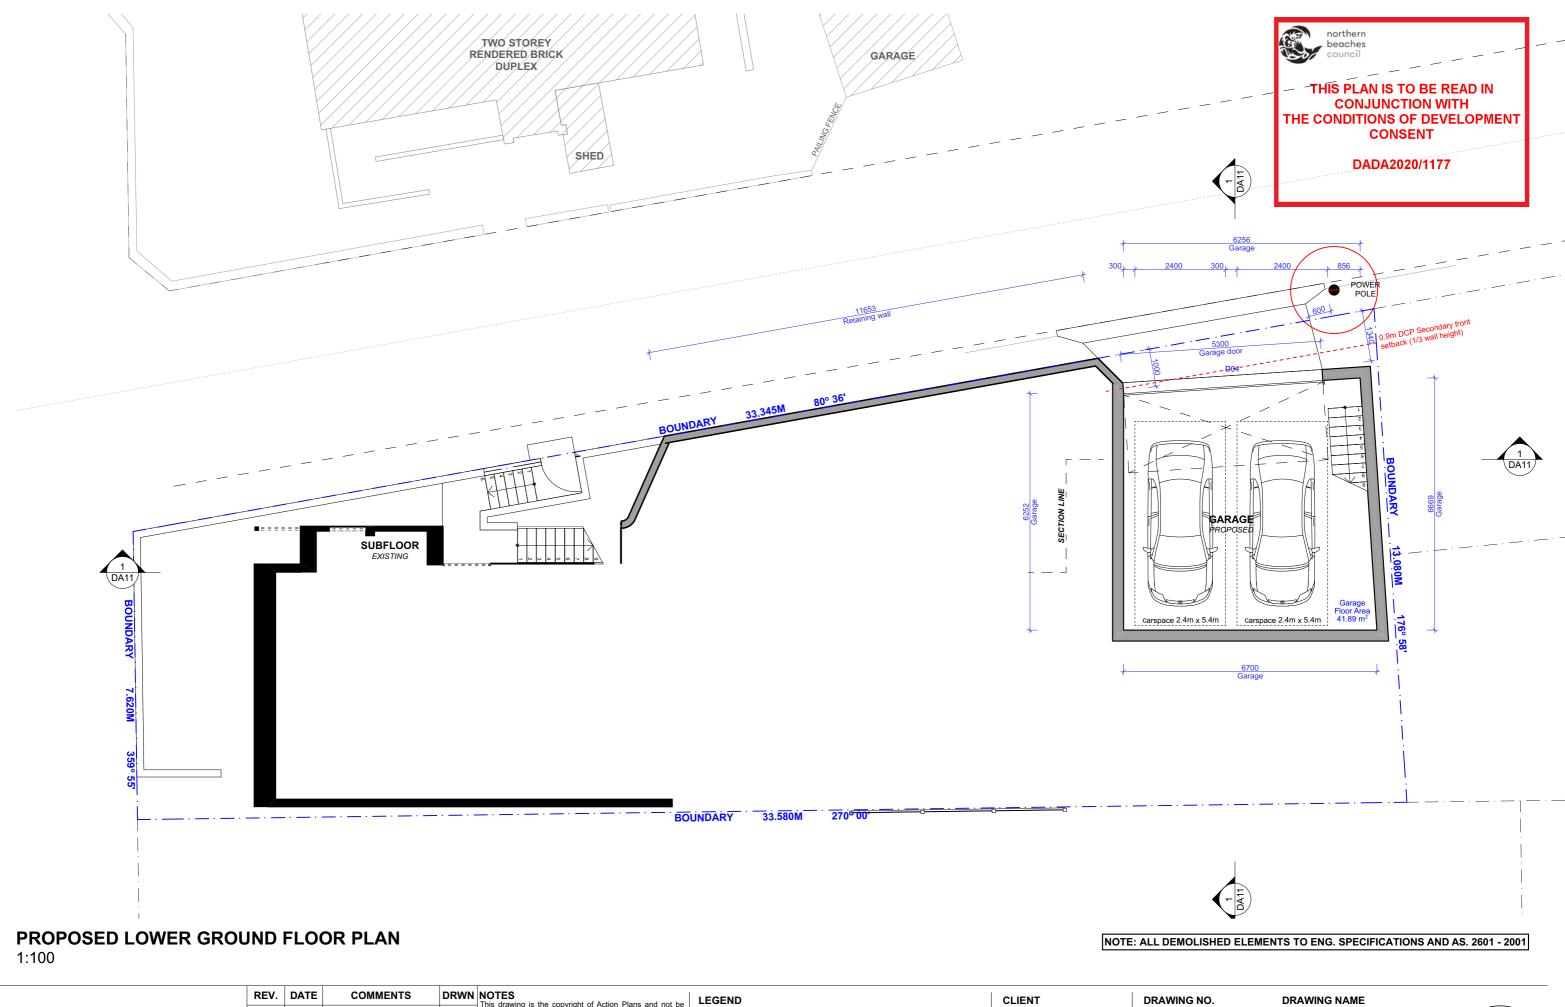


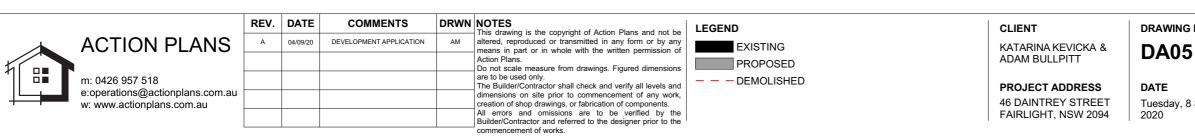

PROPOSED LOWER GROUND FLOOR PLAN




Tuesday, 8 September

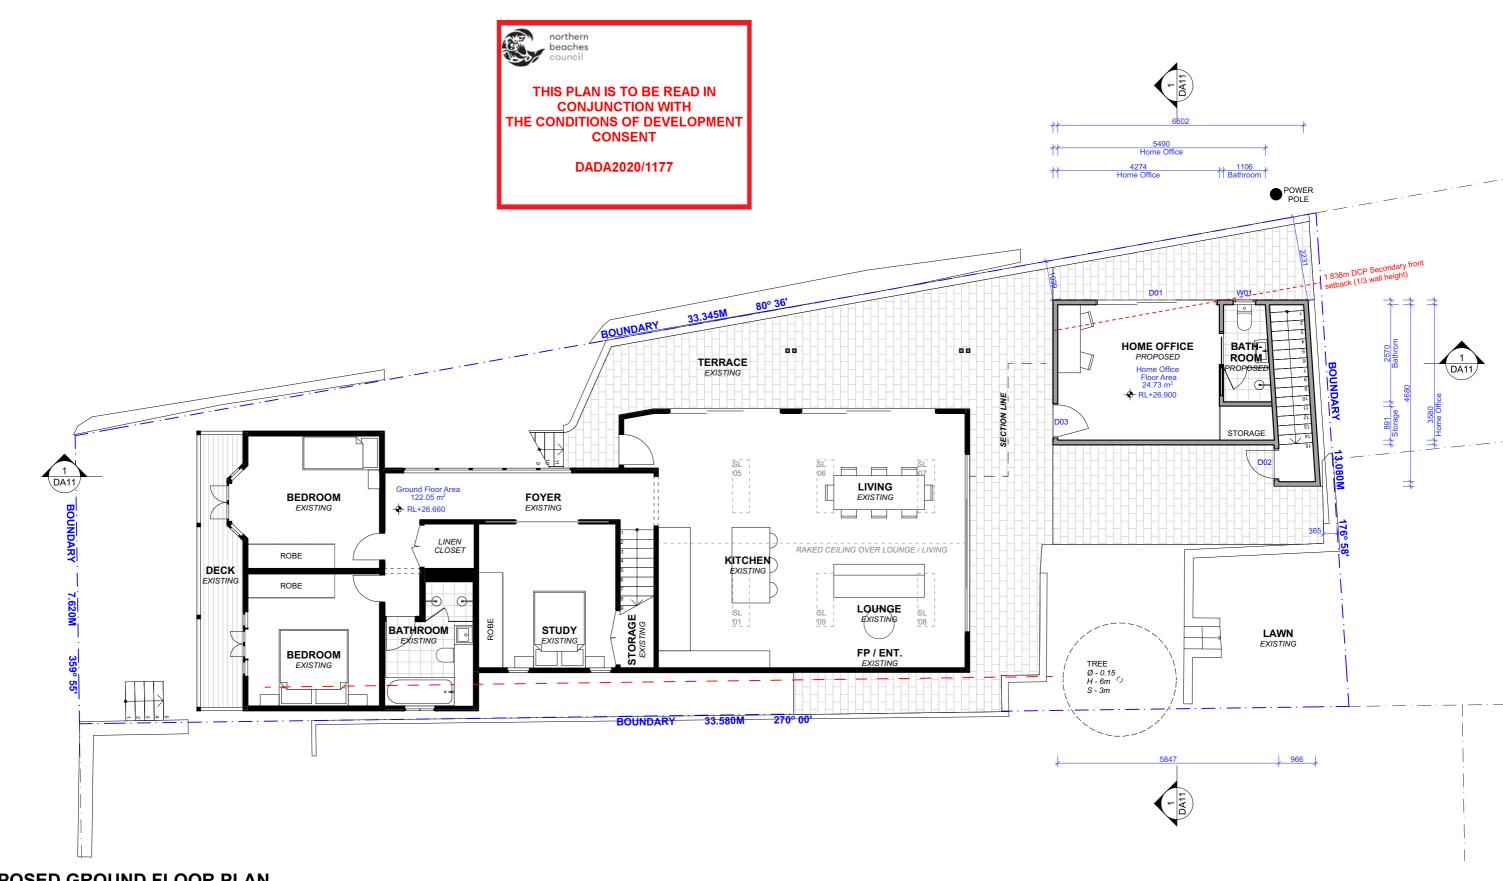

# **PROPOSED GROUND FLOOR PLAN**


1:100

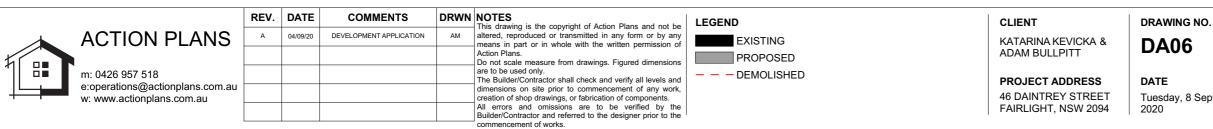

### DRAWING NAME


PROPOSED GROUND FLOOR PLAN

Tuesday, 8 September

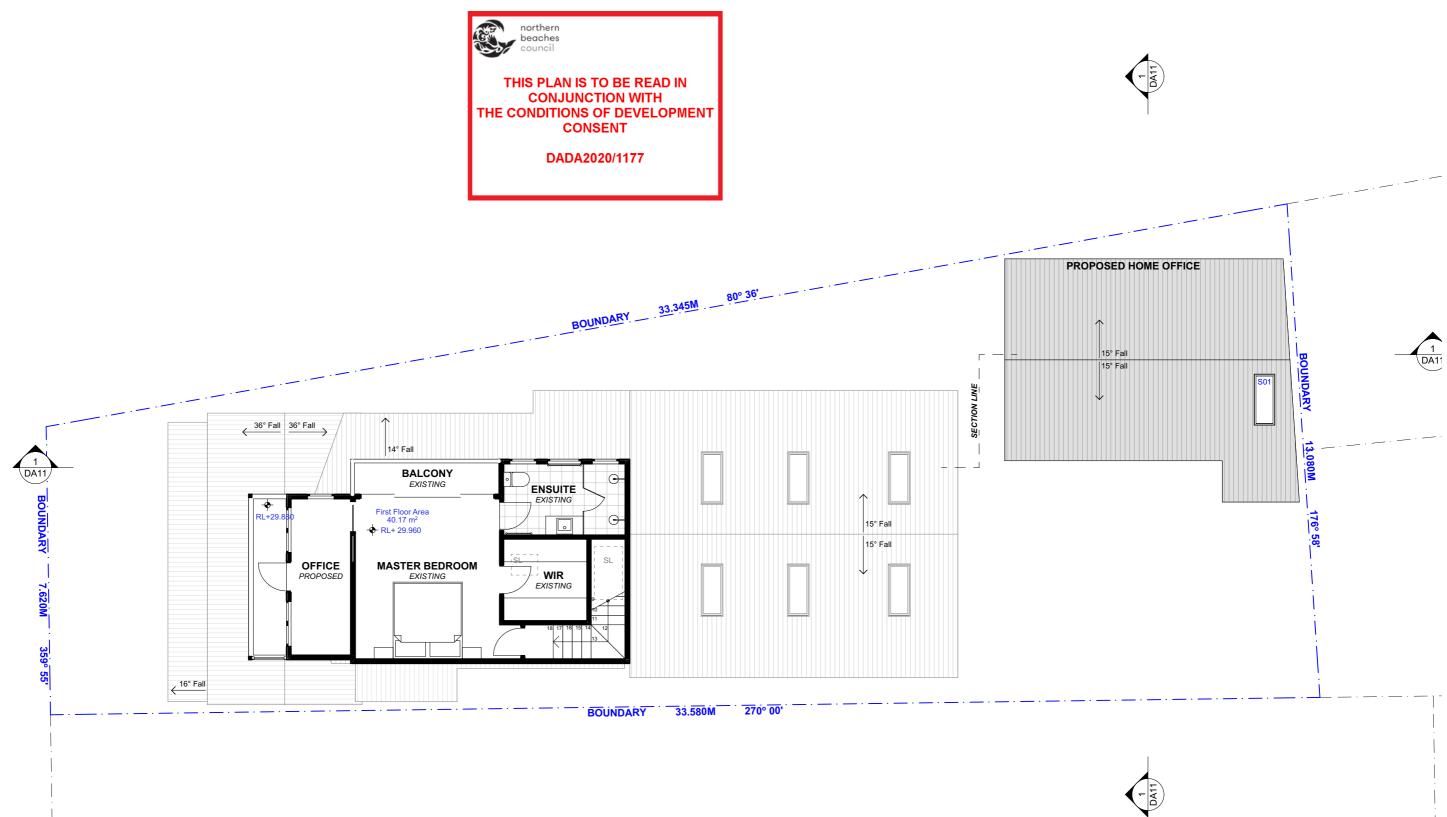

# **PROPOSED FIRST FLOOR PLAN**

1:100

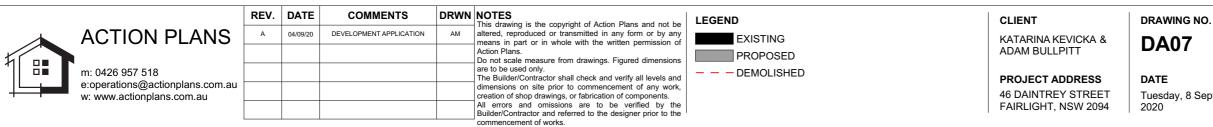




### NOTE: NO PROPOSED CHANGES TO THE EXISTING FIRST FLOOR PLAN

### DRAWING NAME


PROPOSED FIRST FLOOR PLAN

Tuesday, 8 September

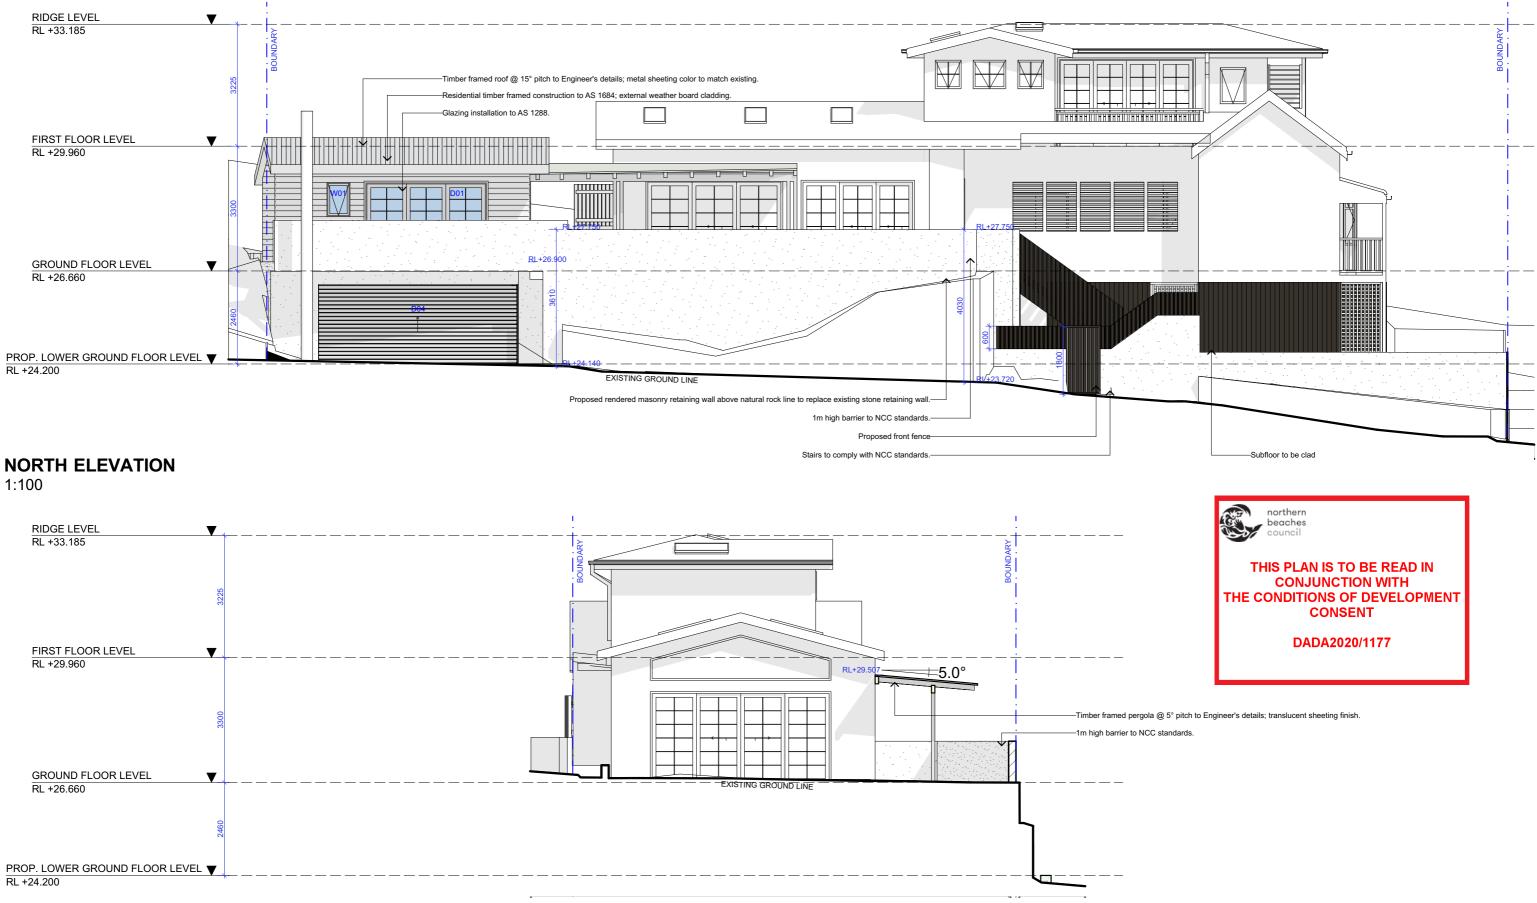


# **EAST ELEVATION**

# 1:100

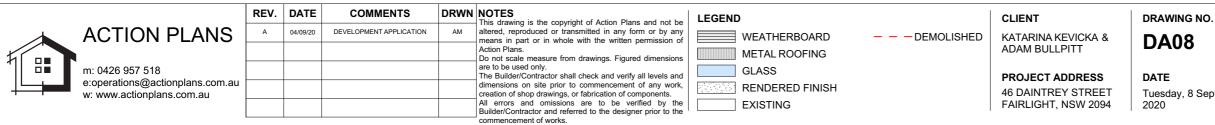


DRAWING NAME NORTH / EAST ELEVATION

Tuesday, 8 September

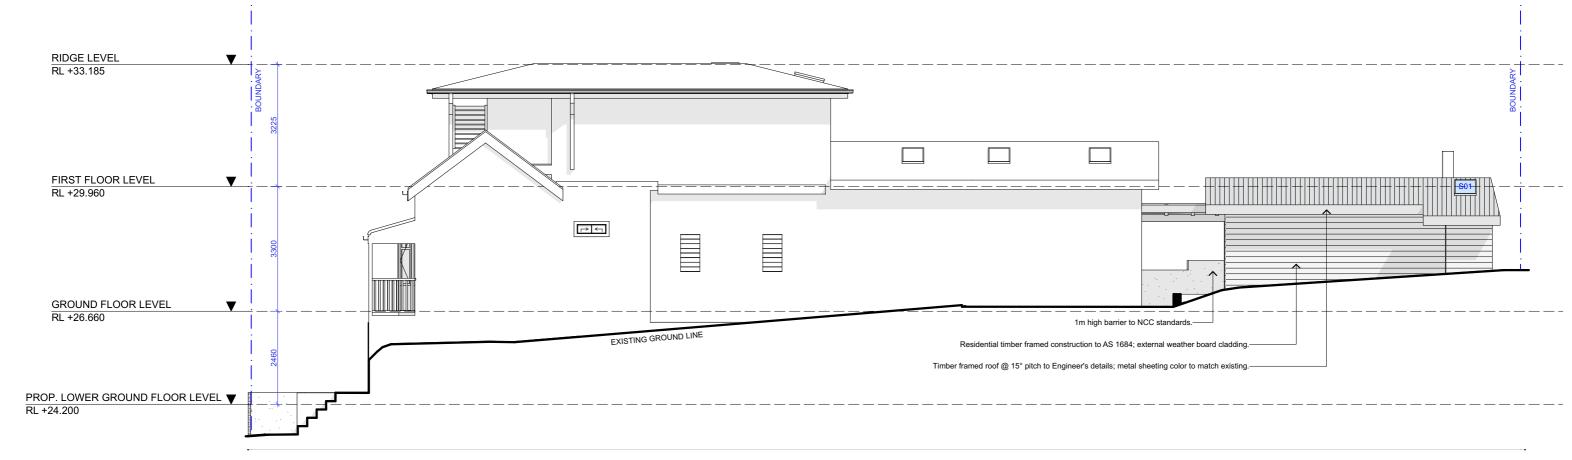

SOUTH ELEVATION

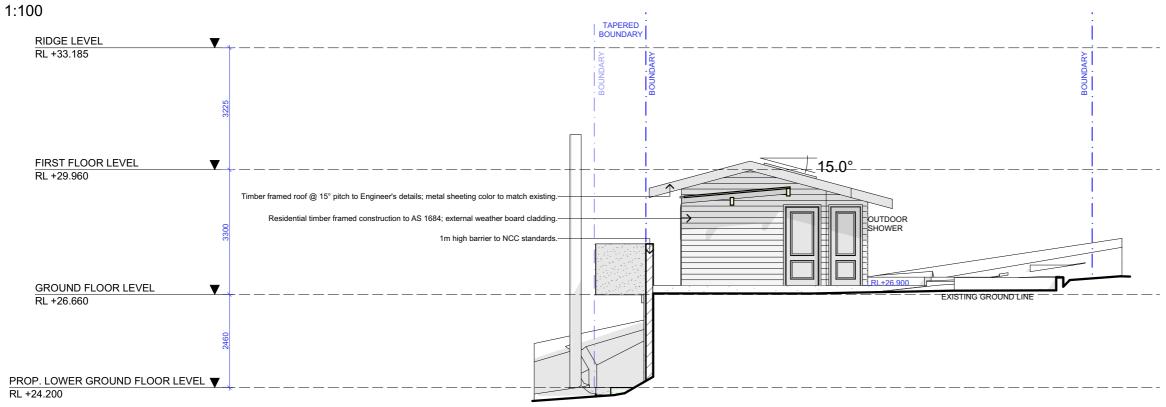

# WEST ELEVATION

1:100


A 04/09/20 DEVELOPMENT APPLICATION AM This drawing is the copyright of Action Plans and not be altered, reproduced or transmitted in any form or by any means in part or in whole with the written permission of WEATHERBOARDDEMOL		G NO
	HED KATARINA KEVICKA & DA09	0
Action Plans. Do not scale measure from drawings. Figured dimensions METAL ROOFING	ADAM BULLPITT DAUS	9
□■ m: 0426 957 518 The Builder/Contractor shall check and verify all levels and GLASS	PROJECT ADDRESS DATE	
e:operations@actionplans.com.au dimensions on site prior to commencement of any work, creation of shop drawings, or fabrication of components.	46 DAINTREY STREET Tuesday, 8	8 Se
All errors and omissions are to be verified by the Builder/Contractor and referred to the designer prior to the EXISTING	FAIRLIGHT, NSW 2094 2020	



VING NO.

DRAWING NAME SOUTH / WEST ELEVATION

SCALE 1:100 @A3 ay, 8 September

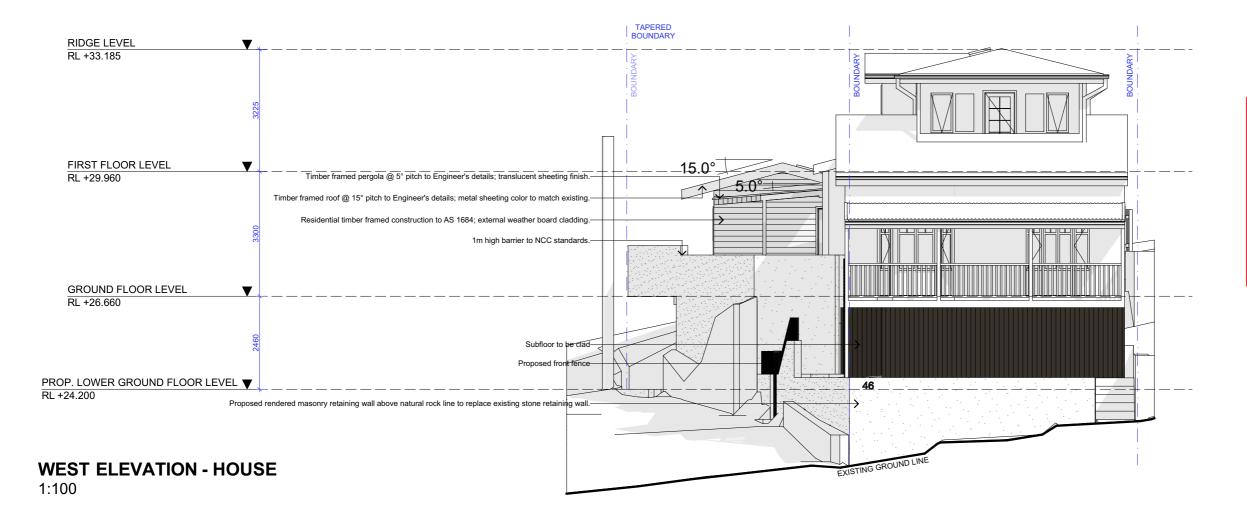

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1	m: 0426 957 518					are to be used only. The Builder/Contractor shall check and verify all levels and	GLASS	PROJECT ADDRESS	DATE
+	e:operations@actionplans.com.au w: www.actionplans.com.au					dimensions on site prior to commencement of any work, creation of shop drawings, or fabrication of components.	RENDERED FINISH	46 DAINTREY STREET	Tuesday, 8
						All errors and omissions are to be verified by the Builder/Contractor and referred to the designer prior to the	EXISTING	FAIRLIGHT, NSW 2094	2020
						commencement of works.			



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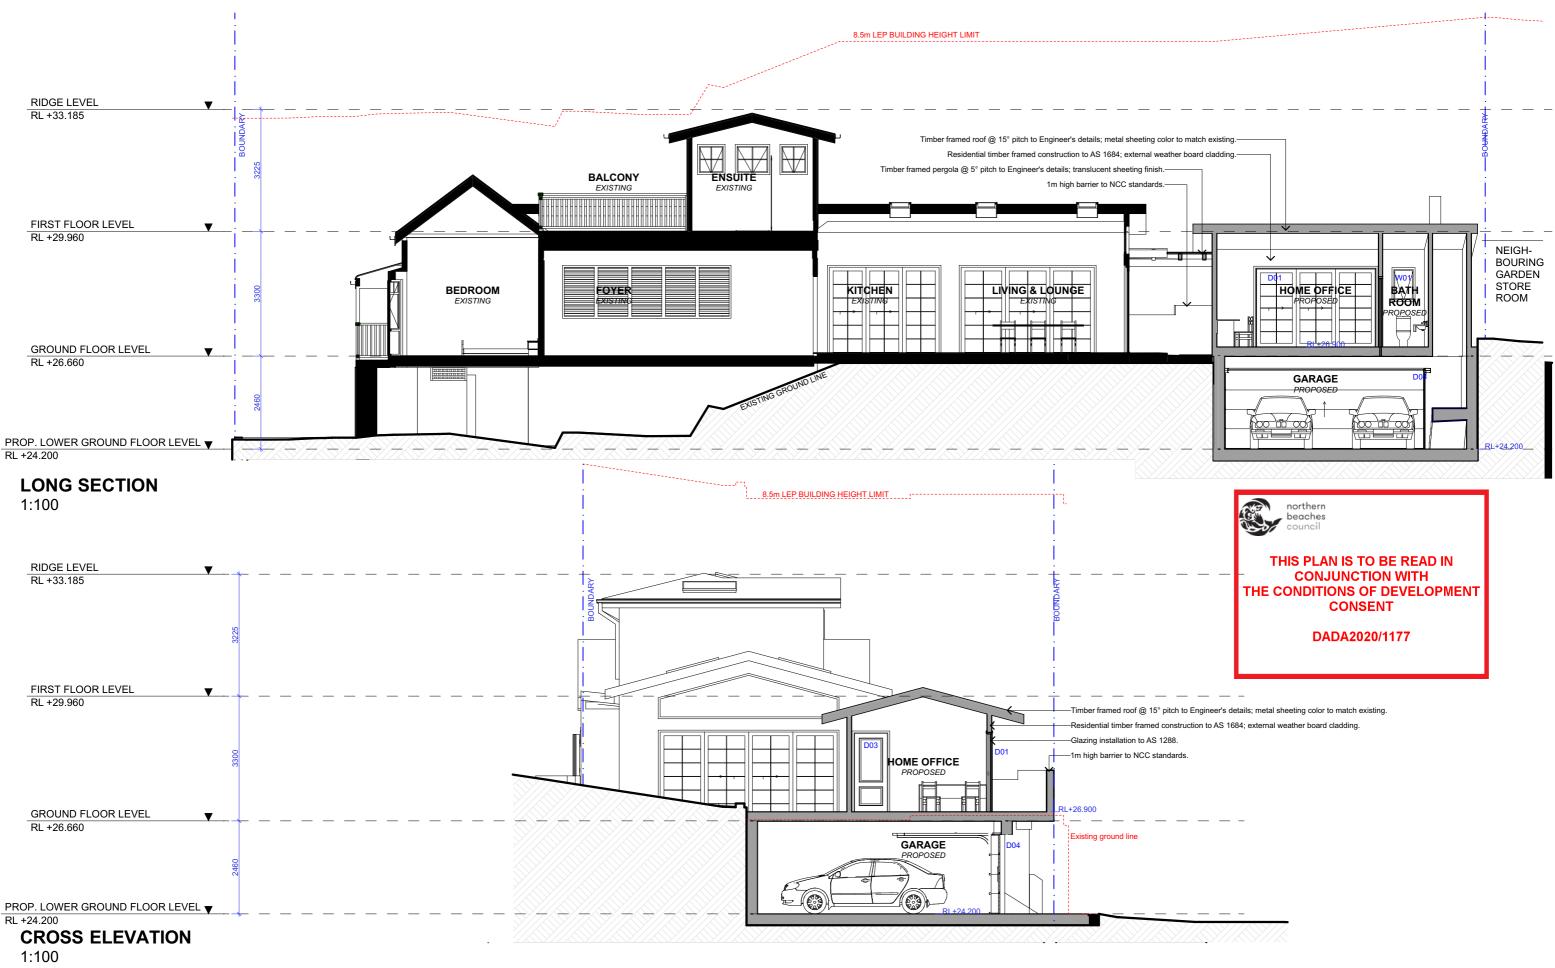
# DADA2020/1177

VING NO.

DRAWING NAME WEST ELEVATION - HOUSE

ay, 8 September


SCALE @A3



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					Action Plans. Do not scale measure from drawings. Figured dimensions	PROPOSED	ADAM BULLPITT	DAII
	m: 0426 957 518 e:operations@actionplans.com.au				are to be used only. The Builder/Contractor shall check and verify all levels and dimensions on site prior to commencement of any work.	DEMOLISHED	PROJECT ADDRESS	DATE
+	w: www.actionplans.com.au				creation of shop drawings, or fabrication of components. All errors and omissions are to be verified by the Builder/Contractor and referred to the designer prior to the		46 DAINTREY STREET FAIRLIGHT, NSW 2094	Tuesday, 8 2020
					commencement of works			

IG NO. 1

DRAWING NAME LONG / CROSS SECTION

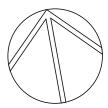


, 8 September


# **AREA CALCULATIONS CONTROLS**

SITE AREA: 344.7m<sup>2</sup>

Maximum Gross floor area: 0.6:1 (206.82m<sup>2</sup>) Minimum Total open space: 55% of the site area (189.59m<sup>2</sup>) Minimum Landscaped area: 35% of the actual total open space Private open space: 18m<sup>2</sup>

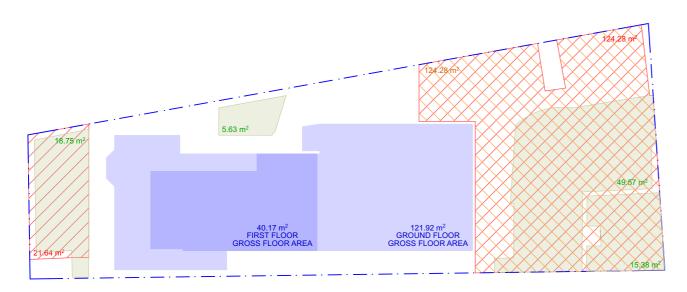

# **EXISTING GROUND FLOOR AREA**

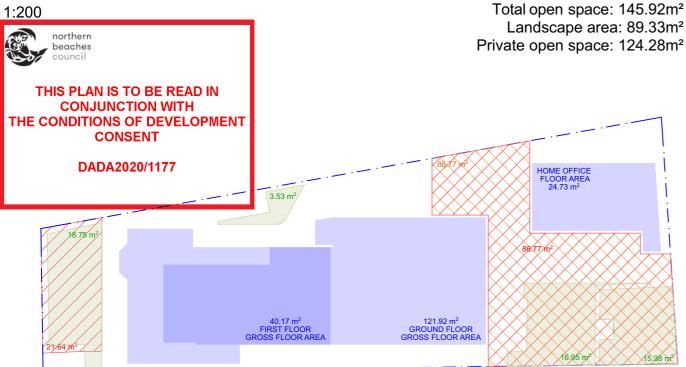

## **PROPOSED GROUND FLOOR AREA** 1:200

w: www.actionplans.com.au

Gross floor area: 186.82m<sup>2</sup> Total open space: 108.41m<sup>2</sup> dscape area: 54.61m<sup>2</sup> open space: 86.77m<sup>2</sup>

creation of shop drawings, or fabrication of components. All errors and omissions are to be verified by the Builder/Contractor and referred to the designer prior to the

encement of works.

LEGEND


TOTAL OPEN SPACE

PRIVATE OPEN SPACE

Gross floor area: 162.09m<sup>2</sup>

					Landscape area: 54.61m <sup>2</sup> Private open space: 86.77m <sup>2</sup>
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					Action Plans. Do not scale measure from drawings. Figured dimensions
m: 0426 957 518					are to be used only. The Builder/Contractor shall check and verify all levels and
e:operations@actionplans.com.au					dimensions on site prior to commencement of any work,

SAMPLE BOARD

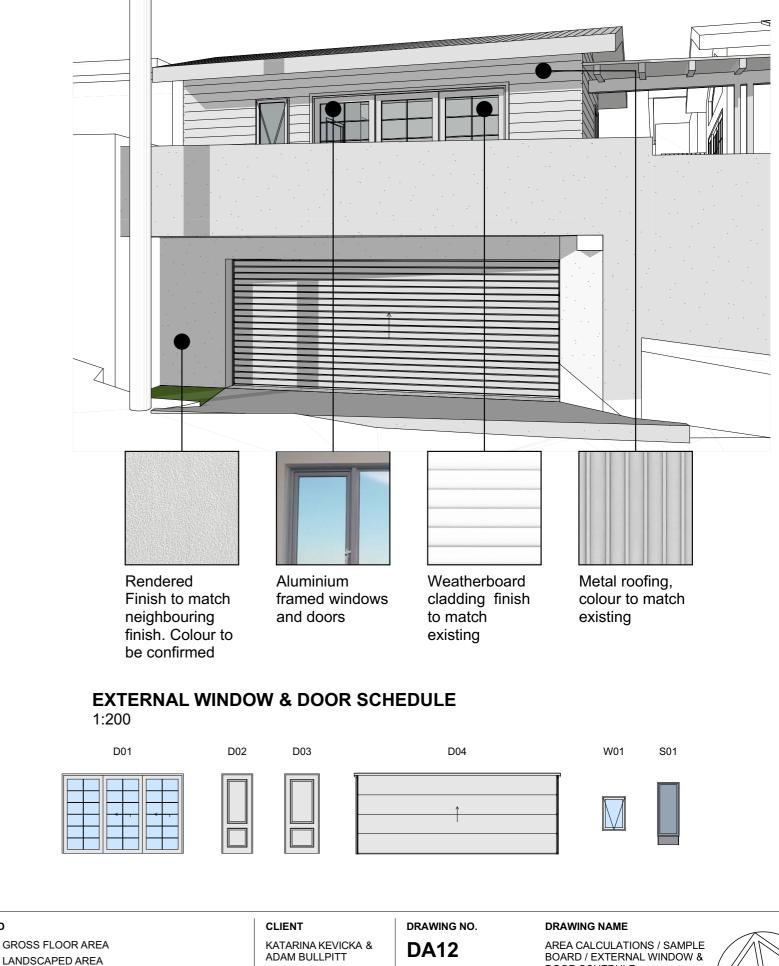



	DRAWI
Α&	

PIII	
DDRESS	DATE
Y STREET	Tuesda
NSW 2094	2020


PROJECT ADDRESS
46 DAINTREY STREET
FAIRLIGHT, NSW 2094

uesday, 8 September

1:200, 1:100 @A3

SCALE

DOOR SCHEDULE

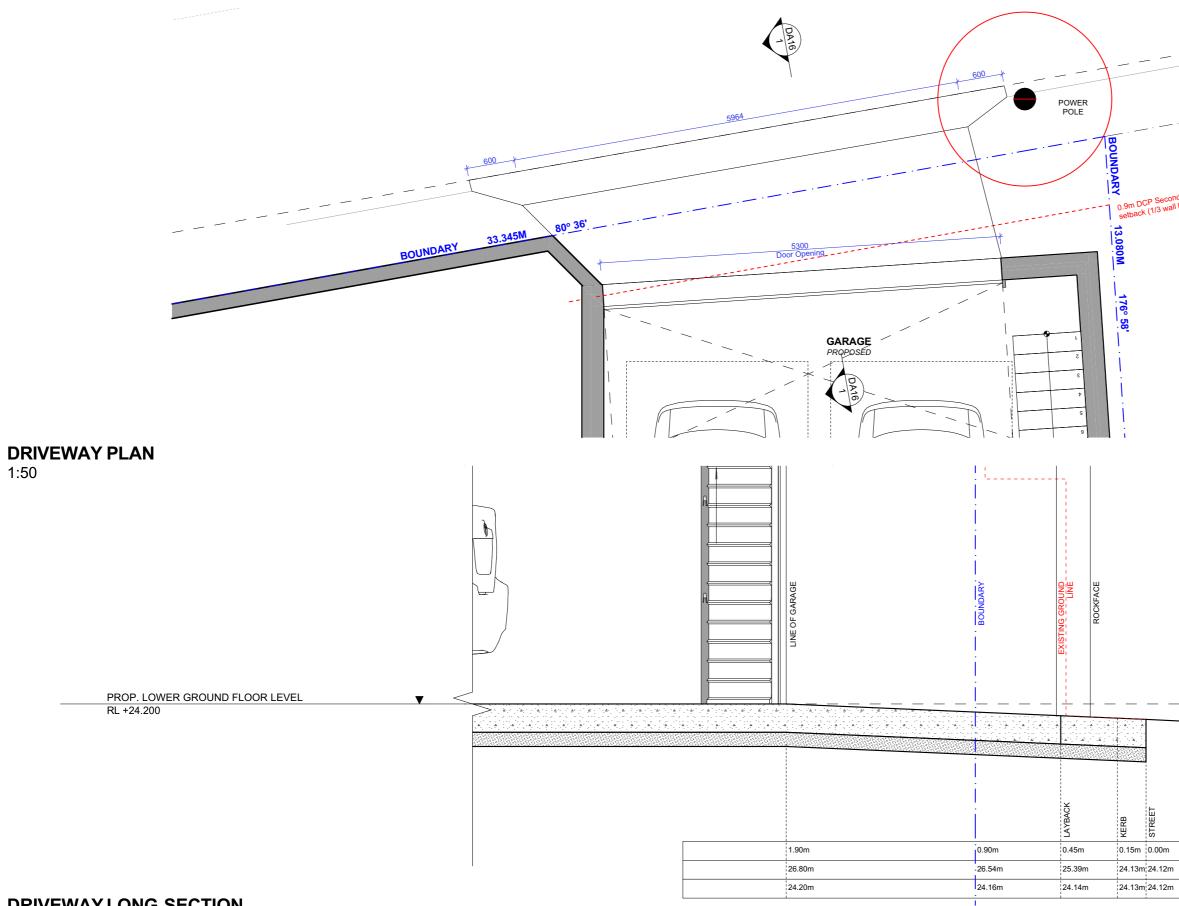

# **DRIVEWAY LONG SECTION**

# 1:20

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m: 0426 957 518					Action Plans. Do not scale measure from drawings. Figured dimensions are to be used only. The Builder/Contractor shall check and verify all levels and dimensions on site prior to commencement of any work, creation of shop drawings, or fabrication of components.		ADAM BULLPITT	
e:operations@actionplans.com.au							PROJECT ADDRESS 46 DAINTREY STREET	DATE Tuesday, 8 Se
· · w. www.actionplans.com.au					All errors and omissions are to be verified by the Builder/Contractor and referred to the designer prior to the		FAIRLIGHT, NSW 2094	2020



EXISTING ROAD LINE

ı	CHAINAGE
m	EXISTING GROUND LEVEL
m	PROPOSED DRIVEWAY LEVEL

IG NO.

DRAWING NAME DRIVEWAY PLAN AND SECTION

, 8 September

SCALE 1:50, 1:20 @A3