

ACTION PLANS

m: 0426 957 518

e: operations@actionplans.com.au

w: www.actionplans.com.au

DEVELOPMENT APPLICATION

These plans are for Development Approval only.

SHEET NUMBER	SHEET NAME	DATE PUBLISHED
DA00	COVER	4/12/2020
DA01	SITE ANALYSIS	4/12/2020
DA02	SITE / ROOF / SEDIMENT EROSION / WASTE MANAGEMENT / STORMWATER CONCEPT PLAN	4/12/2020
DA03	PREVIOUSLY APPROVED GROUND FLOOR PLAN	4/12/2020
DA04	PREVIOUSLY APPROVED FIRST FLOOR PLAN	4/12/2020
DA05	PROPOSED GROUND FLOOR PLAN	4/12/2020
DA06	PROPOSED FIRST FLOOR PLAN	4/12/2020
DA07	NORTH / EAST ELEVATION	4/12/2020
DA08	SOUTH / WEST ELEVATION	4/12/2020
DA09	LONG / CROSS SECTION	4/12/2020
DA10	AREA CALCULATIONS / SAMPLE BOARD	4/12/2020
DA11	WINTER SOLSTICE 9 AM	4/12/2020
DA12	WINTER SOLSTICE 12 PM	4/12/2020
DA13	WINTER SOLSTICE 3 PM	4/12/2020


ITEM DETAILS	DEV	ELOPMENT APPLIC	CATION		
ADDRESS	13 VISTA AVENUE, BALGOWLAH HEIGHTS, NSW, 2093				
LOT & DP/SP	LOT	7 DP 20346			
COUNCIL	NOR	THERN BEACHES COU	NCIL (MANLY)		
SITE AREA	619.6	7m²			
FRONTAGE	15.24	m			
CONTROLS	PERMISSIBLE / REQUIRED		EXISTING	PROPOSED	COMPLIANCE
	m / m² / %		m / m² / %	m / m² / %	
<u>LEP</u>					
LAND ZONING	R2 – LOW DENSITY RESID	ENTIAL	R2	UNCHANGED	YES
MINIMUM LOT SIZE	750m²		619.67m ²	UNCHANGED	NO
FLOOR SPACE RATIO	0:4 : 1 (247.868m²)		0.40 : 1 (270.04m²)	UNCHANGED	NO
MAXIMUM BUILDING HEIGHT	8.5m		8.35m	UNCHANGED	YES
<u>HAZARDS</u>					
FORESHORE SCENIC PRO. AREA	YES				
<u>DCP</u>					
RESIDENTIAL OPEN SPACE	AREA OS4				
TOTAL OPEN SPACE (TOS)	60% (371.8m²)		59% (366.82m²)	57% (351.62m²)	NO
LANDSCAPE AREA	40% OF TOS (60%): 148.72	m ²	57%: 213.78m ²	53%: 198.58m ²	YES
PRINCIPAL PRIVATE OPEN SPACE	18m²		124.67	UNCHANGED	YES
FRONT SETBACK	PREVALING BULDING LINE OR 6m		7.590m	UNCHANGED	YES
REAR SETBACK	8.0m		8.654m	UNCHANGED	YES
SIDE SETBACKS	1/3 WALL HEIGHT		N: 1.415m S: 1.072m	UNCHANGED 0.052m	YES NO
CAR PARKING SPACES	Required: 1		2	UNCHANGED	YES


13 VISTA AVENUE, BALGOWLAH HEIGHTS, NSW 2093



NCC & AS COMPLIANCES SPECIFICATIONS

- EARTHWORKS PART 3.1.1 OF NCC
- EARTH RETAINING STRUCTURES PART 3.1.2 OF NCC
- DRAINAGE PART 3.1.3 OF NCC
- TERMITE-RISK MANAGEMENT PART 3.1.4 OF NCC
- FOOTINGS & SLAB PART 3.2 OF NCC INCLUDING AS2870
- MASONRY PART 3.3 OF NCC INCLUDING AS3700
- FRAMING PART 3.4 OF NCC
- SUB FLOOR VENTILATION PART 3.4.1 OF NCC
- ROOF CLADDING AND WALL-CLADDING PART 3.5 OF NCC
- GLAZING PART 3.6 OF NCC INCLUDING AS1288
- FIRE SAFETY PART 3.7 OF NCC
- FIRE SEPERATION PART 3.7.2 OF NCC
- FIRE PROTECTION OF SEPERATING WALLS AND FLOORS- PART 3.7.3 OF NCC
- SMOKE ALARMS PART 3.7.5 OF NCC
- WET AREAS AND EXTERNAL WATERPROOFING PART 3.8.1 OF NCC
- ROOM HEIGHTS PART 3.8.2 OF NCC
- FACILITIES PART 3.8.3 OF NCC
- LIGHT PART 3.8.4 OF NCC
- VENTILATION PART 3.8.5 OF NCC
- SOUND INSULATION PART 3.8.6 OF NCC
- STAIRWAYAND RAMP CONSTRUCTION PART 3.9.1 OF NCC
- BARRIERS AND HANDRAILS PART 3.9.2 OF NCC
- SWIMMING POOLS PART 3.10.1 OF NCC
- CONSTRUCTION IN BUSHFIRE PRONE AREAS PART 3.10.5 OF NCC
- FENCING & OTHER PROVISIONS REGS & AS1926
- DEMOLITION WORKS AS2601-1991 THE DEMOLITION OF STRUCTURES.
- ALL WATERPROOF MEMBRANES TO COMPLY WITH WITH AS 3740-2010
- ALL PLUMBING & DRAINAGE WORK TO COMPLY WITH AS 3500
- SITE CLASSIFICATION AS TO AS 2870
- ALL PLASTERBOARD WORK TO COMPLY WITH AS 2588-1998
- ALL STRUCTURAL STEEL WORK TO COMPLY WITH AS 4100 & AS 1554
- ALL CONCRETE WORK TO COMPLY WITH AS 3600
- ALL ROOF SHEETING WORK TO COMPLY WITH AS 1562-1992
- ALL SKYLIGHTS TO COMPLY WITH WITH AS 4285-2007
- ALL CERAMIC TILING TO COMPLY WITH AS 3958.1-2007 & 3958.2-1992
- ALL GLAZING ASSEMBLIES TO COMPLY WITH AS2047 &~1288
- ALL TIMBER RETAINING WALLS ARE TO COMPLY WITH AS 1720.1-2010,
- AS 1720.2-2006, AS 1720.4-2006, AS 1170.1-1989 & AS 1170.4-2007
 ALL RETAINING WALLS ARE TO COMPLY WITH 3700 2011 & AS 3600 -2009
- ALL CONSTRUCTION TO COMPLY TO AS3959- 2009

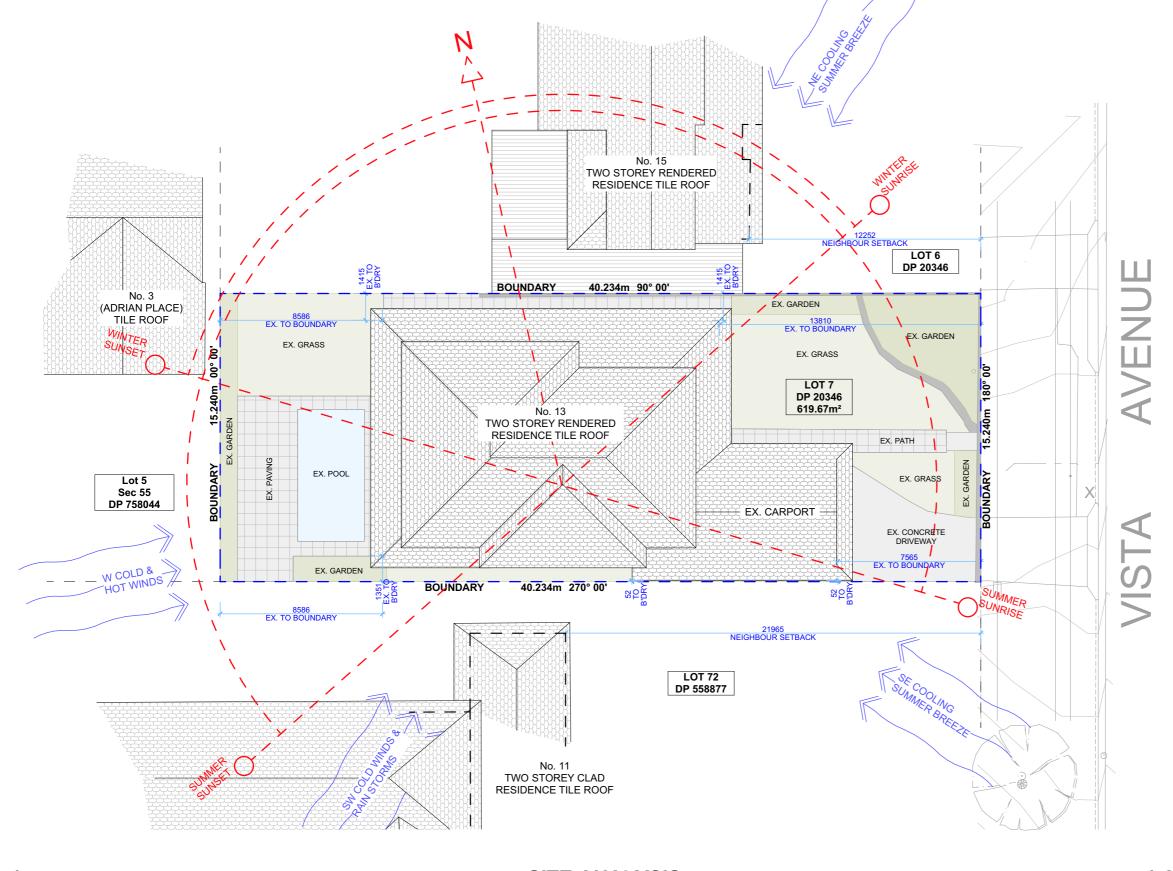

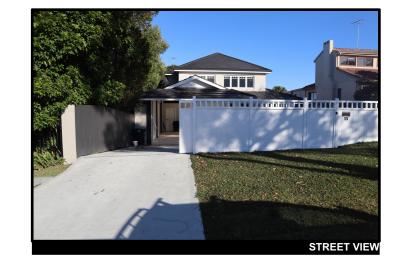





1:200 **SITE ANALYSIS**

NOTE: ALL DEMOLISHED ELEMENTS TO ENG. SPECIFICATIONS AND AS. 2601 - 2001



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CLIENT Mark Griffiths & Emma Flowers


PROJECT ADDRESS 13 VISTA AVENUE, BALGOWLAH HEIGHTS, NSW 2093


DRAWING NO. **DA01**

SITE ANALYSIS DATE Friday, 4 December 2020 **SCALE**

DRAWING NAME

1:200 @A3

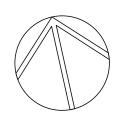

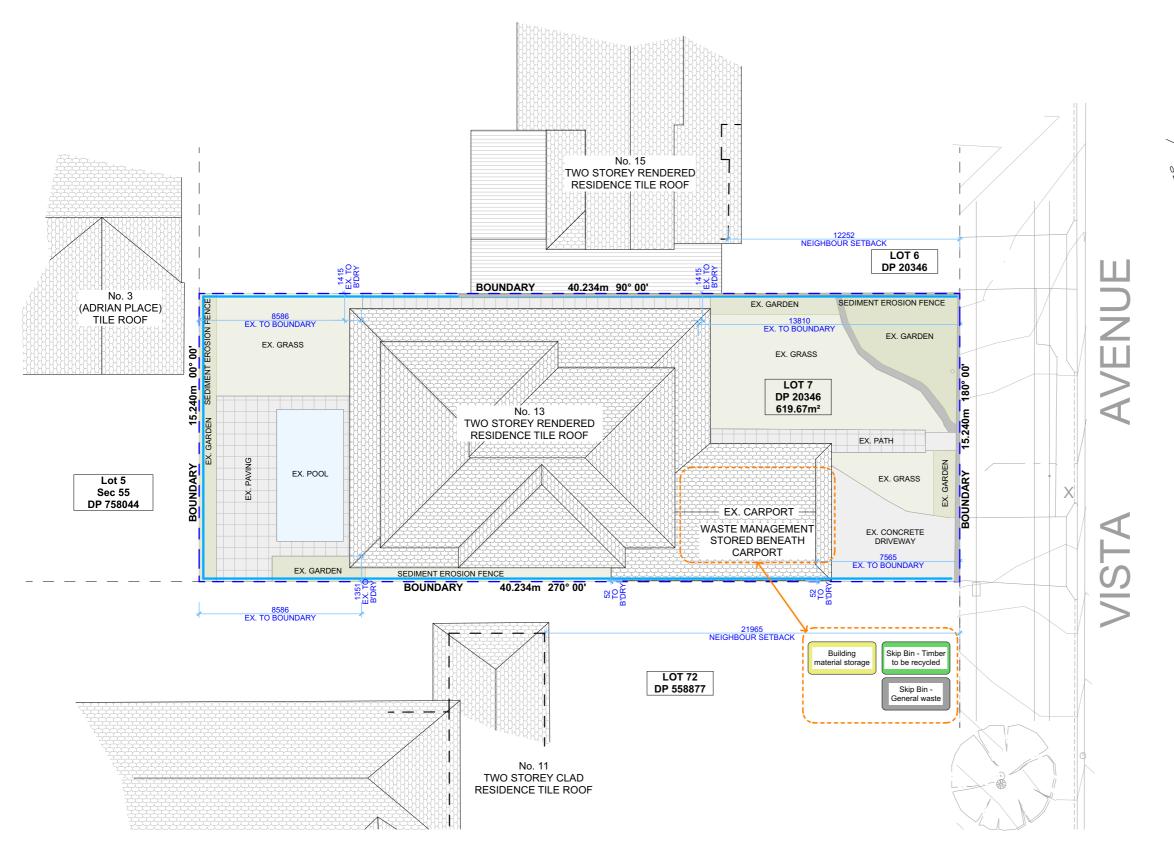

SITE / ROOF / SEDIMENT EROSION / WASTE MANAGEMENT / STORMWATER CONCEPT PLAN

SEDIMENT FENCE

DISTURBED AREA

DUST CONTROL: TO REDUCE DUST GENERATED BY WIND ACTION, THE REMOVAL OF THE TOP SOIL IS TO BE MINIMISED. TO PREVENT DUST GENERATION, WATERING DOWN OF THE SITE, ESPECIALLY DURING THE MOVEMENT OF MACHINERY IS REQUIRED. WHERE EXCAVATING INTO ROCK, KEEP THE SURFACE MOIST TO MINIMISE DUST. CONSTRUCT A GRAVEL ENTRY/EXIT POINT USING BLUE METAL AND RESTRICT ALL VEHICLE MOVEMENTS WITHIN THE SITE TO A MINIMUM. ENSURE WIND BREAKS, SUCH AS EXISTING FENCES ARE MAINTAINED DURING THE CONSTRUCTION PHASE UNTIL NEW LANDSCAPING IS PROVIDED OR REINSTATED. PREVENT DUST BY COVERING STOCKPILES

POSTS DRIVEN - 0.6m INTO

GROUND

↓ UNDISTURBED

AREA

WIRE OR STEEL MESH (WHERE REQUIRED)

3m MAX

DETAIL OF OVERLAP

SEDIMENT NOTE:

1. ALL EROSION AND SEDIMENT CONTROL MEASURES TO BE INSPECTED AND MAINTAINED DAILY BY THE SITE MANAGER.

2. MINIMISE DISTURBED AREAS, REMOVE EXCESS SOIL FROM EXCAVATEDAREA AS SOON AS POSSIBLE. 3. ALL MATERIAL STOCKPILE TO BE CLEAR FROM DRAINS, GUTTERS AND FOOTPATHS, OR WITHIN SEDIMENT FENCE AREA.

4. DRAINAGE TO BE CONNECTED TO STORMWATER AS SOON AS POSSIBLE. IF STORED ON SITE, IT MUST BE FILTERED BEFORE RELEASING INTO STORMWATER SYSTEM OR WATERWAYS

5. ROADS AND FOOTPATHS TO BE SWEPT DAILY.

STOCKPILES:

ALL STOCKPILES ARE TO BE KEPT ON-SITE WHERE POSSIBLE. ANY MATERIALS PLACED ON THE FOOTPATHS OR NATURE STRIPS REQUIRE COUNCIL'S PERMISSION.

ALL STOCKPILES ARE TO BE PLACED AWAY FROM THE DRAINAGE LINES AND STREET GUTTERS. IT IS BEST TO LOCATE THESE ON THE HIGHEST PART OF THE SITE IF POSSIBLE. PLACE WATERPROOF COVERING OVER STOCKPILES.

IF REQUIRED PROVIDE DIVERSION DRAIN & BANK AROUND STOCKPILES.


GUTTER PROTECTION:

PROVIDE PROTECTION TO DOWNHILL GRATE IN GUTTER BY MEANS OF SAND BAGS OR BLUE METAL WRAPPED IN GEOTEXTILE FABRIC. WHEN SOIL OR SAND BUILDS UP AROUND THIS SEDIMENT BARRIER, THE MATERIAL SHOULD BE RELOCATED BACK TO THE SITE FOR DISPOSAL.

NOTE: ALL PROPOSED STORMWATER TO CONNECT WITH EXISTING

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LEGEND

CLIENT

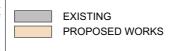Mark Griffiths & Emma Flowers

NSW 2093

PROJECT ADDRESS 13 VISTA AVENUE.

DATE Friday, 4 December BALGOWLAH HEIGHTS, 2020

DA02

DRAWING NO.


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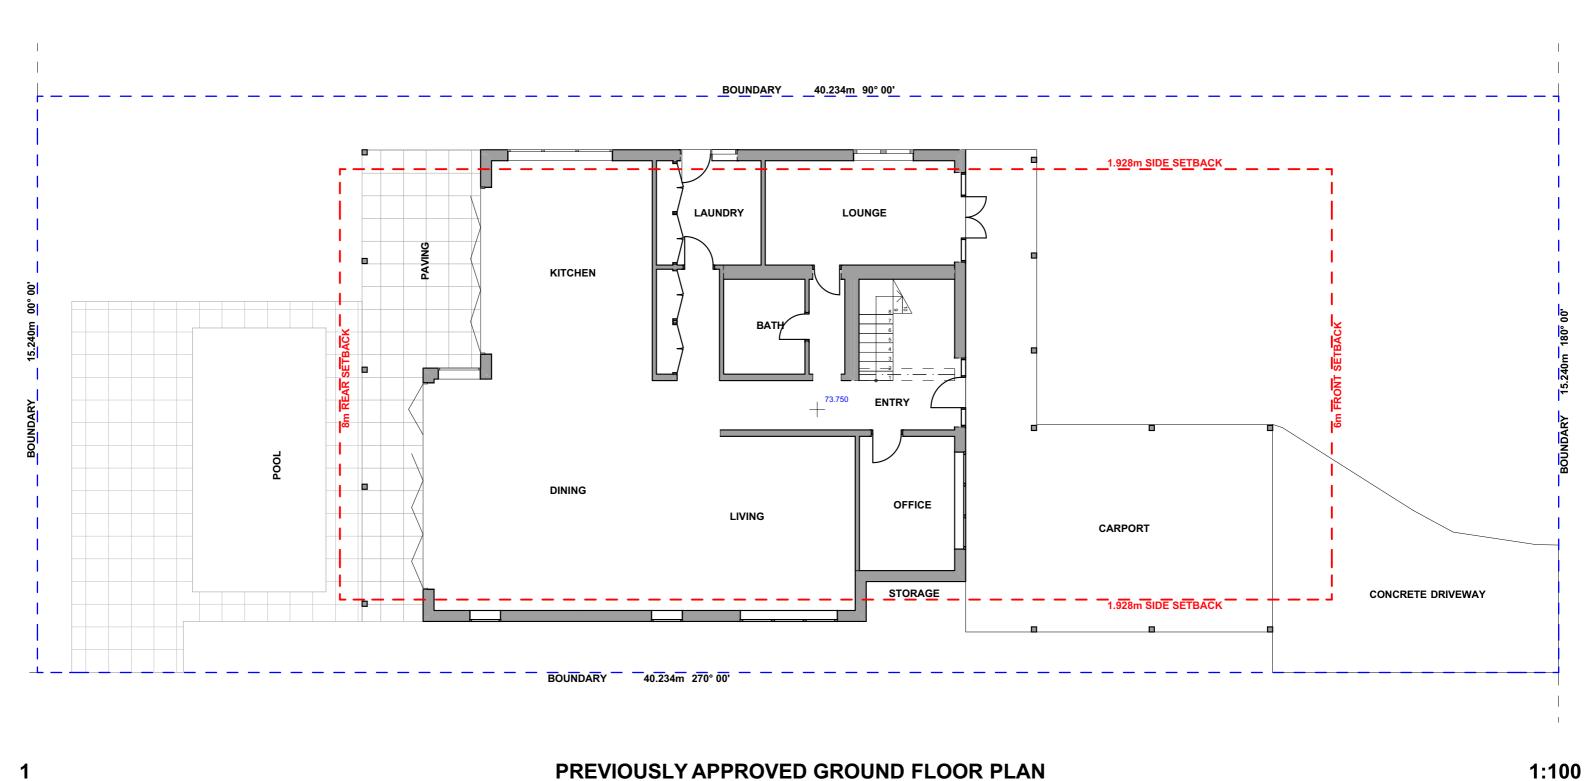
DRAWING NAME

SITE / ROOF / SEDIMENT **EROSION / WASTE** MANAGEMENT / STORMWATER CONCEPT PLAN

SCALE

1:200 @A3



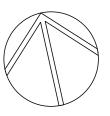


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PROPOSED WORKS

CLIENT

Mark Griffiths & Emma Flowers

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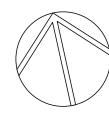
DRAWING NO. **DA03**

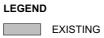Friday, 4 December 2020


DATE

PREVIOUSLY APPROVED GROUND FLOOR PLAN

SCALE 1:100 @A3



BOUNDARY 40.234m 90° 00'

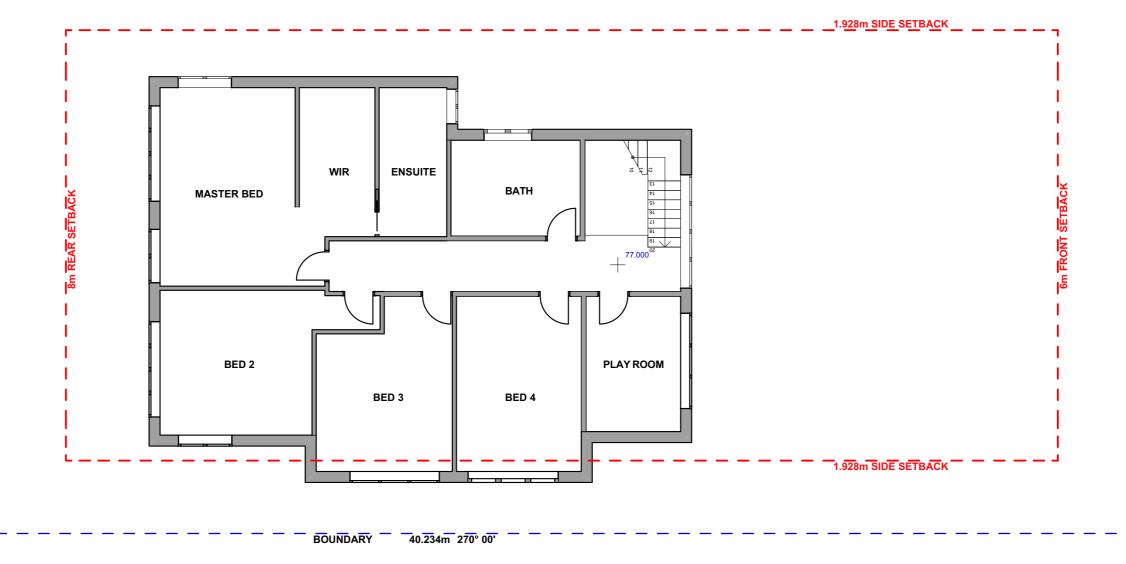


PREVIOUSLY APPROVED FIRST FLOOR PLAN

1:100

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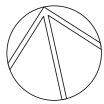
PROJECT ADDRESS 13 VISTA AVENUE, BALGOWLAH HEIGHTS, NSW 2093

DRAWING NO. **DA04**

SCALE

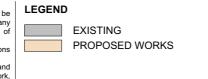1:100 @A3

DATE Friday, 4 December 2020 PREVIOUSLY APPROVED FIRST FLOOR PLAN




NOTE:

NO NEW INTERNAL WORKS PROPOSED TO THIS LEVEL

NOTE:

EAVES/FASCIA OF THE CARPORT ROOF TO COMPLY WITH PART 3.7.2.7 OF THE NCC. CARPORT EAVES TO BE LINED IN NON-COMBUSTIBLE FC SHEET. FASCIA TO BE TIMBER IF >450MM TO BOUNDARY. FASCIA TO BE NON COMBUSTABLE IF <450MM FROM BOUNDARY.

CLADDING TO STORAGE AREAS LESS THAN 900mm FROM ANY BOUNDARY SHALL COMPLY WITH PART 3.7.2 AND MUST HAVE A FRL 60/60/60

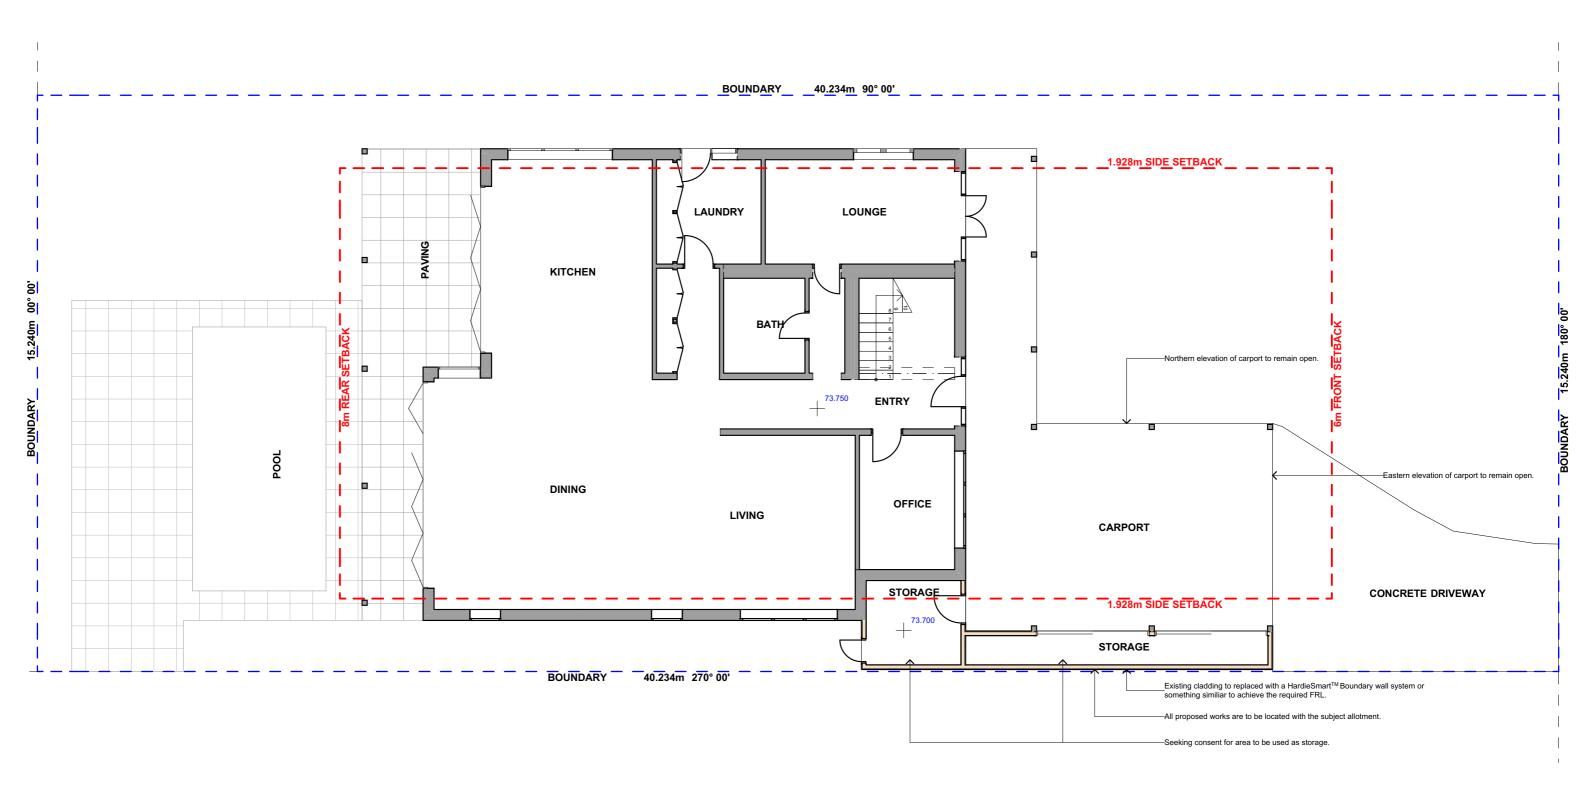

PROPOSED GROUND FLOOR LEVEL

1:100



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EXISTING PROPOSED WORKS

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PROJECT ADDRESS 13 VISTA AVENUE,

NSW 2093


DATE Friday, 4 December BALGOWLAH HEIGHTS, 2020

DA05

DRAWING NO. DRAWING NAME

PROPOSED GROUND FLOOR PLAN



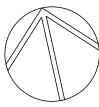

NOTE:

NO NEW INTERNAL WORKS PROPOSED TO THIS LEVEL


BOUNDARY 40.234m 90° 00' 1.928m SIDE SETBACK WIR **ENSUITE** BOUNDARY 15.240m 180°00 BATH MASTER BED BED 2 PLAY ROOM BED 3 BED 4 1.928m SIDE SETBACK BOUNDARY 40.234m 270° 00'

PREVIOUSLY APPROVED FIRST FLOOR PLAN

1:100



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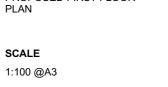


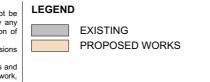
CLIENT	DRAWING NO.
Mark Griffiths & Emma Flowers	DA06

NSW 2093

Mark Griffiths & Emma Flowers	DA06
PROJECT ADDRESS	DATE
13 VISTA AVENUE, BALGOWLAH HEIGHTS,	Friday, 4 Dec 2020


PROPOSED FIRST FLOOR PLAN



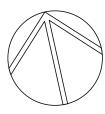




EAST ELEVATION 1:100

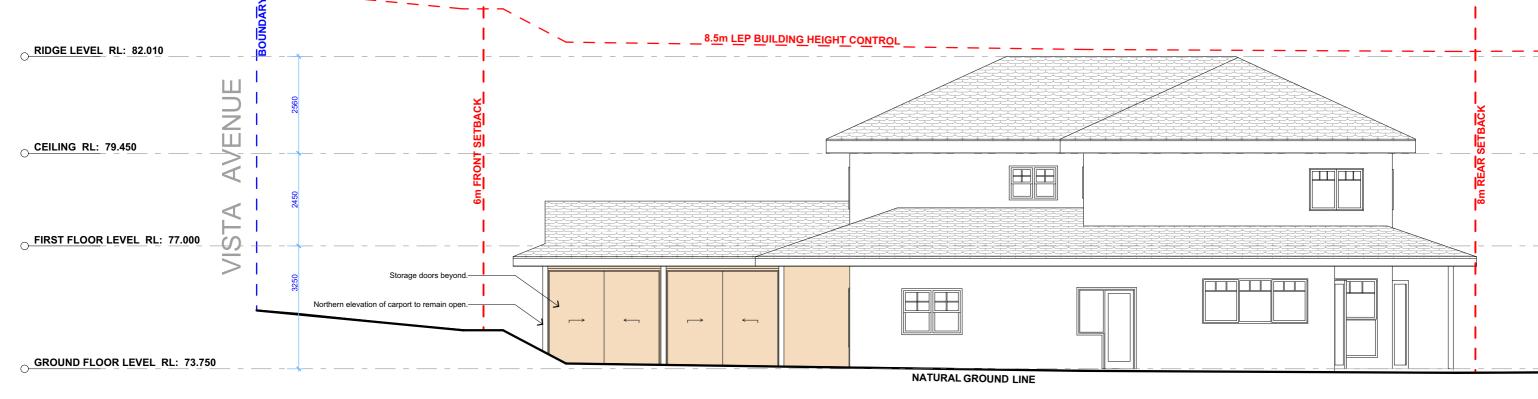

NORTH ELEVATION 1:100 2



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NSW 2093

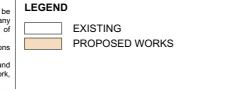
DA07	
DATE	

DRAWING NO. DRAWING NAME NORTH / EAST ELEVATION

PROJECT ADDRESS 13 VISTA AVENUE, BALGOWLAH HEIGHTS, 2020


Friday, 4 December **SCALE**


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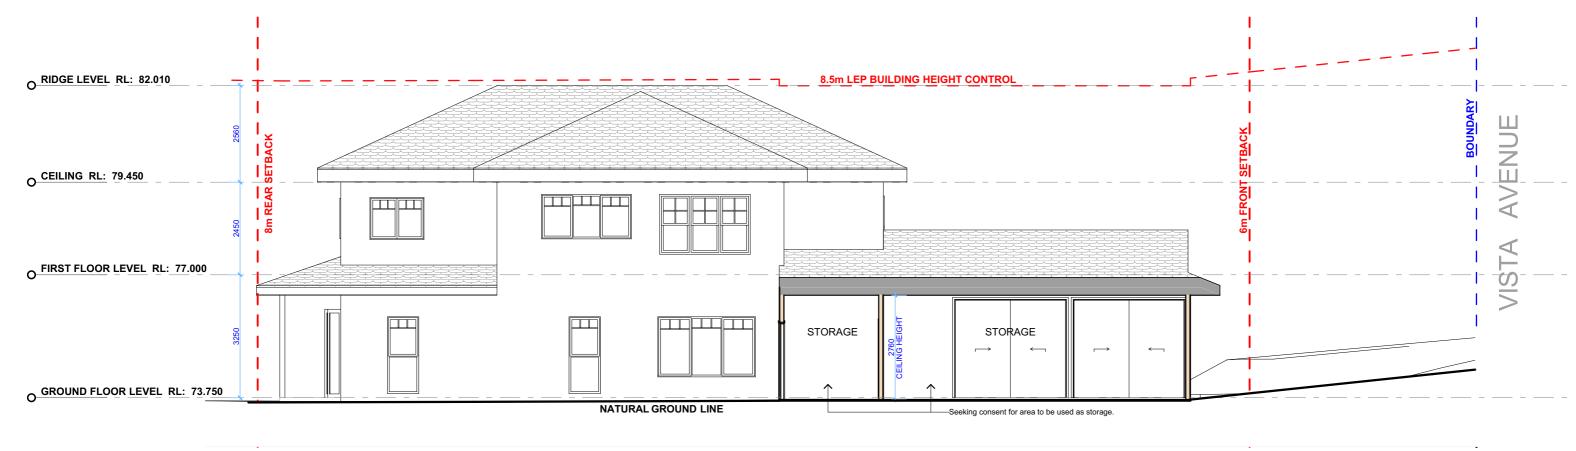


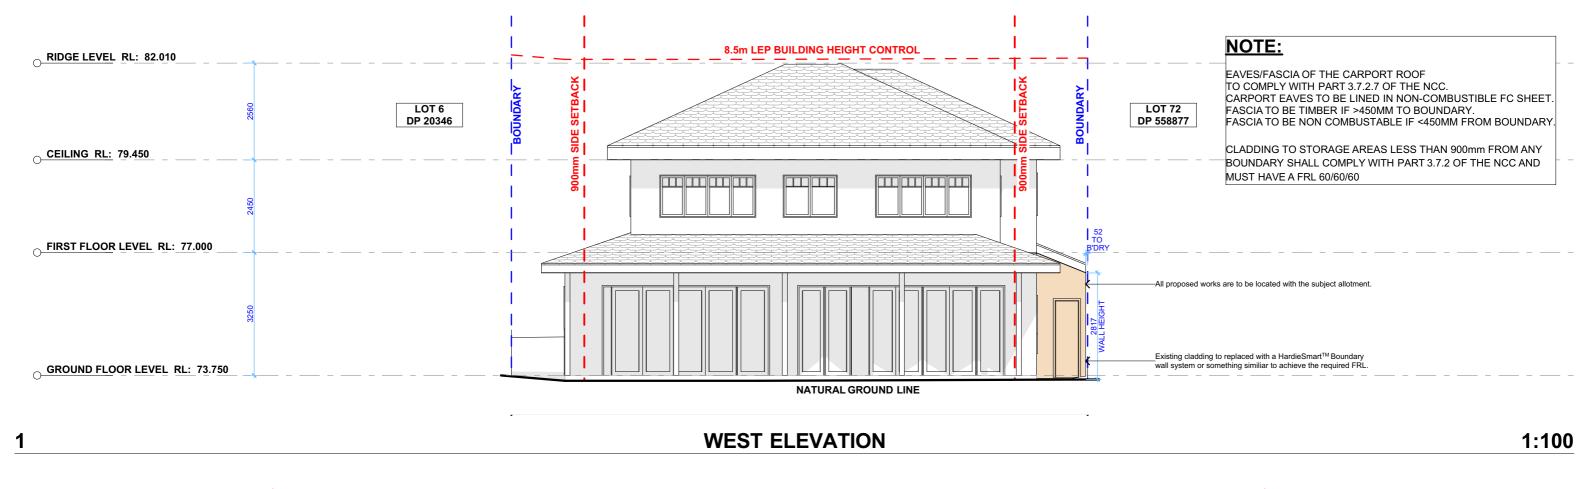


2 SOUTH ELEVATION 1:100




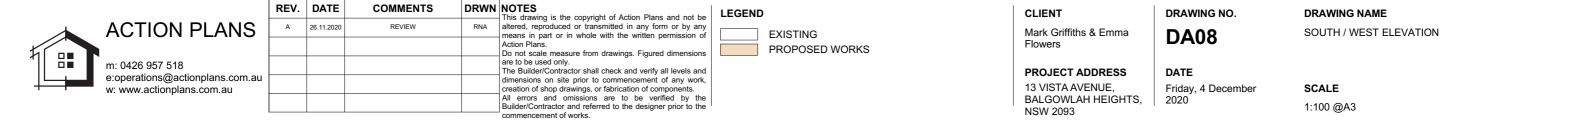

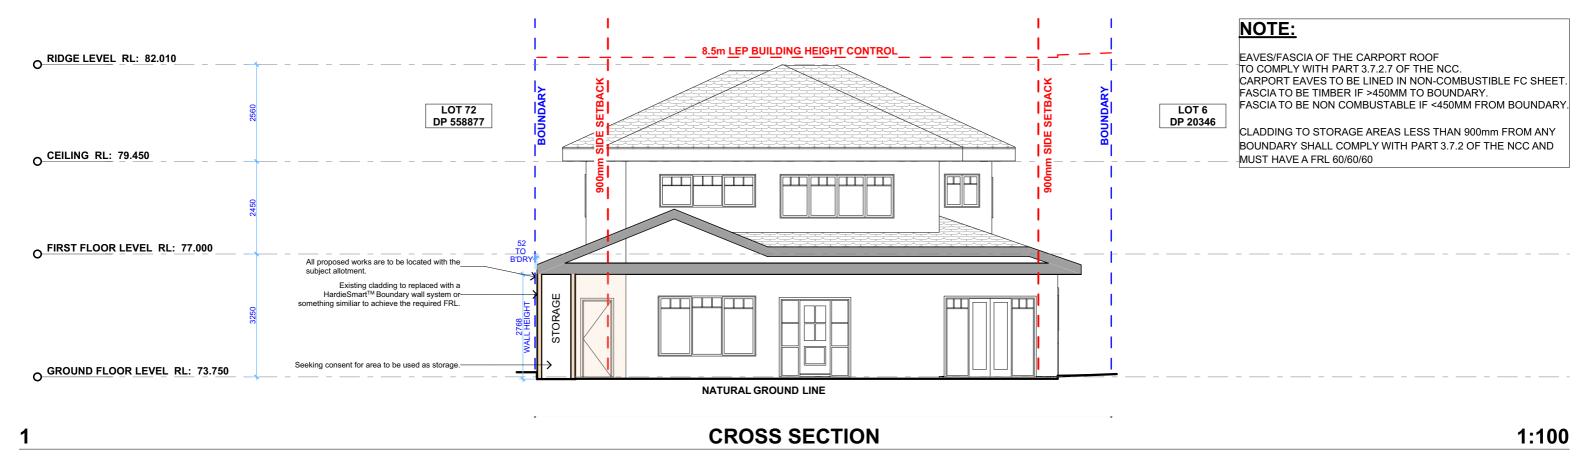

2 LONG SECTION 1:100

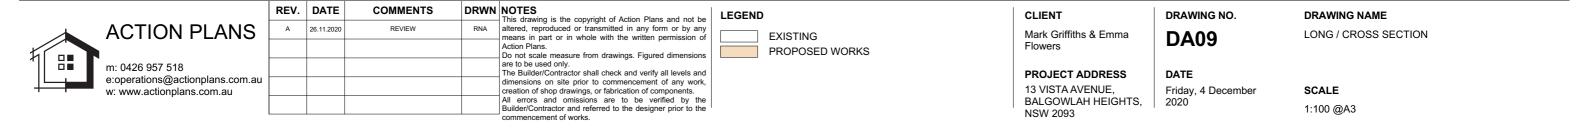

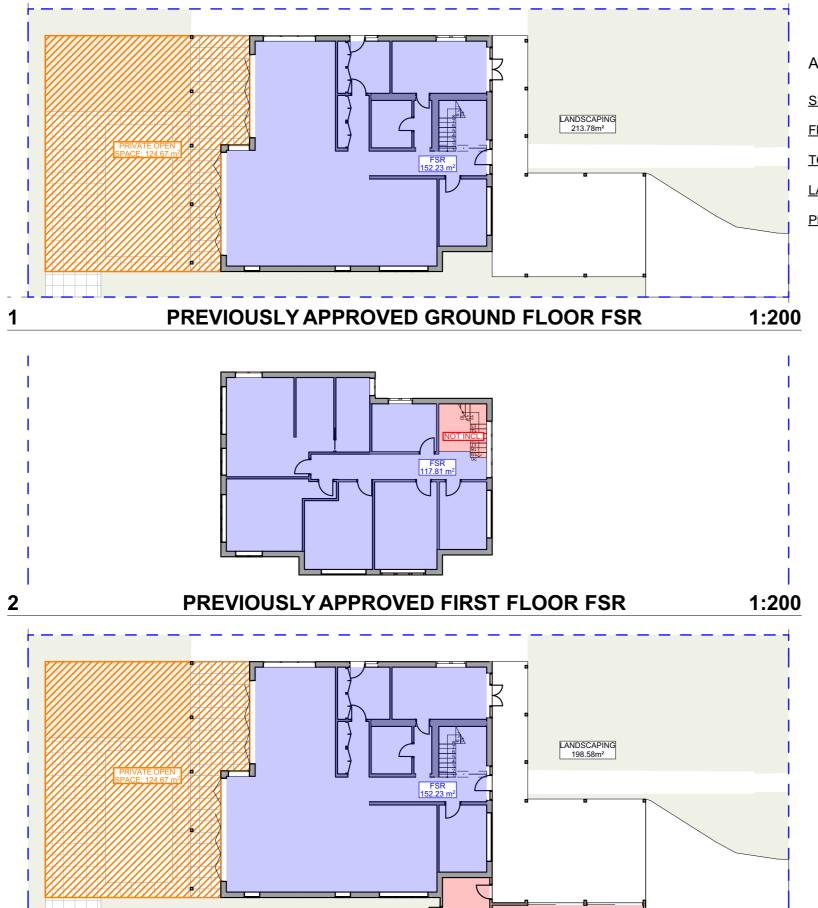

AREA CALCULATIONS

SITE AREA:619.67m ²	REQUIRED	EXISTING	PROPOSED
FLOOR SPACE RATIO	0.4 : 1 (247.868m²)	0.44 : 1 (270.04m²)	0.44 : 1 (270.04m²)
TOTAL OPEN SPACE	60% (371.8m²)	59% (366.82m²)	57% (351.62m²)
LANDSCAPED AREA	40% OF TOS (148.72m²)	57% (213.78m²)	53% (198.58m²)
PRIVATE OPEN SPACE	18m²	124.67m²	124.67m²

LANDSCAPED AREA / LANDSCAPED OPEN SPACE

FLOOR SPACE RATIO

NOT INCL. IN FLOOR SPACE RATIO

PRIVATE OPEN SPACE

PROPOSED GROUND FLOOR FSR 1:200



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LEGEND

Mark Griffiths & Emma

Flowers

CLIENT


PROJECT ADDRESS 13 VISTA AVENUE, BALGOWLAH HEIGHTS, NSW 2093


DA10

DRAWING NO.

DATE Friday, 4 December 2020 DRAWING NAME AREA CALCULATIONS / SAMPLE BOARD

SCALE 1:200 @A3

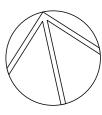

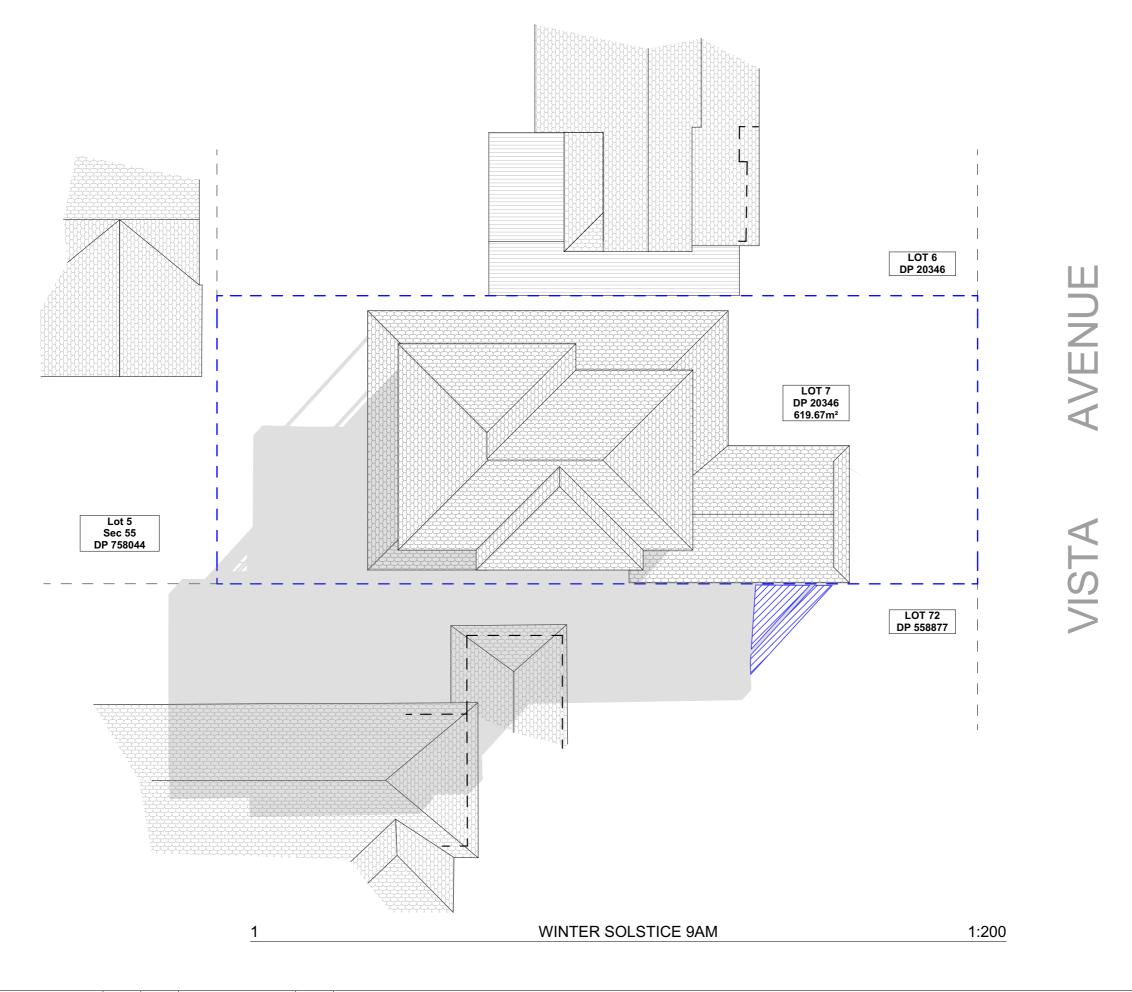



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EXISTING SHADOWS

PROPOSED SHADOWS

CLIENT

Mark Griffiths & Emma Flowers

PROJECT ADDRESS

13 VISTA AVENUE, BALGOWLAH HEIGHTS, NSW 2093

DRAWING NO.


WINTER SOLSTICE 9 AM **DA11**


DATE

Friday, 4 December 2020

DRAWING NAME


SCALE 1:200 @A3

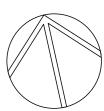

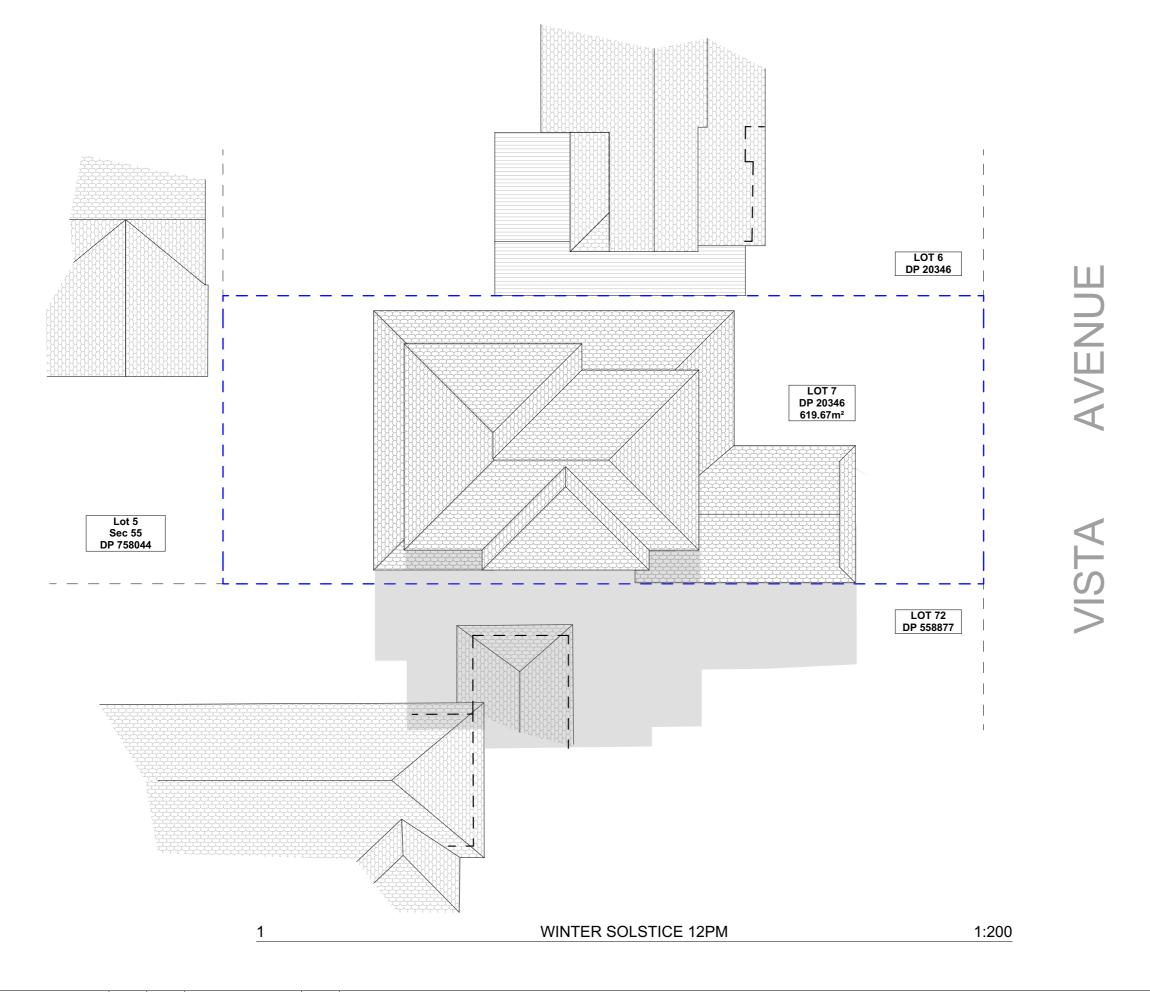



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Mark Griffiths & Emma Flowers
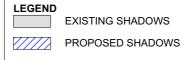
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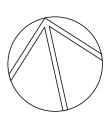
PROJECT ADDRESS 13 VISTA AVENUE, BALGOWLAH HEIGHTS, NSW 2093 DRAWING NO.


DATE

Friday, 4 December 2020

12 WINTER SOLSTICE 12 PM

SCALE 1:200 @A3



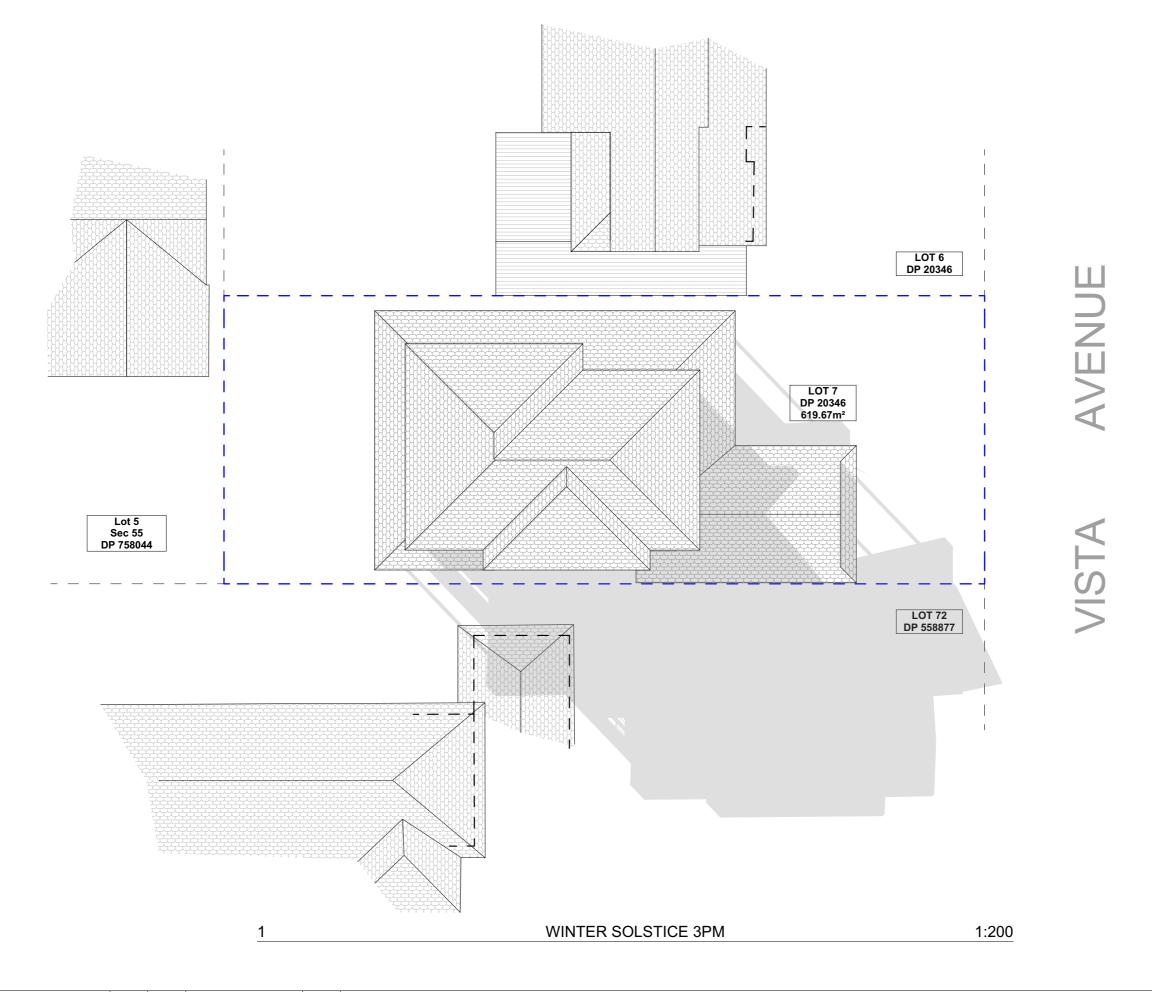



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				commencement of works.



EXISTING SHADOWS

PROPOSED SHADOWS

CLIENT

Mark Griffiths & Emma
Flowers

PROJECT ADDRESS 13 VISTA AVENUE, BALGOWLAH HEIGHTS, NSW 2093 DA13

DATE

Friday, 4 December 2020

DRAWING NAME
WINTER SOLSTICE 3 PM

1:200 @A3

ember **SCALE**

