# **DOUBLE STOREY DWELLING** #10,Raven circuit,Warriewood



## General notes:

- All materials and work practices shall comply with all-relevant current Australian standards (as amended)
- referred to therein.

  These drawings shall be read in conjunction with all relevant structural and all other consultant's drawings/ details and with any other written instructions issued. Figured dimensions take precedence over scaled

- Figured dimensions take precedence over scaled dimensions.
  The builder shall take all steps necessary to ensure the stability and general water tightness of all new and/or existing structures during all works.
  The contractor/builder is responsible for setting out and checking all levels and measurements on site.
  All dimensions and levels are to be checked and verified by the Owner/builder and any discrepancies in the documents must be resolved before ordering commencement of any works.
  Window sizes nominated are nominal only. Actual size may vary according to manufacturer. Windows are to be flashed all around.
  Installation of all services shall comply with supply authority requirements.

- Installation of all services shall comply with supply authority requirements.

  The builder and subcontractor shall ensure that all stormwater drains, Sewer pipes and the like are located at a sufficient distance from any footing and/or slab edge beams so as to prevent general moisture penetration, dampness, weakening and under mining of any building and its footing system.

Page No.	Title
1	Coverpage
2	Basix Notes
3	Cut and Fill Plan
4	Site Plan
5	Ground Floor Plan
6	First Floor Plan
7	Roof Plan
8	Elevations & Section
9	Side Elevations
10	Door Schedule & SOF
11	Windows Schedule
12	Sediment Control Plan
13	Site Analysis
14	Shadow Analysis
15	Floor Finish





# **BASIX** Certificate

# Single Dwelling

Certificate number: 1776820S

This certificate confirms that the proposed development will meet the NSW government's requirements for sustainability, if it is built in accordance with the commitments set out below. Terms used in this certificate, or in the commitment have the meaning given by the document entitled "ABSIX Definitions" dated 10/09/2020 published by the Department. This document is available at

Secretary
Date of issue: Monday, 09 December 2024
To be valid, this certificate must be submitted with a development application or lodged with a 
complying development certificate application within 3 months of the date of issue.



# **Basix-Commitments-Secondary Dwelling**

/for details: See the Basix certificate/

# **Alternative water**

The applicant must install a rainwater tank of at least 2000 litres.

The rainwater tank to collect rain runoff from at least 60m2 of the roof.

The applicant must connect the rainwater tank to:

- all toilets in the development
- the cold water tap that supplies each clothes washer
- at least one outdoor tap in the development

## **Fixtures**

- Shower heads  $\dots$  4 star (>6.0but <= 7.5 L/min)
- Toilets......4 star
- Kitchen tap.....4 star
- Basin Taps......4 star

**Hot Water System:** gas instantaneous with a performance of 6.0 stars /or a system with a higher energy rating/

# Heating/Cooling

- The applicant must install the following heating/cooling system, or a system with a higher energy rating, in at least 1 living area: 1-phase air-conditioning- non ducted; Energy rating: 3 star (average zone)
- The bedrooms must not incorporate any heating/cooling system, or any ducting which is designed to accommodate a heating/cooling system.

# Ventilation

- At least 1 Bathroom: individual fan, ducted to façade or roof; Operation control: interlocked to light
- Kitchen: individual fan, ducted to façade or roof; Operation control: manual switch on/off
- Laundry: individual fan, ducted to façade or roof; Operation control: manual switched on/off

# **Artificial lighting:**

• The applicant must ensure that a minimum of 80% of light fixtures are fitted with fluorescent, compact fluorescent, or light-emitting-diode (LED) lamps.

# **OTHER**

- The applicant must install a gas cooktop & electric oven in the kitchen of the dwelling.
- The applicant must install a fixed outdoor clothes drying line as part of the development.

The Basix certificate should be read in conjunction with the Nathers certificate (including the additional notes pages 4 & 5).

# **Building Elements-Secondary Dwelling**

/For Details: see the Nathers certificate

# **Thermal Comfort-Simulation method**

A detailed method of assessment with greater flexibility of solution choice and capacity to assess complex dwelling designs.

The dwelling design has been assessed with NatHERS software from an accredited assessor

# **External Walls**

Timber Stud Frame Brick Veneer, R2.5 Anti-glare foil with bulk no gap

## **Internal Wall**

- Brick, plaster on studs R2.5, No insulation one side, Bulk Insulation the other
- Timber Stud Frame, Direct Fix Plasterboard, No Insulation

## **External Floor**

Concrete Slab on Ground

# **External Ceiling**

- Plasterboard on Timber, R2.5 Bulk Insulation Unventilated roofspace(Reduced insulation near the eave in the distance of 580mm)
- Plasterboard on Timber, R4.0 Bulk Insulation Unventilated roofspace(All others/ unaffected ceiling area)

# Roof

Corrugated Iron Timber Frame, R1.3 Bulk, Reflective Side Down, No Air Gap Above

Note: All coffer ceiling verticals and walls against the roof-space, to be insulated, with the same insulation as the ceiling insulation

Note: All downlights: IC-F /IC-4/ (insulation covered/ including the control gears/) rated as per AS/NZS standard 60598 and IP (sealed) rated as per BS EN 60529:1992, European IEC 60509:1989

Note: (where the roof is extended over an open area such as a deck or carport): A barrier to be installed within the roof space to separate the space above the zoned part of the house and the space above the open veranda.

The building fabric, including insulation and air cavity ventilation, must meet the requirements specified in Part H Energy Efficiency (Volume 2) of the NCC and the ABCB Housing Provisions 10.8 and 13.2. These standards are essential to ensure proper energy efficiency and compliance in construction practices.

Note-Ceiling fans: For the number and the location, see the Nathers certificate.

For additional information please refer to the additional notes on the Nathers certificate.

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В	19/05/2025	Changes as per Council Letter
Α	24/01/2025	Issue for DA

DRAWING : Basix Notes	DRAWN BY:	DATE:
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CLIENT: Skymark Luxury Living Pty Ltd	SCALE:	APPLICATION
PROJECT: DOUBLE STOREY DWELLING		DA
#10,Raven circuit,Warriewood	PAGE SIZE	PAGE NO:
Lot-10 D.P 271326	A3	2

PROJECT NO.

2411 791

**ISSUE** 

Cut and Fill is only under Slab.
Cut and Fill on the site is minimal, Hence does not required Retaining wall.





Cut and Fill Plan 1:200

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Α	24/01/2025	Issue for DA



DRAWING : Cut and Fill Plan			
CLIENT:	Skymark Luxury Living Pty Ltd		
PROJECT	DOUBLE STOREY DWELLING		
	#10,Raven circuit,Warriewood		

Lot-10 D.P 271326

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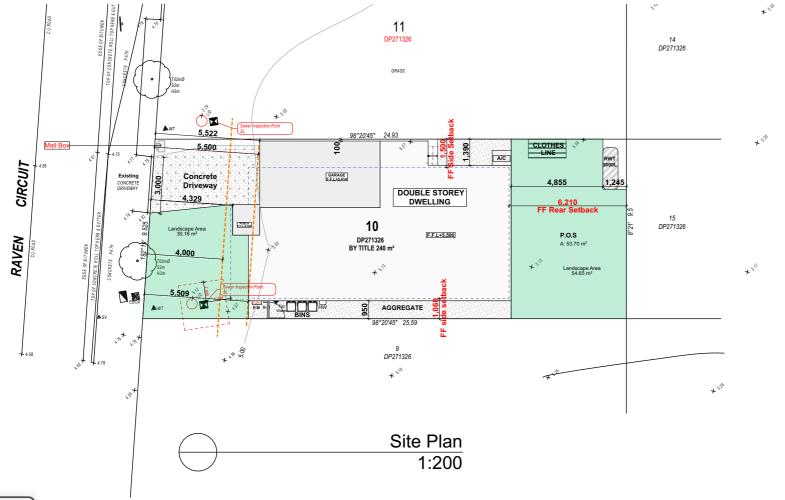
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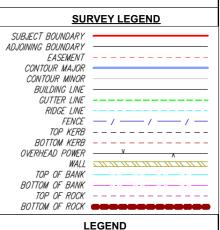
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1		1
CROSSOVER	Driveway	GARAGE
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¦.	4,790	624
	Driveway gradient 1:100	
	1.100	





SYMBOLS:		ABBREVIATIONS:
BENCHMARK	<b>A</b>	B - BOTTOM WINDOWS
ELECTRICITY BOX	E	BM - BENCHMARK
GA TE	a	EL - ELECTRICAL POLE
		FF - FIRST FLOOR
SIGN	-	FL – FLOOR LEVEL
HYDRANT	0	G - GAS VALVE
	7	GF — GROUND FLOOR
KERB OUTLET/IL	<b>+</b>	GM – GAS METER
MAIL		GU - GUTTER RL
0700 14115		H – HYDRANT II – INVERT LEVEL
STOP VALVE	Δ	
WASTEWATER CONTROL PIT		KO – KERB OUTLET IP – LIGHT POLE
WASTEWATER CONTROL TANK	60	MB - MAII BOX
WASIEWAIER CONTROL TANK		PP - POWER POLE
WATER METER	WM.	R - ROOF INF
WATER TAP	A	RI — REDIJOED LEVEL
WAILK IAF		RR - ROOF RIDGE
POWER POLE	•	S - SFWFR CONNFCTION
SEWER MANHOLE	6	SF - SECOND FLOOR
SEMEN MONTOCE	₩	SV = SURFACE   FVFI
S/W GRATE		SV - STOP VALVE
TELSTRA PIT		SVP - SEWER VENT PIPE
	-	T - TOP WINDOWS
UNCLASSIFIED PIT	U	TW - TOP OF WALL
	_	WT - WATER TAP
TREE & TRUNK	$\left( \cdot \right)$	WM - WATER METER

	LEGEND			
	Ref.img	Mark	Name Smoke Alarm (AS3786 Hard Wired to Mains	
		S.A		
		R.W.T	Rai	n Water Tank
		E.M	Ele	ctric Meter
		A/C	Air	Conditioner
		HW	Wall Mounted Hot water System	
		P.O.S	Priv	ate Open Space
		FW		or Waste
	$\boxtimes$	MV	Mechanical Ventilation (All vent to exhaust outside).	
	$\times$	ME	Mechanical Ventilation (All vent to exhaust outside).	
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# PEFORE YOU DIG www.byda.com.au Zero Damage - Zero Harm

SITE CALCUALTIONS

Name

Site Area

Landscape Area

Area SQM

240.00 84.81

No.

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BUILDING DESIGNER

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	В	19/05/2025	Changes as per Council Letter
•	Α	24/01/2025	Issue for DA



DRAWING	:Site Plan
CLIENT :	Skymark Luxury Living

CLIENT: Skymark Luxury Living Pty Ltd

PROJECT: DOUBLE STOREY DWELLING
#10,Raven circuit,Warriewood

Lot-10 D.P 271326

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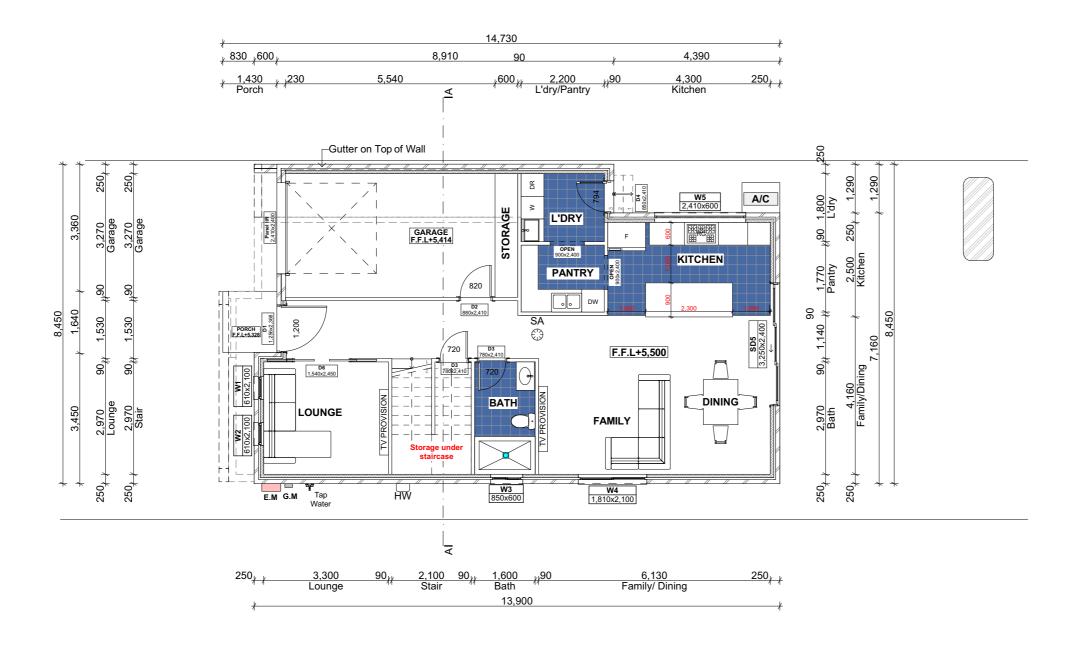
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2411 791

ISSUE

External Walls with vapour permeable membrane as per manufacturer detail.



LEGEND				
Ref.img	Mark	Name		
6	S.A	Smoke Alarm (AS3786 Hard Wired to Mains)		
	R.W.T	Rain Water Tank		
	E.M	Electric Meter		
	A/C	Air Conditioner		
	HW	Wall Mounted Hot water System		
	P.O.S	Private Open Space		
	FW	Floor Waste		
$\boxtimes$	MV	Mechanical Ventilation (All vent to exhaust outside).		
	ME	Mechanical Ventilation (All vent to exhaust outside).		
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Ground Floor 1:100

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В	19/05/2025	Changes as per Council Letter
Α	24/01/2025	Issue for DA



DRAWING : Ground Floor Plan			
CLIENT :	Skymark Luxury Living Pty Ltd		
PROJECT :	DOUBLE STOREY DWELLING		
	#10.Raven circuit.Warriewood		

Lot-10 D.P 271326


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PAGE NO: 5

Selected Cladding with vapour permeable membrane as per manufacturer detail.



2. First Floor 1:100

	LEGEND				
Ref.img	Mark	Name			
0	S.A	Smoke Alarm (AS3786 Hard Wired to Mains)			
	R.W.T	Rain Water Tank			
	E.M	Electric Meter			
	A/C	Air Conditioner			
	HW	Wall Mounted Hot water System			
	P.O.S	Private Open Space			
	FW	Floor Waste			
$\boxtimes$	MV	Mechanical Ventilation (All vent to exhaust outside).			
	ME	Mechanical Ventilation (All vent to exhaust outside).			
	DV-	DATE:   BBO JECT NO			

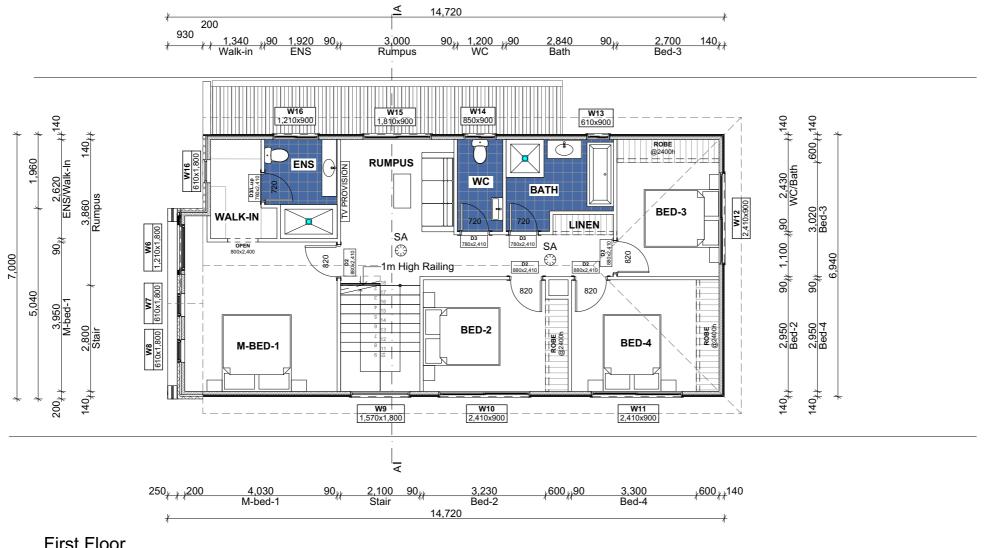

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DRAWING	:First Floor Plan
CLIENT:	Skymark Luxury Living Pty Ltd
PROJECT :	DOUBLE STOREY DWELLING
	#10.Raven circuit.Warriewood

Lot-10 D.P 271326

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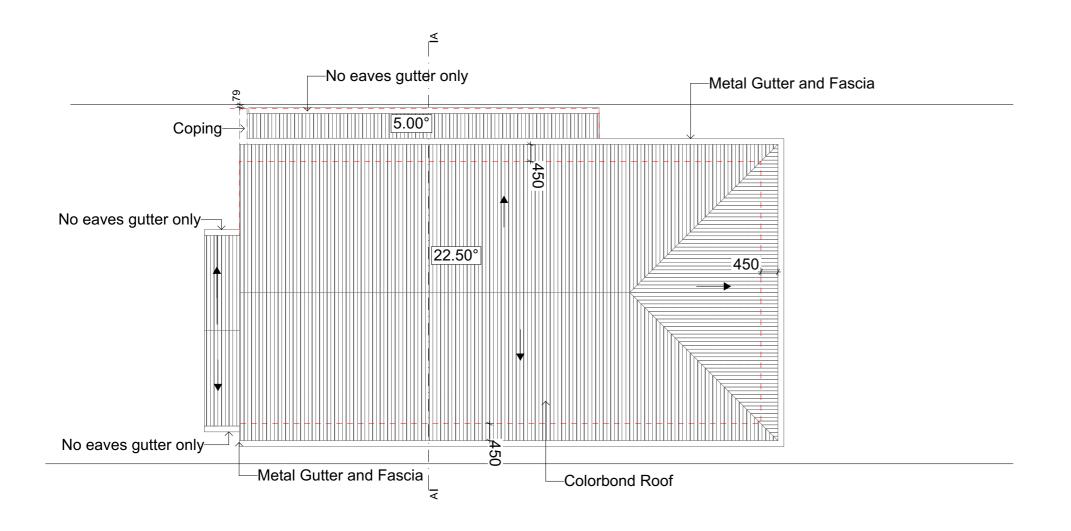
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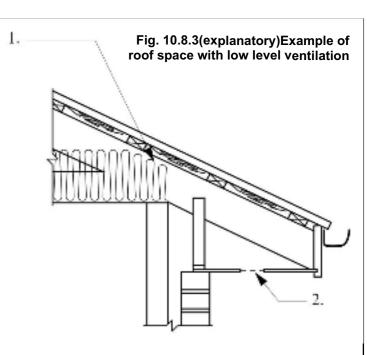
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PAGE NO: 6

PROJECT NO.

2411 791

ISSUE





# Figure Notes

- 1. Min 20 mm gap maintained between insulation and sarking
- 2. Eave ventilation opening in accordance with Table 10.8.3.

3. Roof 1:100



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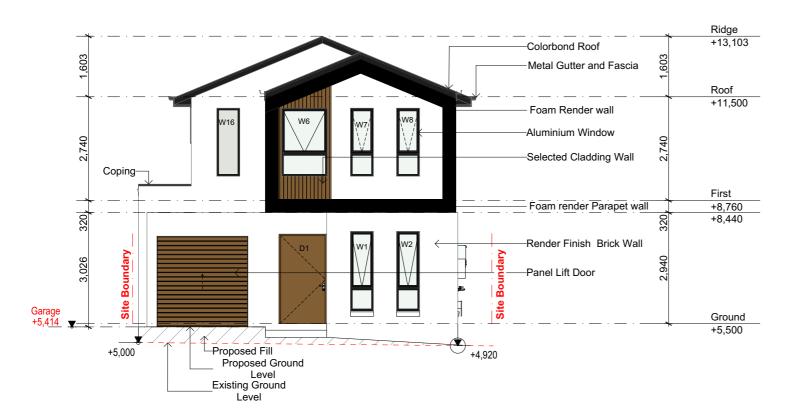
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Α	24/01/2025	Issue for DA



DRAWING	:Roof Plan	D
CLIENT:	Skymark Luxury Living Pty Ltd	_   _
PROJECT :	DOUBLE STOREY DWELLING	_   _
	#10 Rayen circuit Warriewood	P


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GS	19/05/2025	2411 791
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1 West Elevation (Front ) 1:100





2

East Elevation (Rear)

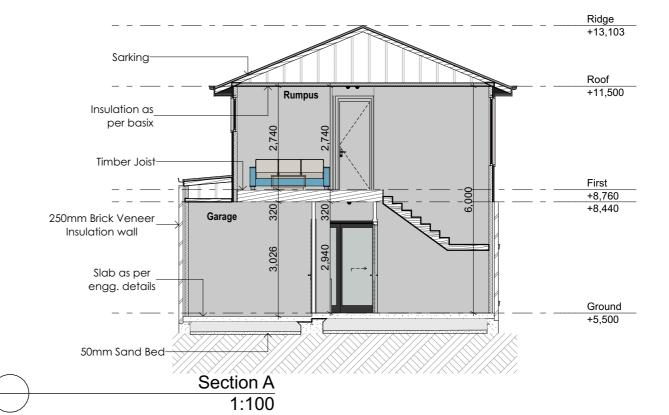1:100

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DRAWING : Elevations & Section	DRA
CLIENT: Skymark Luxury Living Pty Ltd	SC.
PROJECT: DOUBLE STOREY DWELLING	1:
#10 Raven circuit Warriewood	PAC

Lot-10 D.P 271326

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CALE: 1:100	APPLICATION : DA	1:
GE SIZE	PAGE NO:	

2411 791
ISSUE

8.5m (max building height) -Colorbond Roof Ridge +13,103 1,603 22.50° 22.50° Metal Gutter and Fascia No eaves gutter only Roof +11,500 -Aluminium Window -Selected Cladding Foam Rendered wall -Colorbond Roof -Gutter on Top of Wall First 8,096 Building height +8,760 -Face Brick Wall Ground +5,500 +5,110 Existing Ground +5,000 Level

North Elevation (left Side)
1:100

8.5m (max building height)



South Elevation (Right Side)
1:100

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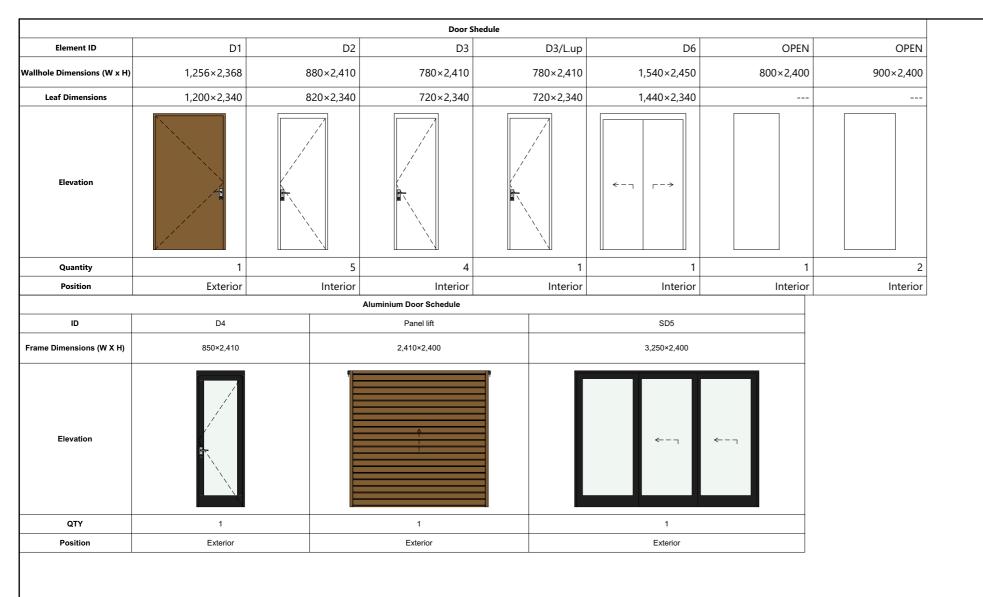
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DRAWING : Side Elevations	GS
CLIENT: Skymark Luxury Living Pty Ltd	SCALE:
PROJECT: DOUBLE STOREY DWELLING	1:100
#10,Raven circuit,Warriewood	PAGE SIZE
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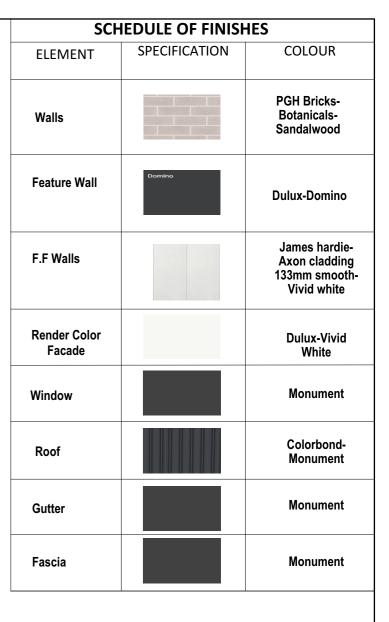
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PAGE NO: BSUE B





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#	В	19/05/2025	Changes as per Council Letter
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DRAWING : Door Schedule & SOF

CLIENT: Skymark Luxury Living Pty Ltd

PROJECT: **DOUBLE STOREY DWELLING** #10,Raven circuit,Warriewood Lot-10 D.P 271326

DATE: DRAWN BY: GS SCALE:

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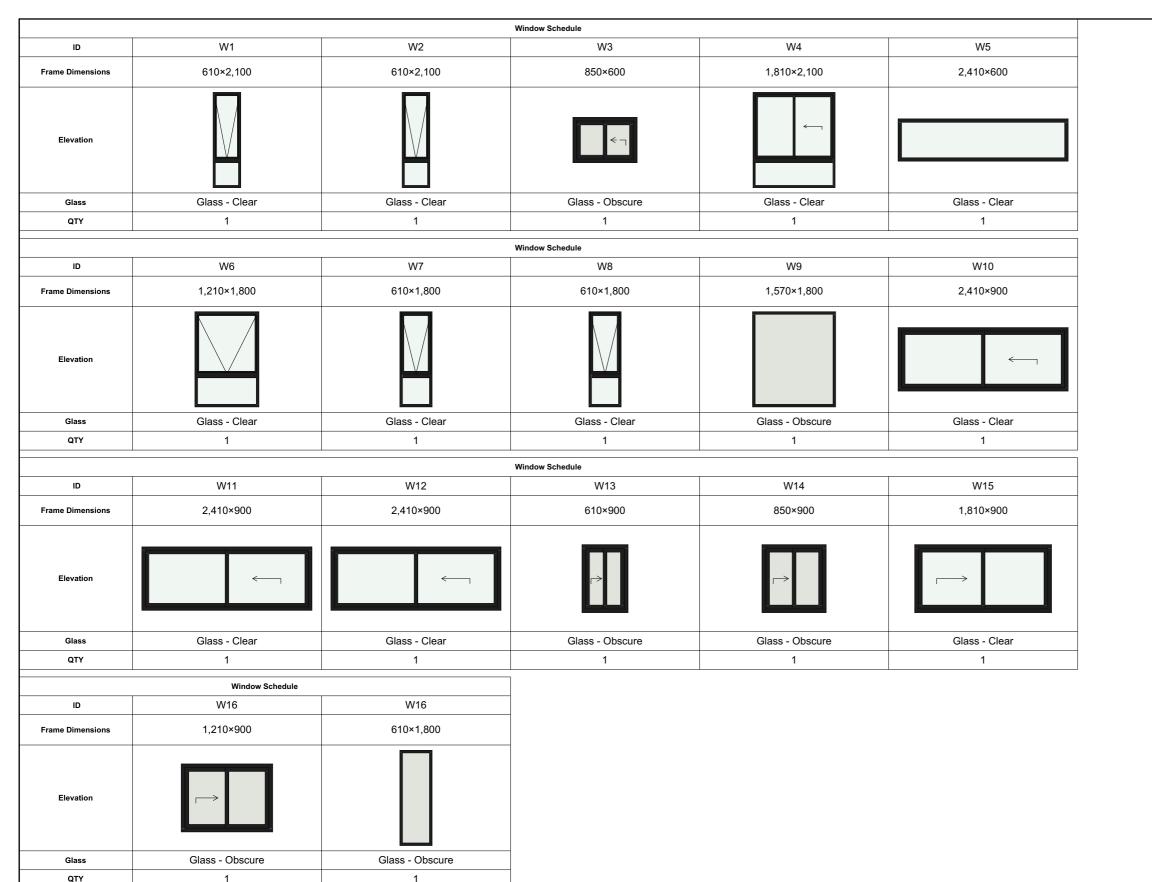
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ISSUE B

PROJECT NO.



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DRAWN BY: DRAWING : Windows Schedule CLIENT: Skymark Luxury Living Pty Ltd SCALE: PROJECT: DOUBLE STOREY DWELLING PAGE SIZE #10,Raven circuit,Warriewood A3

Lot-10 D.P 271326

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DATE: 19/05/2025 GS APPLICATION DA ISSUE PAGE NO:

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O BE CHECKED AND CONFIRMED BY BUILDER ON SITE BEFORE PLACING ORDER. ALL PREVENTION FROM WINDOWS

PRESENTATION FROM WINDOWS IN ACCORDANCE WITH REQUIREMENTS OF BCA CLAUSE 19.2.5

.9.2.5
- If Opening withing 1700mm above the floor; and climable elements between 150 and 750 mN bove the floor, opening must be permanently restricted to 125mm; or fitted withn a non expression of the control of the

bust screen.

If opening between 865 of the floor; and climable elements between 150 and 760mm above following within a non-removable robust screen.

If no opening within 1700mm of the floor. No restrictions apply.

Part 3.9.2.6 Protection of openable windows - bedrooms
(a) A window opening in a bedroom must be provided with protection, where the floor below the window is 2 m or more above the surface beneath.
(b) Where the lowest level of the window opening covered by (a) is less than 1.7 m above the floor, the window opening

) Where the lowest level of the window opening covered by (a) is less than 1.7 m above to or, the window opening ust comply with the following:
The openable portion of the window must be protected withJa device capable of restricting the window opening; or
Ja screen with secure fittings, and the screen with secure fittings, and the screen with secure fittings, with the screen with secure fittings, and permit a 125 mm sphere to pass through the window opening or screen; and resist an outward horizontal action of 250 N against the alwindow restrained by a device; or by screen protecting the opening; and have a child resistant release mechanism if the screen or device is able to be removed, locked or


erridden. Where a device or screen provided in accordance with (b)(i) is able to be removed, unlocked or erridden, a barrier the height not less than 865 mm above the floor is required to the openable window in dition to window


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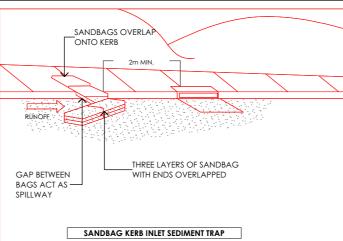
(i) A barrier covered by (c) must notpermit a 125 mm sphere to pass through it; and
) have any horizontal or near horizontal elements between 150 mm and 760 mm above the floo


3.9.2.7 Protection of openable windows - rooms other than bedrooms
(a) A window opening in a room other than a bedroom must be provided with protection where
the floor below the window
is 4 m or more above the surface beneath.
(b) The openable part of the window covered by (a) must be protected with a barrier with a
height of not less than 865
ma above the floor.
(c) A barrier required by (b) must not(i) permit a 125 mm sphere to pass through it; and
(ii) have any horizontal or near horizontal elements between 150 mm and 760 mm above the floor
that facilitate
(limbing.

PROJECT NO. 2411 791



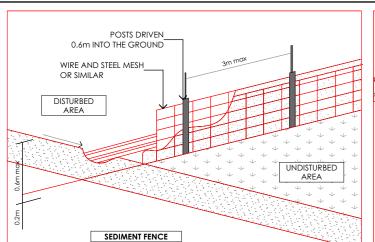

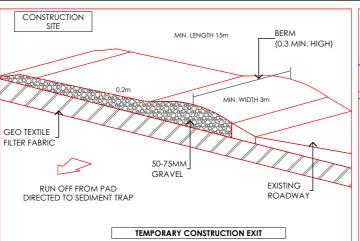

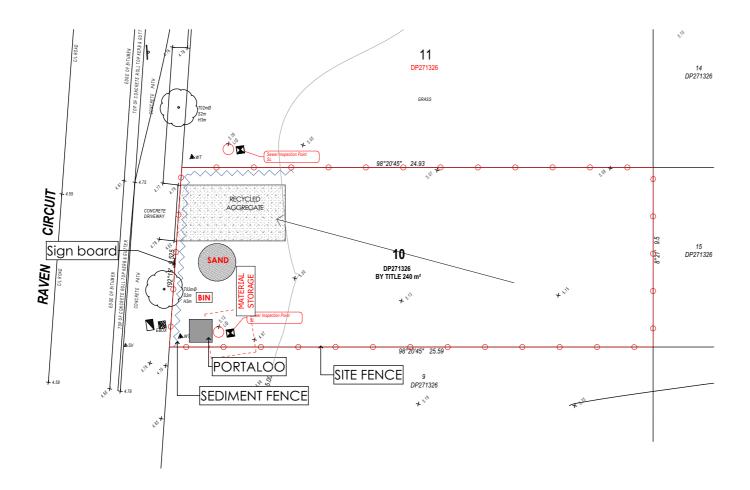



1. ALL EROSION AND SEDIMENTATION CONTROL MEASURES, INCLUDING REVEGETATION AND STORAGE OF SOIL AND TOPSOIL, SHALL BE IMPLEMENTED TO THE STANDARDS OF THE SOIL CONSERVATION OF NSW.

2. ALL DRAINAGE WORKS SHALL BE CONSTRUCTED AND STABILIZED AS EARLY AS POSSIBLE DURING DEVELOPMENT.

3.SEDIMENT TRAPS SHALL BE CONSTRUCTED AROUND ALL INLET PITS, CONSISTING OF 300mm WIDE x 300mm DEEP TRENCH.
4. ALL SEDIMENT BASINS AND TRAPS SHALL BE CLEANED WHEN THE STRUCTURES

4. ALL SEDIMENT BASINS AND TRAPS SHALL BE CLEANED WHEN THE STRUCTURES AREA MAXIMUM OF 60% FULL OF SOIL MATERIALS, INCLUDING THE MAINTENANCE PERIOD.

5. ALL DISTURBED AREAS SHALL BE REVEGITATED AS SOON AS THE RELEVANT WORKS ARE COMPLETED.

6. SOIL AND TOPSOIL STOCKPILES SHALL BE LOCATED AWAY FROM DRAINAGE LINES

AND AREA WHERE WATER MAY CONCENTRATE.
7. FILTER SHALL BE CONSTRUCTED BY STRETCHING A FILTER FABRIC (PROPEX OR APPROVED EQUIVALENT BETWEEN POST AT 3.0m CENTRES. FABRIC SHALL BE BURIED 150mm ALONG ITS LOWER.

TOPSOIL SHALL BE STRIPPED AND STOCKPILED OUTSIDE HAZARD AREAS SUCH AS DRAINAGE LINES. THIS TOPSOIL IS TO BE RE-SPREAD LATER ON AREAS TO BE REVEGETATED AND STABILISED ONLY. (i.e ALL FOOT-PATHS, BATTERS, SITE, REGRADING AREAS, DRAINAGE RESERVES AND CHANNELS). TOP SOIL SHALL NOT BE SPREAD ON ANY OTHER AREAS SPECIFICALLY INSTRUCTED BY THE SUPERINTENDENT. IF THEY ARE TO REMAIN FOR LONGER THAN ONE MONTH STOCKPILES SHALL BE PROTECTED FROM EROSION BY COVERING THEM WITH A MULCH AND HYDROSEEDING AND, IF NECESSARY. BY LOCATING BANKS OR DRAINS UPSLOPE TO DIVERT THE RUNOFF AROUND THEM. IN SOME CIRCUMSTANCES IT MAY BE NECESSARY TO PLACE BANKS OR DRAINSDOWN STREAM OF A STOCKPILE TO RETARD SEDIMENT LADEN RUNOFF. THE CONTRACTOR SHALL REGULARLY MAINTAIN ALL SEDIMENT AND EROSION CONTROL DEVICES AND REMOVE ACCUMULATED SILT FROM SUCH DEVICES BEFORE NO MORE THAN 60% OF THEIR CAPACITY IS LOST. ALL THE SILT REMOVED SHALL BE DISPOSED OF AS DIRECTED BY THE SUPERINTENDENT. (NO SILT SHALL BE PLACED OUTSIDE THE LIMITS OF WORKS). THE PERIOD FOR MAINTAINING THESE DEVICES SHALL BE AT LEAST UNTIL ALL DISTURBED AREAS ARE REVEGETATED AND FURTHER AS MAY BE DIRECTED BY THE SUPERINTENDENT OR COUNCIL

### SEDIMENT NOTES

- $1. \ {\sf CONSTRUCT} \ {\sf SEDIMENT} \ {\sf FENCE} \ {\sf AS} \ {\sf CLOSE} \ {\sf AS} \ {\sf POSSIBLE} \ {\sf AND} \ {\sf PARALLEL} \ {\sf TO} \ {\sf THE} \ {\sf CONTOURS} \ {\sf OF} \ {\sf THE} \ {\sf SITE}.$
- 2. DRIVE 1.5 m LONG STAR PICKETS INTO GROUND Max 3 m Ctrs.
- 3. DIG A 150 mm DEEP TRENCH ALONG THE UPSLOPE LINE OF THE FENCE FOR THE BOTTOM OF THE FABRIC TO BE

ENTRENCHED.

4. BACKFILL TRENCH OVER BASE OF FABRIC.

5. FIX SELF SUPPORTING GEOTEXILE TO UPSLOPE SIDE OF POSTS WITH WIRE TIES OR AS RECOMMENDED BY GEOTEXILE MANUFACTURER.

6. JOIN SECTIONS OF FABRIC AT A SUPPORT POST WITH A Min LAP OF 150 mm.

\*THIS DRAWING SHALL BE READ IN CONJUNCTION WITH THE FOLLOWING:

1-ARCHITECTURAL PLANS
2-CONTOUR AND DETAIL SURVEY



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NOTE
The Builder shall check all dimensions and levels on site prior to construction. Notify any errors, discrepancies or omissions to the building designer. Refer to written dimensions only. Do not scale drawings. Drawings shall not be used for construction purposes until issued for construction. This drawing reflects a design by Innovative Eco Designs and is to be used only for work when authorised in writing by Innovative Eco Designs.

All boundaries and contours are subject to survey drawing. All levels to Australian Height Data. It is the contractors responsibility to confirm all measurements on site and locations of any services prior to work on site.



1:200

Sediment Control Plan





В	19/05/2025	Changes as per Council Letter
Α	24/01/2025	Issue for DA



DRAWING : Sediment Control Plan

CLIENT : Skymark Luxury Living Pty Ltd

PROJECT : DOUBLE STOREY DWELLING

#10,Raven circuit,Warriewood

Lot-10 D.P 271326


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GS 19/05/2025

SCALE: APPLICATION DA

PAGE SIZE PAGE NO:

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INNOVATIVE ECO DESIGNS



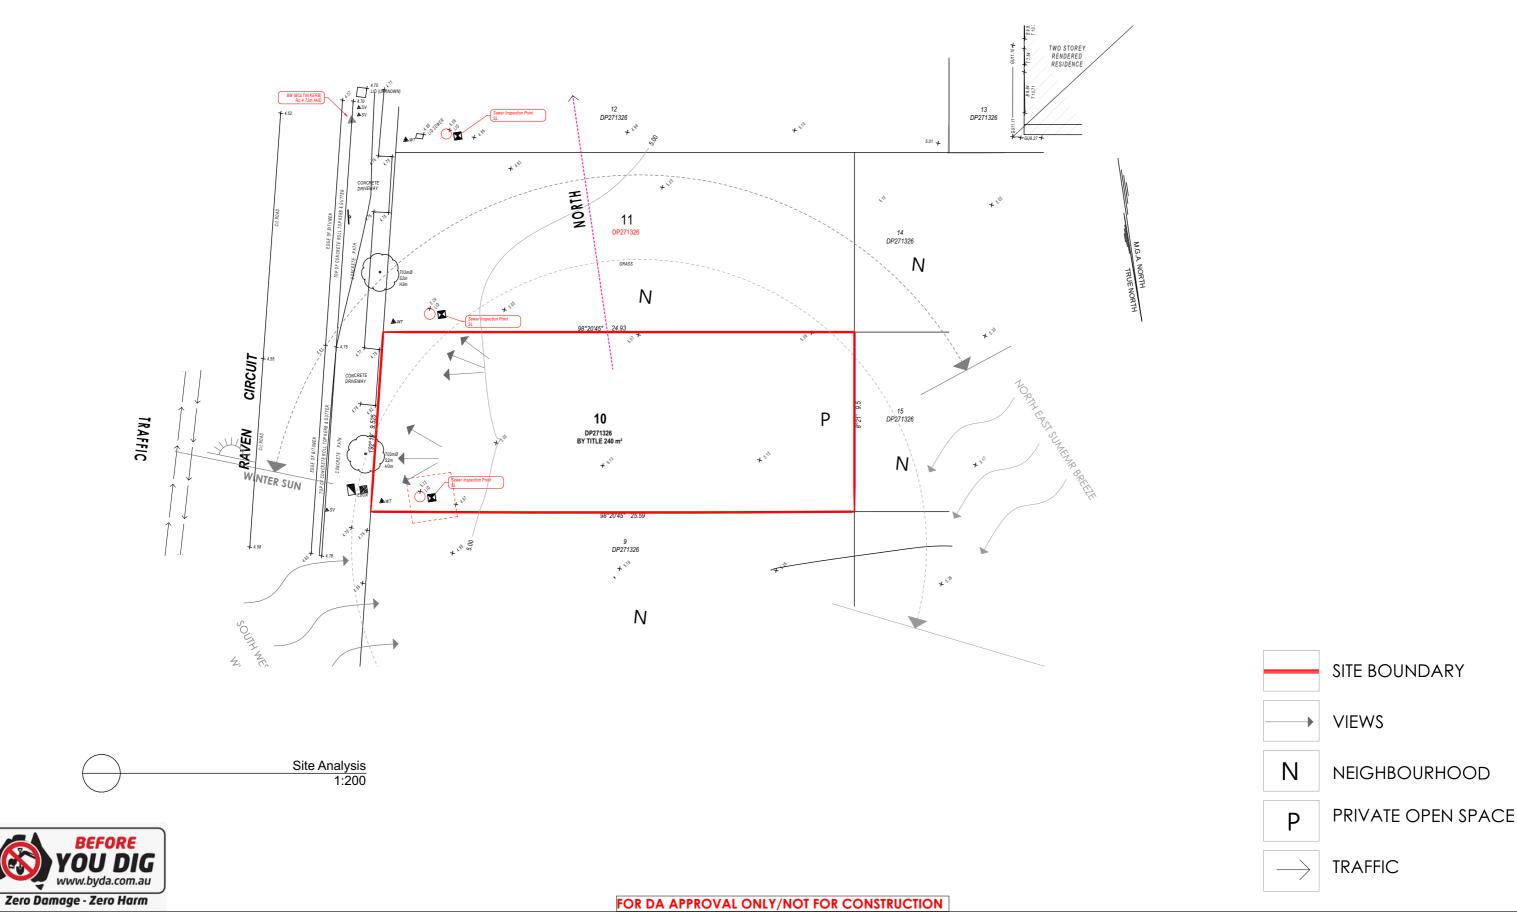

В	19/05/2025	Changes as per Council Letter
Α	24/01/2025	Issue for DA



DRAWING : Site Analysis

CLIENT: Skymark Luxury Living Pty Ltd PROJECT: DOUBLE STOREY DWELLING #10,Raven circuit,Warriewood

Lot-10 D.P 271326

DRAWN BY: GS SCALE: 1:200

PAGE SIZE


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DATE: 19/05/2025 APPLICATION DA PAGE NO:

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PROJECT NO. 2411 791

ISSUE B



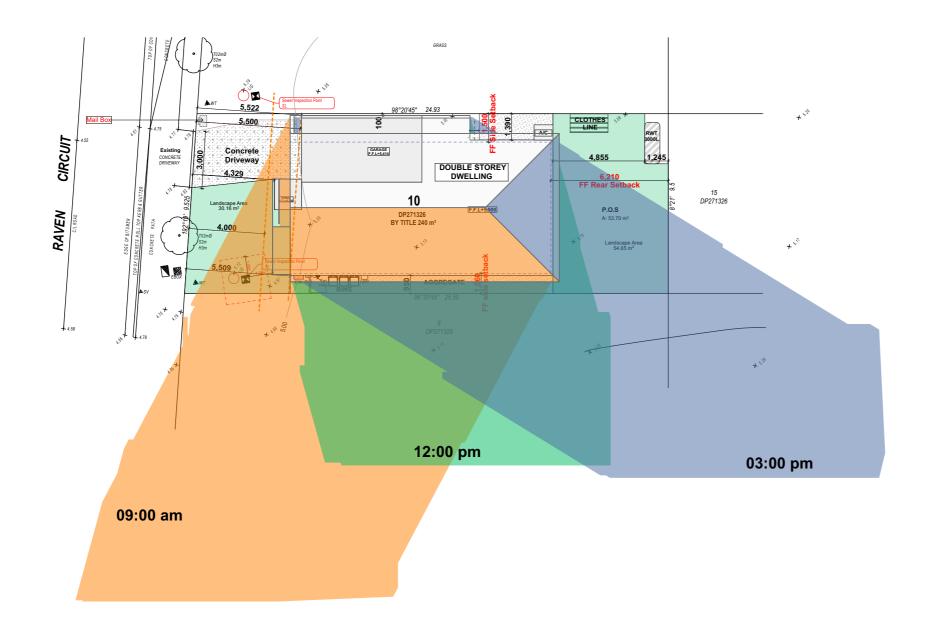

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В	19/05/2025	Changes as per Council Letter
Α	24/01/2025	Issue for DA
Α_	24/01/2025	Issue for DA




DRAWING	:Shadow Analysis
CLIENT:	Skymark Luxury Living Pty Ltd
PROJECT :	DOUBLE STOREY DWELLING
	#10 Deven sive vit Marris vased


Lot-10 D.P 271326

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GS	19/05/2025	2
SCALE: 1:200	APPLICATION :	ISS
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ROJECT NO. 2411 791 SUE B

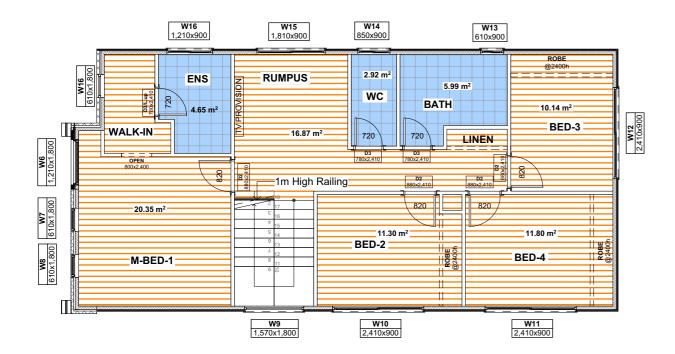

Floor Finish- First Floor 1:100

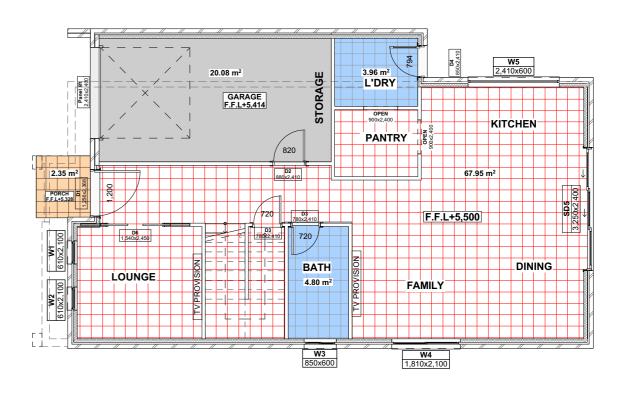

Floor Flnish- Ground Floor 1:100



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ACCREDITED
BUILDING DESIGNER

В	19/05/2025	Changes as per Council Letter
Α	24/01/2025	Issue for DA



DRAWING : Floor Finish	DRA
CLIENT: Skymark Luxury Living Pty Ltd	SC
PROJECT: DOUBLE STOREY DWELLING	1:
#10,Raven circuit,Warriewood	PAG

Lot-10 D.P 271326

Tile for wet area Timber finish RAWN BY: PROJECT NO. DATE: GS 19/05/2025 2411 791 CALE: APPLICATION 1:100 DA ISSUE AGE SIZE PAGE NO: B

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**LEGEND** 

Name Indoor Tiles

Outdoor Tiles

Concrete finish

Ref.img