
STORMWATER SERVICES 193 WHALE BEACH RD, WHALE BEACH NSW

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PROPOSED STORMWATER DRAINAGE EXISTING STORMWATER DRAINAGE PROPOSED SUB-SOIL DRAINAGE EXISTING SUB-SOIL DRAINAGE

SYMBOLS

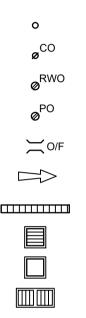

DOWNPIPE CLEAR OUT POINT RAIN WATER OUTLET PLANTER OUTLET **OVERFLOW** OVERLAND FLOW PATH PROPOSED TRENCH DRAIN PROPOSED STW PIT WITH GRATE PROPOSED STW PIT WITH COVER

EXISTING KERB INLET PIT

STORMWATER NOTES

- 1. CONFIRM LOCATION, SIZE, CONDITION AND LEVEL OF ALL EXISTING SERVICES PRIOR TO COMMENCEMENT OF WORK.
- 2. ALL WORK TO BE IN ACCORDANCE WITH LOCAL AUTHORITIES REQUIREMENTS, BCA AND RELEVANT AUSTRALIAN STANDARDS (IN PARTICULARLY AS 3500)
- 3. ALL DRAWINGS TO BE READ IN CONJUNCTION WITH ARCHITECTURAL AND OTHER CONSULTANTS DOCUMENTS. ALL DISCREPANCIES SHALL BE REFERRED TO THE PROJECT MANAGER BEFORE PROCEEDING WITH THE WORK.
- 4. LOCATION OF ALL DOWNPIPES, PITS AND PIPEWORK IS DIGRAMMATIC ONLY FINAL LOCATION TO BE CO-ORDINATED DURING CONSTRUCTION CERTIFICATE DOCUMENTATION.
- 5. ALL MATERIALS USED IN THE WORK SHALL BE NEW AND OF THE BEST QUALITY AND TYPE AVAILABLE TO CONFORM WITH THE RELEVANT AUSTRALIAN STANDARDS AND BEAR THE REQUIRED STANDARDS MARK AND WATERMARK.
- 6. MAKE ALL APPLICATIONS TO LOCAL COUNCIL. PAY ALL FEES AND OBTAIN ALL NECESSARY PERMITS AND APPROVALS AS REQUIRED BY THE AUTHORITIES.
- 7. PIPEWORK UP TO 225mm DIAMETER SHALL BE UPVC DRAINAGE WASTE GRADE WITH SOLVENT WELDED JOINTS.
- 8. PIPEWORK SHALL BE LAID AT 1:100 MINIMUM GRADE UNLESS NOTED OTHERWISE. PIPEWORK MAY BE LAID AT STEEPER GRADES AS REQUIRED TO MEET COVER REQUIREMENTS OR AS NOMINATED BY PIPEWORK INVERT LEVELS.
- 9. SUBSOIL PIPEWORK SHALL BE INSTALLED AS REQUIRED, INCLUDING BEHIND ALL RETAINING STRUCTURES, PLANTERS AND WHERE GROUND WATER IS ENCOUNTED. SHALL BE 90mm SLOTTED UPVC PIPE WRAPPED IN CLOTH SOCK AND SURROUNDED WITH 150mm THICKNESS OF 20mm DIAMETER BLUE METAL AND SURROUNDED IN GEOTEXTILE FABRIC.
- 10. ALL EXTERNAL LEVELS TO FALL AWAY FROM BUILDING. BUILDER TO ENSURE THRESHOLD REQUIREMENTS. OVERLAND FLOW PATHS TO BE MAINTAINED AROUND BUILDING TO PREVENT WATER INGRESS.
- 11. ALL LANDSCAPED AREAS LOCATED ABOVE CONCRETE SLABS TO BE EQUIPPED WITH DEDICATED OUTLET, WATERPROOFING MEMBRANE, DRAINAGE CELL AND GEOFABRIC.
- 12. SUBSOIL, UPLIFT PRESSURE, VERTICAL WALL DRAINAGE AND PIT CONSTRUCTION DETAILS TO BE CONFIRMED / CO-ORDINATED WITH STRUCTURAL AND GEOTECHNICAL ENGINEERS DURING CONSTRUCTION STAGE OF THE PROPOSED DEVELOPMENT.
- 13. ALL BALCONIES TO BE PROVIDED WITH SAFETY OVERFLOWS (FINAL LOCATION OF OVERFLOWS TO BE CONFIRMED BY ARCHITECT).

DRAWING SCHEDULE

DWG No	DESCRIPTION
SW01	COVER SHEET / SITE PLAN
SW02	EROSION / SEDIMENT CONTROL PLAN
SW03	STORMWATER- LEVELS 0, 1, 2 & ROOF PLANS

OSD & RAINWATER TANK CALCULATIONS

ALL IN ACCORDANCE WITH NORTHERN BEACHES COUNCIL'S STORMWATER REQUIREMENTS.

SITE AREA 835.m²

SITE IS LOCATED WITHIN REGION 1 NORTHERN CATCHMENT.


PROPOSED ADDITIONAL HARD IMPERVIOUS AREA UNDER 50m² THEREFORE OSD NOT REQUIRED.

RAINWATER TANK NOT REQUIRED FOR BASIX

STORMWATER PIT SIZES

MINIMUM INTERNAL MEASUREMENTS:					
DEPTH TO BASE			CIRCULAR	LADDER /	
OF CHAMBER	WIDTH	LENGTH		STEP IRON	
SMALLER THAN 600	450	450	600	NO	
601 TO 900	600	600	900	NO	
901 TO 1200	600	900	1050	NO	
GREATER THAN 1200	900	900	1050	YES	

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	REV DATE DESCRIPTION	

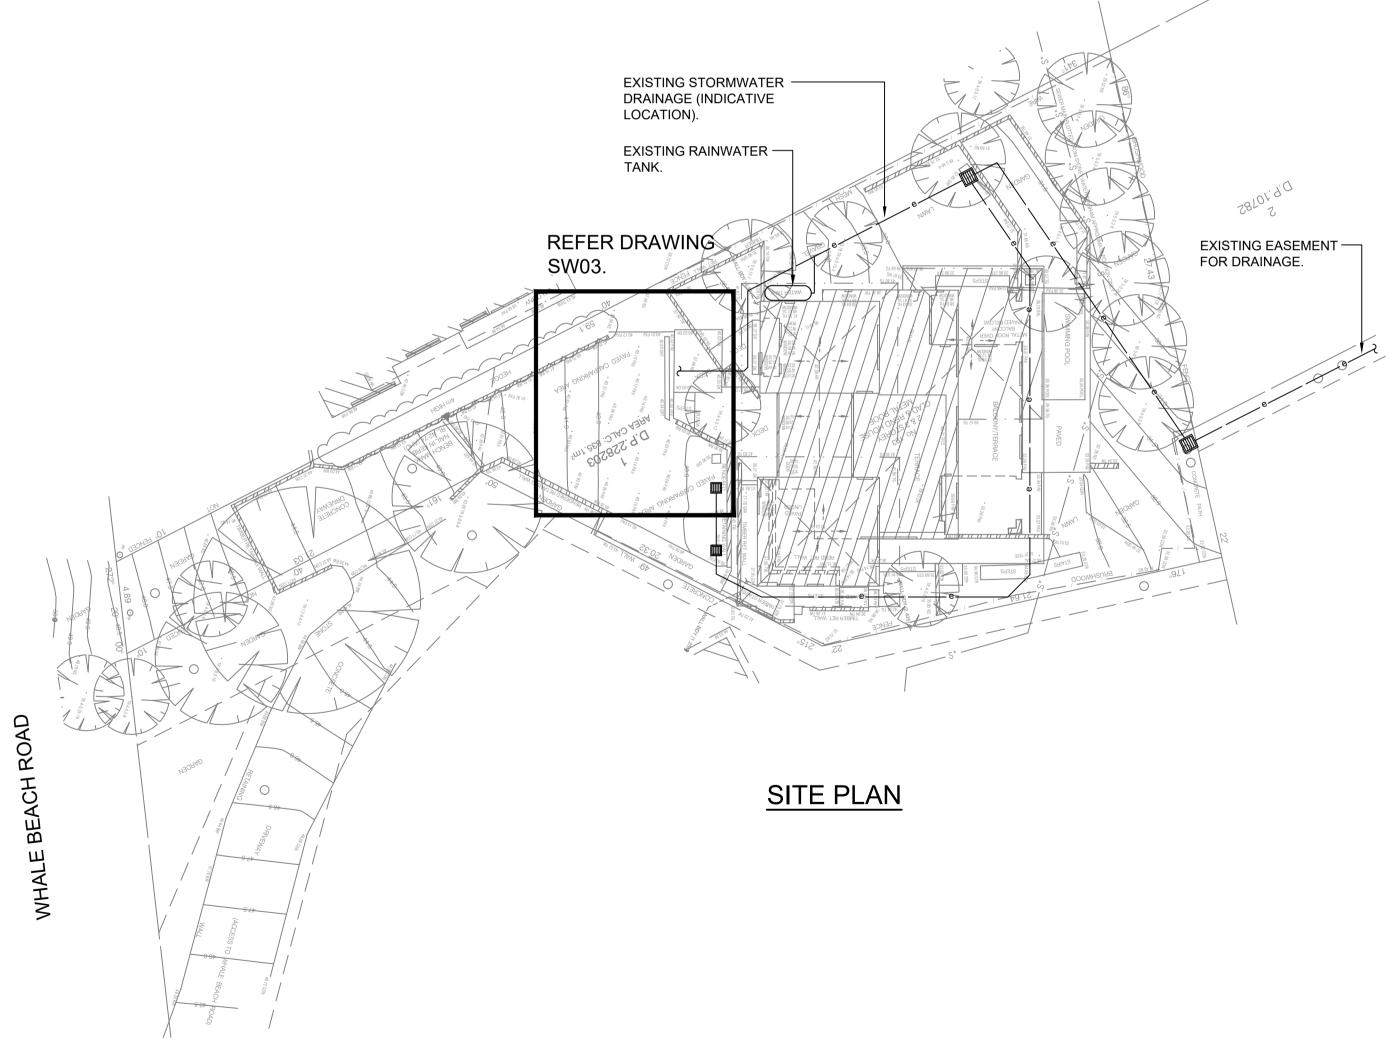

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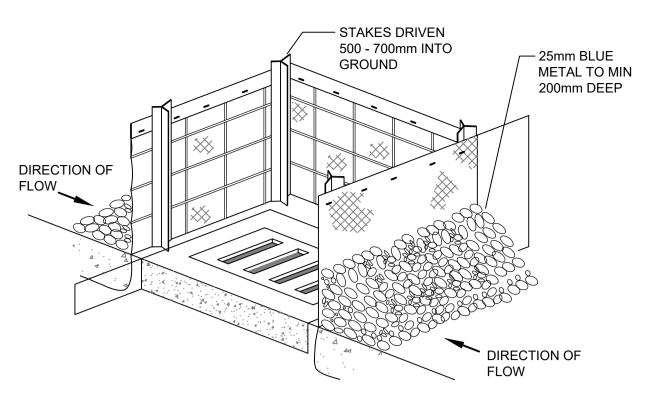
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PROJECT 193 WHALE BEACH ROAD WHALE BEACH NSW

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DRAWING TIT

RMWATER SERVICES	STATUS DA ISSUE					
/ER SHEET / SITE PLAN		drawn PB	engineer PC	CHECKED MA	SCALE 1:200@A1 1:400@A3	
	Ð	PROJECT No. P2025	-113	DRAWING No.	REVISION	



DETAIL: STORM INLET SEDIMENT TRAP

STORM INLET SEDIMENT TRAP

DESCRIPTION THESE ARE TEMPORARY DE-SILTING STRUCTURES.


SUCH SEDIMENT TRAPS ARE USED AT STORMWATER INLETS AND OUTLETS, CULVERT ENTRIES AND POINTS WHERE RUN-OFF FROM DISTURBED CATCHMENTS SUCH AS CONSTRUCTION SITES IS DISCHARGED.

GENERAL REQUIREMENTS

SEDIMENT TRAPS ARE BUILT FROM STRAW BALES, WASHED GRAVEL, GABIONS OR SANDBAGS (OR SARLON TYPE MATERIALS) FILLED WITH BLUE METAL. THE CHOICE OF MATERIAL OR TYPE OF STRUCTURE DEPENDS ON THE SIZE OF THE DRAINAGE AREA AND THE PHYSICAL STRUCTURE SURROUNDING THE SEDIMENT TRAP. CONSTRUCTION MATERIALS TO BE CONFIRMED BY COUNCIL.

MAINTENANCE

SEDIMENT TRAPS SHOULD BE REGULARLY MAINTAINED AND RESTORED TO THEIR ORIGINAL DIMENSIONS WHEN THE SEDIMENT HAS ACCUMULATED TO HALF OF THE DESIGNED CAPACITY. THE OUTLET SHOULD BE CONSTRUCTED AND MAINTAINED TO ENSURE EROSION DOES NOT OCCUR. MAINTENANCE PROGRAM SHALL BE AS REQUESTED BY COUNCIL.

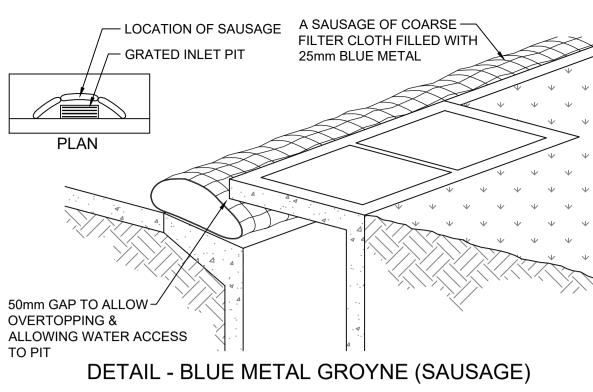

BLUE METAL GROYNE (SAUSAGE)


DESCRIPTION

THE GROYNE COMPRISES A SAUSAGE OF SHADE CLOTH OR OTHER PREVIOUS FABRIC, SOME 200mm DIAMETER, FILLED WITH 25mm BLUE METAL AND CLOSED BOTH ENDS.

INSTALLATION


THE SAUSAGE IS LAID ON THE GROUND ON THE CONTOUR SIMILAR TO A SILT FENCE. GENERALLY THE SAUSAGE SHOULD BE LAID TWO HIGH TO OBTAIN ENOUGH FILTER AREA.

THE GROYNES SHOULD BE LOCATED ACROSS THE ENTRY DRIVEWAY TO THE SITE AND AROUND THE NEAREST DOWNSTREAM KERB ENTRY PITS.

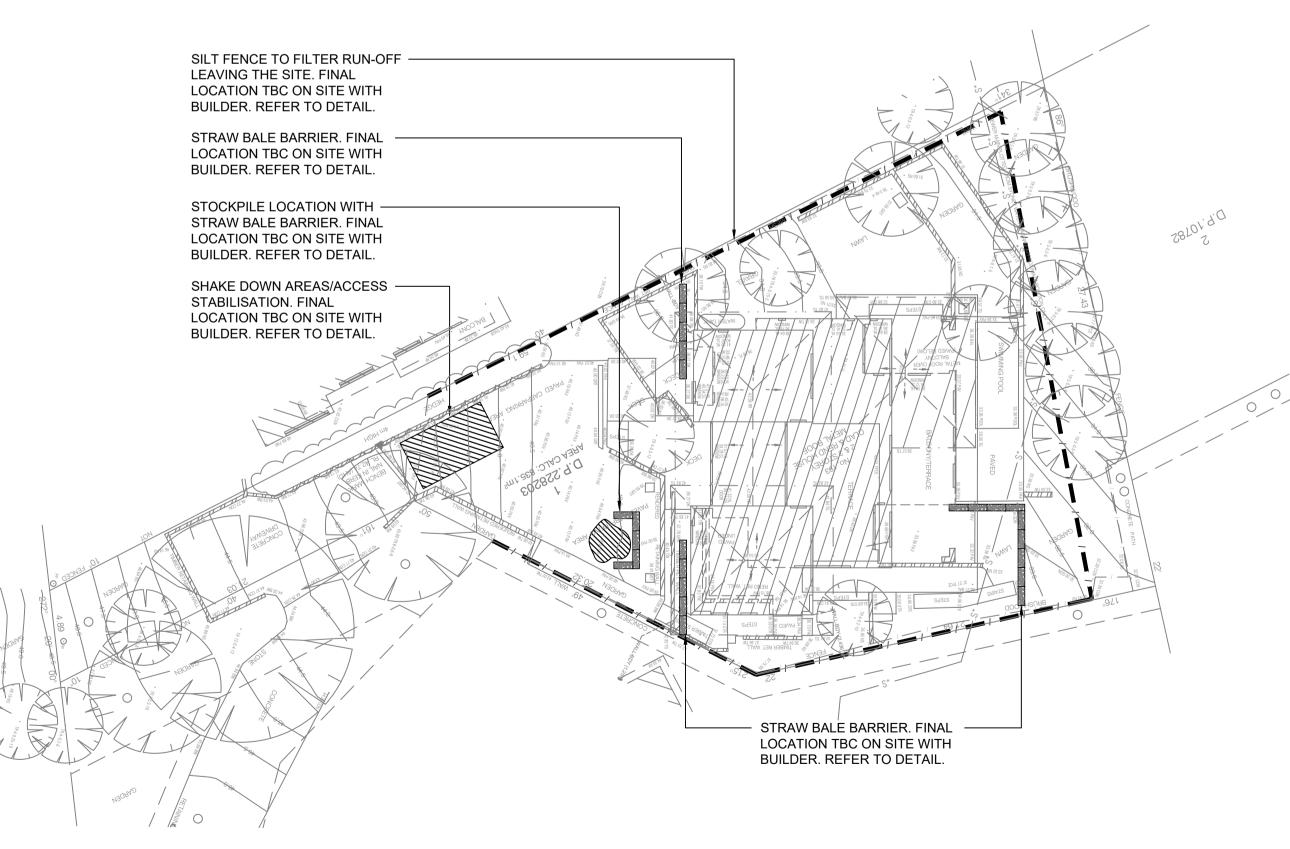

SEDIMENT & EROSION CONTROL PLAN SCALE 1:200

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DETAIL - SILT FENCES

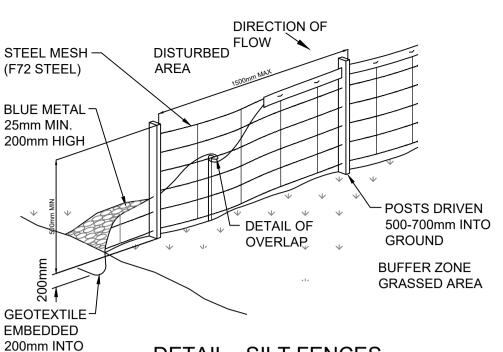SILT FENCES DESCRIPTION

GROUND.

SILT FENCES ARE TEMPORARY BARRIERS MADE FROM A COMBINATION OF FILTER CLOTH AND BLUE METAL

SILT FENCES FILTER RUN-OFF LEAVING THE SITE TRAPPING THE SEDIMENT AND ALLOWING CLEAN FILTERED WATER TO PASS. SILT FENCES ARE TO BE PLACED ON THE CONTOUR OR SLIGHTLY CONVEX TO THE CONTOUR. IF ON THE CONTOUR, EACH END OF THE FENCE SHOULD BE TURNED UP TO CREATE A 'STILLING POND' UP SLOPE OF THE FENCE. WHERE POSSIBLE, A SILT FENCE SYSTEM SHOULD BE NO LONGER THAN ABOUT 20 METRES. THEY SHOULD NOT INTERCEPT LARGE CONCENTRATED OR CHANNELISED FLOWS.


INSTALLATION

THE AREA BELOW A SILT FENCE MUST BE UNDISTURBED ON STABLISED GROUND.

MAINTENANCE

SILT FENCES REQUIRE REGULAR MAINTENANCE. TRAPPED SEDIMENTS SHOULD BE REMOVED, PICKETS STRAIGHTENED, FILTER CLOTH RESECURED AND TIGHTENED AND BLUE METAL REPLACED WHEN HEAVILY CONTAMINATED WITH SILT.

FILTER FABRIC SHALL BE EQUIVALENT TO 'GEOLAB' AND BE CAPABLE OF INTERCEPTING SILT PARTICLES DOWN TO 2 MICRON IN SIZE.

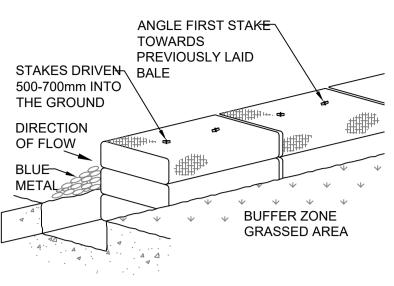

DETAIL - STRAW BALE BARRIERS

STRAW BALE BARRIERS

DESCRIPTION A TEMPORARY BARRIER OF STRAW BALES PLACED AROUND THE PERIMETER OF A DISTURBED AREA.

USAGE

STRAW BALE BARRIERS ARE USED TO DESILT CONTAMINATED WATER

INSTALLATION STRAW BALES ARE ONLY EFFECTIVE ON SITES OF LESS THAN HALF A HECTARE. THE BALES SHOULD BE PLACED LENGTHWISE IN 100mm DE TRENCHES WITH THEIR BINDING ROPE HORIZONTAL TO THE GROUND

THE BALES SHOULD BE CONNECTED AND ANCHORED TO THE GROUN DRIVING TWO STAR PICKETS OR POSTS THROUGH EACH BALE. THE F STAKE MUST BE DRIVEN TOWARDS THE ADJOINING BALE AT A 45° ANG TO FORCE THE BALES TOGETHER.

MAINTENANCE

AFTER RAINFALL STRAW BALE BARRIERS SHOULD BE INSPECTED AND SEDIMENT REMOVED. DAMAGED BALES SHOULD BE REPAIRED OR REPLACED BALES HAVE A LIFE EXPECTANCY OF THREE TO SIX MONTHS.

THE LOCATION OF STRAW BALES ON THE ABOVE SITE PLAN IS

DIAGRAMMATIC ONLY. THE REQUIREMENT FOR THE USAGE OF STRAW BALES IS TO BE AS A SUPPLEMENTARY MEASURE TO ASSIST THE SILT FENCES. FINAL LOCATIONS AND EXTENT OF STRAW BALES TO BE DETERMINED BY THE COUNCIL.

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EROSION & SEDIMENT CONTROL NOTES

MINIMUM REQUIREMENTS

GENERAL

PROVIDE ON SITE CONTROLS THROUGHOUT THE ENTIF ENSURE MINIMUM EROSION AND SEDIMENT LOSS.

ENSURE LEAST DISTURBANCE TO SITE.

AS EACH AREA IS COMPLETED, THAT AREA IS TO BE IMMEDIATELY/PROGRESSIVELY SEEDED AND FERTILISE FENCES, STRAW BALES OR OTHER CONTROLS NEED T PROVIDED UNTIL THE SITE IS STABLE. SHOULD THIS AP BE PRACTICAL THE PROGRESSIVE REVEGETATION OF AREAS WILL BE REQUIRED.


WHERE THERE IS GRADE ON OTHER AREAS OF THE SIT LEAD TO EROSION, FURTHER APPROPRIATE TREATME LOCATED TO CONTROL EROSION i.e. STRAW BALES

THE PROVISION AND MAINTENANCE OF (SEDIMENT) SIL WILL BE NECESSARY DURING THE CONSTRUCTION PHA INSTRUCTED BY THE COUNCIL PROGRESSIVELY REMOV SECTIONS OF SILT FENCES FOR CLEANING. CLEANING TO BE CARRIED OUT DURING PERIODS OF DRY WEATH

FILL AREAS

RUN-OFF AND SEDIMENT LOSS FROM THE AREAS OF F CONTROLLED DURING AND AFTER CONSTRUCTION, BE REVEGETATION TAKES PLACE USING SILT FENCES AND BALES AS INSTRUCTED BY THE PROJECT MANAGER/CC DIRECT WATER FROM THE DISTURBED AREA. OTHER M SHALL BE CARRIED OUT AS DIRECTED BY THE COUNCIL SHOWN ON THE PLANS.

PROJECT 193 WHALE BEACH ROAD WHALE BEACH NSW

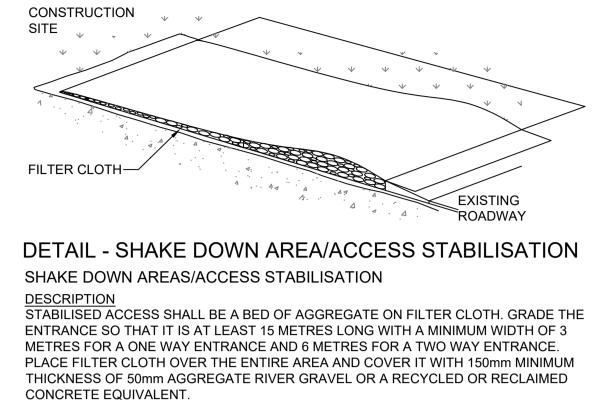


A EEP D.	<u>USAGE</u> SUCH STRUCTURES SHALL BE USED AT ALL POINTS WHERE CONSTRUCTION VEHICLES ENTER OR LEAVE THE SITE AND EXISTING ROADWAYS.
ND BY	TREATMENT/MAINTENANCE
FIRST NGLE	SURFACE WATER FLOWING TO THE ENTRANCE MUST BE PIPED UNDER THE ENTRANCE, OR A BERM CONSTRUCTED TO DIRECT SURFACE FLOW AWAY FROM THE ROAD.

ALL DEPOSITS ARE TO BE REGULARLY CLEARED FROM SITE ACCESS. THE DRAWBAR, TAILGATE ETC OF ANY VEHICLE INVOLVED IN THE TRANSPORT OF GRAVEL ETC TO A CONSTRUCTION SITE MUST BE MANUALLY CLEANED OF MATERIAL BEFORE THE VEHICLE LEAVES THE SITE. SHOULD THE MATERIAL BE DEPOSITED ON THE ROADWAY ETC, SUCH MATERIAL SHALL BE SWEPT AND REMOVED FROM THE ROADWAY.

STORMWATER SERVICES **EROSION / SEDIMENT** CONTROL PLAN

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LEVEL 1
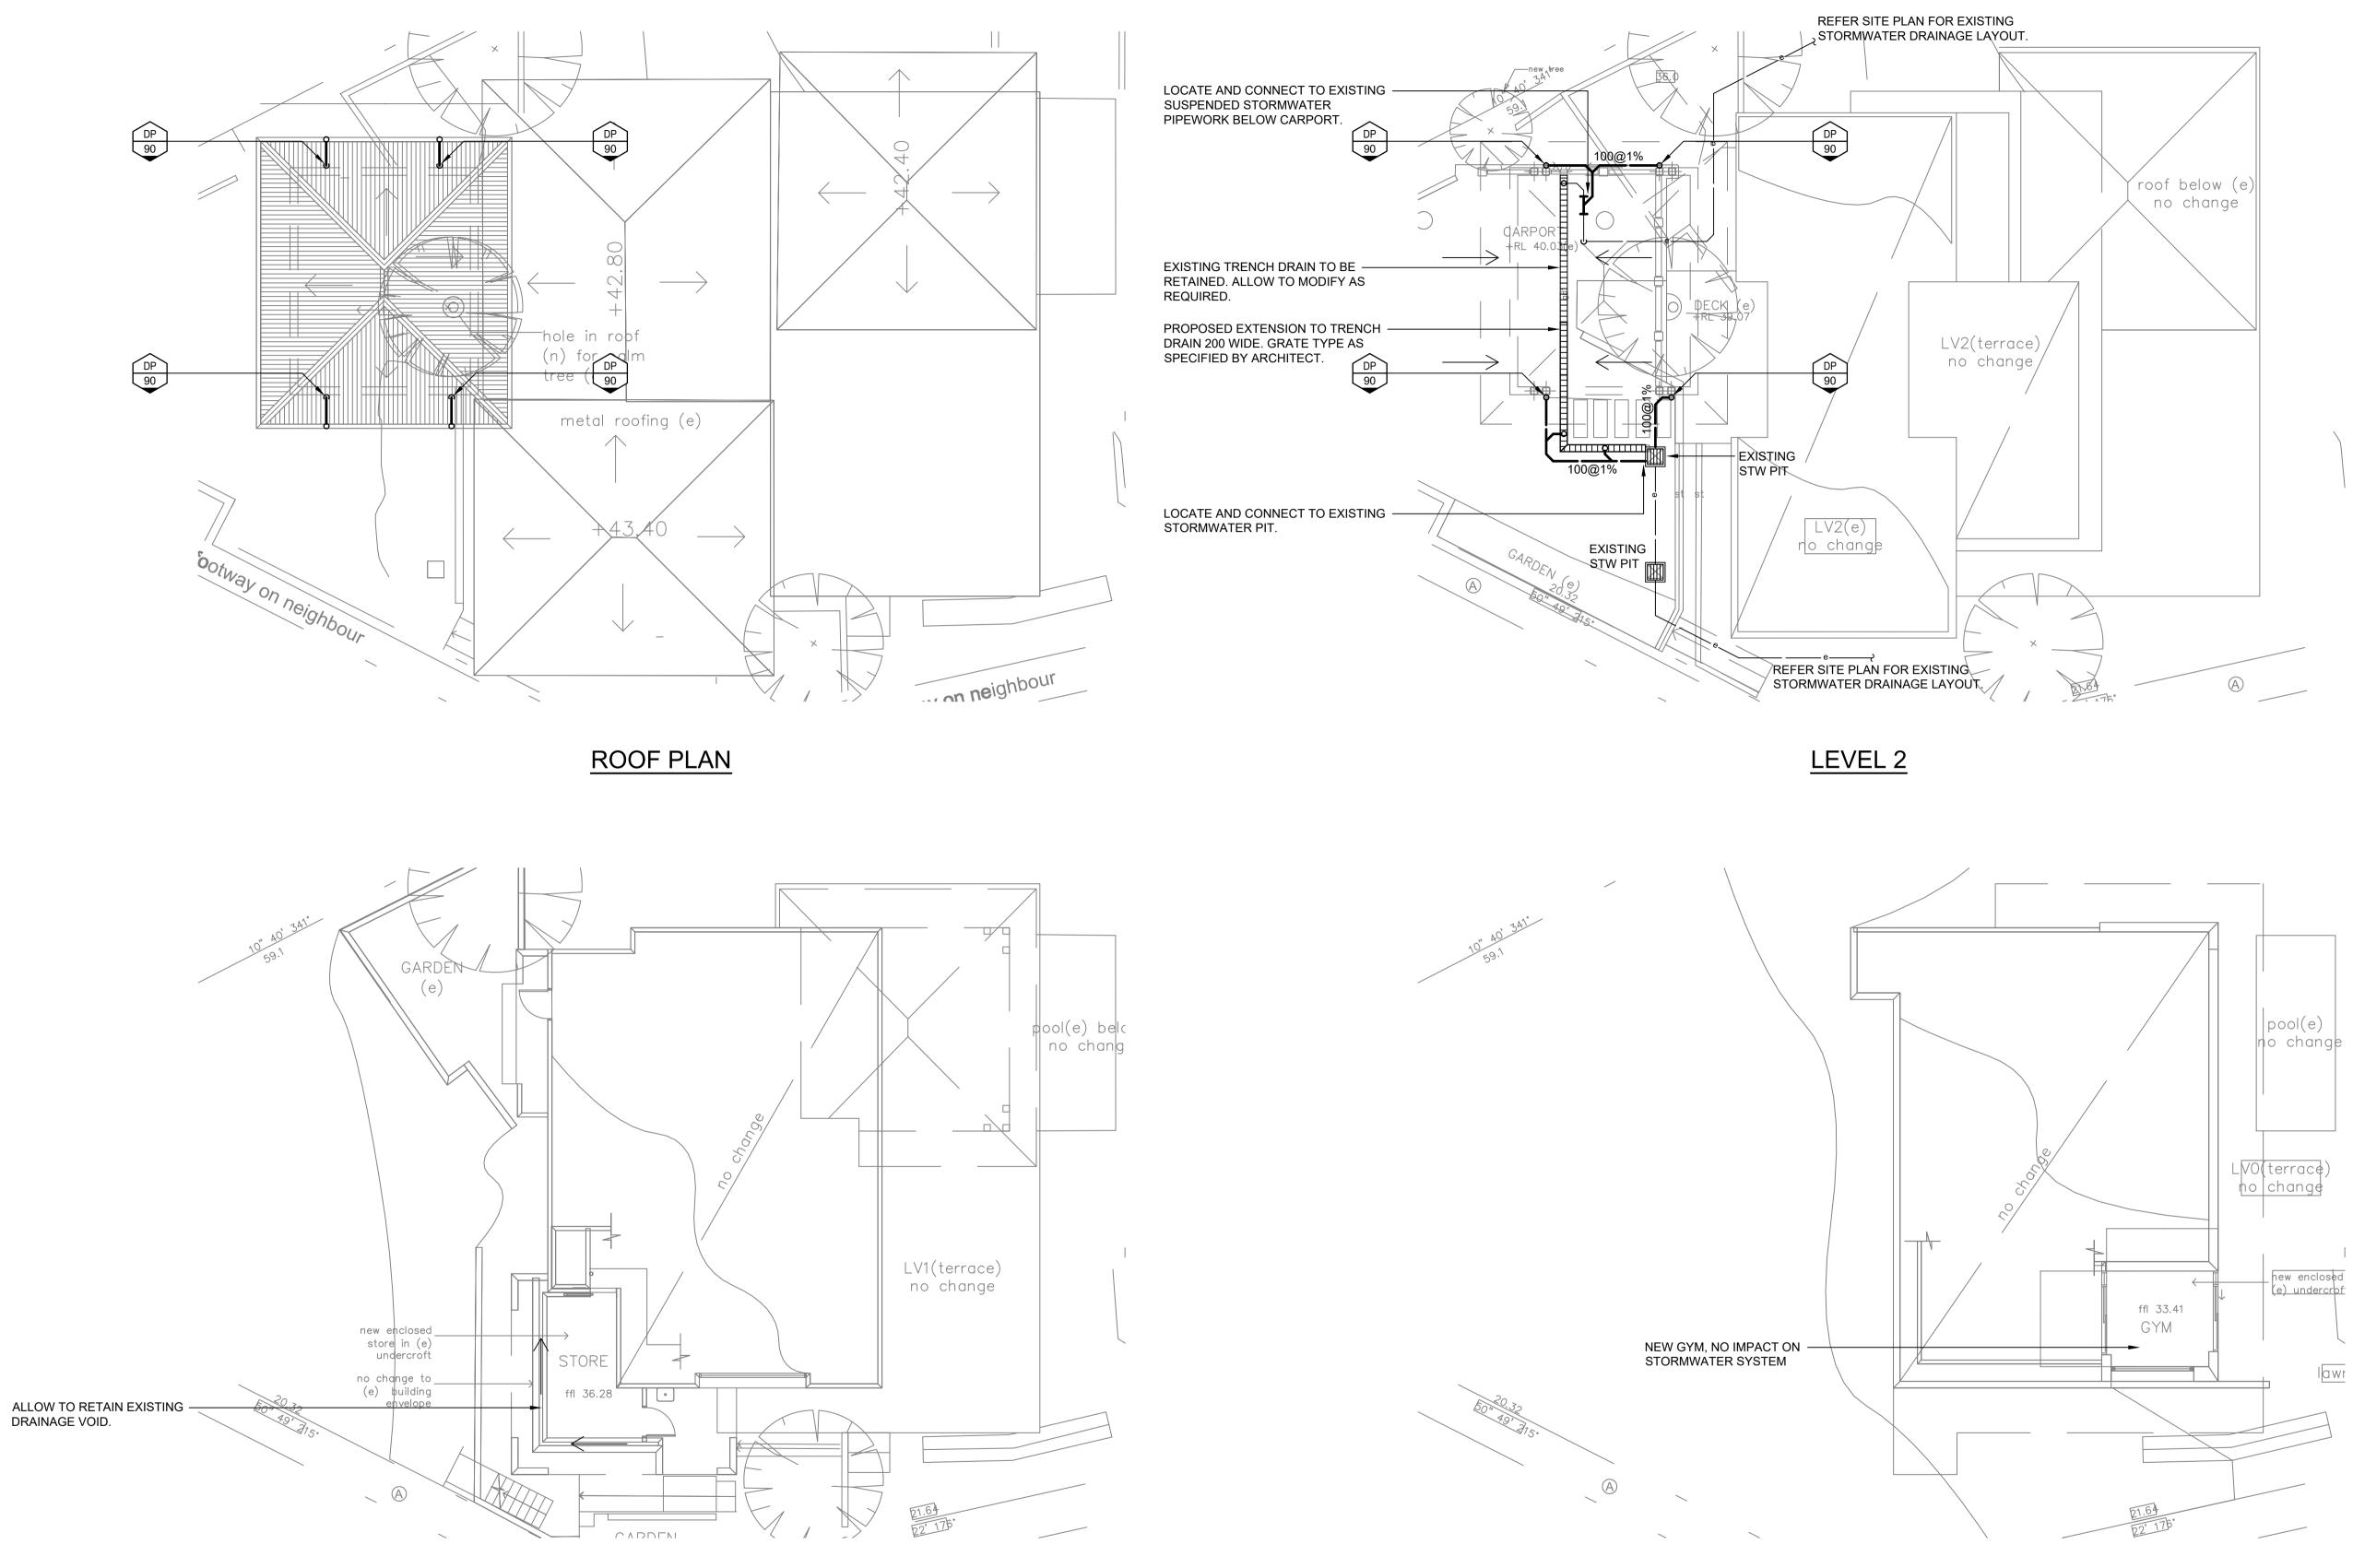
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NOT FOR CONSTRUCTION
 FINAL LOCATION OF ALL DOWNPIPES, PITS, RAINWATER OUTLETS AND SUBSOIL PIPES TO BE CONFIRMED

LANDSCAPING DRAINAGE

- ALL LANDSCAPED AREAS LOCATED ABOVE CONCRETE SLABS TO BE EQUIPPED WITH WATERPROOFING MEMBRANE, DRAINAGE CELL AND GEOFABRIC.
- FINAL LOCATION OF ALL DRAINAGE PITS, OUTLETS AND PIPEWORK IN LANDSCAPE AREAS SHALL BE CO-ORIDINATED WITH THE LANDSCAPE ARCHITECT DURING CONSTRUCTION STAGE.

GEOTECHNICAL & STRUCTURAL ADVICE

SUBSOIL, UPLIFT PRESSURE, VERTICAL WALL DRAINAGE AND PIT CONSTRUCTION DETAILS TO BE CO-ORDINATED WITH STRUCTURAL AND GEOTECHNICAL ENGINEERS DURING CONSTRUCTION STAGE.

EXTERNAL LEVELS

EXTERNAL SURFACE LEVELS SHALL HAVE STEP DOWN AND ADEQUATE SLOPE AS PER NCC / BCA REQUIREMENTS.
THE EXTERNAL FINISHED SURFACE MUST BE DRAINED TO MOVE SURFACE WATER AWAY FROM THE BUILDING.

INSPECTION OPENINGS

INSPECTION OPENINGS MUST BE PROVIDED AT ALL JUNCTIONS, CHANGE IN GRADIENT, CHANGE IN DIRECTION AND CHANGE IN DIAMETER FOR ACCESS AND MAINTENANCE PURPOSES (NOT SHOWN ON PLAN FOR CLARITY).

DRAWING TITLE STORMWATER SERVICES	STATUS DA ISSUE				
LEVELS 0, 1, 2 & ROOF		drawn PB	engineer PC	CHECKED MA	SCALE 1:100@A1 1:200@A3
	Ð	РКОЈЕСТ No. P2025	-113	DRAWING No.	REVISION