

EXACT LOCATION OF ALL EROSION AND SEDIMENT CONTROL DEVICES TO BE DETERMINED ON SITE BY THE BUILDER AND THE RELEVANT COUNCIL INSPECTOR.

## **EROSION & SEDIMENT CONTROL NOTES:**

- 1. ALL SEDIMENT AND EROSION CONTROL MEASURES SHALL BE IN ACCORDANCE WITH "MANAGING URBAN STORMWATER - SOILS AND CONSTRUCTION - VOLUME 1" MARCH 2004 BY LANDCOM.
- 2. SOIL EROSION AND SEDIMENT CONTROL MEASURES SHALL BE SET IN PLACE PRIOR TO ANY WORKS COMMENCING.
- 3. ALL SOIL EROSION AND SEDIMENT CONTROL MEASURES SHALL BE INSTALLED TO THE SATISFACTION AND DIRECTION OF THE COUNCIL'S ENGINEER.
- 4. THE CONTRACTOR SHALL REGULARLY MAINTAIN ALL SEDIMENT AND EROSION CONTROL DEVICES AND REMOVE ACCUMULATED SILT FROM SUCH DEVICES BEFORE NO MORE THAN %60 OF THEIR CAPACITY IS LOST. NO SILT SHALL BE PLACED OUTSIDE THE LIMIT OF WORKS.
- 5. ALL DISTURBED AREAS SHALL BE STABILISED BY MEANS OF LANDSCAPING, TURF OR RE-VEGETATION AS SOON AS POSSIBLE.
- 6. THESE DRAWINGS OUTLINE THE MINIMUM MEASURES TO BE TAKEN TO CONTROL EROSION AND TO ARREST THE TRANSPORT OF SEDIMENT. ADDITIONAL MEASURES MAY BE REQUIRED TO SUIT STAGING OF WORKS OR AS DIRECTED BY THE SUPERVISOR OR COUNCIL'S ENGINEER.


CONSTRUCTION BATTER TO BE CONFIRMED ON

DIVERSION CHANNEL &

SITE

SILT FENCE~

BUND

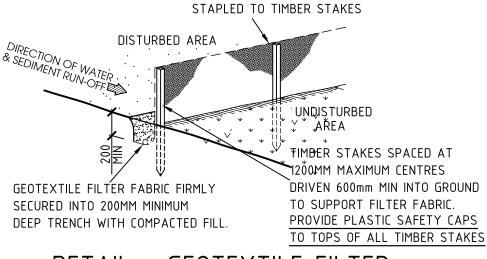

TEMPORARY STOCKPILE

BUND

GEOTEXTILE FILTER FABRIC

TYPICAL TEMPORARY STOCKPILE

SITE

DIVERSION CHANNEL &

COVER WITH IMPERMEABLE

MEMBRANE

NOT TO SCALE

CONSTRUCTION BATTER


SILT FENCE

TO BE CONFIRMED ON

# DETAIL - GEOTEXTILE FILTER FABRIC FENCE. NOT TO SCALE


EXACT LOCATION OF GEOTEXTILE FILTER FENCE TO BE DETERMINED ON SITE BY THE BUILDER AND RELEVANT COUNCIL ENGINEER.

В	19.08.21	Amended as per Owners requests	H Not to scale I		PROPOSED ALTERATIONS & ADDITIONS AT			
Α	0 7.04.21	Amended as per Certifiers requests			LOT 80, DP11449, No.75 PARKES ROAD,			
ISSUE	DATE	REVISION	DATE:		COLLAROY PLATEAU, NSW, 2097.			
	■ IT IS THE RESPONSIBILITY OF THE BUILDER TO CONFIRM ALL NEW		18th February 2021		FOR: MR M. BLAKE.			
	DIMENSIONS BEFORE THE COMMENCEMENT OF ANY BUILDING WORK AND THE ORDERING OF MATERIALS,  DO NOT SCALE OFF DRAWING use all specified dimensions.		SHEET: ISSUE:		TON: TIN TI. DEANE.			
			2 of 8	В	EROSION & SEDIMENT CONTROL DETAILS	A3 SHEET		

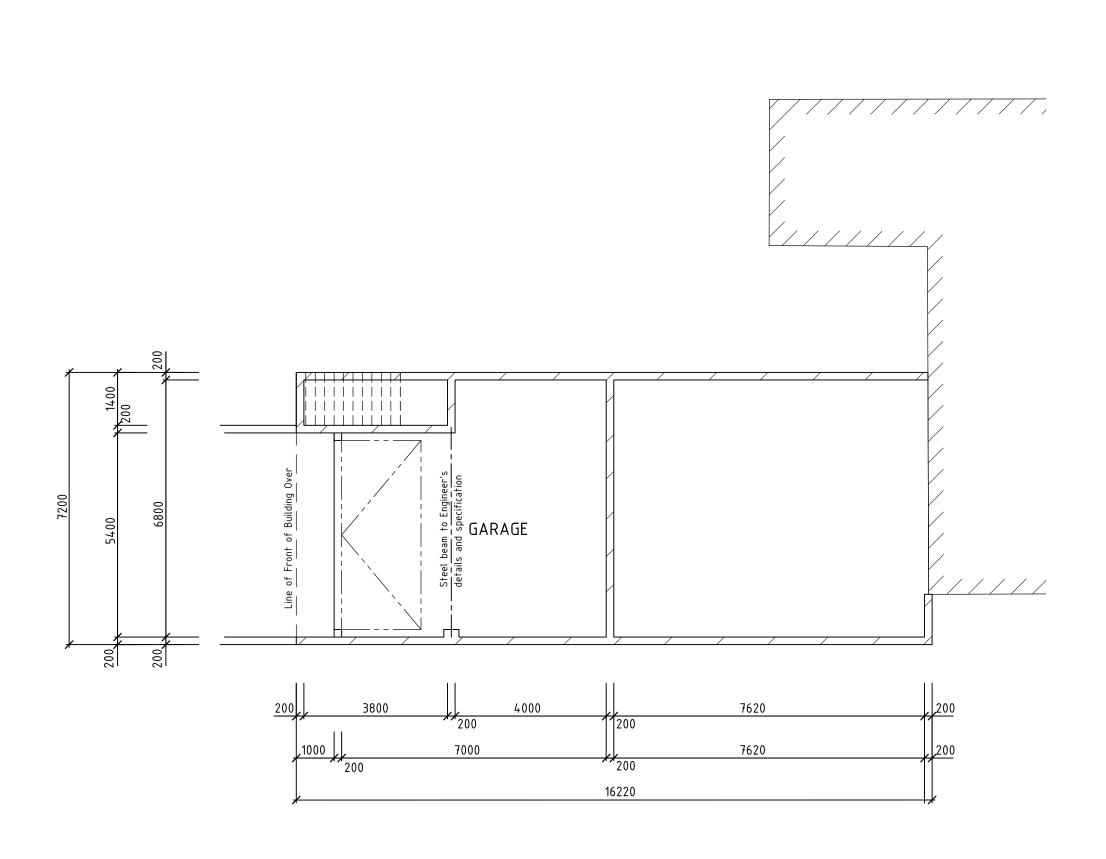

# PLAN - NEW GARAGE FLOOR LAYOUT. SCALE 1:100

В	19.08.21	Amended as per Owners requests	1 1·100 L		PROPOSED ALTERATIONS & ADDITIONS A	Γ
Α	07.04.21	Amended as per Certifiers requests			LOT 80, DP11449, No.75 PARKES ROAD,	
ISSUE				COLLADOY DIATEALI NOW 2007		
		BIBILITY OF THE BUILDER TO CONFIRM ALL NEW	18th Febr 	ruary 2021	FOR: MR M. BLAKE.	
DIM	DIMENSIONS BEFORE THE COMMENCEMENT OF ANY BUILDING		SHEET	ISSUE:	FUR: MR M. DLAKE.	
WC	WORK AND THE ORDERING OF MATERIALS.		]	l R	CDOUND FLOOD DLAN LAVOUT	A 2 CHEET
<b>-</b> DC	DO NOT SCALE OFF DRAWING use all specified dimensions.		3 of 8	D	GROUND FLOOR PLAN LAYOUT.	A3 SHEET

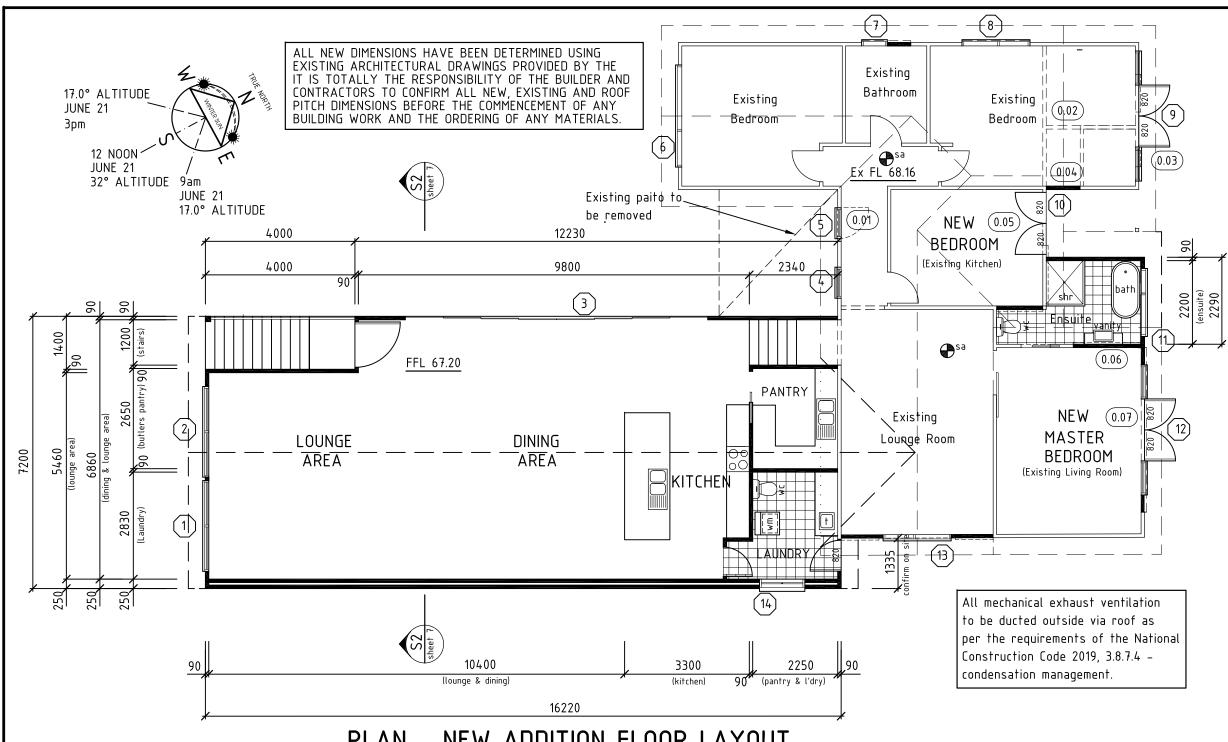

WINDOW S	SCHEDULE
WINDOW/GLAZED DOOR No. height x width	WINDOW TYPE
1 - 2.4 x 2.4	Aluminium louvre
2 - 2.4 x 2.4	Aluminium louvre
3 - 2.4 x 8.0	Aluminium Stacker
4 - 2.1 x 0.9	Aluminium louvre
5 - 2.1 x 0.9	Aluminium louvre
6 - 2.145 x 2.635	Aluminium louvre
7 - 1.75 x 0.68	Aluminium louvre
8 - 1.785 x 1.835	Aluminium louvre
9 - 2/2.1 x 0.9 + 2.1 x 0.9	Aluminium Hinged doors & Aluminium Double Hung
10 - 2/2.1 x 0.9	Aluminium Hinged doors
11 - 1.785 x 1.835	Aluminium louvre
12 - 2/2.1 x 0.9 + 2.1 x 0.9	Aluminium Hinged doors & Aluminium Double Hung
(13) - 2.235 x 1.835	Aluminium louvre
14 - 0.9 x 1.2	Aluminium slider

# PLAN - NEW ADDITION FLOOR LAYOUT.

SCALE 1:100

# SCHEDULE OF ALTERATIONS & ADDITIONS:

- (0.01) Existing entry door to be removed and fill in opening with new aluminium framed sliding window. Exact size of window to be confirmed by Builder and window manufacturer/supplier.
- (0.02) Existing timber wall frames to be removed.
- (0.03) Existing windows to be removed and replace with new french doors with sidelight windows. Exact size of windows and doors to be confirmed by Builder and window manufacturer/supplier.
- (0.04) Provide new timber wall framing. External wall cladding to match existing cladding as closely as possible.
- Existing door & window to be removed and fill in opening with two new aluminium framed hinged doors. Exact size of doors to be confirmed by Builder and window manufacturer/supplier.

- (0.06) Existing window and wall to be removed and provide new timber wall framing.
- (0.07) Existing windows to be removed and replace with new french doors with sidelight windows. Exact size of windows and doors to be confirmed by Builder and window manufacturer/supplier.
- All construction, workmanship and materials to be in accordance with the Specification, National Construction Code and any other relevant codes.
- Termite protection to be provided in accordance with the requirements of AS3660.1 and to the Council's requirements.
- Smoke alarm to be provided and in stalled in accordance with Australian Standard AS3786-2014 and to the BCA requirements. (shown  $\P$ <sup>sa</sup> on plan). Smoke alarm to be provided in existing area of dwelling if smoke alarm is not already provided. Exact number and locations to be determined by the Builder/owner

В	19.08.21	Amended as per Owners requests	nsts 1:100		PROPOSED ALTERATIONS & ADDITIONS AT LOT 80, DP11449, No.75 PARKES ROAD, COLLAROY PLATEAU, NSW, 2097.			
Α	07.04.21	Amended as per Certifiers requests						
ISSUE	DATE	REVISION						
	■ IT IS THE RESPONSIBILITY OF THE BUILDER TO CONFIRM ALL NEW		18th February 2021		FOR: MR M. BLAKE.			
DIN	MENSIONS BEF	ORE THE COMMENCEMENT OF ANY BUILDING	SHEET:	ISSUE:	TOR: MR M. DLAKE.			
WC	ORK AND THE	ORDERING OF MATERIALS.	, , ,	В	CDOUND FLOOD DLAN LAVOUT	۸٦ CUEET		
<b>-</b> DC	NOT SCALE	OFF DRAWING use all specified dimensions.	4 of 8	D	GROUND FLOOR PLAN LAYOUT.	A3 SHEET		

## COMPULSORY "BASIX" CERTIFICATION REQUIREMENTS.

## FIXTURES & SYSTEMS

#### Liaht

The applicant must ensure a minimum of 40% of new or altered light fixtures are fitted with fluorescent, compacted light, or light-emitting-diode (LED) lamps.

#### Firtures

The applicant must ensure new or altered showerheads have a flow rate no greater than 9 litres per minute or a 3 star rating.

The applicant must ensure new or altered toilets have a flow rate no greater than 4 litres per average flush or a minimum 3 star rating.

The applicant must ensure new or altered taps have a flow rate no greater than 9 litres per minute or a 3 star rating.

#### CONSTRUCTION

#### Insulation Requirements

The applicant must construct the new or altered construction (floor(s), walls, ceilings/roofs) in accordance with the specification listed in the table below, except that a) additional insulation is not required where the area of new construction is less than  $2m^2$ , b) insulation specified is not required for parts of altered construction where insulation already exists.

CONSTRUCTION	ADDITIONAL INSULATION REQUIRED (R-value)	OTHER SPECIFICATIONS		
suspended floor with enclosed subfloor: framed (R0.7)	R1.30 (or R1.70 including construction)			
suspended floor above garage: framed (R0.7)	nil			
external wall: framed (weatherboard, fibro metal clad)	R1.30 (or R1.70 including construction)			
raked ceiling, pitched/skillion roof: framed	ceiling: R3.00 (up), roof: foil/sarking	medium (solar absorptance 0.475 – 0.70)		

## GLAZING REQUIREMENTS

#### Windows and Glazed Doors

The applicant must install the windows, glazed doors and shading devices, in accordance with the specifications listed in the table below. Relevant overshadowing specifications must be satisfied for each window and glazed door.

The following requirements must be satisfied in relation to each window and glazed door:

Each window or glazed door with standard aluminium or timber frames and single clear or toned glass may either match the description, or, have a U-value and Solar Heat Gain Coefficient (SHGC) no greater than that listed in the window schedule. Total system U-values & SHGC's must be calculated in accordance with National Fenestration Rating Council (NFRC) conditions.

Each window or glazed door with improved frames, or pyrolytic low-e glass, or clear/air gap/clear glazing must have a U-value and a Solar Heat Gain Coffecient (SHGC) no greater than that listed in the table below. Total system U-values and SHGC's must be calculated in accordance with National Federation Rating Council (NFRC) conditions. The description is provided for information only. Alternative systems with complying U-value and SHGC may be substituted.

For Projections described in millimetres, the leading edge of each eave, pergola, verandah, balcony or awning must be no more than 500mm above the head of the window or glazed door and no more than 2400mm above the sill.

Pergolas with polycarbonate roof or similar translucent material must have a shading coefficient of less than 0.35

Pergolas with fixed battens must have battens parallel to window or glazed door above which they are situated, unless the pergola also shades a perpendicular window. The spacing between battens must not be more than 50mm.


WINDOW SCHEDULE (In accordance with Basix Certificate requirements)						
WINDOW/GLAZED DOOR No.	ORIENTATION	MAXIMUM AREA (m²)	FRAME & GLAZING TYPE			
1 - 2.4 x 2.4	South	5.76	standard aluminium, single clear, (or U-value: 7.63, SHGC: 0.75)	none		
2 - 2.4 x 2.4	South	5.76	standard aluminium, single clear, (or U-value: 7.63, SHGC: 0.75)	none		
3 - 2.4 x 8.0	West	19.2	standard aluminium, single clear, (or U-value: 7.63, SHGC: 0.75)	awning (adjustable) >=900mm		
4 - 2.1 x 0.9	South	1.89	standard aluminium, single clear, (or U-value: 7.63, SHGC: 0.75)	eave/verandah/pergola/ balcony >=450mm		
5 - 2.1 x 0.9	South	1.89	standard aluminium, single clear, (or U-value: 7.63, SHGC: 0.75)	eave/verandah/pergola/ balcony >=450mm		
6 - 2.145 x 2.635	South	5.65	standard aluminium, single clear, (or U-value: 7.63, SHGC: 0.75)	eave/verandah/pergola/ balcony >=450mm		
7 - 1.75 × 0.68	West	1.19	standard aluminium, single clear, (or U-value: 7.63, SHGC: 0.75)	external louvre/ (adjustable)		
8 - 1.785 x 1.835	West	3.28	standard aluminium, single clear, (or U-value: 7.63, SHGC: 0.75)	external louvre/ (adjustable)		
9 - 2/2.1 x 0.9 + 2.1 x 0.9	North	8.0	standard aluminium, single pyrolytic low-e, (or U-value: 5.7, SHGC: 0.47)	eave/verandah/pergola/ balcony >=450mm		
10 - 2/2.1 x 0.9	North	3.87	standard aluminium, single pyrolytic low-e, (or U-value: 5.7, SHGC: 0.47)	eave/verandah/pergola/ balcony >=900mm		
11 - 1.785 x 1.835	North	3.28	standard aluminium, single pyrolytic low-e, (or U-value: 5.7, SHGC: 0.47)	eave/verandah/pergola/ balcony >=450mm		
12 - 2/2.1 x 0.9 + 2.1 x 0.9	North	8.0	standard aluminium, single pyrolytic low-e, (or U-value: 5.7, SHGC: 0.47)	eave/verandah/pergola/ balcony >=450mm		
(13) - 2.235 x 1.835	East	4.10	standard aluminium, single pyrolytic low-e, (or U-value: 5.7, SHGC: 0.47)	eave/verandah/pergola/ balcony >=450mm		
14 - 0.9 x 1.2	East	1.19	standard aluminium, single clear, (or U-value: 7.63, SHGC: 0.75)	external louvre/ (adjustable)		


В	19.08.21	Amended as per Owners requests	SCALES:		
Α	07.04.21	Amended as per Certifiers requests Not applic		plicable	
ISSUE	DATE	DATE REVISION			
■ IT IS THE RESPONSIBILITY OF THE BUILDER TO CONFIRM ALL NEW			18th February 2021		
DIMENSIONS BEFORE THE COMMENCEMENT OF ANY BUILDING			SHEET:	ISSUE:	
WO	RK AND THE	F - 4 0			
= DO	NOT SCALE	5 of 8	D		


PROPOSED ALTERATIONS & ADDITIONS AT LOT 80, DP11449, No.75 PARKES ROAD, COLLAROY PLATEAU, NSW, 2097. FOR: MR M. BLAKE.

BASIX CERTIFICATE REQUIEREMENTS

A3 SHEET

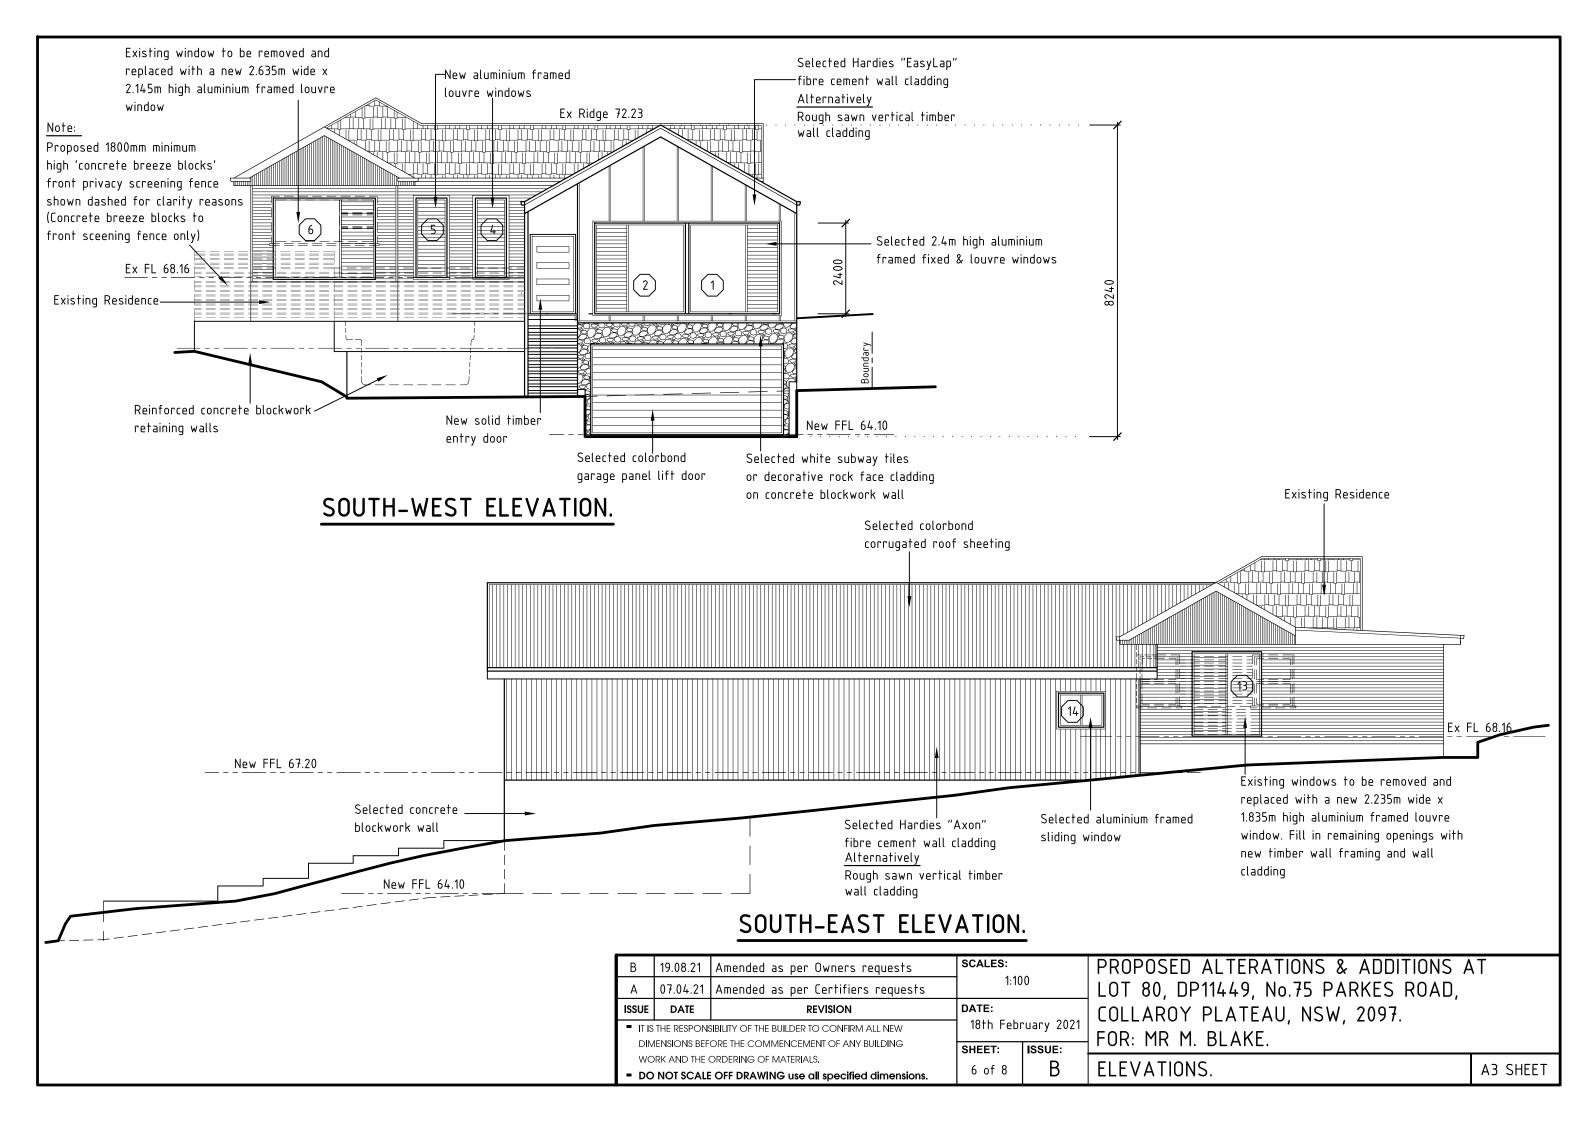


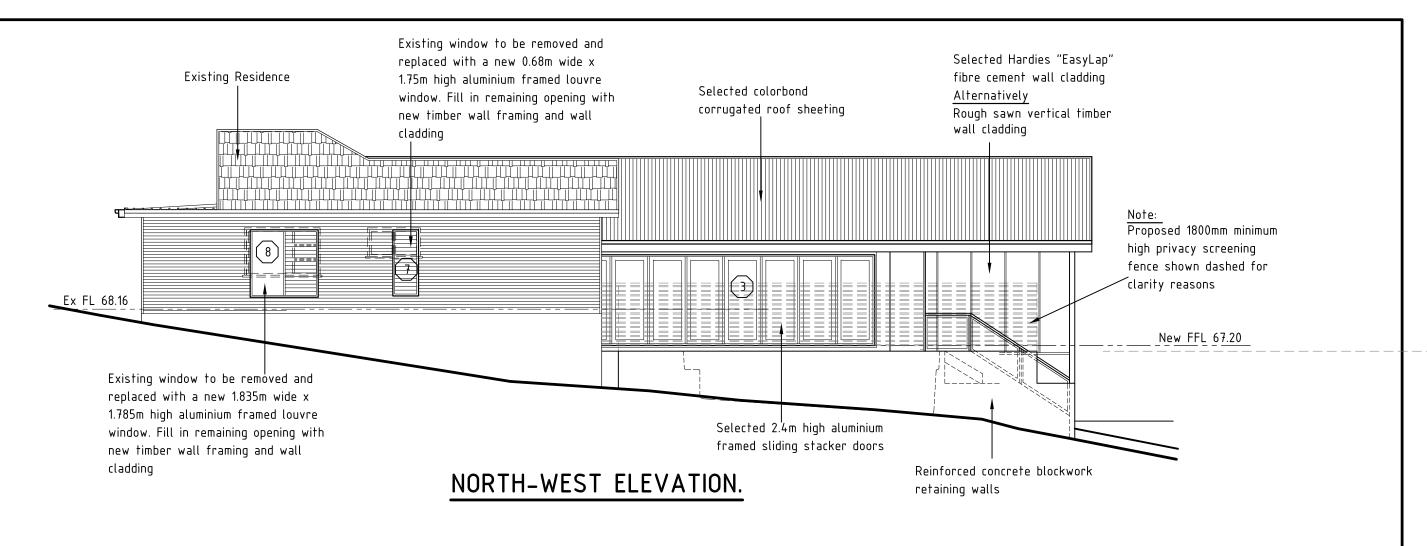


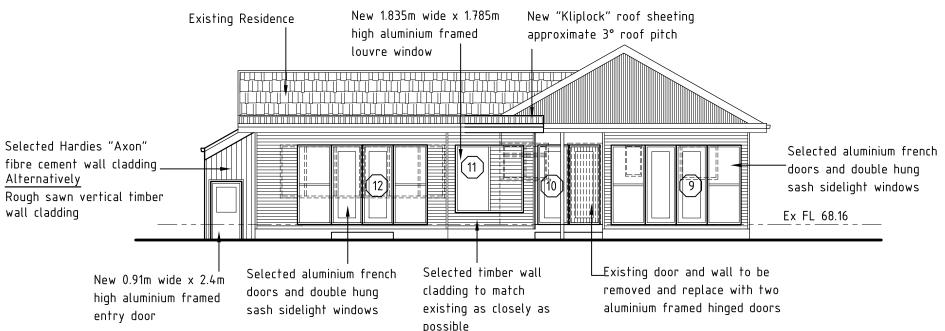


# NORTH-EAST ELEVATION.

<u>В</u> А		Amended as per Owners requests  Amended as per Certifiers requests	1:100		PROPOSED ALTERATIONS & ADDITIONS A  LOT 80, DP11449, No.75 PARKES ROAD,	ΛT	
ISSUE	ISSUE DATE REVISION		DATE: 18th February 2021 SHEET: ISSUE:		COLLAROY PLATEAU, NSW, 2097.		
	■ IT IS THE RESPONSIBILITY OF THE BUILDER TO CONFIRM ALL NEW DIMENSIONS BEFORE THE COMMENCEMENT OF ANY BUILDING				FOR: MR M. BLAKE.		
	WORK AND THE ORDERING OF MATERIALS.  DO NOT SCALE OFF DRAWING use all specified dimensions.		7 of 8	В	ELEVATIONS.	A3 SHEET	

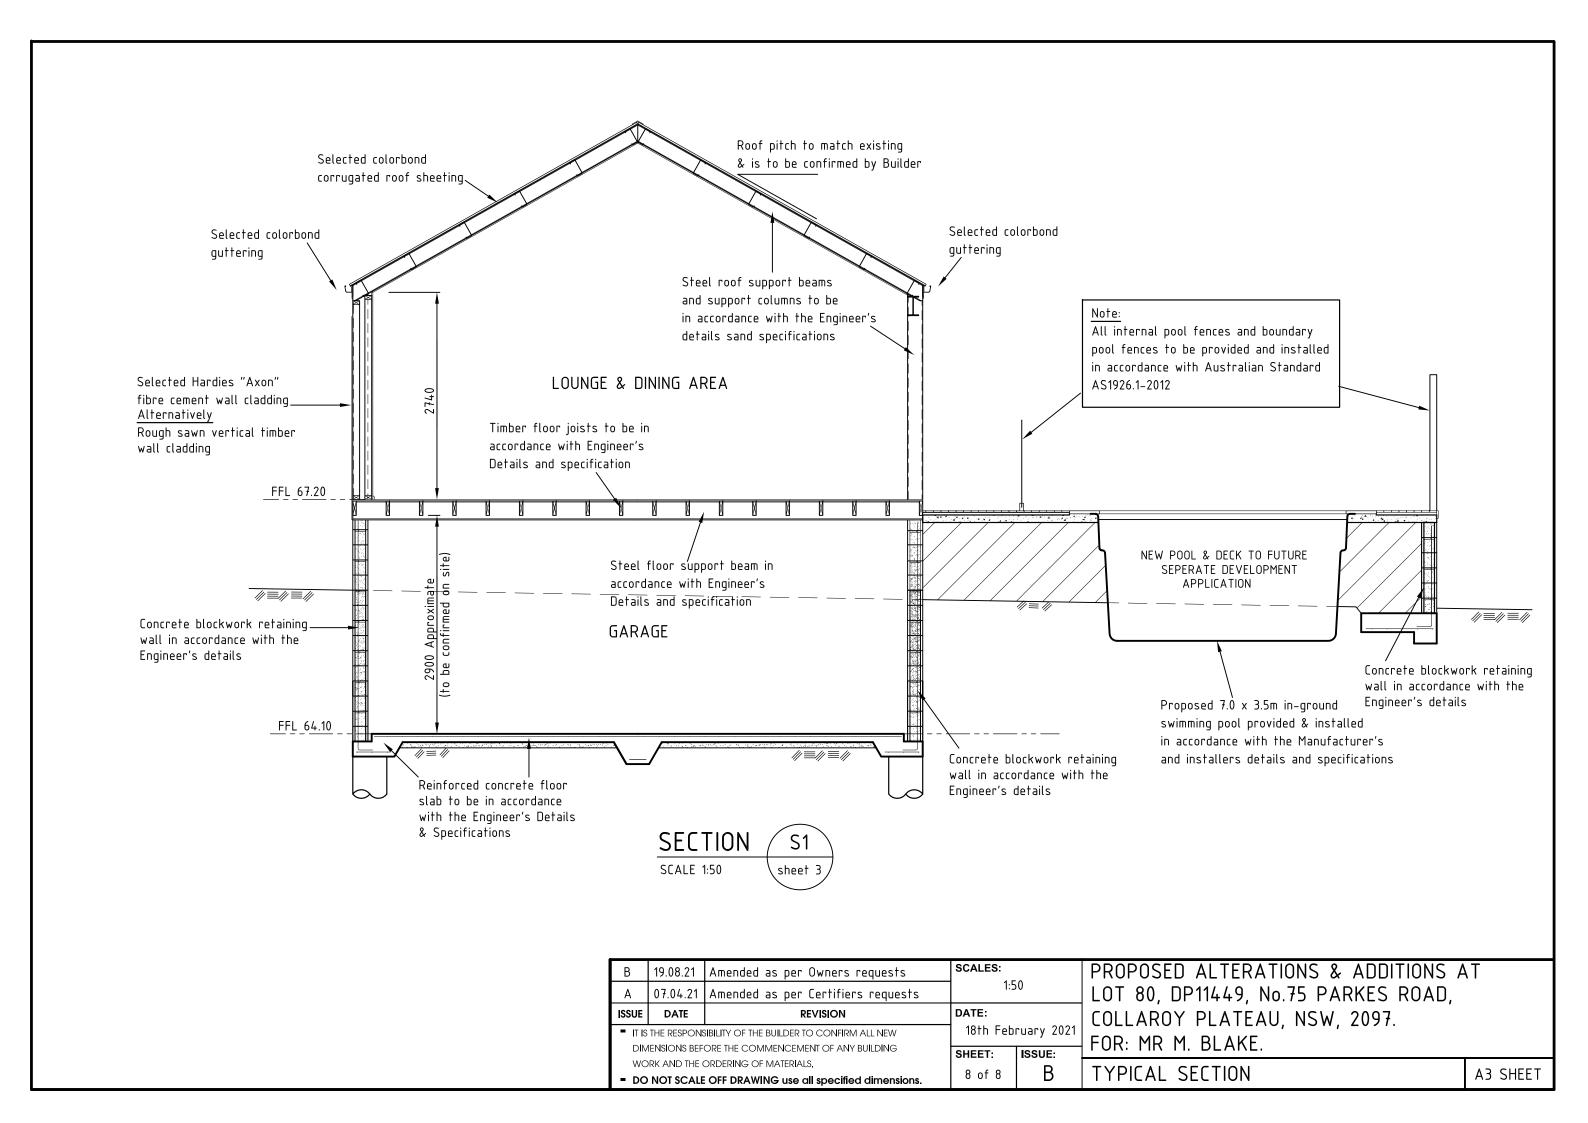

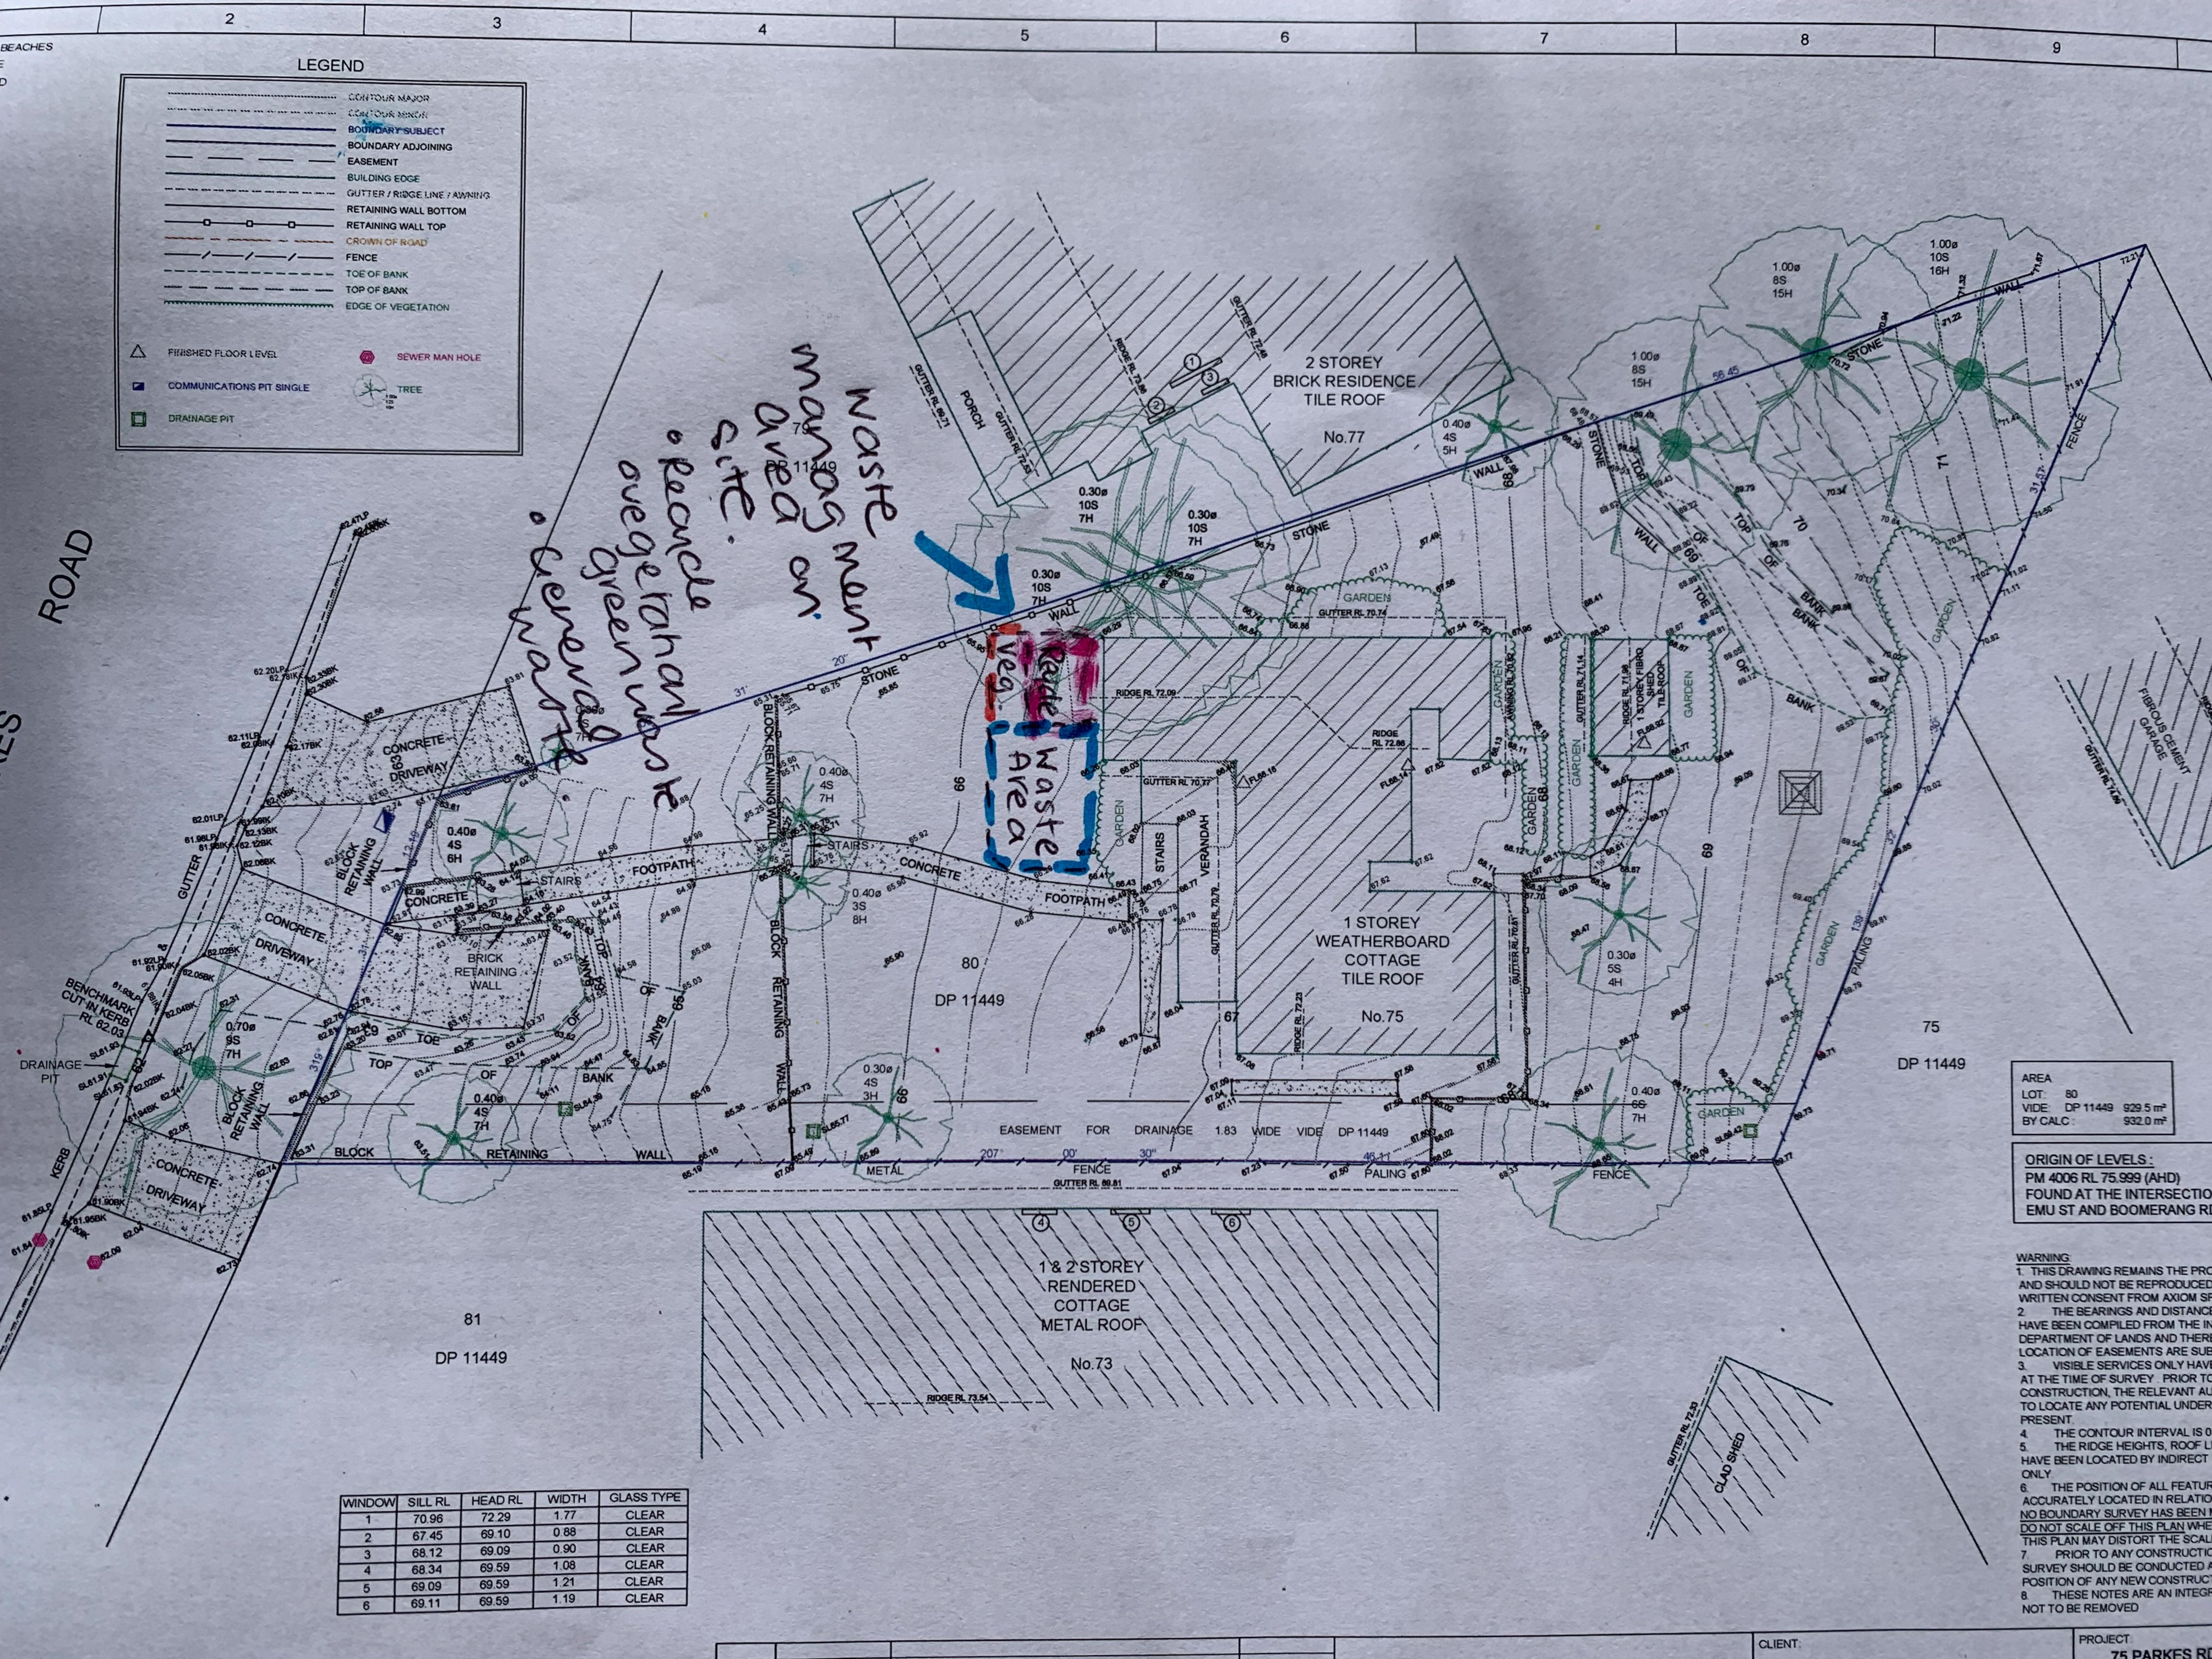

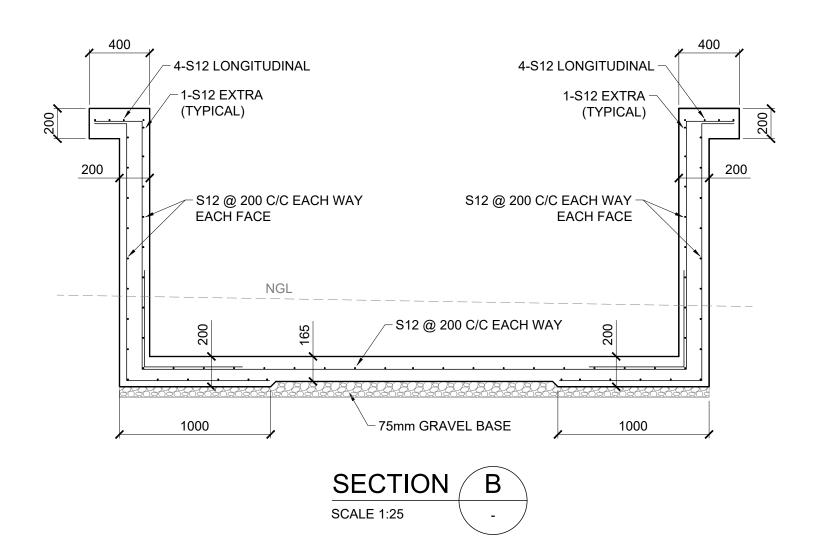


			Client	
			Architect	
REVISION	AMENDMENT	DATE		eliot@



2/25 Seabeach Avenue, Mona Vale				
eliot@greenwoodengineers.com.au	ABN - 90 625 916 341			

F	Project	Drawn	Designed	Date	
	,				
		Checked	Approved	Scale	
			l		
	Title	Drawing number			Revision
		-			
11					

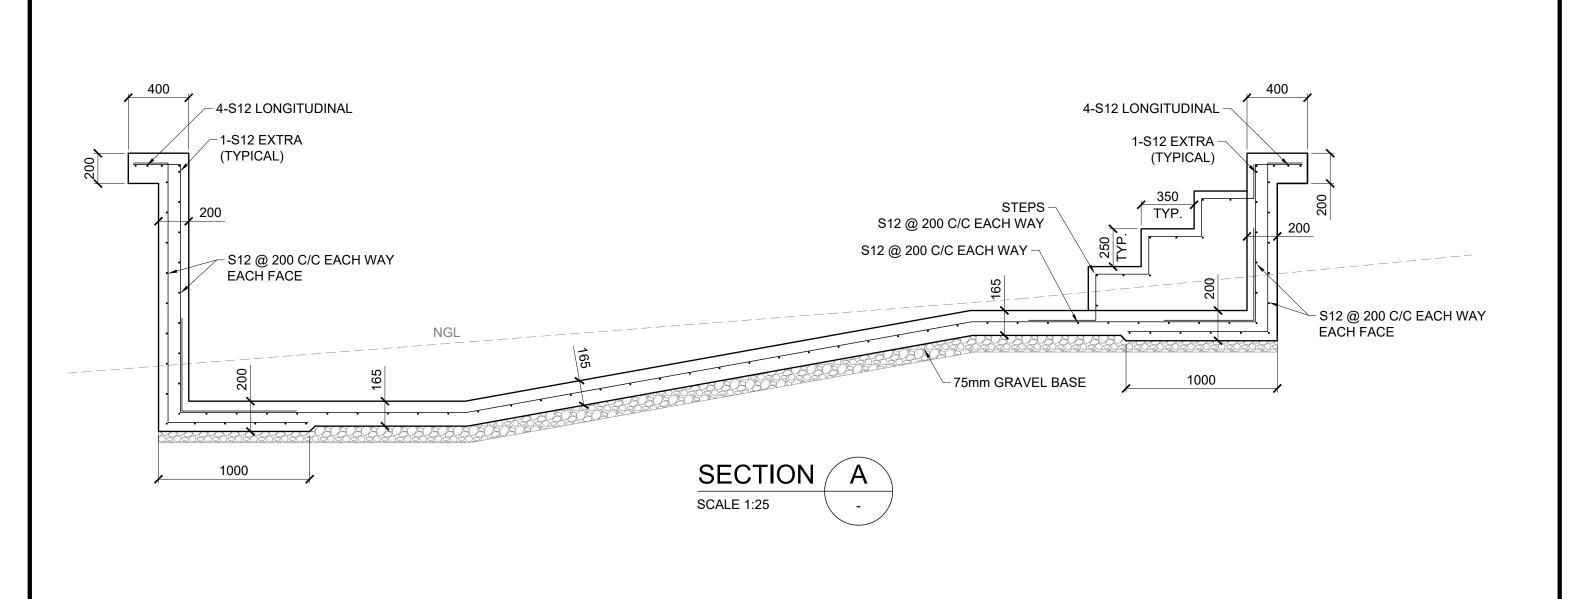

		Client						
		Architect						
			l					
AMENDMENT	DATE							
	AMENDMENT	AMENDMENT DATE	Architect  Architect					



2/25 Seabeach Avenue, Mona Vale				
eliot@greenwoodengineers.com.au	ABN - 90 625 916 341			

	Project	Drawn	Designed	Date	
		Checked	Approved	Scale	
	Title	Drawing number	Drawing number		
341					