

Contractors to check and verify all dimensions and all levels on site prior to any works.

Any discrepancies should be immediately referred to Serenescapes Landscape Designs
 All work to comply with B.C.A. Statutory Authorities and relevant Australian Standards.

Dimensions recognised over scaling. All measurements are in millimetres

Copyright Serenescapes Landscape Designs 2019.

Serenscapes Landscape Designs ABN 71 611 726 222

Serenescopes Suite 54, 14 Narabang Way Belrose NSW 2085

Tel: 02 9986 2157 info@serenescapes.com.au www.serenescapes.com.au

Client:	Keith	& Heather Wilkinson
Site Add	ress:	17 The Sementine

47 The Serpentine

Bilgola Beach

Site Plan / Site Analysis

19508

Drawn by:


Ben Farrar

AILDM # 1179

Sedimentation Control P Project Number:

	ite Analysis /	Rev:	Date:	Issue:	Ch	
n Control Plan			Α	20/02/19	Preliminary Issue	TE
			R	01/03/19	DA Issue	TE
	Scale: Sheet Number:			01/03/13	D/ (10000	
	1:200 @ A3	L-01 of 5				
	1.200 @ 70					



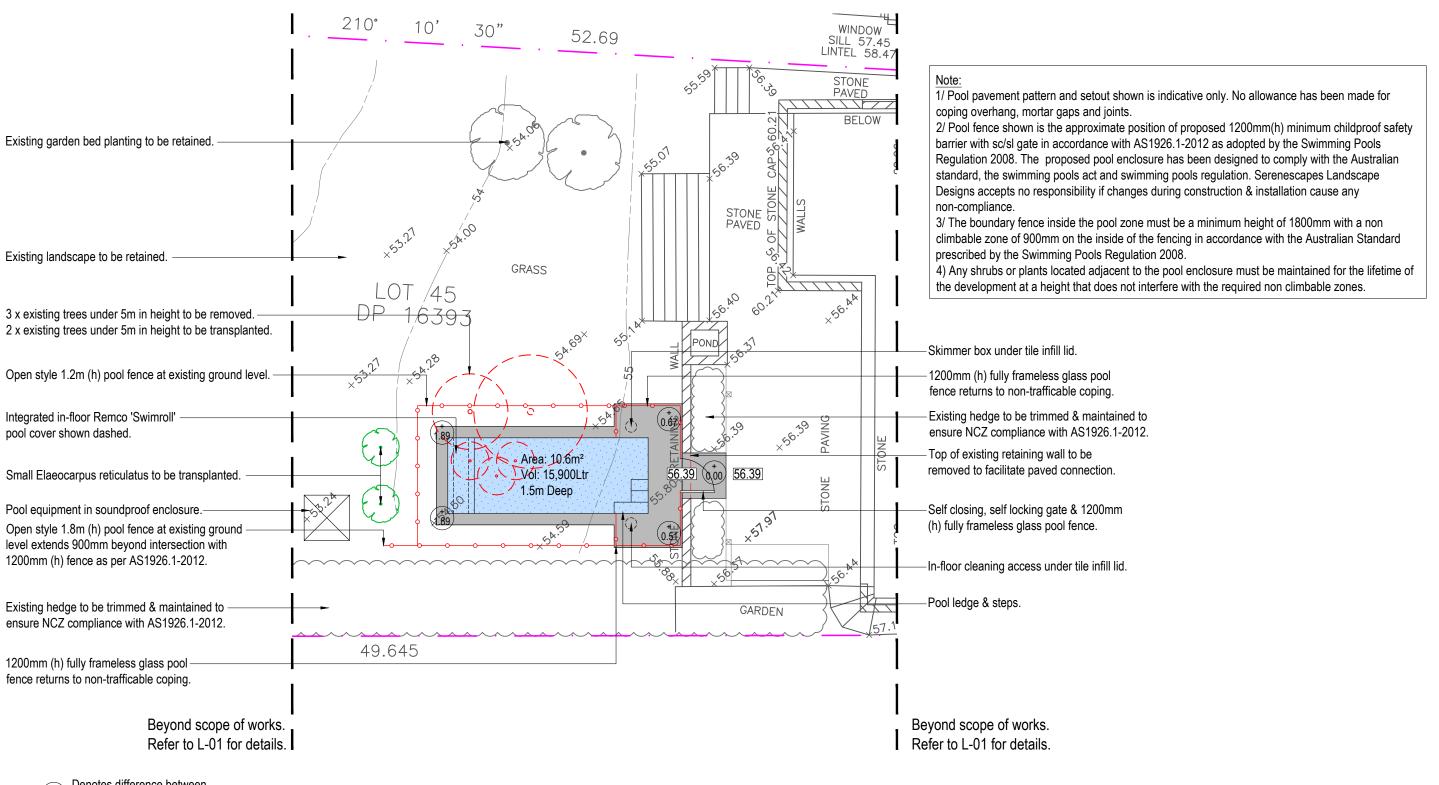

Denotes difference between coping & existing ground level

Contractors to check and verify all dimensions and all levels on site prior to any works.

 Any discrepancies should be immediately referred to Serenescapes Landscape Designs
 All work to comply with B.C.A. Statutory Authorities and relevant Australian Standards. Dimensions recognised over scaling. All measurements are in millimetres

Copyright Serenescapes Landscape Designs 2019.

Serenescopes Suite 54, 14 Narabang Way Belrose NSW 2085

Serenscapes Landscape Designs


ABN 71 611 726 222

Tel: 02 9986 2157 info@serenescapes.com.au www.serenescapes.com.au

У	Keith	& Heather Will
u	Site Address:	47 The Serper
u		Bilgola Bead

	Detail Plan			Rev:	Date:	Issue:	
kinson			Α	20/02/19	Preliminary Issue		
	Drawn by: Project Number: Scale: Sheet N				В	01/03/19	DA Issue
ntine	Drawn by: Ben Farrar	,	Scale: 1:100 @ A3	Sheet Number: L-02 of 5			
	AILDM # 1179		L-02 013				



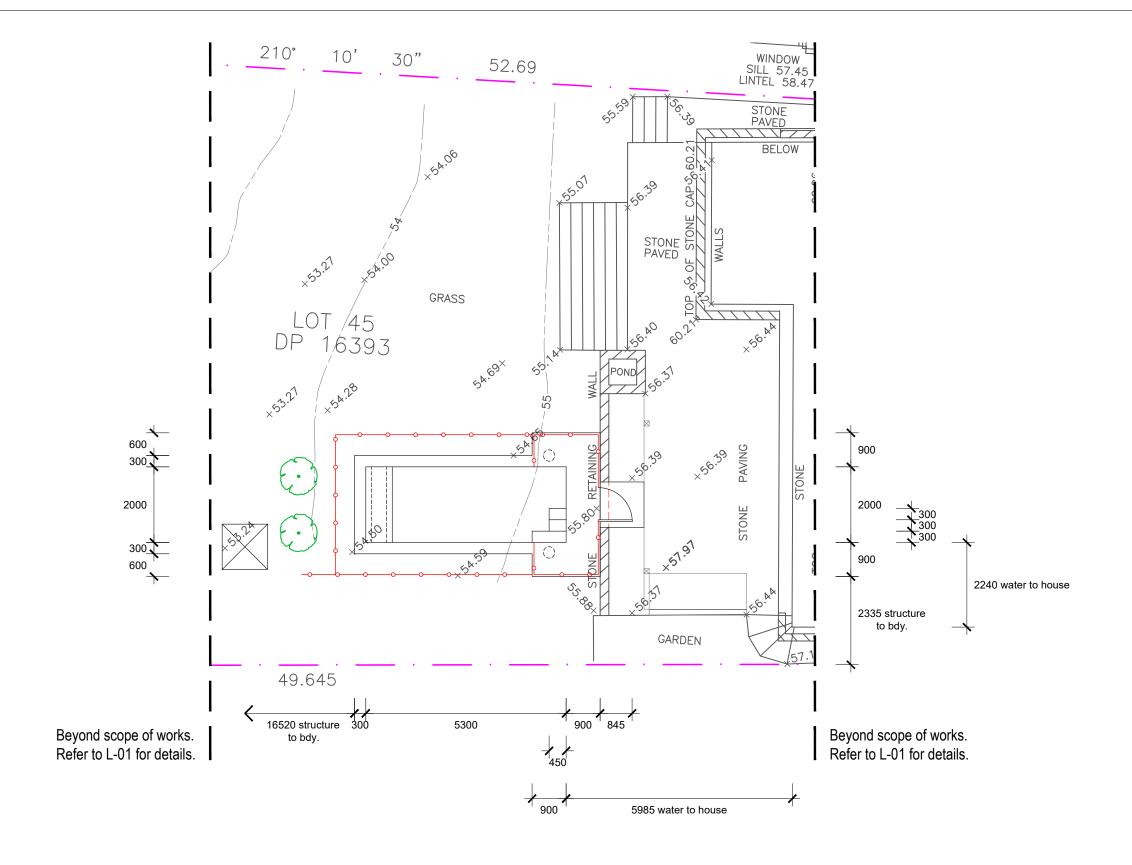

Note:
- Contractors to check and verify all dimensions and all levels on site prior to any works.

Onlineations to clience, and verify an interiestoris and interest or its ground using whomey and order of any discrepancies should be immediately referred to Serenescapes Landscape Designs.
 All work to comply with B.C.A. Statutory Authorities and relevant Australian Standards.
 Dimensions recognised over scaling. All measurements are in millimetres.
 Copyright Serenescapes Landscape Designs 2019.

Serenscapes Landscape Designs ABN 71 611 726 222

Suite 54, 14 Narabang Way Belrose NSW 2085 serenescapes Tel: 02 9986 2157 info@serenescapes.com.au www.serenescapes.com.au


Keith & Heather Wilkinson		Drawing Title:	Setou		Rev:	Date:	
			00100			Α	20/02/19
						R	01/03/19
Site Addre	47 The Serpentine	Drawn by:	Project Number:	Scale:	Sheet Number:		0 1/00/10
47 1118	47 The Serpendine	Ben Farrar	19508	1:100 @ A3	L-03 of 5		
	Bilgola Beach	AILDM # 1179	19300	1.100 @ A3	L-03 of 5		



Issue:

DA Issue

Preliminary Issue

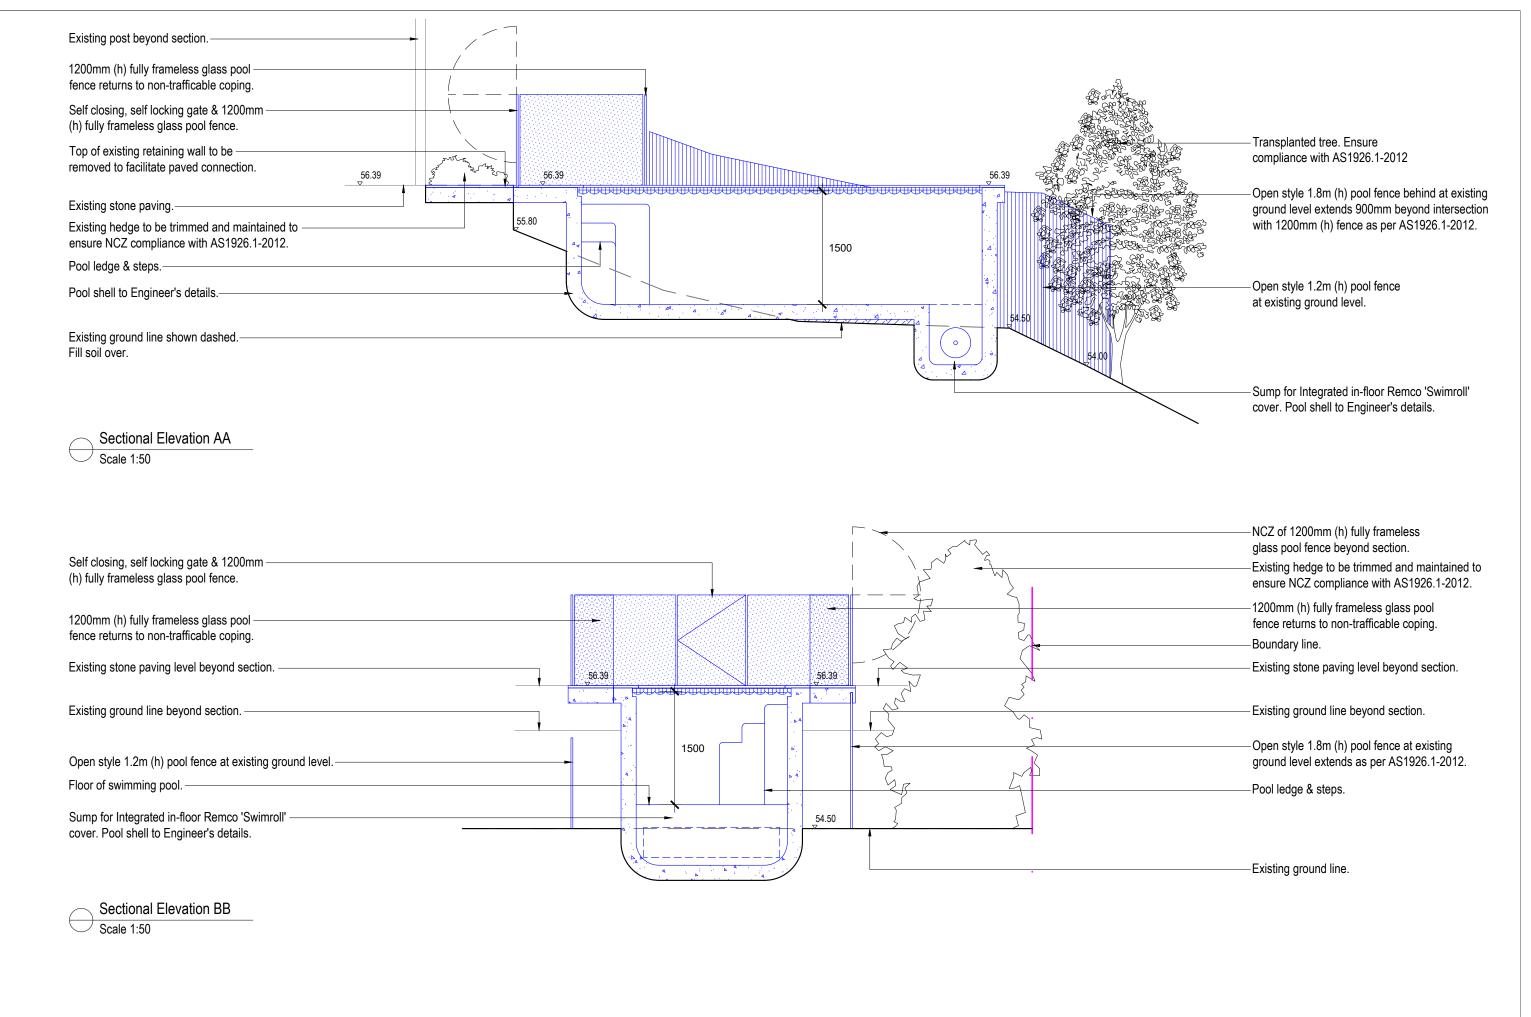

Contractors to check and verify all dimensions and all levels on site prior to any works.

 Any discrepancies should be immediately referred to Serenescapes Landscape Designs
 All work to comply with B.C.A. Statutory Authorities and relevant Australian Standards. Dimensions recognised over scaling. All measurements are in millimetres

Copyright Serenescapes Landscape Designs 2019.

Serenscapes Landscape Designs ABN 71 611 726 222

Suite 54, 14 Narabang Way Belrose NSW 2085 serenescapes Tel: 02 9986 2157 info@serenescapes.com.au www.serenescapes.com.au

Keit	th & Heather Wilkinson
Site Address:	47 The Serpentine
	Bilgola Beach

Drawing Title:

Drawn by:

Ben Farrar

AILDM # 1179

Sectional Elevation						
oject Number:	Scale:	Sheet Number:	<u> </u>			
19508	1:50 @ A3	L-04 of 5				

Checked: 20/02/19 Preliminary Issue ТВ 01/03/19 DA Issue TB

LANDSCAPE SPECIFICATION NOTES SITE PREPARATION

Locate any underground and overground services & ensure no damage occurs. Levels on plan are nominal only & all dimensions to be checked on site prior to commencement. Final structural integrity of all items shall be the sole responsibility of landscape contractor.

PROTECTION OF EXISTING TREES:

Prior to construction, the builder shall erect tree protection fencing to the drip line of existing trees to be retained.

The fence shall be constructed of star pickets at 2.4m spacings and connected by three strands of 2mm wire at 300mm spacings to a minimum height of 1500mm.

Protect all trees affected by demolition & construction. Take necessary precautions to protect the Critical Root Zone(CRZ) which is the area normally within 3m radius from each tree trunk.

Tree protection measures shall remain intact until the completion of all construction works.

Prohibited Works within the CRZ:

- entry of machinery or storage of building materials
- parking of any kind of vehicle
- erection or placement of site facilities
- removal or stockpiling of soil or site debris
- disposal of liquid waste including paint & concrete wash
- excavation or trenching of any kind (including irrigation or electrical connections).
- attaching any signs or any other objects to the tree
- placement of waste disposal or skip bins
- pruning and removal of branches, other than those by a qualified Arborist

Compacted Ground/Coring: Avoid compaction of the ground under trees. If compaction nevertheless occurs loosen the soil by Coring. Coring to be carried out by a qualified Arborist.

REMOVAL OF EXISTING TREES

All trees to be removed shall be carried out by a qualified arborist and work shall conform to the provisions of AS4373-2007 Australian Standards for The Pruning of Amenity Trees.

ELIMINATE WEEDS

Remove all existing weeds by hand, wiping or spraying with a glyphosate based herbicide. Weed control shall never be performed by mechanical cultivation or by scraping. Herbicide spraying is to be used to eliminate all existing weeds 30 days prior to planting.

EXCAVATION & SUB SOIL PREPARATION

Excavate garden beds to the depth required and rip or scarify base & sides of pit to a minimum depth of 150mm.

SUB SOIL DRAINAGE

Install drainage layer where there is surface water runoff draining into garden bed areas & where the existing sub-soil has more than 50% clay composition & there is a risk of subsurface water ponding. Install perforated corrugated ag. line 75-100mm Dia. with geotextile filter sock & backfill to a minimum 200mm using free draining material, reclaimed/recycled where available. Direct flows at a minimum 0.5% fall to sw system. In areas isolated from stormwater system excavate & backfill an appropriate water dispersion pit.

REUSE EXISTING TOPSOIL

Existing site topsoil should be salvaged & appropriately stockpiled where possible.

IMPORTED TOPSOIL

Quality System: AS 4419 or as specified below.

Turf Areas: 'Turf Underlay' as supplied by, ANL p: 02 9450 1444 or approved alternative.

Tree Pit and Shrub Planting: 'Premium Garden Mix' as supplied by, ANL p: 02 9450 1444 or approved alternative.

PLANTING

Health & Vigour: Supply plants with foliage size, texture & colour consistent with that shown in healthy specimens of the species.

Balance of Crown: Supply plants with max. variation in crown bulk on opposite sides of stem axis, +/- 20%. Stock selection should be based on NATSPEC Guide Specifying Trees: a Guide to Assessment of Tree Quality.

STAKING

Install 2 x 1800mm 40x40 hardwood timber stakes with hessian ties to all trees. Provide appropriate support considering exposure to prevailing winds. Stakes and hessian ties to be removed as soon as the tree is self supporting.

IRRIGATION SYSTEM

New dripline irrigation system to be installed with backflow preventer and with timers. Irrigation system to be designed and installed to local codes.

The entire irrigation system shall be fully automated and provide drip irrigation to all tree, shrub and ground cover zones. It is the Contractor's responsibility to verify water pressure available and determine all design-built parameters prior to any installation and sizing of irrigation components. Irrigation system to be connected to water tank to supplement water from mains.

MULCHING

Quality system: AS 4454

All planting area impacted by building works to receive 50-75mm of garden Mulch, Hort-Bark, ANL p: 02 9450 1444 or approved alternative. Keep mulch 100mm away from plant stem & form a well to stop excessive water runoff. Finish flush with adjacent surfaces.


TURFING

New turf- Sir Walter Soft Leafed Buffalo.

Excavate / grade all areas to be turfed to 120mm below finished levels. Ensure that all surface runoff is directed away from buildings. Ensure that no pooling or ponding will occur. Further rip the sub-grade to 150mm. Install 100mm of imported turf underlay. Rolls to be closely butted and laid in a brickwork pattern. Fill any small gaps with topsoil and water thoroughly.

WATERING

Water in immediately after plant installation & allow for soil settlement. For the first 2 to 4 weeks after planting, the root zone & immediate surrounds must be kept moist. Continue watering until plants have established.

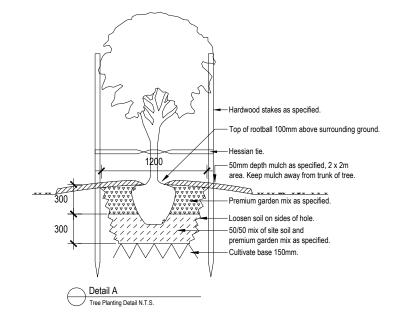

Contractors to check and verify all dimensions and all levels on site prior to any works.

 Any discrepancies should be immediately referred to Serenescapes Landscape Designs
 All work to comply with B.C.A. Statutory Authorities and relevant Australian Standards. Dimensions recognised over scaling. All measurements are in millimetres Copyright Serenescapes Landscape Designs 2019.



Tel: 02 9986 2157 info@serenescapes.c Serenscapes Landscape Designs www.serenescapes.co ABN 71 611 726 222

Suite 54, 14 Narabang Way	Client:
Belrose NSW 2085	
Tel: 02 9986 2157	Site Addre
info@serenescapes.com.au	Sile Addie
www.serenescapes.com.au	

										_
Keith & Heather Wilkinson		Drawing Title: Landscape Specification & Details				Rev:	Date:	Issue:	Checked:	
						Α	20/02/19	Preliminary Issue	ТВ	
						В	01/03/19	DA Issue	ТВ	
e Add	Iress: 47 The Serpentine	Drawn by:	Project Number:	Scale:	Sheet Number:					
	'	Ben Farrar	19508	NTS @ A3	L-05 of 5					
		AILDM # 1179		15 66 7.18						