


PLEASE NOTE AN IMPERMEABLE LINER SUCH AS BIDIM A44 GEO-FABRIC MUST BE INSTALLED AT THE BASE (AND UP THE EDGES) OF THE RAIN GARDEN TO STOP GROUND WATER FILTERING INTO SURROUNDING SOIL NOTING THE LANDSLIDE RISK EVIDENT PRIMARILY LINKED TO GROUNDWATER.

WATER SENSITIVE URBAN DESIGN ELEMENTS FORM PART OF THIS PROJECT - RAIN GARDEN AND RAINWATER REUSE TANK - REUSE OF TANK IN ACCORDANCE WITH BASIX REQUIREMENTS OR AS PER


RAIN GARDEN:

COUNCIL REQUIREMENTS

PROVIDED RAIN GARDEN AREA: 1.21m2

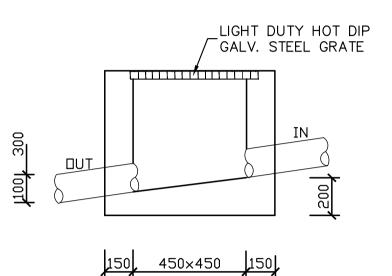

TYPICAL INTERNAL PIT

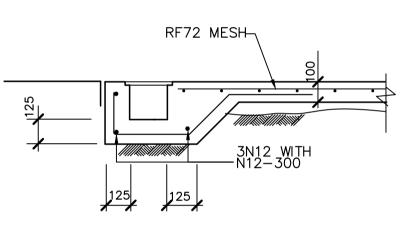

GRATED DRAIN

RAINWATER TANK NOTES: RAINWATER TANK AND PIPE WORK IS TO BE PAINTED IN COLOURS MATCHING THE EXTERNAL FINISHES OF THE DWELLING AND IS TO BE NON-REFLECTIVE FINISH.


LEGEND					
RL 00.000	NEW REDUCED LEVEL				
GFL. 00.00	GROUND FLOOR LEVEL				
FFL. 00.00	FINISH FLOOR LEVEL				
A,B,C,D, etc.	REFER TO PIPE SEHEDULE				
L1	PIPE LABEL				
PIT P1	SURFACE INLET PIT				
● DP	DOWNPIPE				
□ RWH	RAIN WATER HEAD				
	PIT: SIZE AS MARKED				
	SEALED PIT: SIZE AS MARKED				
	W:200mm x D:200mm GRATED DRAIN				
-	GROUND FALL				
	OVERLAND FLOW				
	100mm UPVC CHARGED LINE				
	DRAINAGE PIPE IN GROUND				
	RAINWATER TANK OVERFLOW PIPE				


	PIPE SCHEDULE					
TO ALL GUTTERS						
3	PIPE Ø	MATERIAL	Min. GRADE			
	100	PVC	1%			
	100 OVERFLOW	PVC	1%			
	100 CHARGED	PVC	_			
)	100	PVC	-			


NOTES

CONTRACTORS EXPENSE.

- 1. THESE DRAWINGS ARE TO BE READ IN CONJUNCTION WITH THE ARCHITECTURAL DRAWINGS, STRUCTURAL DRAWINGS AND THE SPECIFICATON.
- 2. PRIOR TO COMMENCEMENT OF WORKS THE CONTRACTOR SHALL SATISFY HIMSELF OF THE CORRECT LOCATION OF EXISTING SERVICES WHETHER INDICATED OR NOT ON THE PLANS. ANY DAMAGE TO EXISTING SERVICES SHALL BE RECTIFIED AT THE
- 3. TRAFFIC MANAGEMENT MEASURES HAVE TO BE IMPLEMENTED AND MAINTAINED DURING CONSTRUCTON, ALL IN ACCORDANCE WITH COUNCIL'S REQUIREMENTS. THE CONTRACTOR SHALL MAINTAIN SAFE PEDESTRIAN ACCESS ALONG THE FOOTPATH. 4. THE CONTRACTOR SHALL EFFECT TEMPORARY DRAINAGE MEASURES TO AVOID LOCALISED PONDING OF SURFACE RUN-OFF 5. REFER TO ARCHITECT'S DRAWINGS FOR ALL DETAILS (LEVELS, GRADING ETC.) OF DRIVEWAYS, CONCRETE AND PAVED AREAS, AND RETAINING WALL TYPES AND LOCATIONS.
- 6. REFER TO LANDSCAPE ARCHITECT'S DRAWINGS FOR DETAILS AND EXTENT OF ALL LANDSCAPED AREAS.
- 7. ALL SWD PIPES ARE UPVC AT 1.0% MINIMUM GRADE (UNO). 8. SWD PITS CAN BE PRE-CAST SIZED AS FOLLOWS:
- 450mm SQ. UP TO 600mm DEEP 600mm SQ. UP TO 1000mm DEEP
- 9. ALL PITS LOCATED IN TRAFFICABLE AREAS, (IE, DRIVEWAYS) TO HAVE MEDIUM DUTY GRATED COVERS SUITABLE FOR WITHSTANDING LOADS ASSOCIATED WITH SMALL TRUCKS.
- 10. PROVIDE STEP IRONS TO ALL PITS GREATER THAN 1.2m DEEP. 11. THE CONTRACTOR SHALL IMPLEMENT ALL SOIL EROSION AND SEDIMENT CONTROL MEASURES PRIOR TO COMMENCEMENT OF 12. TOPSOIL SHALL BE STRIPPED DN STOCKPILED OUTSIDE
- HAZARD AREAS SUCH AS DRAINAGE LINES. THIS TOPSOIL IS TO BE RESPREAD LATER ON AREAS TO BE REVEGETATED. 13. THE CONTRACTOR SHALL REGULARLY MAINTAIN ALL SEDIMENT AND EROSION CONTROL DEVICES AND REMOVE ACCUMULATED SILT FROM SUCH DEVICES. ALL SILT REMOVED SHALL BE DISPOSED OF AS DIRECTED BY THE SUPERINTENDENT. THE PERIOD FOR MAINTAINING THESE DEVICES SHALL BE AT LEAST UNTIL ALL DISTURBED AREAS ARE REVEGETATED AND FURTHER AS MAY BE DIRECTED BY THE SUPERINTENDENT OR COUNCIL.
- 14. THE CONTRACTOR SHALL MAINTAIN DUST CONTROL UNTIL FINAL COMPLETION OF WORKS.

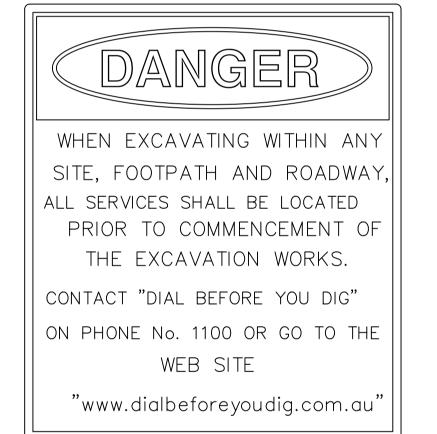


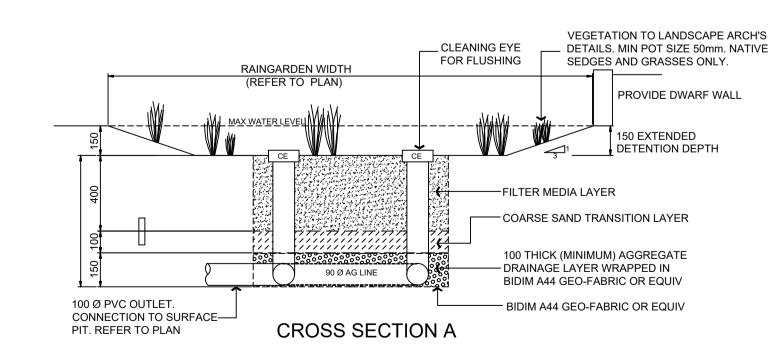

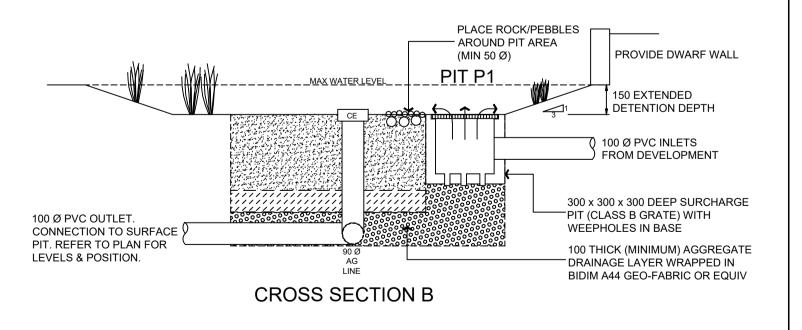


RAIN GARDEN DETAILS


						SUITE 303 / 29-31 LEXINGTON DRIVE	PROJECT	DRAWING TITLE		
					CARA	NORWEST BUSINESS PARK, BELLA VISTA N.S.W. 2153	PROPOSED DEVELOPMENT LOT 19, 10 FERN CREEK ROAD,	DRAINAGE LAYOUT	PLAN	
D	ISSUED FOR DA APPROVAL	22/11/2021				ALL CORRESPONDENCE TO:	WORRIEWOOD, NSW			
С	ISSUED FOR DA APPROVAL	04/11/2021				P.O. BOX 6080 BAULKHAM HILLS BC	CLIENT	SCALES	DESIGNED	DRAFTED
В	ISSUED FOR DA APPROVAL	26/10/2021			CONCLUTING	BAULKHAM HILLS NSW 2153	SKYCORP	A1 - 1:100	A.C.	M.W.
А	PRELIMINARY DESIGN	21/09/2021			CONSULTING	PH. 8814 6191 FAX 8814 5301 MOB. 0425 270 333	ARCHITECT / PROJECT MANAGER	DRAWING NO.	APPROVED	REVISION
REVISION	AMENDMENT	ISSUE DATE ISSUE	ISSUED TO	ISSUE DATE	STRUCTURAL & CIVIL ENGINEERS	EMAIL andrew@camconsulting.com.au	KAE CHAN	C21187 -SW01	A.C.	D

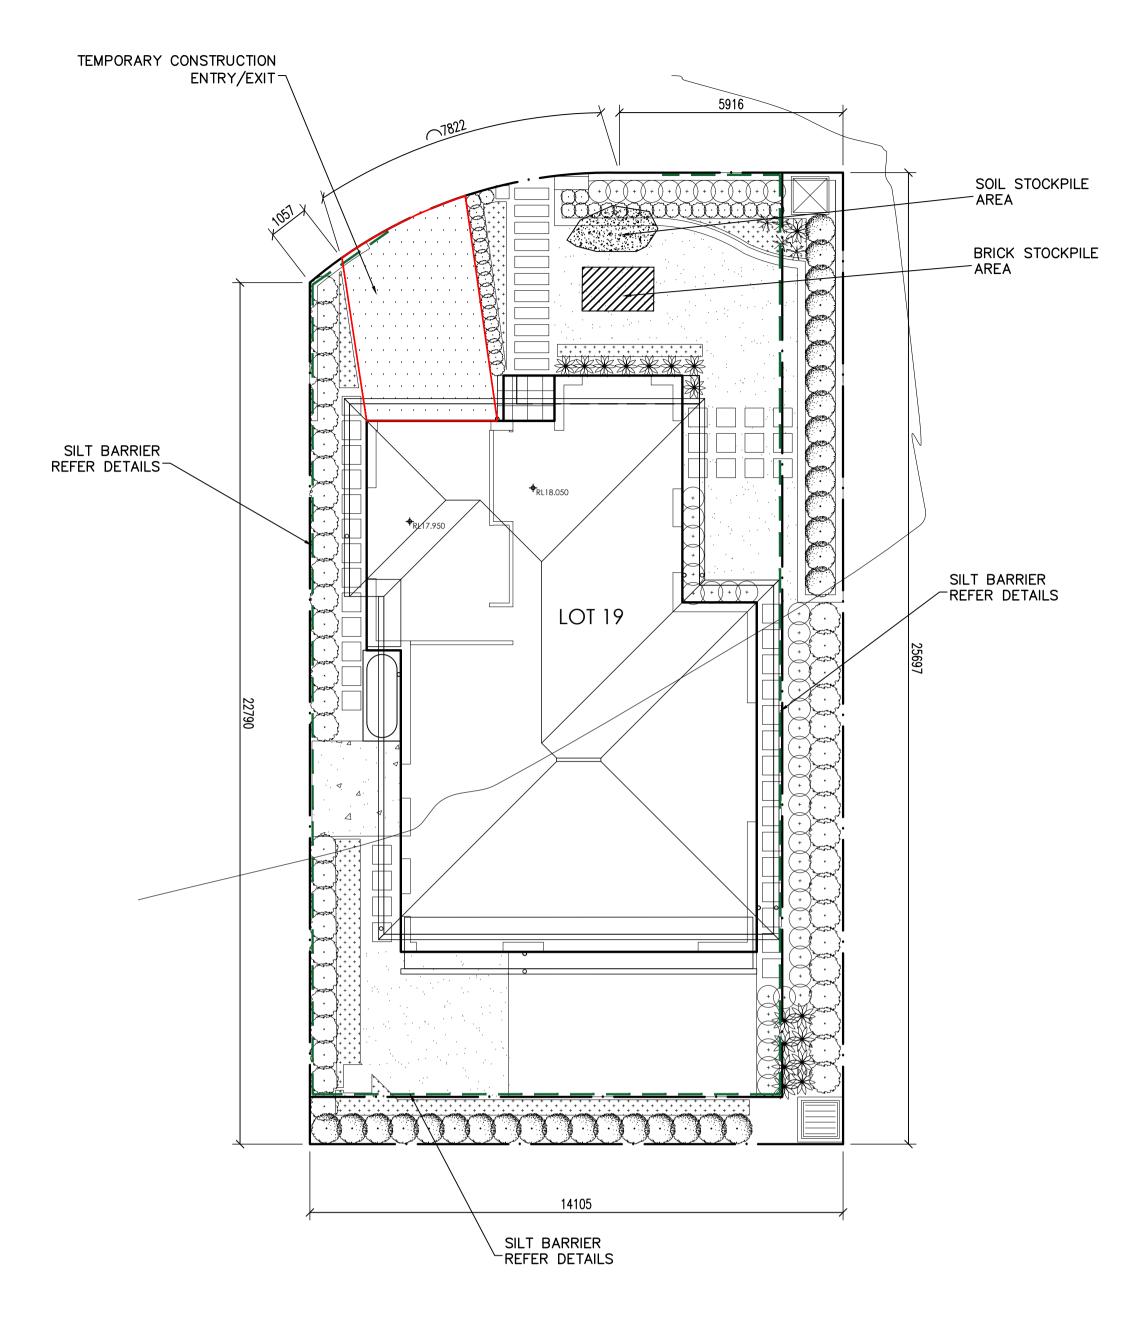



SOIL MANAGEMENT PLAN
SCALE: 1:100



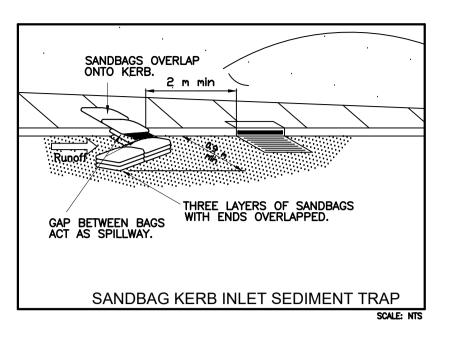

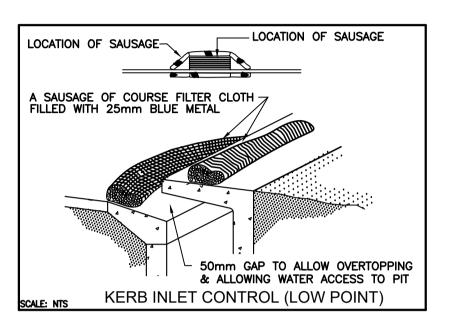

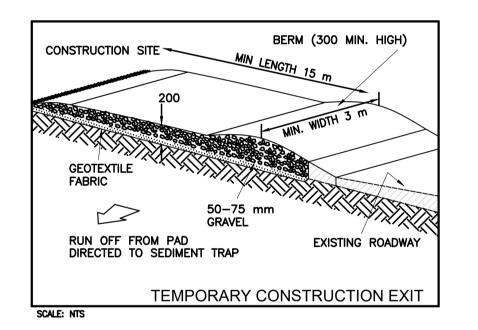

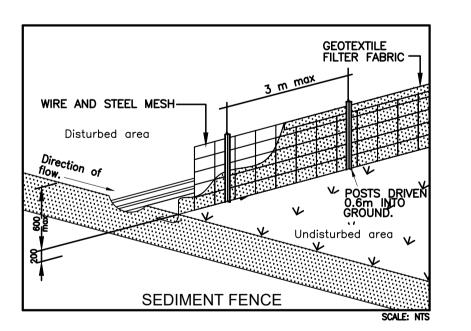


SOIL EROSION CONTROL INSTRUCTIONS

- EARTH BATTERS WILL BE CONSTRUCTED WITH AS LOW AS A GRADIENT AS PRACTICABLE BUT NO STEEPER, UNLESS OTHERWISE NTOED, THAN:
 - -2(H):1(V) WHERE SLOPE LENGTH LESS THAN 12 METRES
 -2.5(H):1(V) WHERE SLOPE LENGTH BETWEEN 12 & 16 METRES
 -3(H):1(V) WHERE SLOPE LENGTH BETWEEN 16 & 20 METRES
 -4(H):1(V) WHERE SLOPE LENGTH GREATER THAN 20 METRES
- ALL WATERWAYS, DRAINS, SPILLWAYS AND THEIR OUTLETS WILL BE CONSTRUCTED TO BE STABLE IN AT LEAST THE 1:20 YEAR ARI, TIME OF CONCENTRATION STORM EVENT.
- WATERWAYS AND OTHER AREAS SUBJECT TO CONCENTRATED FLOWS AFTER CONSTRUCTION ARE TO HAVE A MAXIMUM GROUNDCOVER C-FACTOR OF 0.05 (70% GROUND COVER) WITHIN 10 WORKING DAYS FROM COMPLETION OFFORMATION. FLOW VELOCITIES ARE TO BE LIMITED TO THOSE SHOWN INTABLE 5-1 OF "MANAGING URBAN STORMWATER SOILS AND CONSTRUCTION DEPT OF HOUSING 1998 (BLUE BOOK). FOOT AND VEHICULAR TRAFFIC WILL BE PROHIBITED IN THESE AREAS.
- STOCKPILES AFTER CONSTRUCTION ARE TO HAVE A MAXIMUM GROUND COVER C-FATOR OF 0.1 (60% GROUND COVER) WITHIN 10 WORKING DAYS FROM COMPLETION OF FORMATION.
- ALL LANDS, INCLUDING WATERWAYS AND STOCKPILES, DURING CONSTRUCTION ARE TO HAVE A MAXIMUM GROUND COVER C—FACTOR OF 0.15 (50% GROUND COVER) WITHIN 20 WORKING DAYS FROM INACTIVITY EVEN THOUGH WORKS MAY CONTINUE LATER
- FOR AREAS OF SHEET FLOW USE THE FOLLOWING GROUND COVER PLANT SPECIES FOR TEMPORARY COVER: JAPANESE MILLET 20KG/HA AND OATS.
- PERMANENT REHABILITATION OF LANDS AFTER CONSTRUCTION WILL ACHIEVE A GROUND COVER C-FACTOR OF LESS THAN 0.1 AND LESS THAN 0.05 WITHIN 60 DAYS. NEWLY PLANTED LANDS WILL BE WATERED REGULARLY UNTIL AN EFFECTIVE COVER IS ESTABLISHED AND PLANTS ARE GROWING VIGOROUSLY FOLLOW-UP SEED AND FERTILISER WILL BE APPLIED AS
- REVEGATATION SHOULD BE AIMED AT RE-ESTABLISHING NATURAL SPECIES. NATURAL SURFACE SOILS SHOULD BE REPLACED AND NON-PERSISTANT ANNUAL COVER SROPS SHOULS BE USED.

DUST CONTROL INSTRUCTIONS

- ALL STOCKPILED MATERIAL OR SEDIMENT COLLECTION TO BE SPRAYED BY LIGHTLY WIDE ANGLED WATER
- THIS TEMPORARY MECHANICAL METHOD CONFINES AND SETTLES
 THE DUST FROM THE AIR BY DUST AND WATER PARTICLE
 ADHESION. WATER IS SPRAYED THROUGH NOZZELS OVER THE
 PROBLEM AREA.

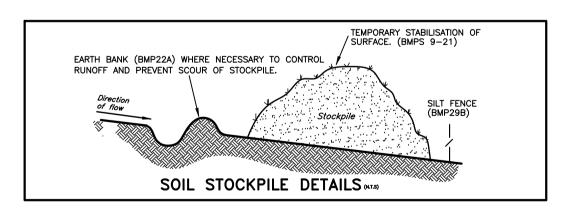

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REVISION	AMENDMENT	ISSUE DATE	ISSUE	ISSUED TO	ISSUE DATE



SUITE 303 / 29-31 LEXINGTON DRIVE NORWEST BUSINESS PARK, BELLA VISTA N.S.W. 2153

ALL CORRESPONDENCE TO: P.O. BOX 6080 BAULKHAM HILLS BC BAULKHAM HILLS NSW 2153

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PROJECT
PROPOSED DEVELOPMENT
LOT 19, 10 FERN CREEK ROAD,
WORRIEWOOD, NSW

SOIL MANAGEMENT PLAN

SKYCORP

ARCHITECT / PROJECT MANAGER

KAE CHAN

 SCALES
 DESIGNED
 DRAFTED

 A1 - 1:100
 A.C.
 M.W.

 DRAWING NO.
 APPROVED
 REVISION

 C21187 -SW02
 A.C.
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