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# **DEVELOPMENT SCHEDULE**

385.70m<sup>2</sup> SITE AREA

**BUILDING FOOTPRINT** 

PROPOSED:

A FOR DA

ALLOWABLE: 128.40m<sup>2</sup> (33.3% x SITE AREA)

184.79 m<sup>2</sup> (48%)

**EXISTING:** 125.38m<sup>2</sup> (32%)

BUILDER TO ALLOW FOR WALL AND FLOOR FINISHES NOTES



No. 1130 PITTWATER ROAD COLLAROY - EXISTING REAR ELEVATION



NUTES
ALL WORK SHOULD COMPLY WITH RELEVANT AUSTRALIAN
STANDARDS AND BUILDING CODE OF AUSTRALIA (BCA) ALL WORK
SHALL CONFORM TO THE CONTRACT DOCUMENTS WHICH INCLUDE
SPECIFICATIONS, THE DRAWNISS, ALL ADDENDUMS, FINISHES
SCHEDULES, ALL THE CONSTRUCTION DRAWNISS SHALL BE READ IN
CONJUNCTION WILL CONSULTANTS AND CONTRACTOR DRAWNISS,
SCHEDULES AND SPECIFICATIONS. IN CASE OF CONFLICT BETWEEN
ARCHITECTS AND CONSULTANTS DOWNINGS IN LOCATING
STRUCTURAL ELEMENTS, MATERIALS / EQUIPMENT. HOUSI







No. 1130 PITTWATER ROAD COLLAROY - FRONT ELEVATION



Nominated NSW Architects Reg. 9401 · Mark P. Alves ABN: 37 615 694 356 Suite 4, Building B, 37 Alexandra St. Hunters Hill 2110

COLLAROY drawn MA/JG date 22.05.23 scale1:1, 1:4.15 @ A3

1130 PITTWATER RD

2\_23\_10 A0000

# Single Dwelling

Certificate number: 1412073S

This certificate confirms that the proposed development will meet the NSW government's requirements for sustainability, if it is built in accordance with the commitments set out below. Terms used in this certificate, or in the commitments, have the meaning given by the document entitled 'BASIX Definitions' dated 10/09/2020 published by the Department. This document is available at www.basix.nsw.gov.au

Secretary
Date of issue: Friday, 08 September 2023
To be valid, this certificate must be lodged within 3 months of the date of issue.



Project summary				
Project name	1130 Pittwater Rd F	1130 Pittwater Rd HEC1482		
Street address	1130 Pittwater Road	1130 Pittwater Road Collaroy 2097		
Local Government Area	Northern Beaches 0	Northern Beaches Council		
Plan type and plan number	deposited 121939	deposited 121939		
Lot no.	1	1		
Section no.	-	-		
Project type	separate dwelling h	separate dwelling house		
No. of bedrooms	4	4		
Project score				
Water	<b>✓</b> 40	Target 40		
Thermal Comfort	✓ Pass	Target Pass		
Energy	<b>✓</b> 50	Target 50		

Certificate Prepared by
Name / Company Name: House Energy Certified
ABN (if applicable): 81601166561

Project name	1130 Pittwater Rd HEC1482
Street address	1130 Pittwater Road Collaroy 2097
Local Government Area	Northern Beaches Council
Plan type and plan number	Deposited Plan 121939
Lot no.	1
Section no.	-
Project type	
Project type	separate dwelling house
No. of bedrooms	4
Site details	
Site area (m²)	386
Roof area (m²)	126
Conditioned floor area (m2)	266.0
Unconditioned floor area (m2)	7.0
Total area of garden and lawn (m2)	150

Assessor details and thermal loads			
Assessor number	DMN/18/4423		
Certificate number	HR-A9EO3G-01		
Climate zone	56		
Area adjusted cooling load (MJ/m².year)	24		
Area adjusted heating load (MJ/m².year) 40			
Ceiling fan in at least one bedroom	No		
Ceiling fan in at least one living room or other conditioned area	Yes		
Project score			
Water	<b>✓</b> 40	Target 40	
Thermal Comfort	✓ Pass	Target Pass	
Energy	<b>✓</b> 50	Target 50	

Show on Show on CC/CDC Certifier

Water Commitments	DA plans	plans & specs	check
Fixtures			
The applicant must install showerheads with a minimum rating of 4 star (> 6 but <= 7.5 L/min plus spray force and/or coverage tests) in all showers in the development.		~	~
The applicant must install a toilet flushing system with a minimum rating of 4 star in each toilet in the development.		<b>V</b>	~
The applicant must install taps with a minimum rating of 4 star in the kitchen in the development.		<b>V</b>	
The applicant must install basin taps with a minimum rating of 4 star in each bathroom in the development.		~	
Alternative water			
Rainwater tank			
The applicant must install a rainwater tank of at least 2000 litres on the site. This rainwater tank must meet, and be installed in accordance with, the requirements of all applicable regulatory authorities.	~	~	~
The applicant must configure the rainwater tank to collect rain runoff from at least 100 square metres of the roof area of the development (excluding the area of the roof which drains to any stormwater tank or private dam).		~	~
The applicant must connect the rainwater tank to:			
all toilets in the development		•	-
<ul> <li>at least one outdoor tap in the development (Note: NSW Health does not recommend that rainwater be used for human consumption in areas with potable water supply.)</li> </ul>		•	-
Thermal Comfort Commitments	Show on DA plans	Show on CC/CDC plans & specs	Certifier check
Simulation Method			
The applicant must attach the certificate referred to under "Assessor Details" on the front page of this BASIX certificate (the "Assessor Certificate") to the development application and construction certificate application for the proposed development (or, if the applicant is applying for a complying development certificate for the proposed development, to that application). The applicant must also attach the Assessor Certificate to the application for an occupation certificate for the proposed development.			
The Assessor Certificate must have been issued by an Accredited Assessor in accordance with the Thermal Comfort Protocol.			
The details of the proposed development on the Assessor Certificate must be consistent with the details shown in this BASIX certificate, including the Cooling and Heating loads shown on the front page of this certificate.			
The applicant must show on the plans accompanying the development application for the proposed development, all matters which the Assessor Certificate requires to be shown on those plans. Those plans must bear a stamp of endorsament from the Accredited Assessor to certify that this is the case. The applicant must show on the plans accompanying the application for a construction certificate (or complying development certificate, if applicable), all thermal performance specifications set out in the Assessor Certificate, and all aspects of the proposed development which were used to calculate those specifications.	~	•	~

Floor and wall construction	Area
floor - concrete slab on ground	119.0 square metres
floor - suspended floor/enclosed subfloor	6.0 square metres

BUILDE	R TO ALLOW FOR WALL AND F	LOOR FINISHES	NOTES
SSUE	AMENDMENT	DATE	ALL WORK SHOULD COMPLY WITH RELEVANT AUSTRALIAN
Α	FOR DA	15.09.23	STANDARDS AND BULDING CODE OF AUSTRALIA (BCA) ALL WORK SHALL CONFORM TO THE CONTRACT DOCUMENTS WHICH INCLUDE SPECIFICATIONS, THE DRAWMISS, ALL ADDENDUMS, FINISHES SCHEDULES. ALL THE CONSTRUCTION DRAWMINGS SHALL BE READ IN CONJUNCTION WILL CONSULTANTS AND CONTRACTOR DRAWMING SCHEDULES AND SPECIFICATIONS. IN CASE OF CONFLICT BETWEEN ARCHITECTS AND CONSULTANTS DRAWMINGS IN LOCATING STRUCTURAL ELEMENTS, MATERIALS J EQUIPMENT.
			This drawing is issued as a preliminary concept design and must not be used for construction, cost estimation or any purpose other than for preliminary design

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The applicant must construct the development in accordance with all thermal performance specifications set out in the Assessor Certificate, and in accordance with those aspects of the development application or application for a complying development certificate

Where there is an in-slab heating or cooling system, the applicant must install insulation with an R-value of not less than 1.0 around the vertical edges of the perimeter of the slab, and underneath the slab if it is a suspended floor.

The applicant must show on the plans accompanying the development application for the proposed development, the locations of ceiling fans set out in the Assessor Certificate. The applicant must show on the plans accompanying the application for a constructorificate (or complying development certificate, if applicable), the locations of ceiling fans set out in the Assert Certificate.

The applicant must construct the floors and walls of the dwelling in accordance with the specifications listed in the table be

1000	#HR-A9E03G-01 0	8/09/2023
5.1	Assessor Paul G	radwell
NATIONWIDE	Accreditation No. DMN/1	8/4423
HOUSE	Address	
63.8 M./m²	1130 Pittwater Road, Collaroy, NSW, 2097	

~

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V

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Energy Commitments	Show on DA plans	Show on CC/CDC plans & specs	Certifier check
Hot water			
The applicant must install the following hot water system in the development, or a system with a higher energy rating: gas instantaneous with a performance of 5 stars.	~	<b>✓</b>	~
Cooling system			
The applicant must install the following cooling system, or a system with a higher energy rating, in at least 1 living area: 1-phase airconditioning; Energy rating: 2.5 Star (old label)		<b>✓</b>	~
The applicant must install the following cooling system, or a system with a higher energy rating, in at least 1 bedroom: 1-phase airconditioning; Energy rating: 2.5 Star (old label)		<b>✓</b>	~
Heating system			
The applicant must install the following heating system, or a system with a higher energy rating, in at least 1 living area: electric floor heating; Energy rating: n/a		<b>✓</b>	~
The applicant must install the following heating system, or a system with a higher energy rating, in at least 1 bedroom: 1-phase airconditioning; Energy rating: 2.5 Star (old label)		<b>✓</b>	~
Ventilation			
The applicant must install the following exhaust systems in the development:			
At least 1 Bathroom: individual fan, ducted to façade or roof; Operation control: manual switch on/off			
Kitchen: individual fan, ducted to façade or roof; Operation control: manual switch on/off		<b>.</b>	<u>*</u>
		_	-
Laundry: individual fan, ducted to façade or roof; Operation control: manual switch on/off		<b>✓</b>	~
Artificial lighting			
The applicant must ensure that the "primary type of artificial lighting" is fluorescent or light emitting diode (LED) lighting in each of the following rooms, and where the word "dedicated" appears, the fittings for those lights must only be capable of accepting fluorescent or light emitting diode (LED) lamps:			
at least 4 of the bedrooms / study; dedicated			
at least 1 of the living / dining rooms; dedicated		•	
		~	-
the kitchen; dedicated		<b>✓</b>	-
Energy Commitments	Show on	Show on CC/CDC	Certifier
·-	DA plans	plans & specs	check
all bathrooms/toilets; dedicated		_	
the laundry; dedicated			
all hallways; dedicated			
Natural lighting		•	•
The applicant must install a window and/or skylight in the kitchen of the dwelling for natural lighting.			
The applicant must install a window and/or abriliable in 2 hadronom(a)/bailas/a) in the development for a track in the	~		_
The applicant must install a window and/or skylight in 3 bathroom(s)/toilet(s) in the development for natural lighting.	~	~	~
Alternative energy			
The applicant must install a photovoltaic system with the capacity to generate at least 1.5 peak kilowatts of electricity as part of the development. The applicant must connect this system to the development's electrical system.	~	~	~
Other			

# Assessor Construction Summary

The applicant must install a gas cooktop & gas oven in the kitchen of the dwelling.

Issued for information only - refer to the NatHERS Certificate(s).

File Ref: HEC1482 Project: Address: 1130 Pittwater Road Collaroy NSW 2097 Applicant: Name: Azzwic Holdings Pty Ltd Designer: Map Architects Pty Ltd House Energy Certified Company: PO BOX 3136 Tamarama NSW 2026 DMN/18/4423 Address: Number: 02 9130 2068 paul@houseenergycertified.com Email: Contact: Ext. Walls: Construction Details Insulation Colour Cavity Brick 25mm Kooltherm K8 or equiv (R1.1) Light As per plans Metal Clad R2.5 added Dark As per plans Details Int. Walls: Construction Insulation Plasterboard on Stud R2.5 added To garage Details Insulation Floors: Construction To slab edge where underfloor heating Concrete R1.0 added Concrete R1.1 added Where open below/Above cellar Concrete R4.0 added Above garage Details Ceilings: Construction Plasterboard R4.0 added Where flat R2.5 added Where raked Plasterboard Colour Insulation Details Construction Concrete 90mm PIR or equiv (R4.1) Medium Ground floor roof Metal Deck 60mm Anticon (R1.3) Dark First floor roof Product ID Glass Uw/SHGCw Details Group A ALM-003-03 A Double Clear Aluminium 4.3/0.47 Casement, Entry Door Group B 4.3/0.53 Fixed, Sliding ALM-004-03 A Double Clear Aluminium ALM-002-01 A 6.7/0.70 Group B Single Clear Aluminium Product ID Uw/SHGCw Details Skylights: Glass Type VEL-011-01 W Double Fixed 2.6/0.24 As per plans Roof Light Orientation Terrain Recessed Downlights Software Version 0 Exposed Ducted Sealed LED - 1 per 2.5m2 HFRO

R2.5 added to the walls to roof space Add 1 x 1200 mm ceiling fan to Living room

## Nationwide House Energy Rating Scheme NatHERS Certificate No. #HR-A9E03G-01

Generated on 08 Sep 2023 using Hero 3.0.1

Property 1130 Pittwater Road, Collarov, NSW, 2097 Lot/DP 1/121939

NCC Class\* 1a

Type

## **Plans** Main Plan 2-23-10

Prepared by MA/JG

Construction and environment

Assessed floor area (m2)\* Conditioned\* 266.1 Exposed

71

312.1

Garage 38.9

Accredited assessor

Total

Email

Paul Gradwell House Energy Certified paul@houseenergycertified.com

+61 410315381 DMN/18/4423

Assessor Accrediting DMN

NATIONWIDE HOUSE

63.8 MJ/m<sup>2</sup>

**Thermal Performance** 

Heating Cooling

24.2 39.6 MJ/m<sup>2</sup> MJ/m<sup>2</sup>

## About the rating

NatHERS software models the expected about the design and construction, climate and common patterns of household use. The software does not take into account appliances, apart from the airflow impacts from ceiling fans

## Verification

To verify this certificate, scan the QR code or visit http://www.hero-software.com.au/pdf/HR-A9E03G-01. When using either link, ensure you are

visiting http://www.hero

## National Construction Code (NCC) requirements

The NCC's requirements for NatHERS-stated houses are detailed in 3.12.0(a)(i) and 3.12.5 of the NCC Volume Two. For apartments the requirements are detailed in J0.2 and J5 to J8 of the NCC Volume One.

NatHERS climate zone

56 - Mascot AMO

In NCC 2019, these requirements include minimum star ratings and separate heating and cooling load limits that need to be met by buildings and apartments through the NatHERS assessment. Requirements additional to the NatHERS assessment that must also be satisfied include, but are not limited to: insulation installation methods, thermal breaks, building sealing, water heating and pumping, and artial lighting requirements. The NCC and NatHERS Heating and Cooling Load Limits (Australian Building Codes Board Standard) are available at www.abcb.gov.au.

State and territory variations and additions to the NCC may also apply.

\* Refer to glossary. Generated on 08 Sep 2023 using Hero 3.0.1 for 1130 Pittwater Road, Collaroy, NSW, 2097

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ABN: 37 615 694 356

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checked MA

A0001

drawn MA/JG 1:4.15, 14207, 22209.2326, \$2489, 1:1.99 @ A3

AS1926.1-2012, SWIMMING POOL SAFETY - SAFETY BARRIERS FOR SWIMMING POOLS. AS1926.2-2007, SWIMMING POOL SAFETY - LOCATION OF SAFETY BARRIERS FOR SWIMMING POOLS. AS/NZS 2416.1:2010, WATER SAFETY SIGNS AND BEACH SAFETY FLAGS

- EARTHWORK IS TO COMPLY WITH BCA 2016 TABLE 3.1.1.1 AS REFERENCED IN FIG 3.1.2.1 & CLAUSE 3.1.1.0(B) FOR DETERMINATION OF A NORMAL SITE AS REFERENCED BY CLAUSE 3.2.1.

DRAINAGE IS TO COMPLY WITH AS/NZS 3500.3-2015 OR SECTION 5 OF AS/NZS 3500.5 2012. TERMITE MANAGEMENT IS TO COMPLY WITH BCA 2016 PART 3.1.3 AND AS 3660.1-2014. A DURABLE NOTICE IS TO BE INSTALLED IN ACCORDANCE WITH BCA 2016 PART 3.1.3(b), WHERE A CHEMICAL TERMITE MANAGEMENT SYSTEM IS USED, THE CHEMICAL MUST BE INCLUDED ON

## SITE ACCESS

PROVIDE A SINGLE STABILISED ENTRY/EXIT POINT. SEDIMENT OR BUILDING WASTE SHOULD BE REMOVED FROM THE ROAD BY SWEEPING, SHOVELLING OR SPONGING: NOT WASHING.

DIVERSION OF WATER DIVERT RUN OFF AWAY FROM DISTURBED AREAS AND STOCKPILES USING BANKS AND CHANNELS. RUN OFF SHOULD BE TREATED (BY SEDIMENT FENCE OR THE LIKE) BEFORE LEAVING THE SITE.

ROOF WATER DRAINAGE CONNECT TEMPORARY OR PERMANENT DOWNPIPES TO THE STORM WATER SYSTEM AS SOON AS THE ROOF IS COMPLETE, TO REDUCE SITE WETNESS.

> DUST CONTROLS MINIMISE DISTURBANCES COVER STOCKPILES.

JRK SHOULD COMPLY WITH RELEVAN.
ANDARDS AND BUILDING CODE OF AUSTRALIA I.
ALL WORK SHALL CONFORM TO THE CONTRACT
DOCUMENTS WHICH INCLUDE SPECIFICATIONS, THE
DRAWINGS, ALL ADDENDUMS, FINISHES SCHEDULES. ALL
CONSTRUCTION DRAWINGS SHALL BE READ IN
"ONJUNCTION WITH ALL CONSULTANTS AND
"OTOR DRAWINGS, SCHEDULES AND
"ASE OF CONFLICT BETWEEN
"OAWINGS IN LOCATING
"IMPENT.

# SEDIMENTATION FENCES

FENCES SHOULD BE INSTALLED DOWN SLOPE TO TREAT SITE RUN-OFF. TO BE EFFECTIVE, THEY NEED TO BE INSTALLED PROPERLY

AND MAINTAINED REGULARLY.

## DETAIL 2

GUTTER PROTECTION

GRAVEL SAUSAGES, GRAVEL BAGS OR SAND BAGS SHOULD BE INSTALLED AROUND STORM WATER INLETS TO REDUCE THE RISK OF UNTREATED RUN OFF ENTERING THE WATERWAYS.

## DETAIL 3


STOCKPILES

STOCKPILES SHOULD BE LOCATED UPSLOPE AWAY FROM DRAINAGE LINES

RUN OFF SHOULD BE DIVERTED AWAY FROM THE STOCKPILE. PROTECT STOCKPILES WITH WATERPROOF COVERING.

INSTALL A SEDIMENT CONTROL DEVICE ON THE DOWNSLOPE SIDE OF THE STOCKPILE. STOCKPILES MUST NOT BE STORED ON FOOTPATHS.



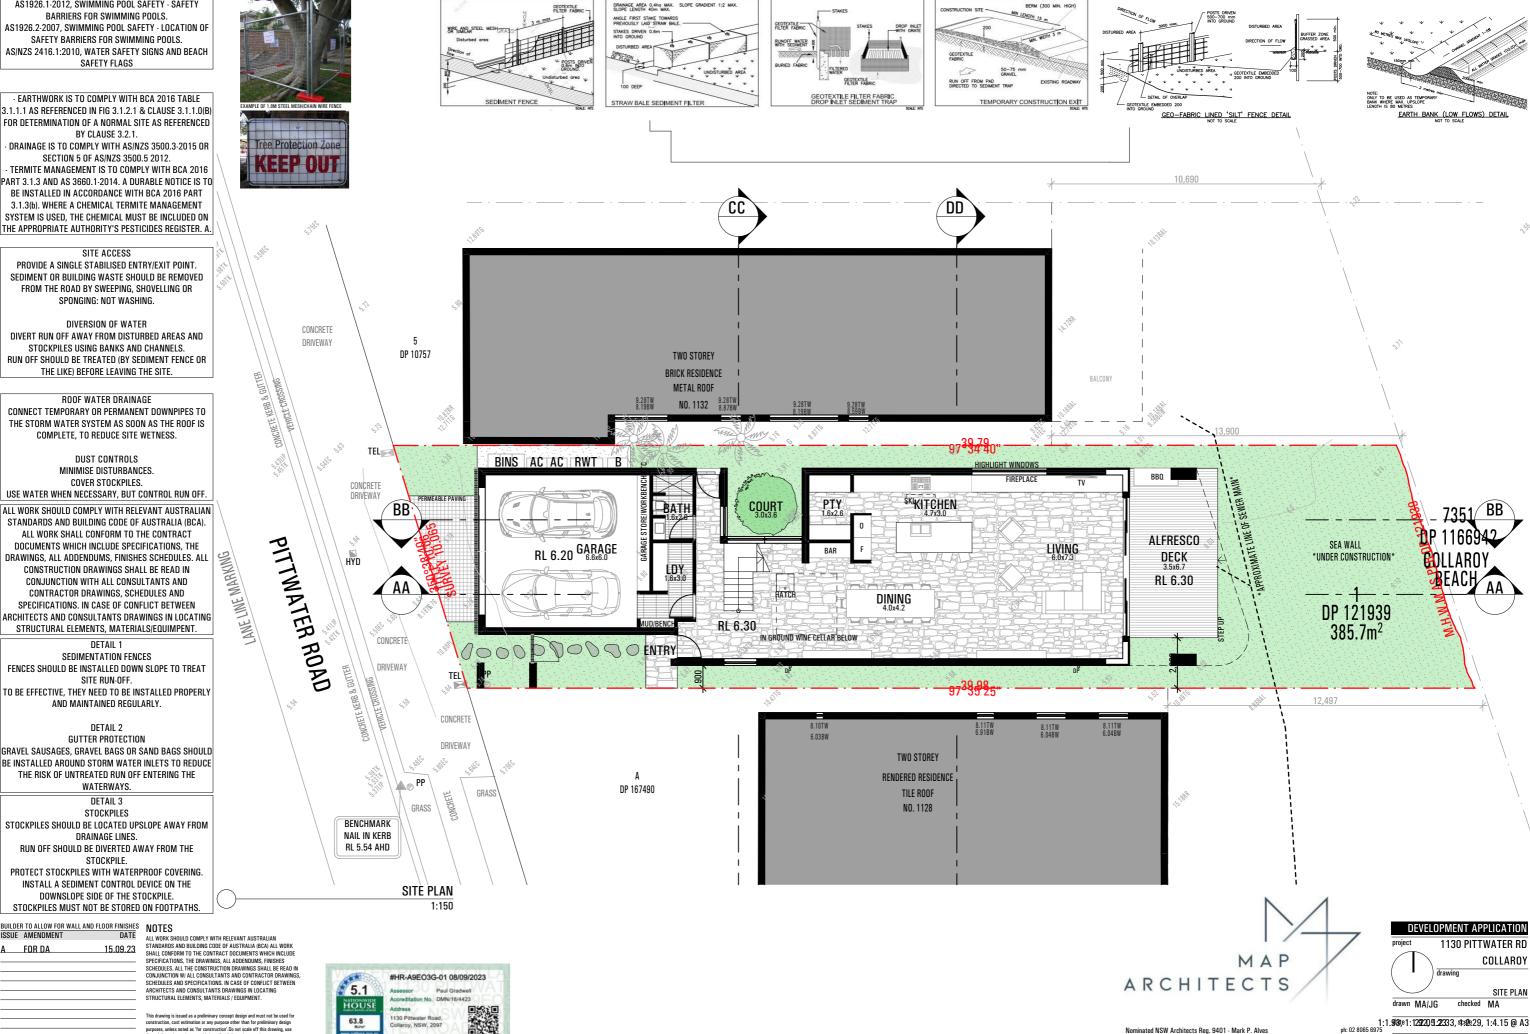

BERM (300 MIN. HIGH)

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A0002

# **DEMOLITION**

STANDARD

DEMOLITION: TO AS 2601 DEMOLISHED MATERIALS

EXCEPT FOR MATERIALS TO BE SALVAGED AND RETAINED BY THE OWNER OR RE-

DEMOLISH MATERIALS AND REMOVE FROM THE SITE

DO NOT BURN OR BURY DEMOLISHED MATERIALS ON THE SITE.

PROVIDE TEMPORARY SUPPORT FOR SECTIONS OF EXISTING BUILDINGS WHICH

BE ALTERED AND WHICH RELY FOR SUPPORT ON WORK TO BE DEMOLISHED. ASBESTOS REMOVAL

METHOD: USE WET REMOVAL METHODS RECOMMENDED IN THE CODE OF PRACTICE FOR

THE REMOVAL OF ASBESTOS (HOHSC: 2002), INCLUDING PART 4 FOR INSULATION

LAGGING, AND PART 9 FOR ASBESTOS CEMENT.

MONITORING: HAVE DUST MONITORING PERFORMED BY AN INDEPENDENT

AUTHORITY

## ELEMENTS TO BE REMOVED


THIS DRAWING IS TO BE READ IN CONJUNCTION WITH DEMOLITION SPECIFICATION, SCHEDULES, ENVIRONMENTAL MANAGEMENT PLAN & DA CONSENT CONDITIONS THE Public Footways & roadways adjacent to the site shall be maitained at ALL TIMES DURING THE COURSE OF THE WORK IN A SAFE CONDITION. LIGHTING, FENCING, TRAFFIC CONTROL & ADVANCED WARNING SIGNS SHALL BE PROVIDED FOR THE PROTECTION OF THE WORKS & THE SAFETY & CONVENIENCE OF THE PUBLIC TO THE SATISFACTION OF THE PCA & IN ACCORDANCE WITH COUNCIL'S STANDARD SPECIFICATION FOR ENGINEERING WORKS. TRAFFIC MOVEMENT IN BOTH DIRECTIONS ON PUBLIC ROADS , AND VEHICLE ACCESS TO PRIVATE PROPERTIES IS TO BE IAINTAINED AT ALL TIMES DURING THE WORKS


CONTRACTOR PRIOR TO THE COMMENCEMENT OF WORKS WILL INSTALL. MAINTAIN

SEDIMENT CONTROL MEASURES AT ALL TIMES. THE MEASURES TO REMAIN IN PROPER OPERATION UNTIL ALL DEVELOPMENT ACTIVITIES HAVE BEEN COMPLETED & THE SITE FILLY STABILISED. REFER TO HYDRALLLIC ENGINEER'S SEDIMENT. CONTROL PLAN DRAWING 0708 SCP:01REVISION B ISSUED 25/07/07. TOILET FACILITIES TO BE PROVIDED DURING DEMOLITION & CONSTRUCTION, AT A RATE OF 1 Toilet to 20 Persons or Part Persons on Site. Demolition must be UNDERTAKEN IN ACCORDANCE WITH PROVISIONS OF AS2601- DEMOLITION OF STRUCTURES, ALL EXISTING WALL FIXINGS, EXPOSED SERVICES, WIRING ETC. NOT REUSED TO BE CAPPED OFF & MADE SAFE, IN ACCORDANCE WITH DEMOLITION SPECIFICATION. ALL FILL & VEGETATION TO EXISTING PLANTERS TO BE REMOVED 8 ANY SERVICE CAPPED WHERE WALLS ARE TO BE REMOVED & NOT REPLACED, THE EXISTING WALLS TO BE MADE GOOD WORK MUST SATISFY APPLICABLE OCCUPATIONAL HEALTH & SAFETY, & CONSTRUCTION SAFETY REGULATIONS, INCLUDING ANY WORK COVER AUTHORITY REQUIREMENTS. SITE FENCE TO BE INSTALLED TO EXCLUDE PUBLIC FROM SITE. SAFETY SIGNS MUST BE FRECTED TO ARN PUBLIC TO KEEP OFF SITE AND PROVIDE A TELEPHONE CONTACT NUMBER FOR ENOUIRIES, WORK COVER AUTHORITY TO BE NOTIFIED IMMEDIATELY IF ANY PART OF THE BUILDING BEING DEMOLISHED OR REMOVED IS IDENTIFIED OR SUSPECTED OF CONTAINING ASBESTOS. THE REQUIREMENTS & STANDARDS IMPOSED BY THE AUTHORITY, ITS CONSULTANTS OR CONTRACTORS SHALL BE COMPLIED WITH. IF REQUIRED CONTRACTOR SHALL ENGAGE QUALIFIED CONSULTANT TO UNDERTAKE ASBESTOS & LEAD PAINT CONTAMINATION SURVEY DEMOLITION WORKS SHALL BE RESTRICTED TO WITHIN THE HOURS OF 8.00AM TO 5 OOPM MONDAY TO ERIDAY ONLY THE RUILDER SHALL DISPLAY ON-SITE THEIR 24 HOUR CONTACT NUMBER, WHICH IS CLEARLY VISIBLE & LEGIBLE FROM ANY PUBLIC PLACE ADJOINING THE SITE NOISE EMISSIONS & VIBRATIONS TO BE MINIMISED. WHERE POSSIBLE & WORK TO BE CARRIED OUT IN ACCORDANCE WITH EPA GUIDLINES & COMPLY WITH THE PROTECTION OF THE ENVIRONMENTAL OPERATIONS ACT 1997. ALL PLANT & EQUIPMENT USED DURING DEMOLITION SHALL BE SITUATED WITHIN THE BOUNDARIES OF THE SITE AND PLACED SO THAT ALL SLURY, WATER AND DEBRIS SHALL BE DISCHARGED & CONTAINED ON SITE. ALL WORK SHOULD COMPLY WITH RELEVANT AUSTRALIAN STANDARDS AND

BUILDING CODE OF AUSTRALIA (BCA) ALL WORK SHALL CONFORM TO THE CONTRACT DOCUMENTS WHICH INCLUDE SPECIFICATIONS THE DRAWINGS ALL ADDENDUMS FINISHES SCHEDULES ALL THE CONSTRUCTION DRAWINGS SHALL BE READ IN CONJUNCTION W/ ALL CONSULTANTS AND CONTRACTOR DRAWINGS, SCHEDULES AND SPECIFICATIONS IN CASE OF CONFLICT BETWEEN ARCHITECTS AND CONSULTANTS DRAWINGS IN LOCATING STRUCTURAL ELEMENTS, MATERIALS / EQUIPMENT.

## Sediment Fences should be installed downslope to treat site run-off. To be effective they need to be installed properly and maintained regularly. SEDIMENT CONTROL MEASURES TO BE INSTALLED PRIOR TO COMMENCING WORK

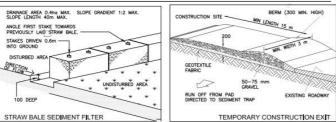


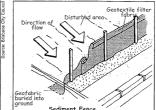

## Gutter Protection

As a precautionary measure, sediment controls such as gravel sausages, gravel bags or sand bags should be installed around stormwater inlets if there is a risk of untreated run-off entering the waterways.



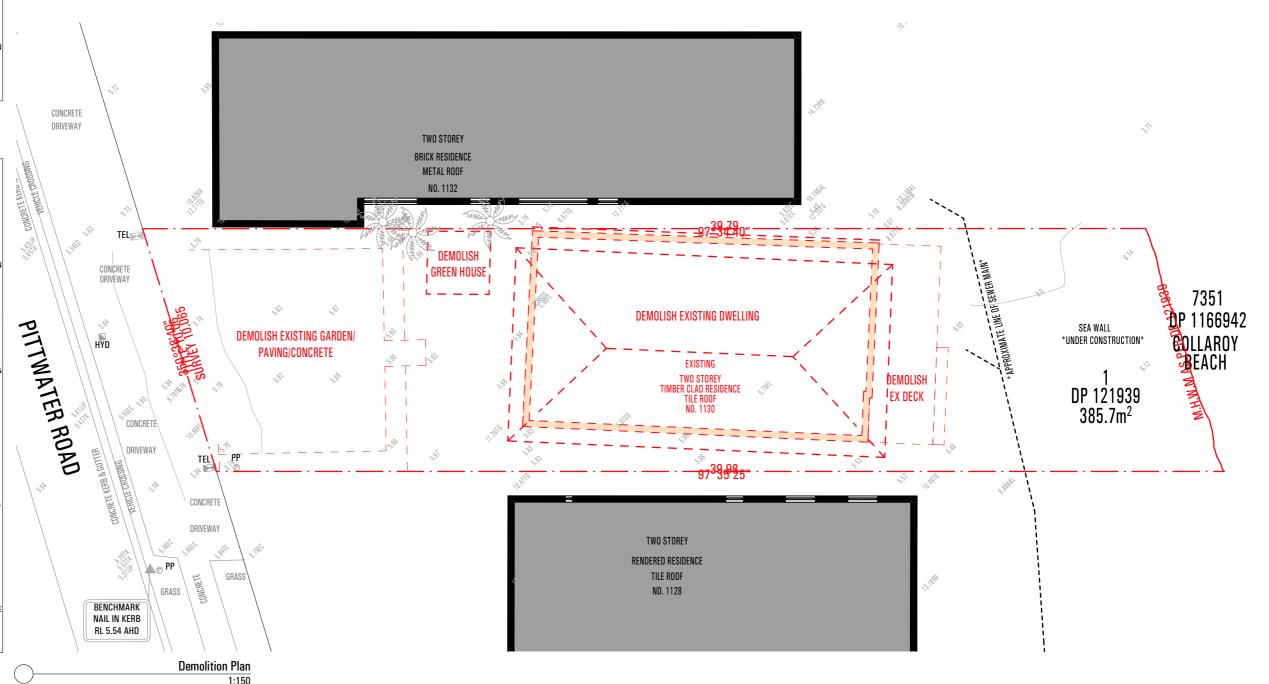



ARCHITECTS


1130 PITTWATER RD COLLAROY DEMOLITION PLAN

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drawn MA/JG





BUILDER TO ALLOW FOR WALL AND FLOOR FINISHES ISSUE AMENDMENT DATE ALL WORK SHO NULES
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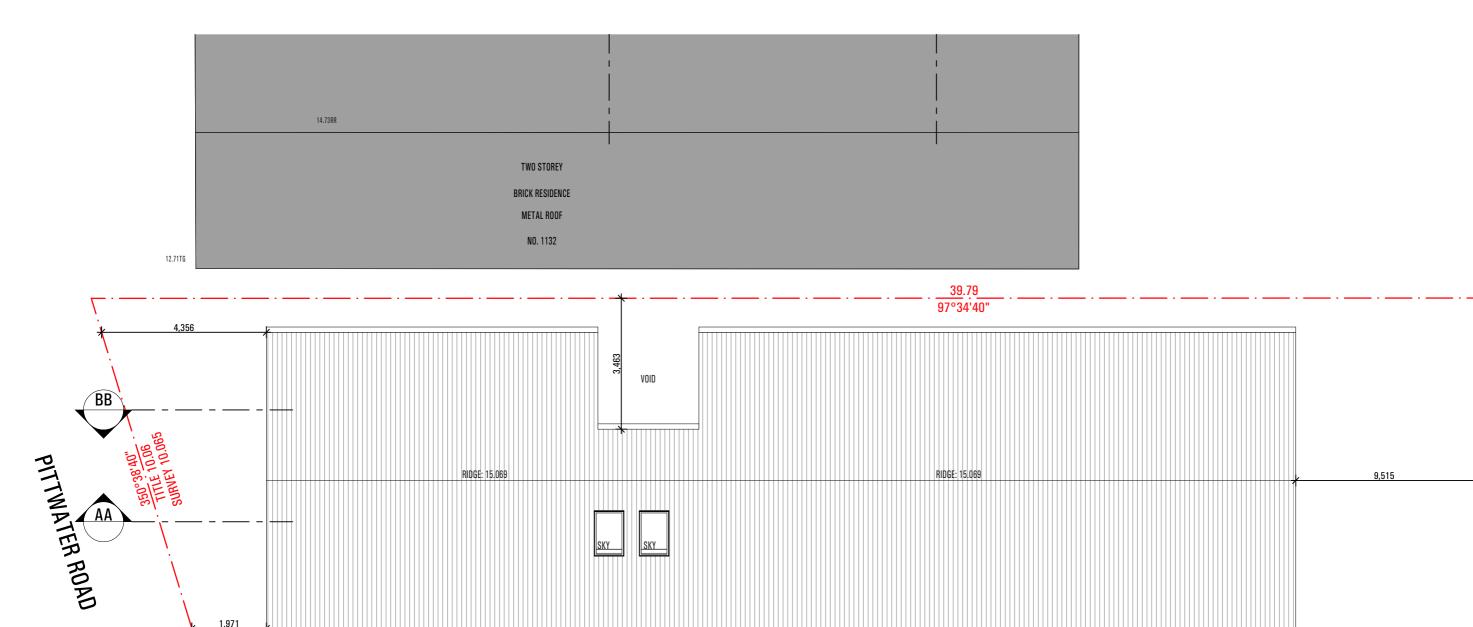


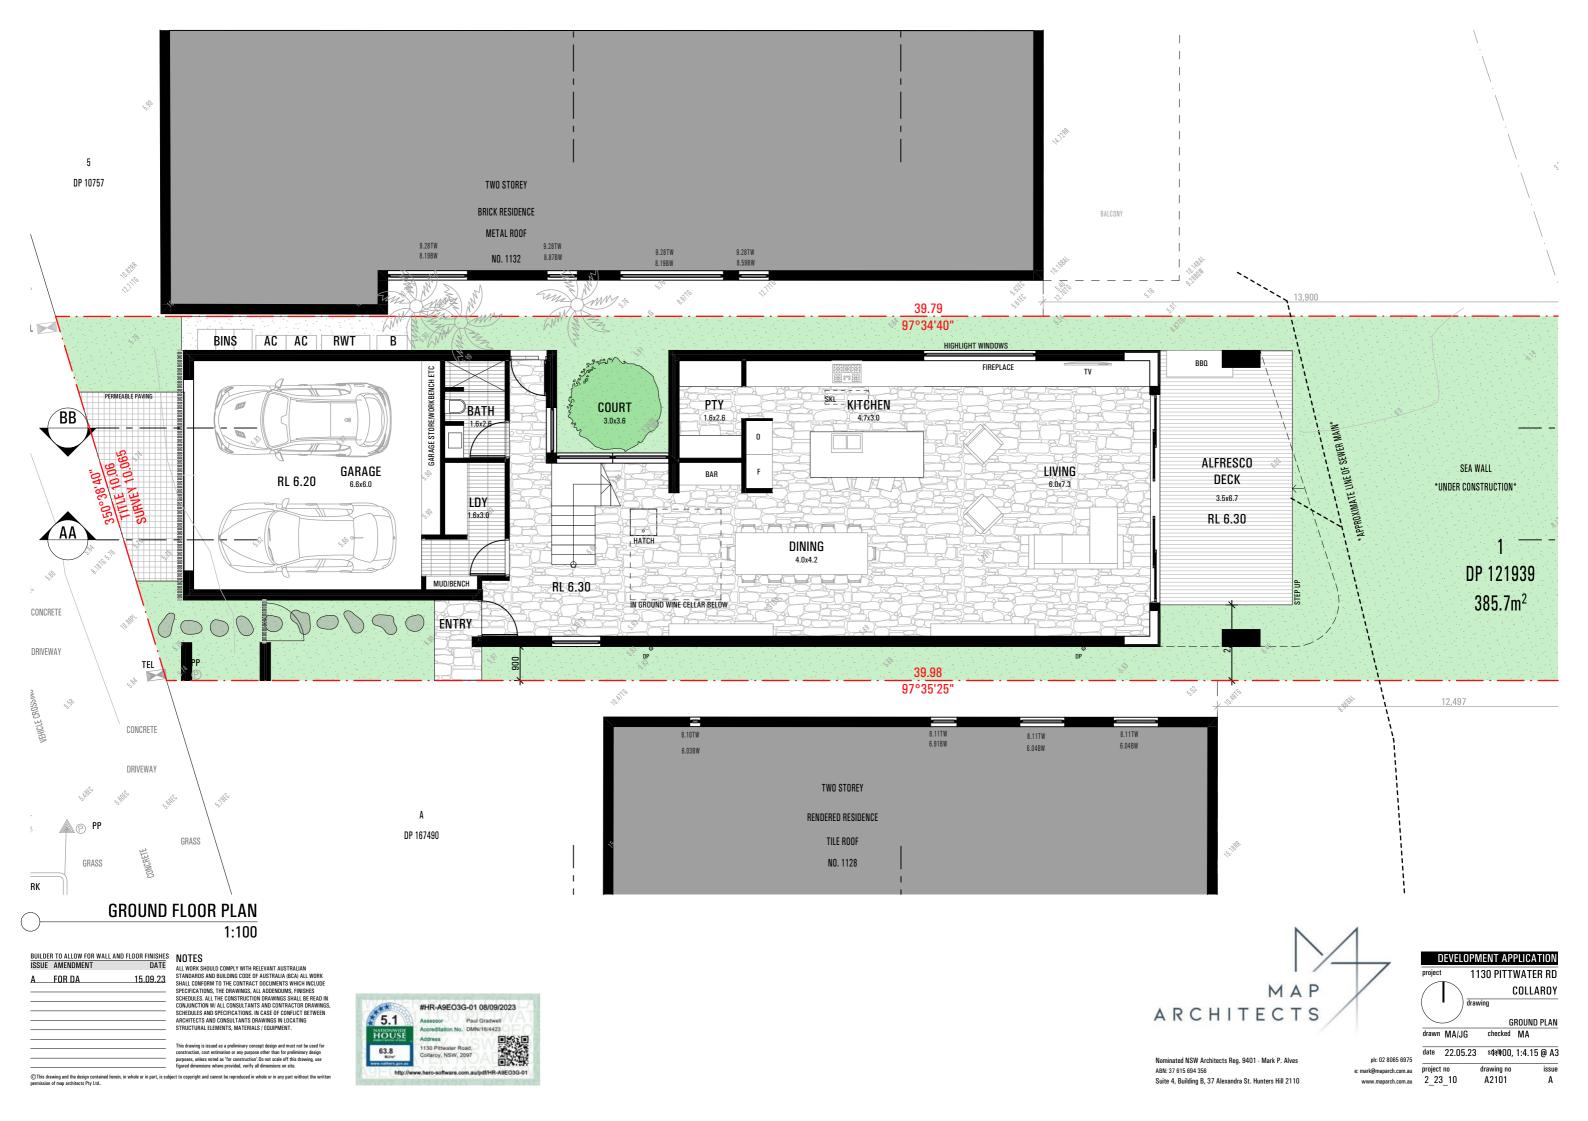

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1130 PITTWATER RD COLLAROY FIRST FLOOR PLAN drawn MA/JG checked MA

date 22.05.23 sqalle00, 1:4.15 @ A3 www.maparch.com.au 2\_23\_10 A2102



39.98 97°35'25" 10.47TG TWO STOREY RENDERED RESIDENCE TILE ROOF 15.13RR NO. 1128



# **ROOF PLAN** 1.100

			1.100
	R TO ALLOW FOR W	ALL AND FLOOR FINISHES DATE	NOTES
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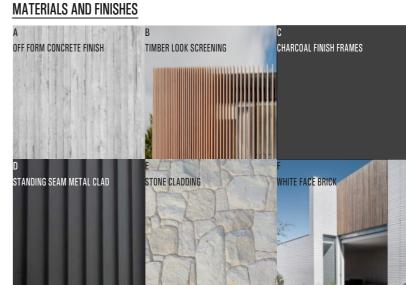




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date 22.05.23 sqal@00, 1:4.15 @ A3 e: mark@maparch.com.au project no drawing no www.maparch.com.au 2\_23\_10 A2103







## NORTH ELEVATION 1:100

BUILDER TO ALLOW FOR WALL AND FLOOR FINISHES
ISSUE AMENDMENT

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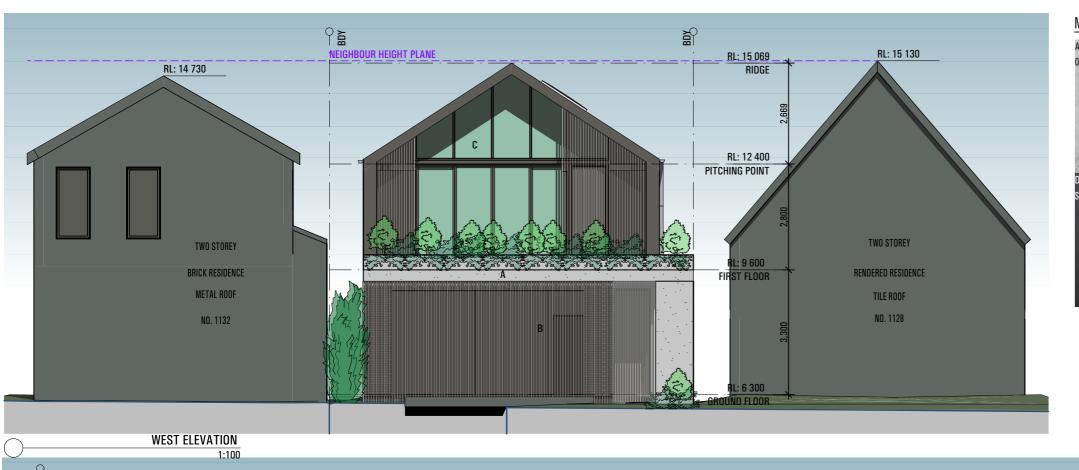



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DEVELOPMENT APPLICATION 1130 PITTWATER RD COLLAROY NORTH/EAST ELEVATION drawn MA/JG checked MA

date 22.05.23 sqalle00, 1:4.15 @ A3 drawing no

e: mark@maparch.com.au project no www.maparch.com.au 2\_23\_10 A3000





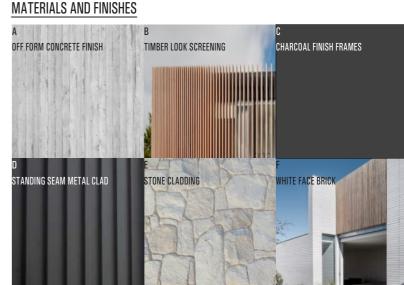

## SOUTH ELEVATION 1:100

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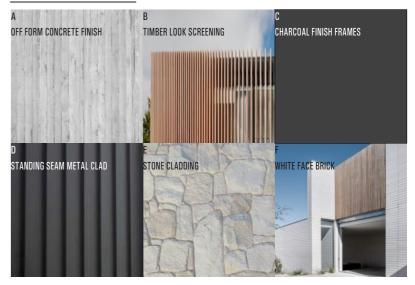
DEVELOPMENT APPLICATION


1130 PITTWATER RD


SOUTH/WEST ELEVATION


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## MATERIALS AND FINISHES





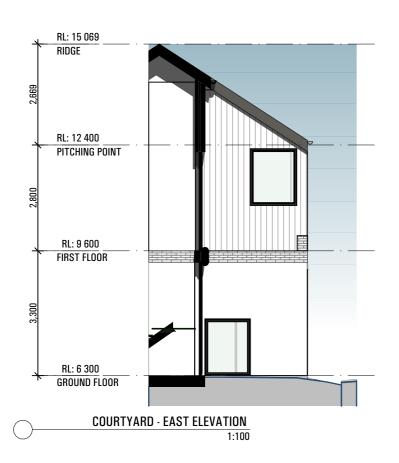

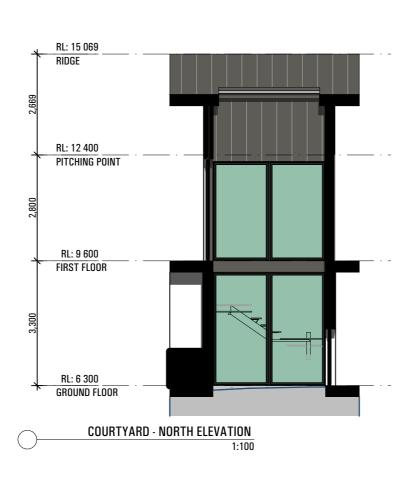
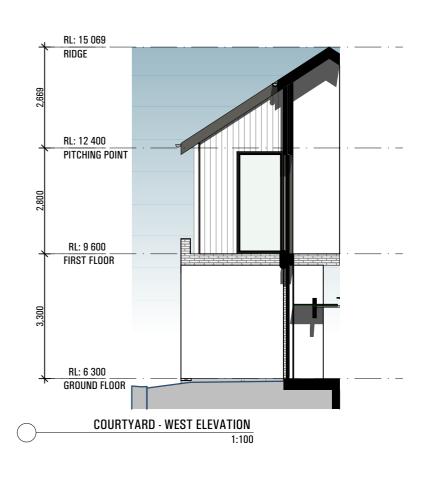
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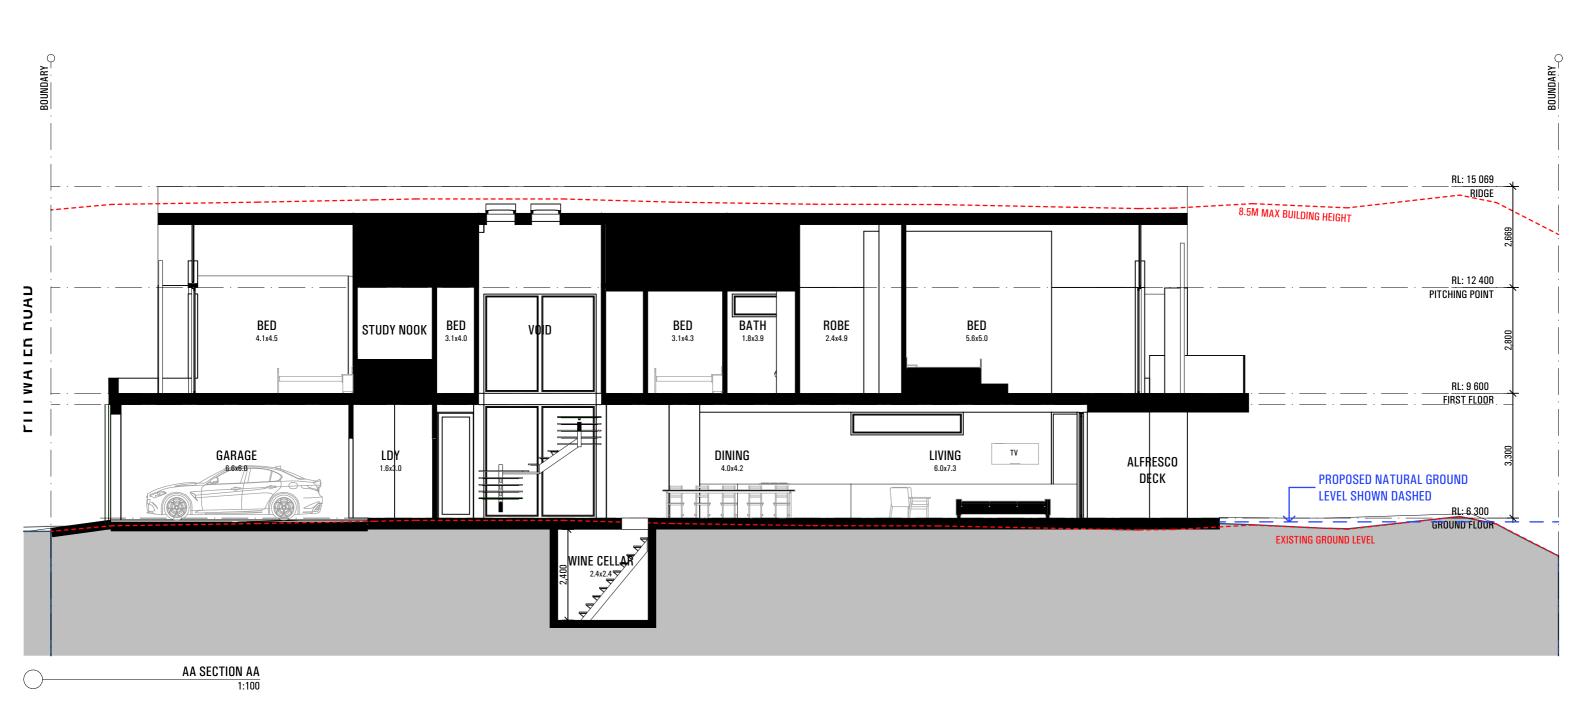



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1130 PITTWATER RD COLLAROY COURTYARD ELEVATIONS drawn MA/JG checked MA

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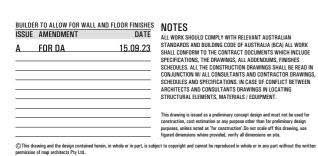


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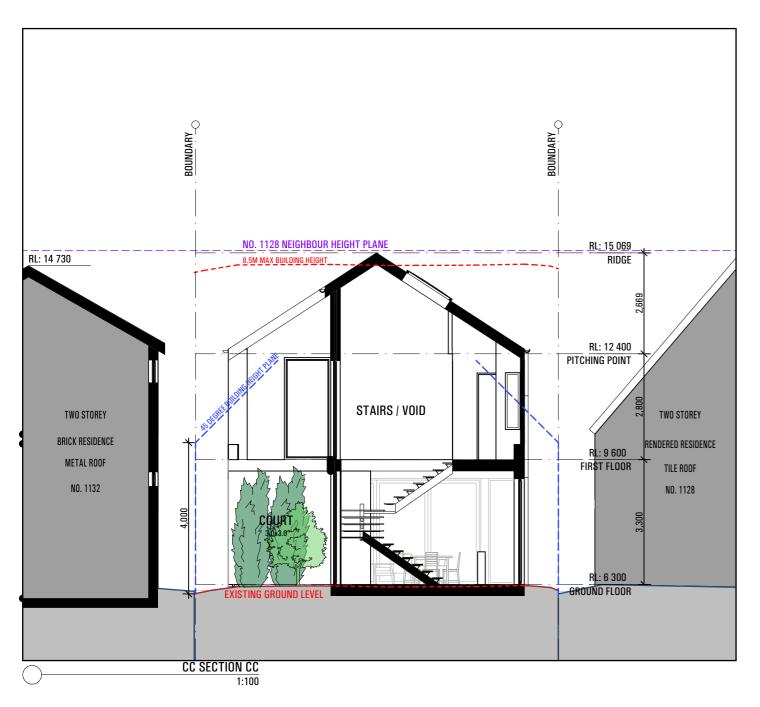



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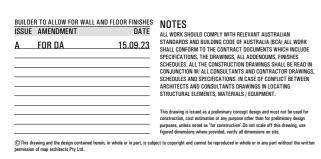
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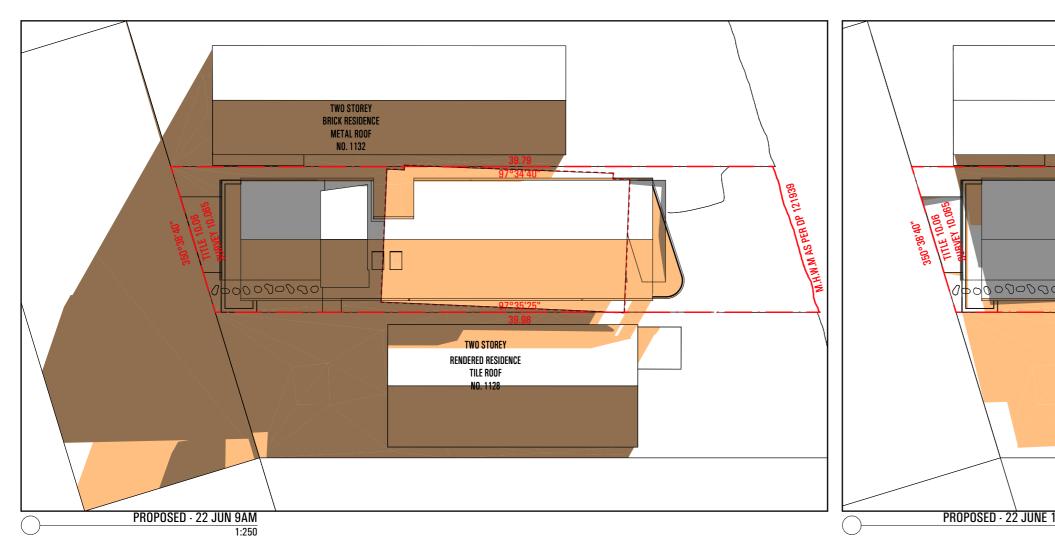




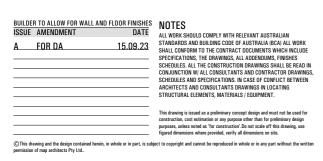



Nominated NSW Architects Reg. 9401 · Mark P. Alves ABN: 37 615 694 356 Suite 4, Building B, 37 Alexandra St. Hunters Hill 2110 DEVELOPMENT APPLICATION 1130 PITTWATER RD COLLAROY SECTION CC/DD drawn MA/JG checked MA

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1:250

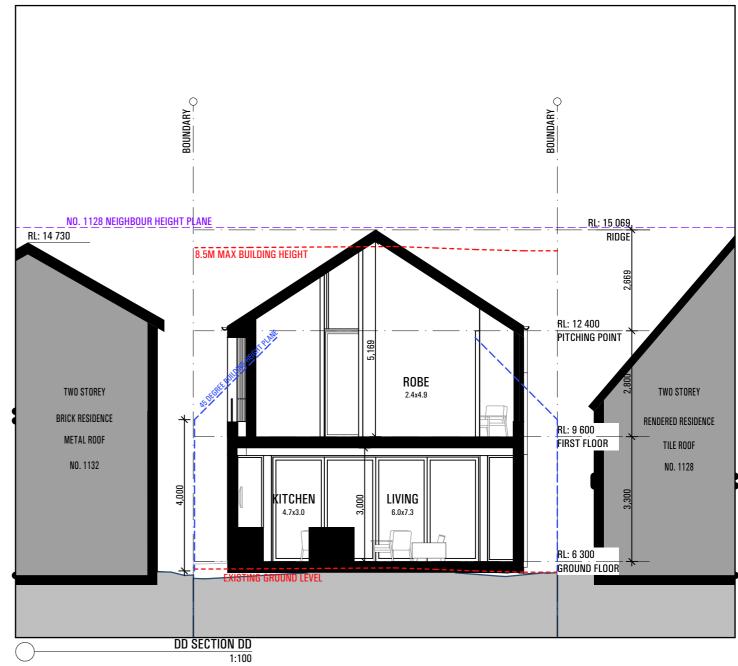



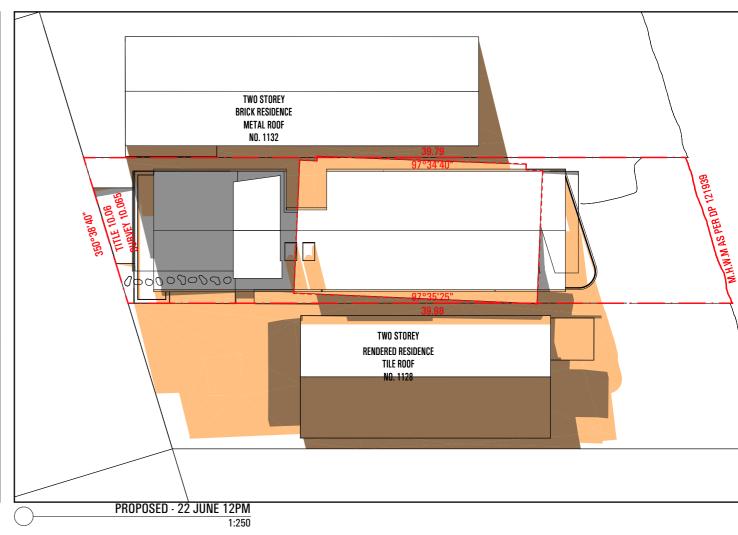

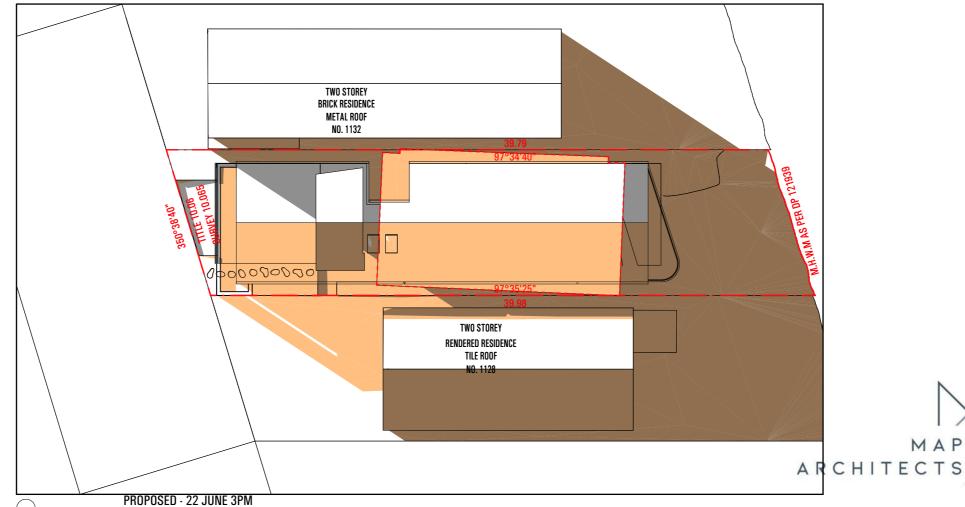NEW SHADOWS

EXISTING SHADOWS

OVERLAPPING SHADOWS

BUILDER TO ALLOW FOR WALL AND FLOOR FINISHES

ISSUE AMENDMENT

DATE

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15.09.23

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MAP

DEVELOPMENT APPLICATION 1130 PITTWATER RD COLLAROY

SHADOW DIAGRAMS drawn MA/JG checked MA

date 22.05.23 scale 1:250 @ A3 e: mark@maparch.com.au project no drawing no www.maparch.com.au 2\_23\_10 A4000

# **DEVELOPMENT SCHEDULE**

SITE AREA 385.70m<sup>2</sup>

**BUILDING FOOTPRINT** 

ALLOWABLE: 128.40m<sup>2</sup> (33.3% x SITE AREA)

**EXISTING:** 125.38m<sup>2</sup> (32%)

PROPOSED: 184.79 m<sup>2</sup> (48%)

DEEP SOIL LANDSCAPING

ALLOWABLE: 154.28m<sup>2</sup> (40% x SITE AREA)

**EXISTING:** 


PROPOSED: ... (30%)


LEGEND:

BUILDING FOOTPRINT



DEEP SOIL LANDSCAPE

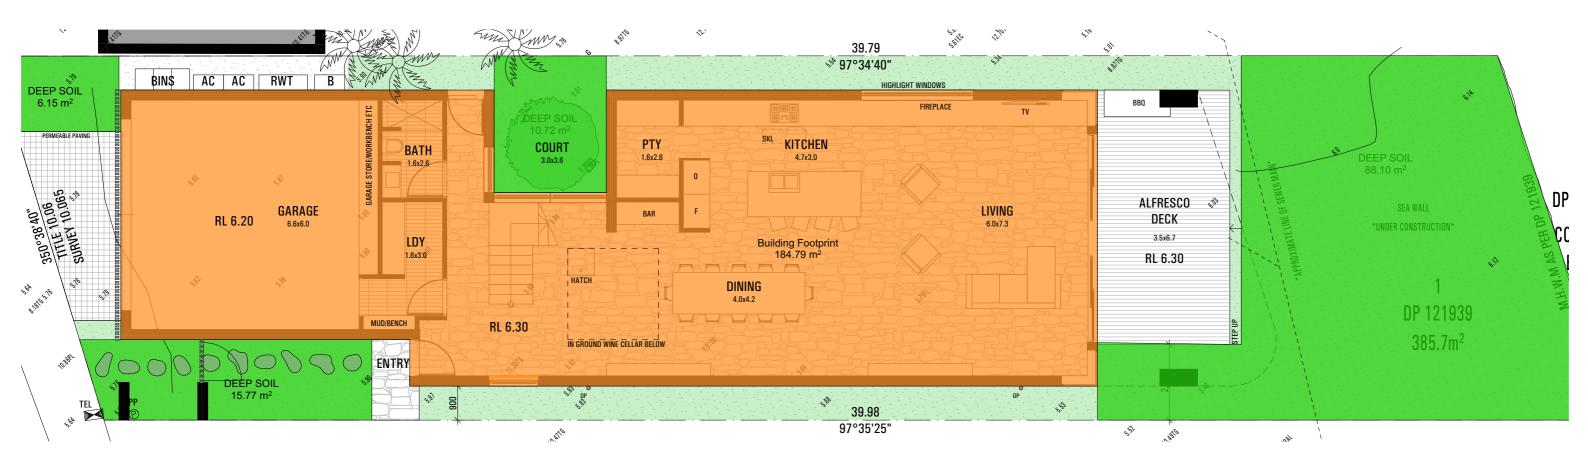

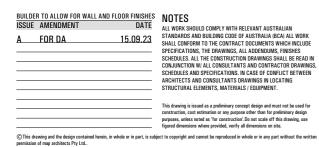



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1130 PITTWATER RD COLLAROY AREA SCHEDULE drawn MA/JG

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# CONTOUR LANDSCAPE ARCHITECTURE

# LANDSCAPE PLAN FOR DA

**PROJECT** 

**Proposed Residence Development** 

**CLIENT** 

**Anthony Aziz** 


**ADDRESS** 

1130 Pitterwater Road,
Collaroy NSW 2097
architects

**ARCHITECT** 





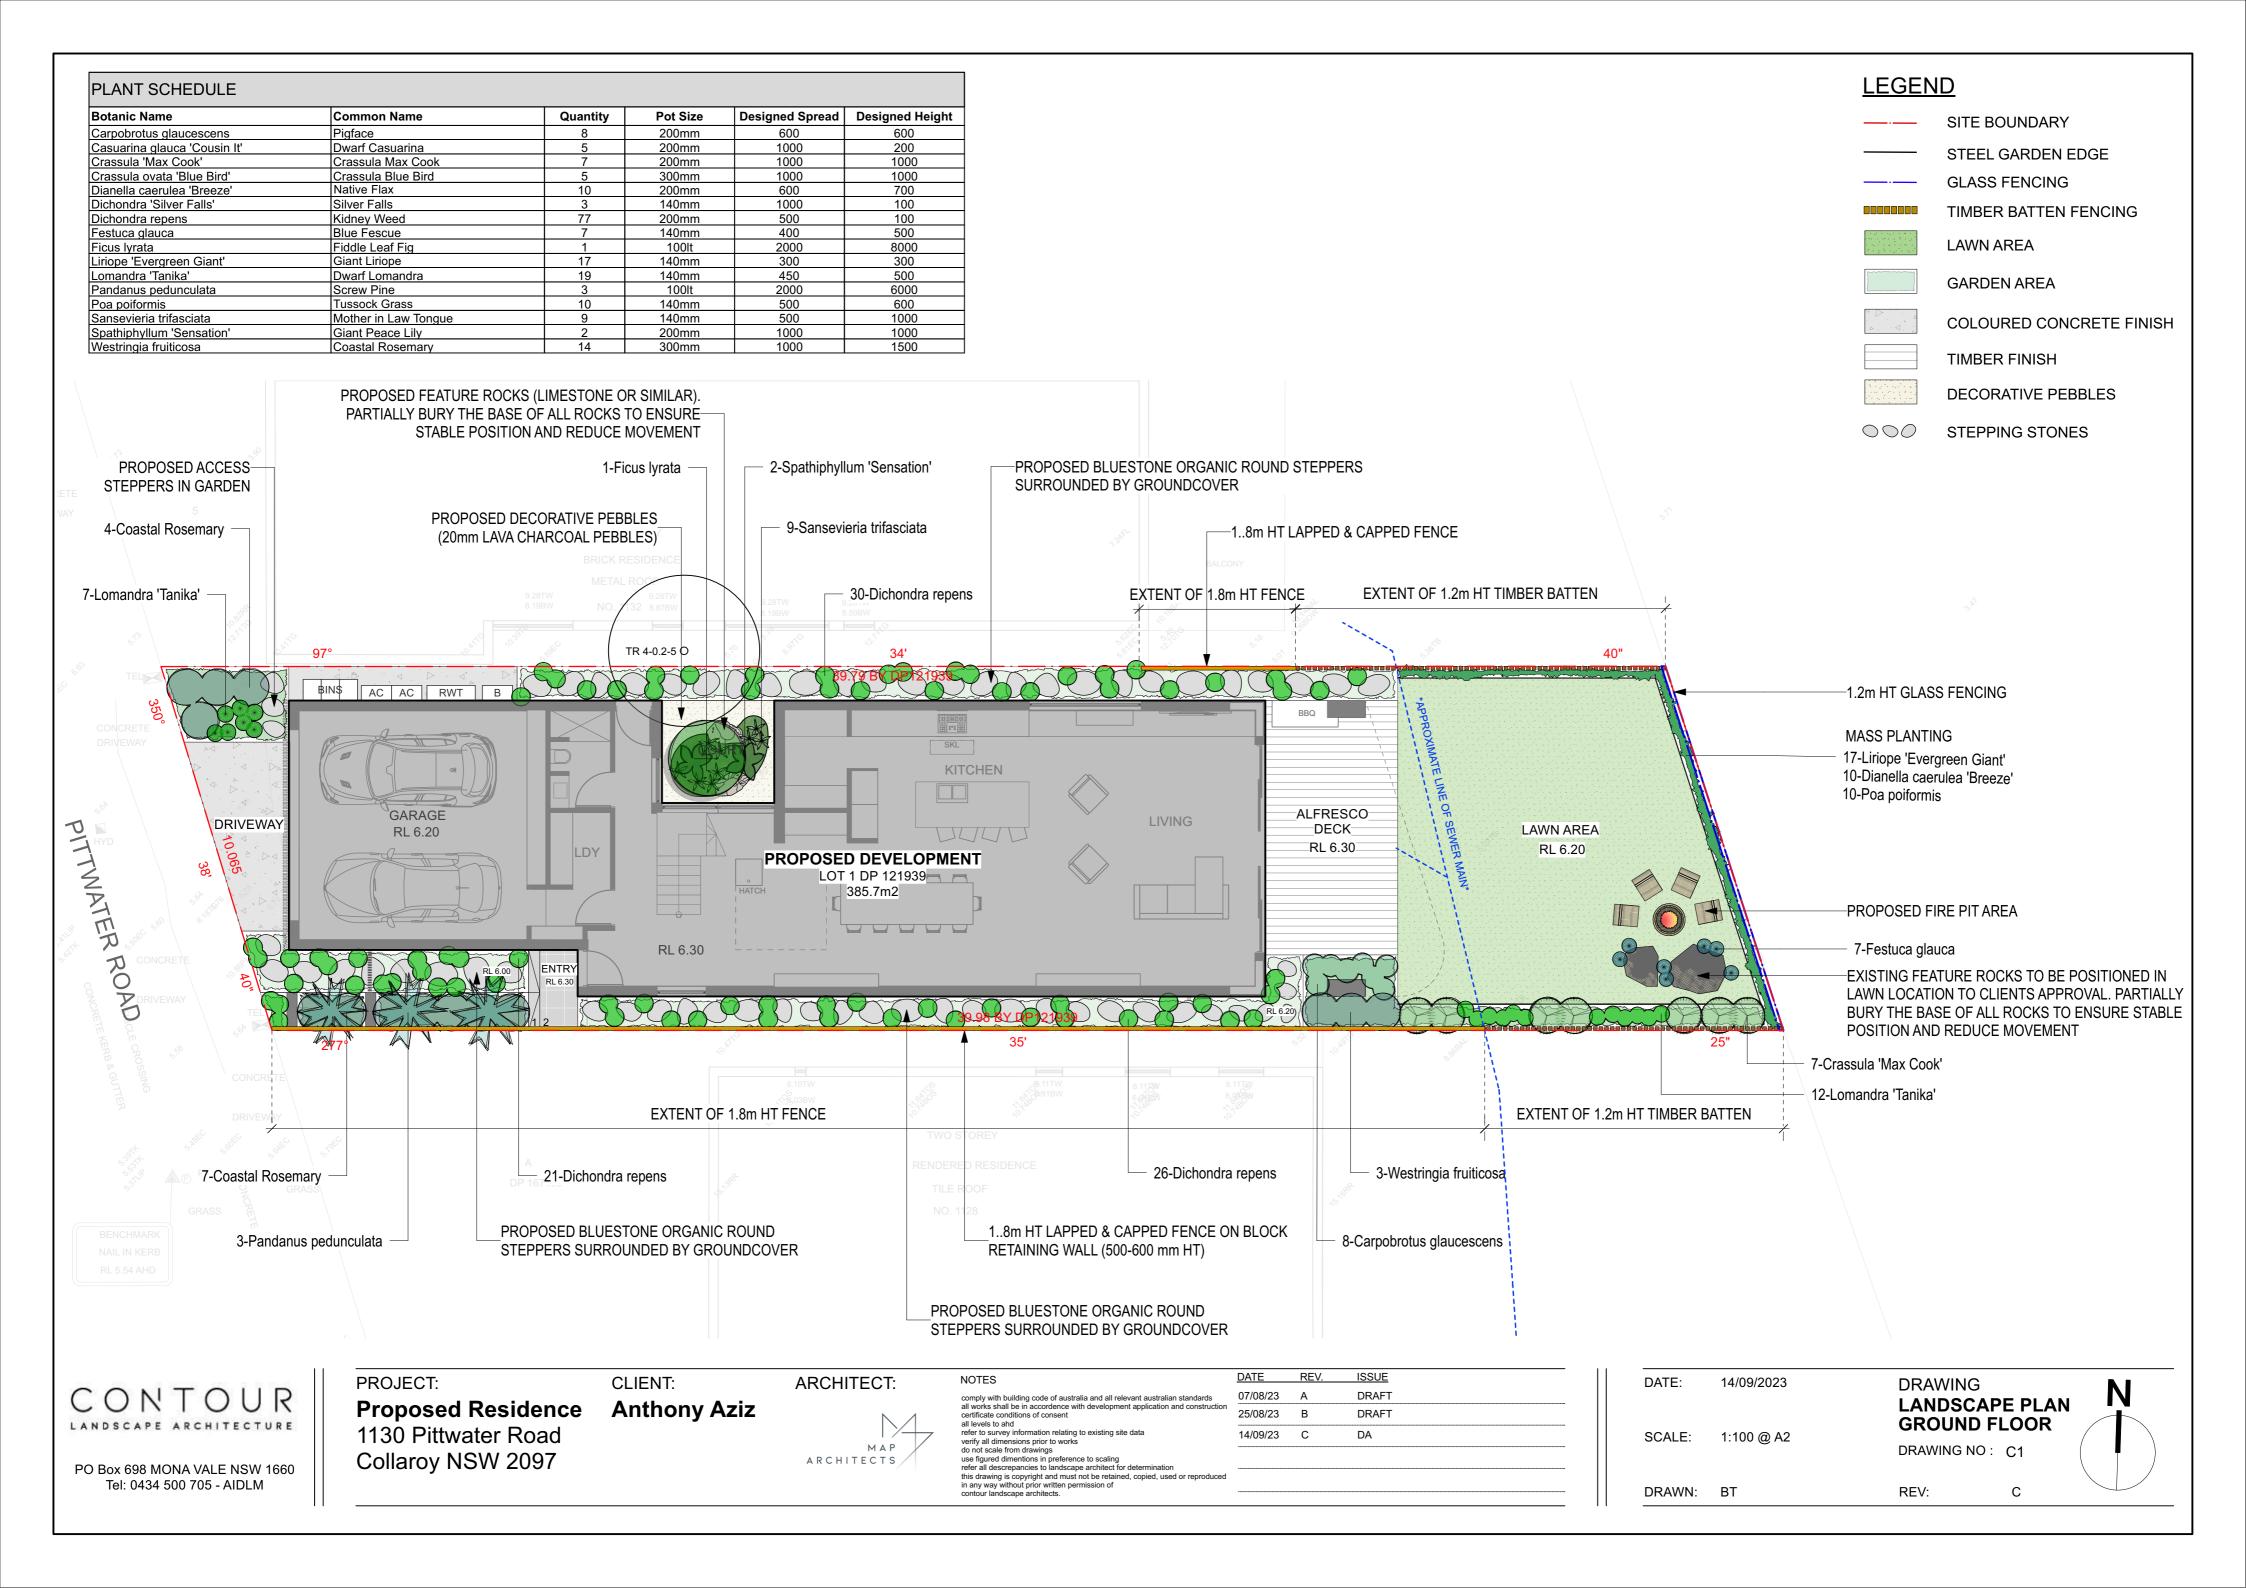























Liriope 'Evergreen Giant'

Lomandra 'Tanika'

Pandanus pedunculata

Poa poiformis

Westringia fruiticosa





Sansevieria trifasciata

Spathiphyllum 'Sensation'

LANDSCAPE ARCHITECTURE

PO Box 698 MONA VALE NSW 1660 Tel: 0434 500 705 - AIDLM

PROJECT:

Proposed Residence Anthony Aziz 1130 Pittwater Road Collaroy NSW 2097

CLIENT:

ARCHITECT:

comply with building code of australia and all relevant australian standards all works shall be in accordence with development application and construction certificate conditions of consent all levels to ahd refer to survey information relating to existing site data verify all dimensions prior to works do not scale from drawings use figured dimentions in preference to scaling refer all descrepancies to landscape architect for determination this drawing is copyright and must not be retained, copied, used or reproduced in any way without prior written permission of contour landscape architects.

MAP ARCHITECTS/

DATE	REV.	ISSUE
07/08/23	Α	DRAFT
25/08/23	В	DRAFT
14/09/23	С	DA
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DATE:	14/09/2023	DRAWING
SCALE:	N/A	PLANTING PALETTE GROUND FLOOR DRAWING NO: C2
DRAWN:	ВТ	REV: C

PLANT SCHEDULE					
Botanic Name	Common Name	Quantity	Pot Size	Designed Spread	Designed Height
Carpobrotus glaucescens	Pigface	8	200mm	600	600
Casuarina glauca 'Cousin It'	Dwarf Casuarina	5	200mm	1000	200
Crassula 'Max Cook'	Crassula Max Cook	7	200mm	1000	1000
Crassula ovata 'Blue Bird'	Crassula Blue Bird	5	300mm	1000	1000
Dianella caerulea 'Breeze'	Native Flax	10	200mm	600	700
Dichondra 'Silver Falls'	Silver Falls	3	140mm	1000	100
Dichondra repens	Kidney Weed	77	200mm	500	100
Festuca glauca	Blue Fescue	7	140mm	400	500
Ficus lyrata	Fiddle Leaf Fig	1	100lt	2000	8000
Liriope 'Evergreen Giant'	Giant Liriope	17	140mm	300	300
Lomandra 'Tanika'	Dwarf Lomandra	19	140mm	450	500
Pandanus pedunculata	Screw Pine	3	100lt	2000	6000
Poa poiformis	Tussock Grass	10	140mm	500	600
Sansevieria trifasciata	Mother in Law Tongue	9	140mm	500	1000
Spathiphyllum 'Sensation'	Giant Peace Lily	2	200mm	1000	1000
Westringia fruiticosa	Coastal Rosemary	14	300mm	1000	1500








Dichondra 'Silver Falls'

Casuarina glauca 'Cousin It'

Crassula ovata 'Blue Bird'

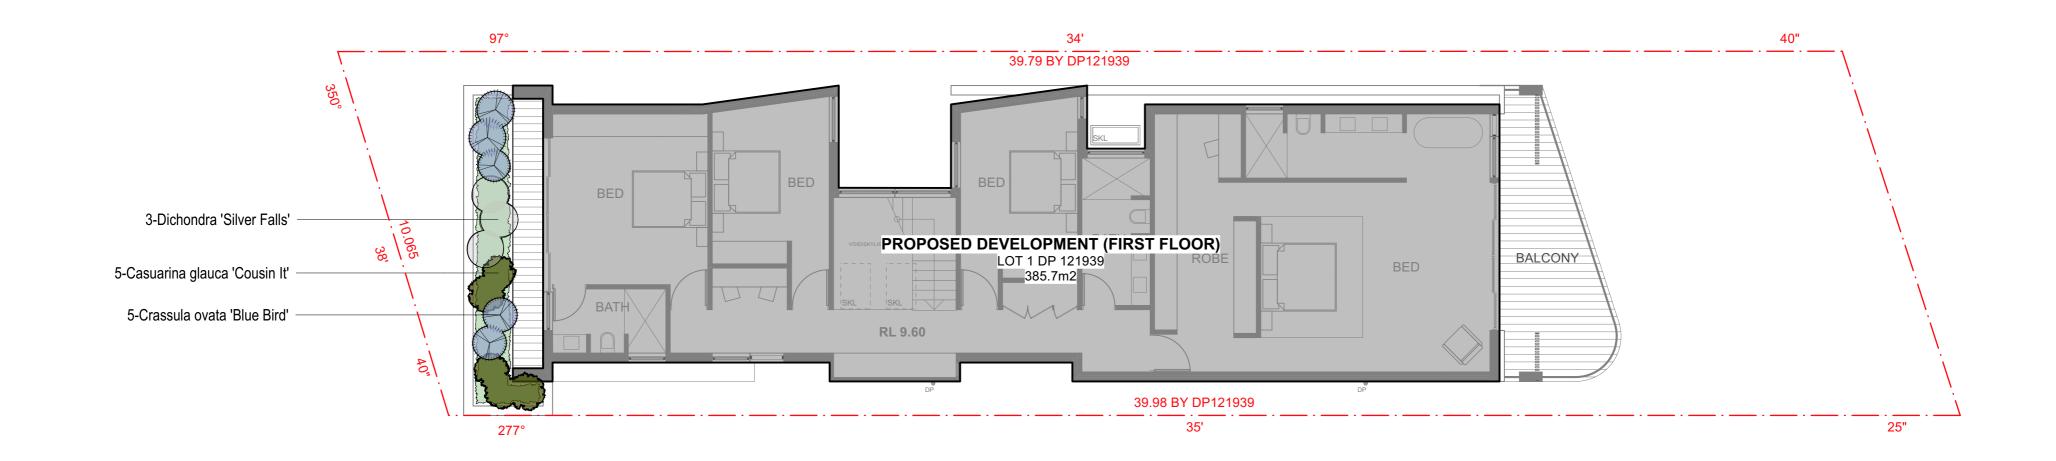

LANDSCAPE ARCHITECTURE

PO Box 698 MONA VALE NSW 1660 Tel: 0434 500 705 - AIDLM

PROJECT: Proposed Residence Anthony Aziz

1130 Pittwater Road Collaroy NSW 2097

CLIENT:


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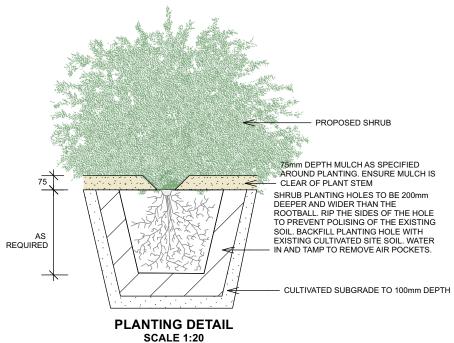
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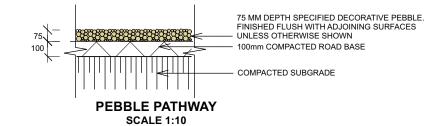
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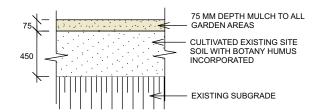
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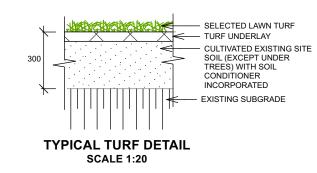








SOIL TO GARDEN AREAS SCALE 1:20

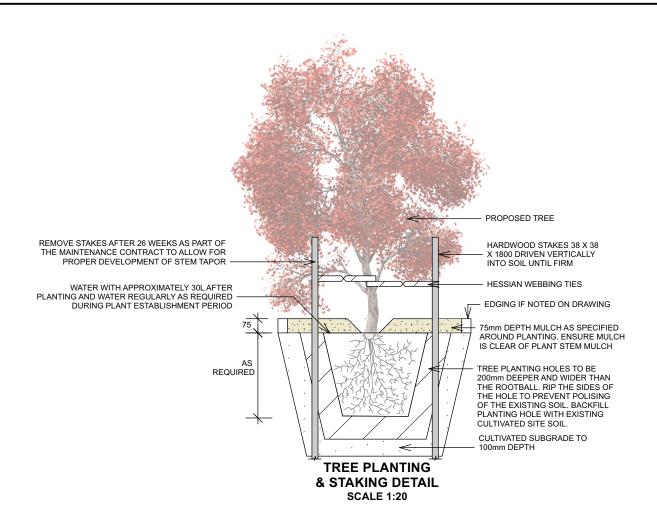

CONTOUR

PO Box 698 MONA VALE NSW 1660 Tel: 0434 500 705 - AIDLM PROJECT:
Proposed Residence
1130 Pittwater Road
Collaroy NSW 2097

CLIENT:

**Anthony Aziz** 

M A P A R C H I T E C T S

ARCHITECT:

NOTES

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SCALE:	SHOWN @A3	DRAWING NO :	C4
DRAWN:	ВТ	REV:	С

## LANDSCAPE SPECIFICATION

ALL LANDSCAPE WORKS SHALL BE EXECUTED BY A COMPETENT LANDSCAPE CONTRACTOR EXPERIENCED IN HORTICULTURAL PRACTICE AND LANDSCAPE CONSTRUCTION. THE CONTRACTOR SHALL HOLD A CURRENT NSW STRUCTURAL LANDSCAPE LICENSE OR BE A MEMBER OF THE NSW LANDSCAPE CONTRACTORS ASSOCIATION. IRRIGATION WORKS SHALL BE EXECUTED BY A CONTRACTOR SUITABLY QUALIFIED AND LICENSED BY THE NSW DEPARTMENT OF FAIR TRADING FOR URBAN IRRIGATION

THESE GENERAL LANDSCAPE SPECIFICATIONS SHALL BE READ IN CONJUNCTION WITH DETAILED DOCUMENTATION PREPARED BY CONTOUR LANDSCAPE ARCHITECTURE, STRUCTURAL ENGINEERING PLANS, STORMWATER ENGINEER PLANS, ARCHITECTURAL DUCUMENTATION AND ALL D.A. CONSENT CONDITIONS.

LANDSCAPE HARDWORKS DEMOLITION, BUILK FARTHWORKS, RETAINING WALLS, STONE FACING, PLANTER BOXES, PAVING, DRAINAGE, WATERPROOFING FENCING AND ALL SITE CONSTRUCTION INDICATED SHALL BE EXECUTED IN ACCORDANCE WITH LANDSCAPE ARCHITECTURAL, ARCHITECTURAL + ENGINEERING SPECIFICATIONS LANDSCAPE WORKS SHALL GENERALLY BE UNDERTAKEN IN ACCORDANCE WITH DA APPROVED PLANS AND CONSTRUCTION CERTIFICATE PLANS AND DETAILS AND SHALL BE COMPLIANT WITH:

AS4970-2009 Protection of trees on development sites

AS 4970-2009/Amdt 1-2010 Protection of trees on development sites

AS4373-2007 Pruning of amenity trees

AS4419-2003 Soils for landscaping and garden use

AS4454-2012 Composts, soil conditioners and mulches

AS3743-2003 Potting mixes

AS/NZ3500:2015 Plumbing and drainage Set

BEFORE LANDSCAPE WORK IS COMMENCED THE LANDSCAPE CONTRACTOR IS TO ESTABLISH THE POSITION OF ALL SERVICES LINES AND ENSURE TREE PLANTING IS CARRIED OUT AT LEAST 3 METRES AWAY FROM THESE SERVICES. SERVICES LIDS, VENTS AND HYDRANTS SHALL BE LEFT EXPOSED AND NOTE COVERED BY ANY LANDSCAPE FINISHES (TURNING, PAVING, GARDEN BEDS ETC.) FINISH ADJOINING SURFACES FLUSH WITH PIT LIDS

## MANAGEMENT OF TREE PROTECTION (AS REQUIRED)

A QUALIFIED AND APPROVED ARBORIST IS TO BE CONTRACTED TO UNDERTAKE OR MANAGE THE INSTALLATION OF PROTECTIVE FENCING, AND TO UNDERTAKE SUCH MEASURES AS THEY DEEM APPROPRIATE TO PRESERVE THE SUBJECT TREES TO BE RETAINED. THE ARBORIST IS TO BE RETAINED FOR THE ENTIRE CONTRACT PERIOD TO UNDERTAKE ONGOING MANAGEMENT AND REVIEW OF THE TREES.

CARE SHALL BE TAKEN DURING THE ENTIRE PERIOD OF WORKS TO ENSURE NO DAMAGE TO ROOTS OR CANOPIES OF TREES TO BE RETAINED. NO STORING OF BUILDING MATERIALS, WASHING OF EQUIPMENT, DISPOSAL OF CHEMICALS, ETC. SHALL BE PERMITTED BENEATH CANOPY OF TREES TO BE RETAINED.. NO EXCAVATION OR TRENCHING SHOULD OCCUR BENEATH CANOPIES EXCEPT FOR COUNCIL-APPROVED WORKS. ALL EXCAVATION BENEATH TREE CANOPIES SHALL BE UNDERTAKEN TO COUNCIL / PROJECT ARBORIST INSTRUCTIONS. PROJECT ARBORIST SHALL BE ADVISED AND ATTEND SITE IF TREE ROOTS GREATER THAN 50MM DIAMETER ARE ENCOUNTERED.

## PREPARATION BY BUILDER

BUILDER SHALL REMOVE ALL EXISTING CONCRETE PATHWAYS, FENCES, FOOTINGS, WALLS, ETC. NOT NOTATED TO BE RETAINED AND COMPLETE ALL NECESSARY EXCAVATION WORK PRIOR TO COMMENCEMENT ON SITE BY LANDSCAPE CONTRACTOR. BUILDER SHALL ALSO INSTALL NEW RETAINING WALLS. KERBS, LAYBACK KERB, CROSSOVER, PATHWAYS, ETC. AND MAKE GOOD ALL EXISTING KERBS, GUTTERS, ETC. AS NECESSARY AND TO APPROVAL OF COUNCIL. BUILDER SHALL ENSURE THAT A MINIMUM 600MM OF TOPSOIL IN GARDEN AREA AND A MINIMUM 150MM OF TOPSOIL IN LAWN AREAS EXISTS. SHOULD REQUIRED DEPTHS NOT EXIST BUILDER SHALL CONTACT LANDSCAPE ARCHITECT AND ASK FOR INSTRUCTIONS PRIOR TO COMPLETION OF EXCAVATION WORKS.

ALL LEVELS AND SURFACE DRAINAGE SHALL BE DETERMINED BY OTHERS AND APPROVED ON SITE BY LANDSCAPE CONTRACTOR.

## SOIL PREPARATION + PLANTING SOILS

CULTIVATE TO A DEPTH OF 450MM ALL PROPOSED GARDEN AREAS AND 300mm FOR ALL LAWN AREA. DO NOT CULTIVATE BENEATH EXISTING TREES TO BE RETAINED. IN AREAS WHERE FILL IS REQUIRED GAIN REQUIRED SHAPES AND LEVELS USING A PREMIUM GRADE SOIL MIX. IN AREAS WHERE EXCAVATION IS REQUIRED (IF IN CLAY) OVER EXCAVATE AS REQUIRED TO ALLOW FOR INSTALLATION OF 600MM DEPTH OF PREMIUM GRADE TOPSOIL MIX TO GARDEN AREAS AND 300M DEPTH OF PREMIUM GRADE TOPSOIL MIX TO LAWN AREAS.

BEFORE LAYING TOPSOIL, THE FOLLOWING SUBGRADE TREATMENT MUST BE APPLIED TO ALL FINISHED SUBGRADE AREAS:

- 1. FAIR + TRIM TO RELATIVE LEVEL TO ACCOMMODATE REQUIRE OVERALL SOIL DEPTH
- 2.REMOVE ROCK >100mm DIAMETER
- 3. REMOVE RUBBISH SUCH AS CONSTRUCTION GENERATED WASTER, PLASTICS, METALS, GLASS
- 4. APPLY GYPSUM AND LIME AT MANUFACTURER'S RECOMMENDED RATES
- 5. LOOSEN SUBGRADE TO 200mm DEPTH LEAVING SURFACE 'KEYED' TO ACCEPT TOPSOIL

CONTRACTOR SHALL UNDERTAKE PH TESTS AND ADJUST WHERE NECESSARY TO ACHIEVE A PH WITHIN THE 5.5 - 7.5 RANGE. MIX IN GYPSUM AT MANUFACTURER'S RECOMMENDED RATES IF CLAY SOIL ENCOUNTERED.

UNDERTAKE ALL REQUIRED ACTION TO ENSURE THAT NO ROOTBALLS OF PROPOSED PLANTS SIT IN CLAY WELLS AND THAT ALL GARDEN AREAS AND LAWN AREAS DRAIN SATISFACTORILY. NOTE IT IS INTENDED THAT WHEREVER POSSIBLE EXISTING LEVELS SHALL NOT BE ALTERED THROUGH GARDEN AND LAWN AREAS. IT IS THE CONTRACTOR'S RESPONSIBILITY TO ENSURE THAT THE END RESULT OF THE PROJECT IS THAT ALL LAWN AND GARDEN AREAS DRAIN SUFFICIENTLY (BOTH SURFACE AND SUBSTRATE), ARE AT REQURIED FINISH LEVELS AND HAVE SUFFICIENT SOIL DEPTHS TO ENABLE LAWN AND PLANTS TO THRIVE AND GROW. SHOULD ALTERNATIVE WORKS TO THOSE SPECIFIED REQUIRED TO ACHIEVE THAT RESULT, CONTRACTOR SHALL INFORM BUILDER AT TIME OF TENDER AND REQUEST INSTRUCTIONS.

CLIENT:

## **PLANTING**

ALL PLANTS SHALL BE WELL GROWN AND DISEASE FREE PLANTING SHALL BE IN ACCORDANCE WITH PLANTING SCHEDULE. TREES SHALL BE GROWN TO NATSPEC, GENERAL PLANT MATERIAL (EXOTICS AND ENDEMIC) SUPPLY PLANTS IN ACCORDANCE WITH PLANTING SCHEDULE, NO SUBSTITUTIONS ARE PERMITTED WITHOUT THE CONSENT OF THE SUPERVISING LANDSCAPE ARCHITECT. PLANT MATERIAL SHALL BE GROWN TO NATSPEC AND SHALL BE VIGOROUS, WELL ESTABLISHED, FREE OF DISEASE AND PESTS, HARDENED OFF, TRUE TO FORM, AND GROWN IN THEIR FINAL CONTAINERS FOR NOT LESS THAN 12 WEEKS TREES SHALL HAVE A SINGLE LEADING SHOOT AND POTS FREE FROM WEEDS.

IMMEDIATELY REJECT DRIED OUT, DAMAGED OR UNHEALTHY PLANT MATERIAL BEFORE PLANTING.

PLANT HOLES SHALL BE DUG APPROXIMATELY TWICE THE WIDTH AND TO 100MM DEEPER THAN PLANT ROOTBALLS THAT THEY ARE TO RECEIVE. BASE AND SIDES OF HOLE SHALL BE FURTHER LOOSENED. FERTILISER, FOLLOWED BY 100MM DEPTH OF TOPSOIL MIX SHALL THEN BE PLACED INTO BASE OF HOLE AND LIGHTLY CONSOLIDATED. BASE OF HOLE SHALL THEN BE WATERED. REMOVE PLANT CONTAINER AND INSTALL PLANT INTO HOLE. ROOTBALL SHALL BE BACKFILLED WITH SURROUNDING TOPSOIL AND TOPSOIL FIRMED INTO PLACE. AN APPROVED SHALLOW DISH SHALL BE FORCED TO CONTAIN WATER AROUND BASE OF STEM, BASE OF STEM OF PLANT SHALL FINISH FLUSH WITH FINISHED SOIL LEVEL. ONCE INSTALLED PLANT SHALL BE THOROUGHLY WATERED AND MAINTAINED FOR THE DURATION OF THE CONTRACT.

THE LANDSCAPE CONTRACTOR SHALL REPLACE OR ADJUST PLANT STAKES, AND TREE GUARDS AS NECESSARY OR AS DIRECTED BY THE LANDSCAPE

STAKES SHALL BE STRAIGHT HARDWOOD, FREE FROM KNOTS AND TWISTS, POINTED AT ONE END AND SIZED ACCORDING TO THE SIZE OF PLANTS TO BE STAKED:

- 5-15 LITRE SIZE PLANT 1X 1200 X 25 X 25MM
- 35-75 LITRE SIZE PLANT 2X 1500 X 38 X 38MM
- 100+ LITRE SIZE PLANT 3X 1800 X 50 X 50MM

TIES SHALL BE 50MM WIDE HESSIAN WEBBING OR APPROVED EQUIVALENT NAILED OR STAPLED TO STAKE, DRIVE STAKES A MINIMUM ONE THIRD OF THEIR LENGTH, AVOIDING DAMAGE TO THE ROOT SYSTEM, ON THE WINDWARD SIDE OF THE PLANT.

## **FERTILIZER**

AT PLANTING SPREAD SLOW RELEASE FERTILIZER AROUND DRIP LINE OF ALL PLANTS AT MANUFACTURER'S RECOMMENDED RATES GENERAL APPLICATION:

EQUAL TO OSMOCOTE PLUS TRACE ELEMENTS - ALL PURPOSE NPK 19.4: 1.6:6

NATIVE PLANTS: EQUAL TO OSMOCOTE PLUS TRACE ELEMENTS - NATIVE GARDENS NPK 17.9: 0.8: 7.3

SHALL BE WELL-ROTTED BEGETATIVE MATTER OR ANIMAL MANURE, OR OTHER APPROVED MATERIAL, FREE FROM HARMFUL CHEMICALS, GRASS AND WEEK GROWTH AND WITH NEUTRAL PH. PROVIDE A CERTIFICATE OF PROOF OF PH UPON REQUEST.

ENSURE ALL MULCH IS FREE OF WEED SEED AND VEGETATIVE MATERIAL. PROVIDE SAMPLE OF MULCH FOR CLIENT APPROVAL PRIOR TO DELIVERY.

PLACE MULCH TO REQUIRED DEPTH, (REFER TO DRAWINGS) CLEAR OF PLANT STEMS, AND RAKE TO AN EVEN SURFACE FINISHING 25MM BELOW ADJOINING LEVELS. ENSURE MULCH IS WATERED IN AND TAMPED DOWN DURING INSTALLATION.

EDGING SHALL BE INSTALLED AT THE JUNCTION OF LAWN AND GARDEN AREAS AS INDICATED ON DRAWINGS (REFER TO DETAIL), EDGE SHALL BE FINISHED LEVEL WITH LAWN OR ADJOINING GRAVEL. EDGE

TURF SHALL BE 'SIR WALTER' BUFFALO. TURF ROLLS SHALL BE A MINIMUM OF 25mm THICK SUPPLIED FROM A SPECIALIST GROWER OF CULTIVATED TURF. IT SHALL BE OF EVEN THICKNESS, FREE FROM WEEDS. TURF SHALL BE DELIVERED WITHIN 24HRS OF CUTTING AND LAID WITHIN 24 HRS OF DELIVERY. CONTRACTOR SHALL LAY CLOSE BUTTED IN STRETCHER PATTERN WITH STAGGERED JOINTS TO FINISH FLUSH WITH ADJOINING SURFACES AFTER TAMPING. LIGHTLY TAMP TO AN EVEN SURFACE IMMEDIATELY AFTER LAYING. DO NOT USE ROLLER. ENSURE TURF ROLLS ARE NOT ALLOWED TO DRY OUT AND WATER IMMEDIATELY AFTER LAYING AS NECESSARY TO ENSURE TOPSOIL IS KEPT MOIST TO 100mm DEPTH. PROTECT NEWLY LAID TURF FROM PEDESTRIAN AND VEHICULAR TRAFFIC UNTIL ESTABLISHED. FERTILISE WITHIN 2 WEEKS OF LAYING WITH AN APPROVED LAWN FERTILISER APPLIED TO MANUFACTURER'S RECOMMENDATIONS. APPLY ADDITIONAL FERTILISER AS REQUIRED TO MAINTAIN HEALTHY GROWTH. ONCE ESTABLISHED, MOW TO MAINTAIN GRASS HEIGHT BETWEEN 30-50mm

AT SAME TIME MAKE GOOD ALL EXISTING LAWN AREAS USING SAME LAWN TYPE. LAWNS IN SHADE SHALL BE OVERSOWN WITH AN APPROVED SEED MIX. ALLOW TO RETRIM AND RETURF COUNCIL NATURE STRIP AS REQUIRED.

## **FENCING**

(REFER TO DRAWINGS)

## **PAVING & CONCRETE WORKS**

AREAS TO BE PAVED SHALL BE EXCAVATED OR FILLED TO ALLOW FOR INSTALLATION OF BEDDING MATERIALS. LEVELS AND FALLS SHALL BE AS PER PLAN. SURFACE DRAINAGE ON PAVING SHALL BE TOWARDS GRATED DRAINS INSTALLED BY BUILDER WITH ALL DRAINS CONNECTED TO STORMWATER SYSTEM

## IRRIGATION

(REFER TO DRAWINGS)

LANDSCAPE ARCHITECTURE

PO Box 698 MONA VALE NSW 1660 Tel: 0434 500 705 - AIDLM

PROJECT: **Proposed Residence** 1130 Pittwater Road Collarov NSW 2097

ARCHITECT: **Anthony Aziz** 

NOTES

all works shall be in accordence with development approach certificate conditions of consent all levels to alt certificate conditions of consent all tevels to although the certification of the certi

25/08/23 B DRAFT	

DATE: 14/09/2023 **DRAWING LANDSCAPE SPECIFICATIONS** SCALE: DRAWING NO: C5 DRAWN: BT REV: С



Bluestone Organic Steppers
Location: Entry Access Path & North Side Access Pathway



Lava Charcoal Pebble 20mm Location: North Side Access Pathway




Stone Collective - Nordic Granite Paving Location: South Side Access Pathway




Steel Lawn Edging
Location: Rear Lawn Area & Court



Lapped & Capped Fence
Location: South Boundary

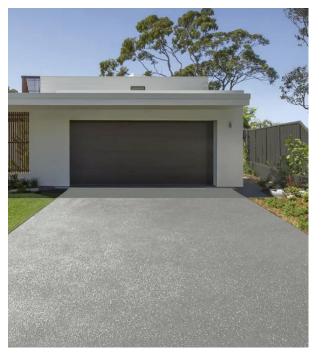

Coloured Concrete Surface
Location: Driveway

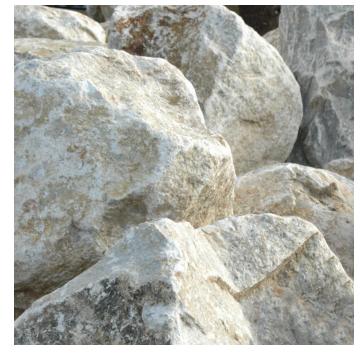

2 to 3 Man Limestone Feature Rocks
Location: Courtyard Garden

CONTOUR

PO Box 698 MONA VALE NSW 1660 Tel: 0434 500 705 - AIDLM PROJECT:
Proposed Residence
1130 Pittwater Road
Collaroy NSW 2097

CLIENT:
Anthony Aziz

M A P A R C H I T E C T S

ARCHITECT:

NOTES

comply with building code of australia and all relevant australian standards all works shall be in accordence with development application and constru certificate conditions of consent all levels to with all revels to without all revels and with all revels with a reverse and revels and rev

all levies to dand formation relating to existing site data refer to survey information and to too do not scale from drawings of the control of the control

DATE	REV.	ISSUE	
07/08/23	Α	DRAFT	
25/08/23	В	DRAFT	
14/09/23	С	DA	 

DATE:	14/09/2023	DRAWING FINISHES PAL	ETTE
SCALE:	N/A	DRAWING NO : C6	3
DRAWN:	ВТ	REV: C	