Residential Dwelling MONA VALE, NSW 2103 04 December 2024 Issue A

Prepared for JENNIFER ROBINS

18 HILCREST AVE



NO:	SHEET NAME	DATE
DA00	COVER PAGE	4/12/2024
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LANDSCAPING: 60.00% (2097.00 m²) 89.84% (3140.02 m²) 86.21% (3013.33 m²) REQUIRED EXISTING PROPOSED



IMPERVIOUS AREAS LESS THAN 1M INCLUDED IN LANDSCAPED AREA






PRIVATE OPEN SPACE (MIN. 3M X 3M) REQUIRED 80.00m² **EXISTING** 524.66m² PROPOSED 390.64m²



PRINCIPAL AREA (MIN. 4M X 4M) REQUIRED PROPOSED 16.00m² 16.00m²

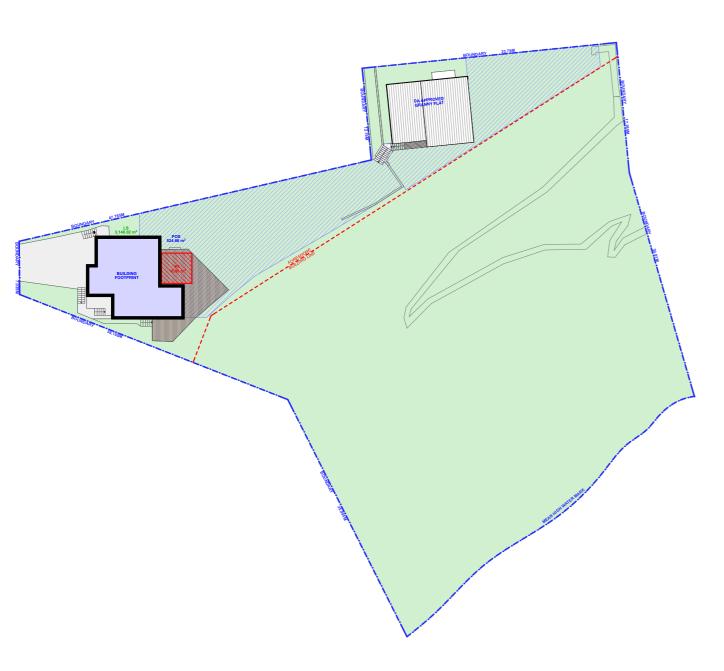

EXISTING AREA CALCULATIONS

1:500

PROPOSED AREA CALCULATIONS

1:500




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REV.	NOTES.	INITIAL	DATE	LEGEND
Α	DA DOCUMENTATION	SB	09.09.24	DWELLING WALLS
В	DOOR&WINDOW SCHEDULE	SB	11.09.24	CONCRETE / PAVERS
				TIMBER DECK
				POOL / WATER
В	DOOR&WINDOW SCHEDULE	SB	11.09.24	CONCRETE / PAVERS TIMBER DECK



CLIENTS: **NEIL BURNARD** SITE ADDRESS: 18 HILLCREST AVE DRAWING TITLE: AREA CALCULATIONS 1:500 @A3 4/12/2024 PROJECT NO: DRAWING NO: 1084 DA02

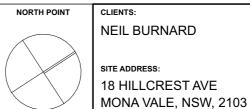


EXTERNAL VIEW



LOCATION MAP



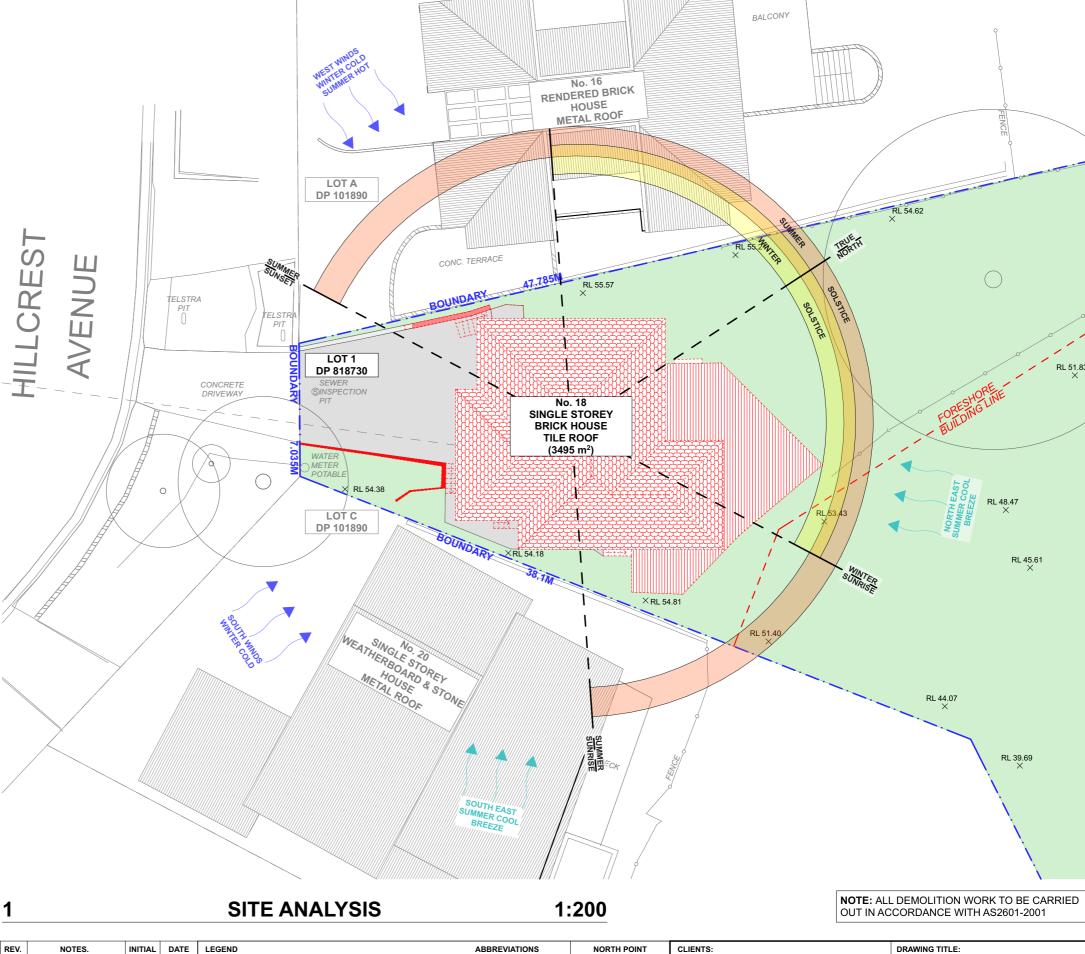

SITE ANALYSIS

4/12/2024

DRAWING NO:

DA03

1:200, 1:4.38, **9:4:3:5**; 1:3.07

PROJECT NO:

1084


@A3



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	REV.	NOTES.	INITIAL	DATE	LEGEND	ABBREVIATIONS	NORTH POINT	CLIENTS:
	Α	DA DOCUMENTATION	SB	09.09.24	EXISTING LANDSCAPE / GRASS	DP: DEPOSIT PLAN		NEIL BURNARD
	В	DOOR&WINDOW SCHEDULE	SB	11.09.24	DEMOLISHED CONCRETE / PAVERS	RL: REDUCED LEVEL SP: STRATA PLAN		
,					EXISTING ROOF TIMBER DECK			SITE ADDRESS:
					PROPOSED ROOF POOL / WATER			18 HILLCREST AVE
						FENCE		MONA VALE, NSW, 2103




WASTE

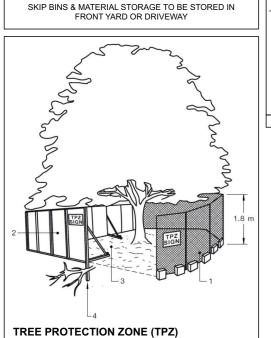SKIP BIN RECYCLING MATERIAL STORAGE

1. CHAIN WIRE MESH PANELS WITH SHADE CLOTH (IF REQUIRED) ATTACHED, HELD IN PLACE WITH CONCRETE FEET.


FENCING (WHEN POSSIBLE):

- 2. ALTERNATIVE PLYWOOD OR WOODEN PALING FENCE PANELS. THE FENCING MATERIAL ALSO PREVENTS BUILDING MATERIALS OR SOIL ENTERING THE TPZ.
- 3. MULCH INSTALLATION ACROSS SURFACE OF TPZ (AT THE DISCRETION OF THE PROJECT ARBORIST). NO EXCAVATION, CONSTRUCTION ACTIVITY, GRADE CHANGES, SURFACE TREATMENT OR STORAGE OF MATERIALS OF ANY KIND IS PERMITTED WITHIN THE TPZ.
- 4. BRACING IS PERMISSIBLE WITHIN THE TPZ. INSTALLATION OF SUPPORTS TO AVOID DAMAGING ROOTS.

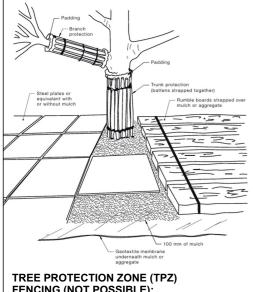

TREE PROTECTION ZONE (TPZ) FENCING (NOT POSSIBLE):

- 1. FOR TRUNK AND BRANCH PROTECTION USE BOARDS AND PADDING THAT WILL PREVENT DAMAGE TO BARK. BOARDS ARE TO BE STRAPPED TO TREES, NOT NAILED, OR
- 2. RUMBLE BOARDS SHOULD BE OF SUITABLE THICKNESS TO PREVENT SOIL COMPACTION AND ROOT DAMAGE.

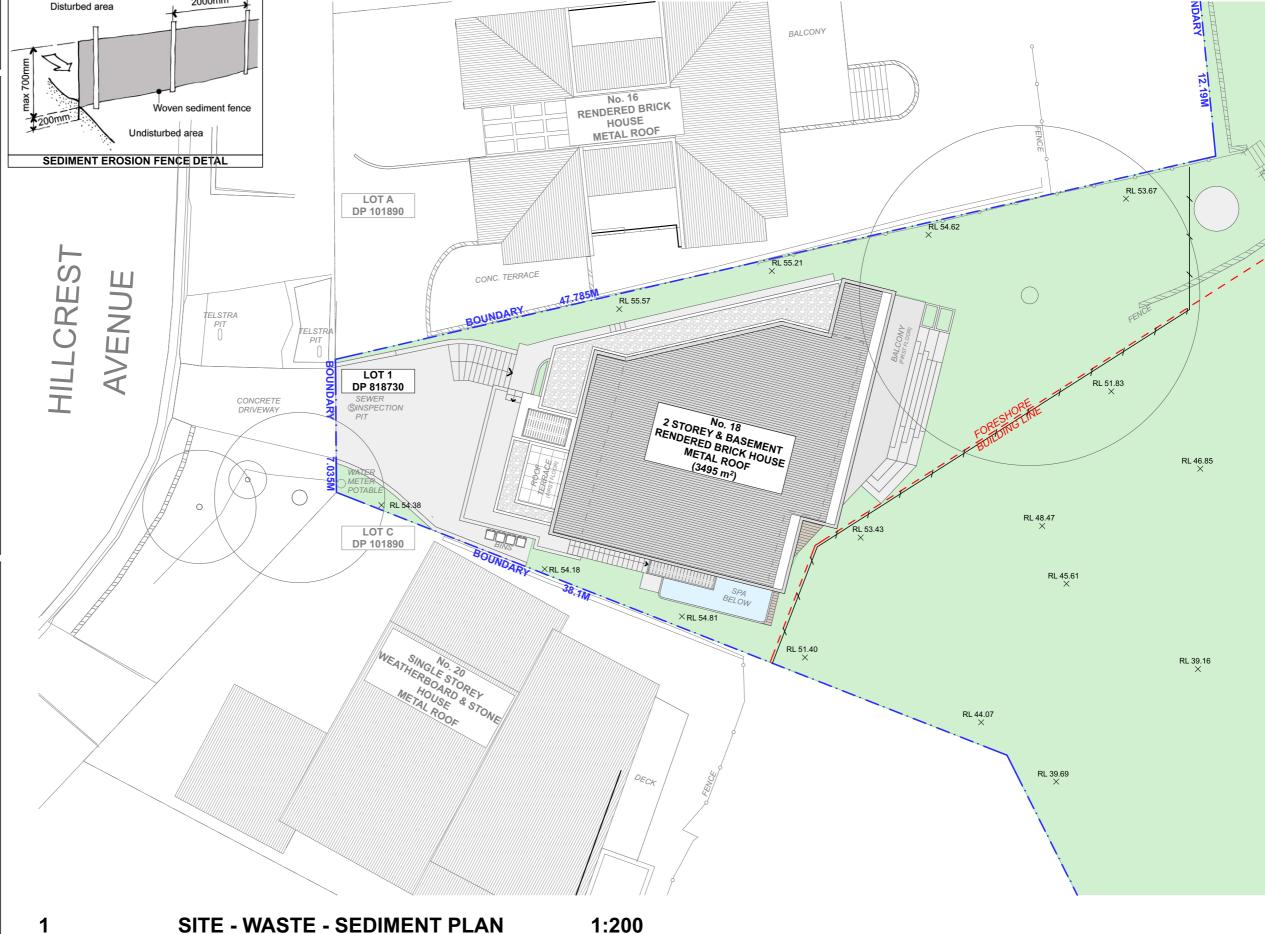




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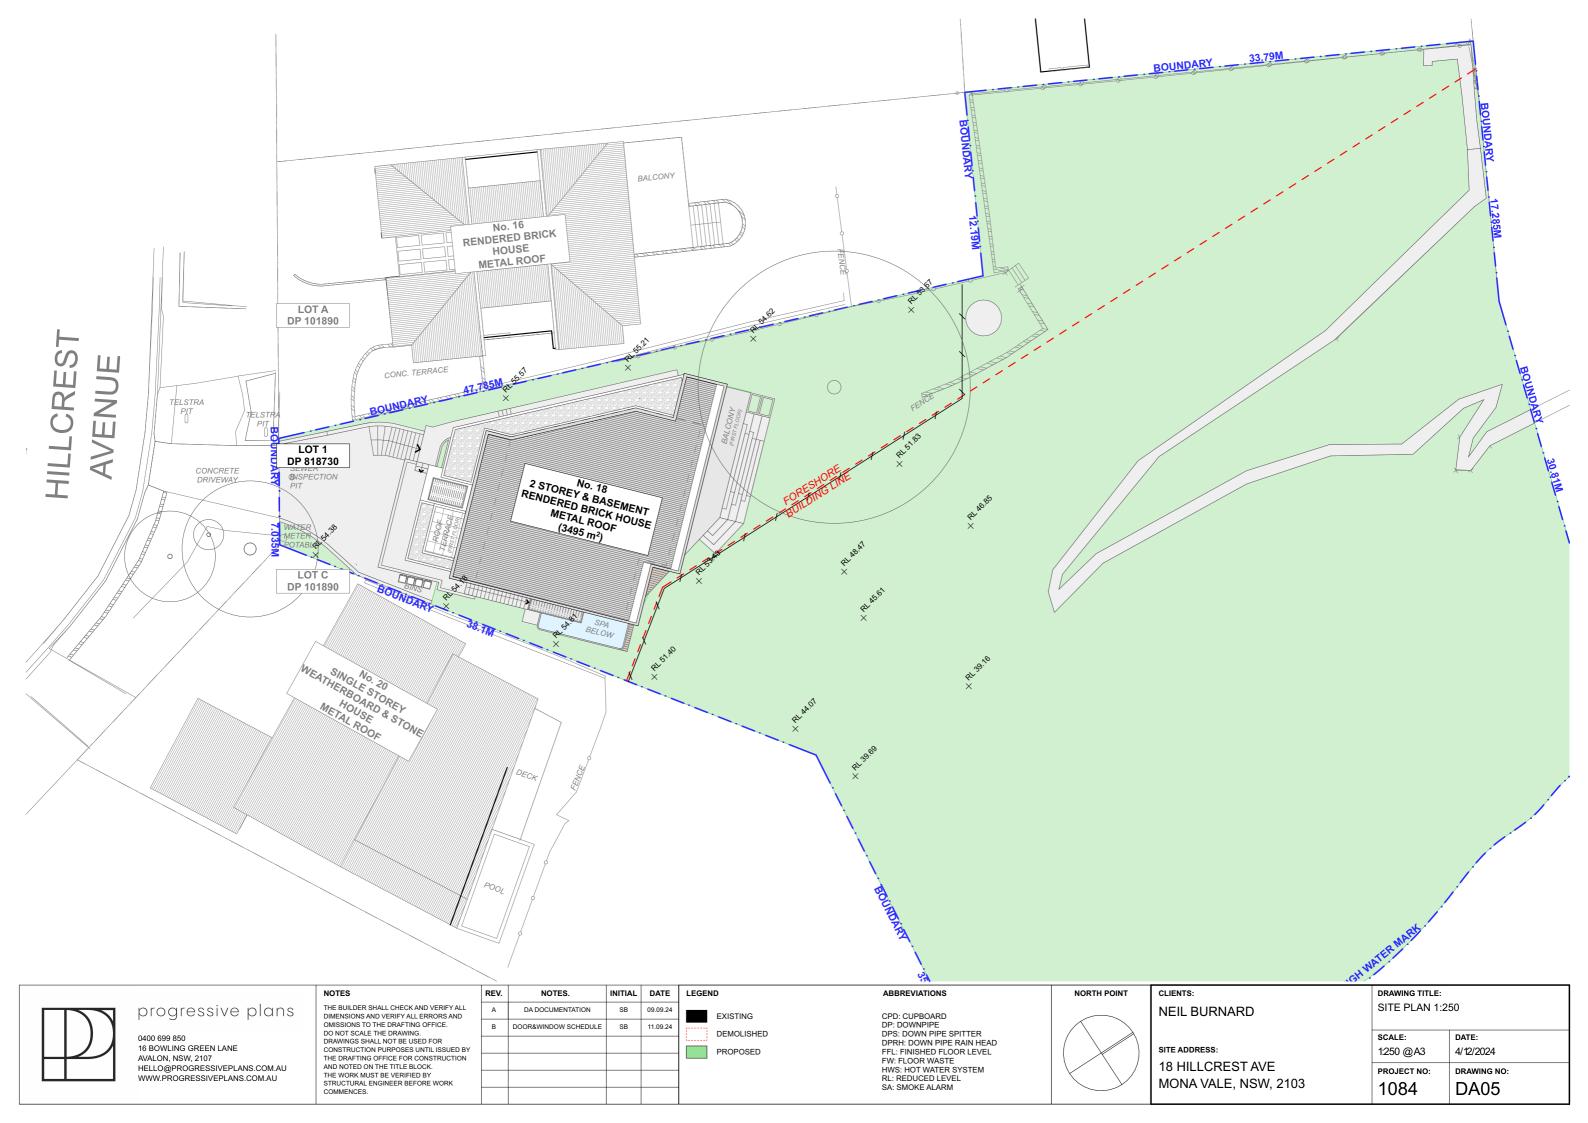
REV.	NOTES.	INITIAL	DATE	LEGEND	ABBREVIATIONS
Α	DA DOCUMENTATION	SB	09.09.24	EXISTING LANDSCAPE / GRASS	DP: DEPOSIT PLAN
В	DOOR&WINDOW SCHEDULE	SB	11.09.24	DEMOLISHED CONCRETE / PAVERS	RL: REDUCED LEVEL SP: STRATA PLAN
				EXISTING ROOF TIMBER DECK	
				PROPOSED ROOF POOL / WATER	
				SEDIMENT EROSION FENCE	





CLIENTS: NEIL BURNARD SITE ADDRESS: 18 HILLCREST AVE MONA VALE, NSW, 2103 DRAWING TITLE: SITE - WASTE - SEDIMENT PLAN 1:200 @A3 4/12/2024 PROJECT NO: DRAWING NO:


DA04

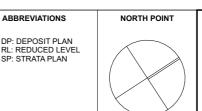
1084



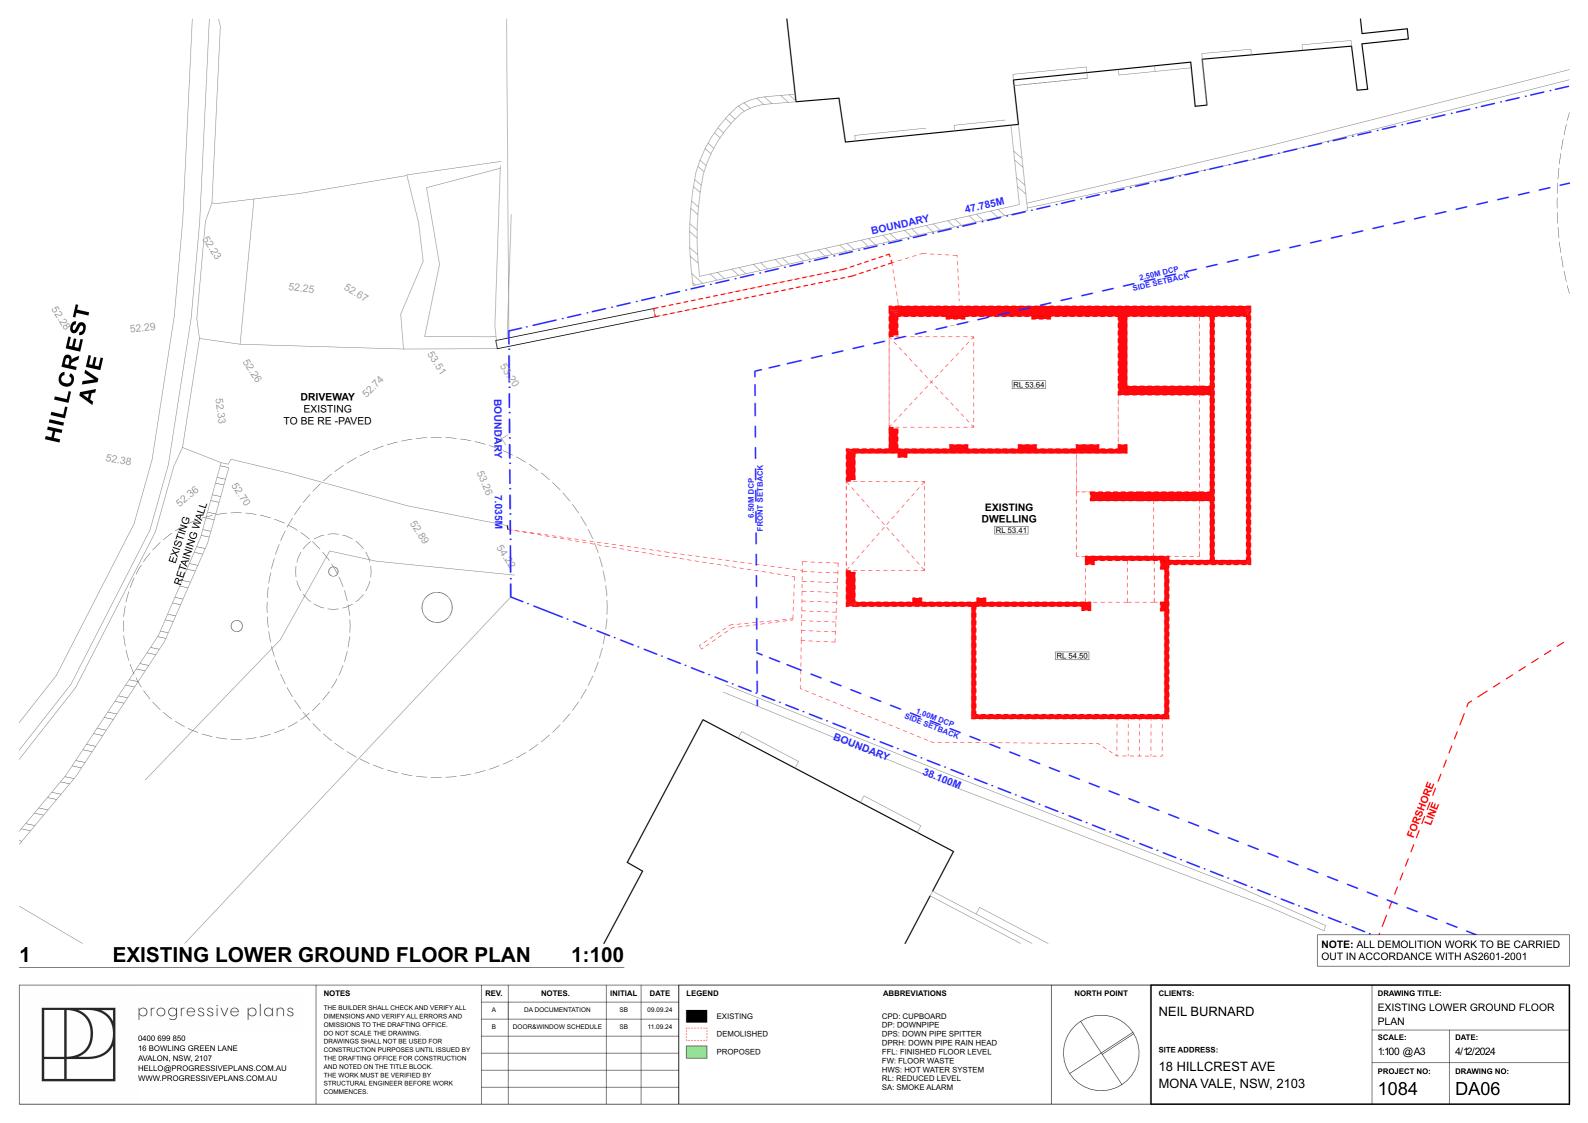

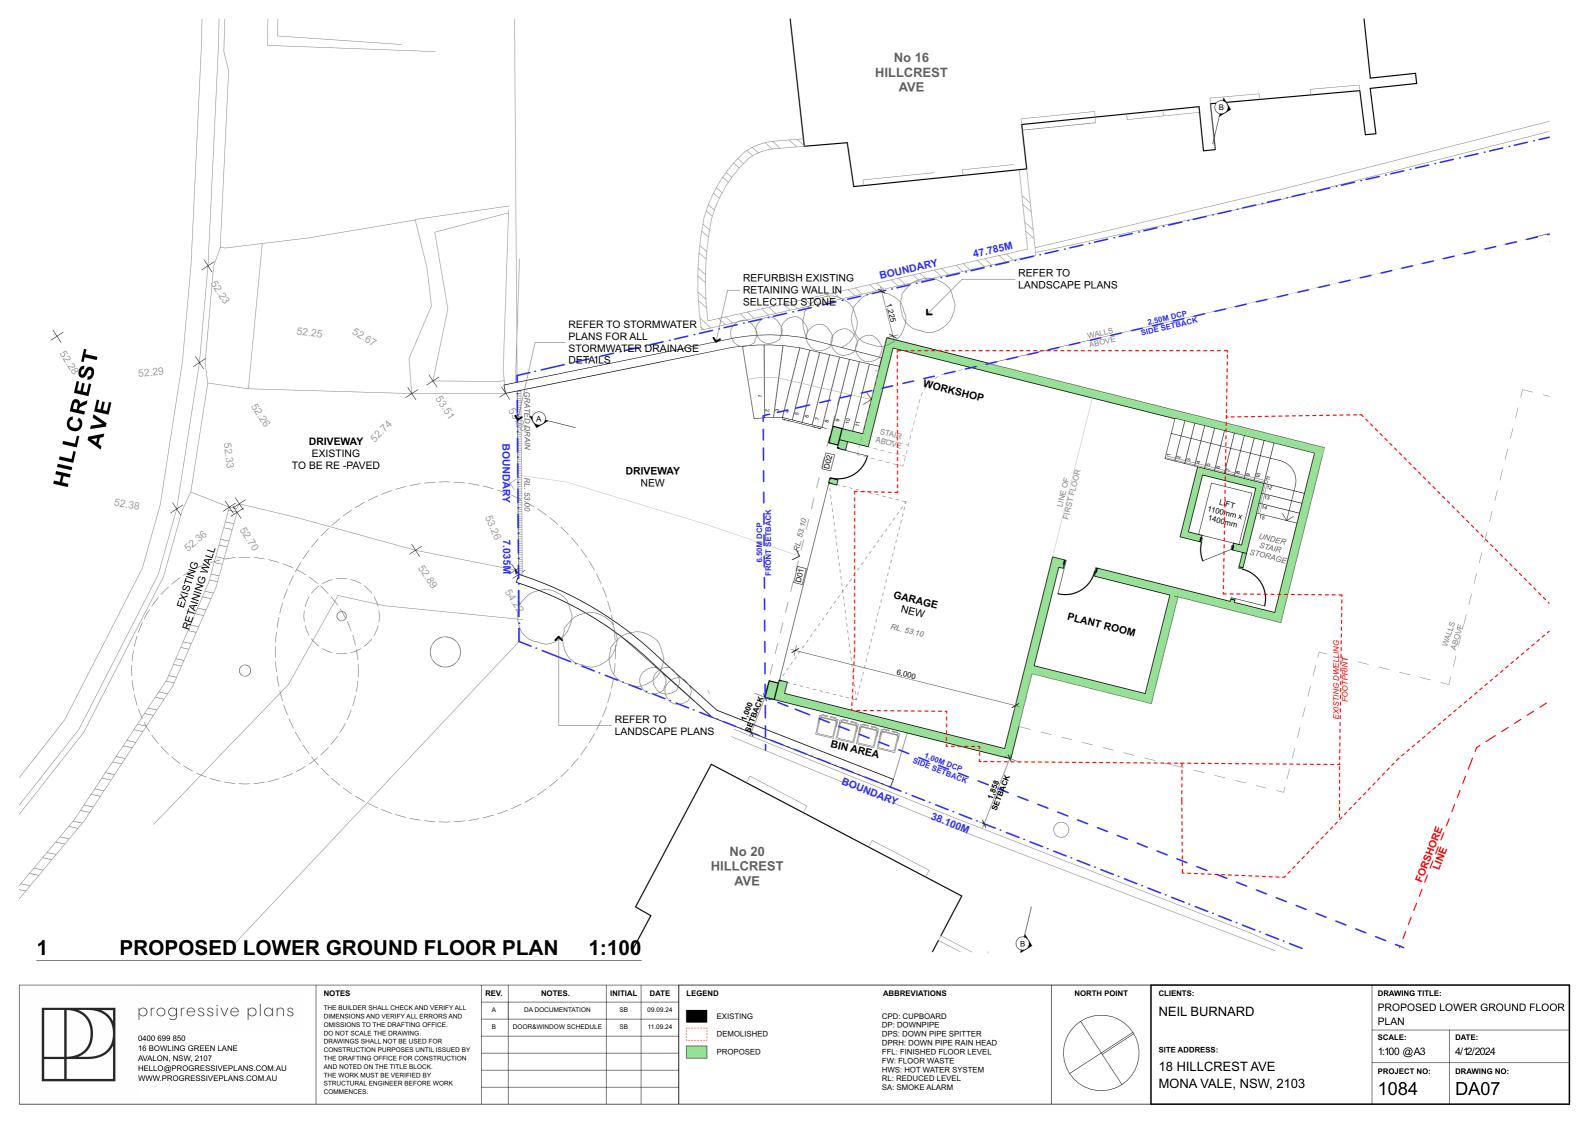

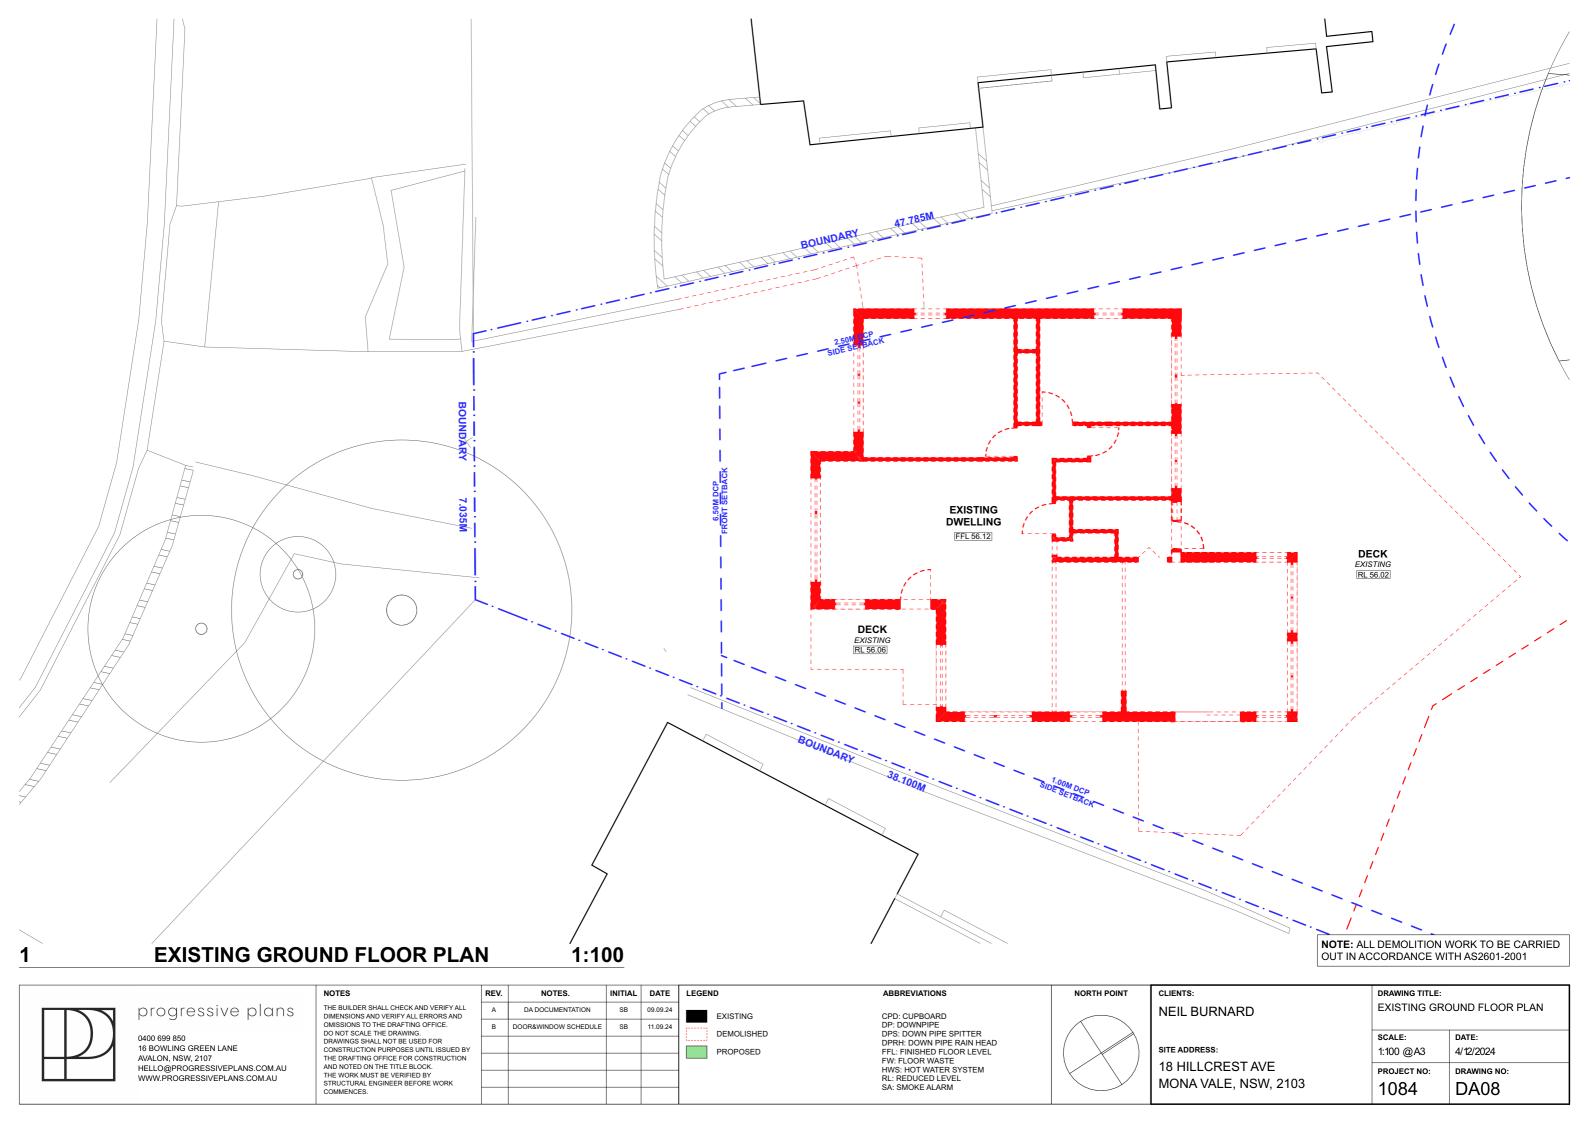

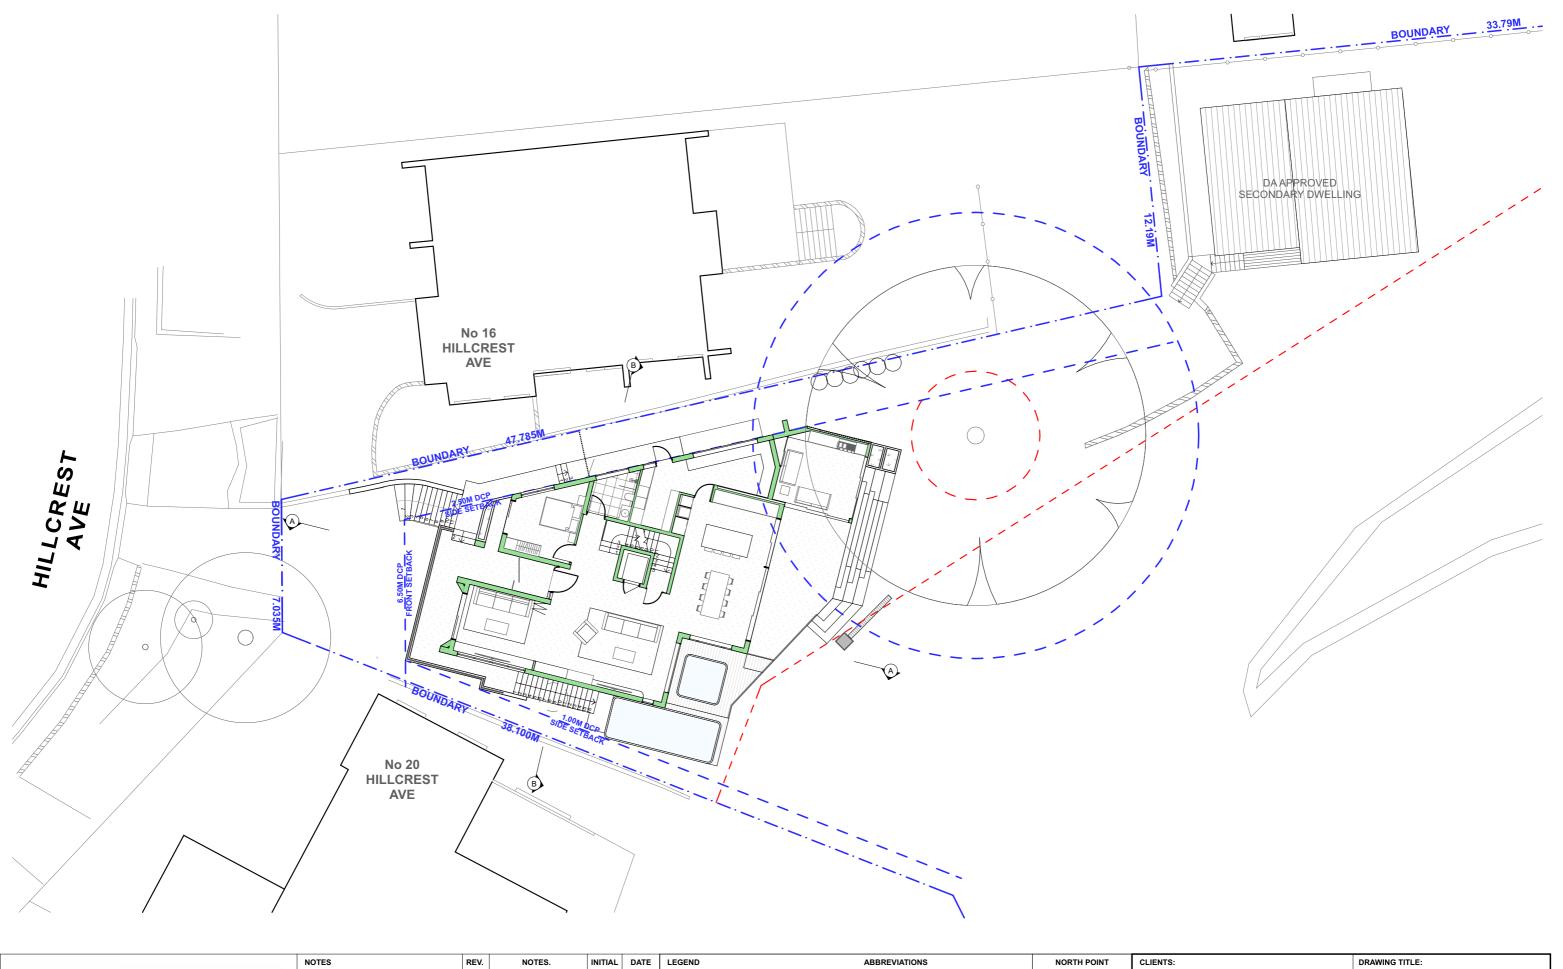



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REV.	NOTES.	INITIAL	DATE	LEGEND	
Α	DA DOCUMENTATION	SB	09.09.24	EXISTI	NG
В	DOOR&WINDOW SCHEDULE	SB	11.09.24	DEMOL	LISHED
				PROPO	OSED
					7025

CPD: CUPBOARD
DP: DOWNPIPE
DPS: DOWN PIPE SPITTER
DPRH: DOWN PIPE RAIN HEAD
FFL: FINISHED FLOOR LEVEL
FW: FLOOR WASTE
HWS: HOT WATER SYSTEM
RL: REDUCED LEVEL
SA: SMOKE ALARM




NEIL BURNARD

SITE ADDRESS: 18 HILLCREST AVE MONA VALE, NSW, 2103

	DRAWING TITLE:					
	PROPOSED GROUND FLOOR PLA					
1:200						
	SCALE:	DATE:				
	1:200 @A3	4/12/2024				
	DDO IECT NO.	DD AWING NO.				

DA09

1084

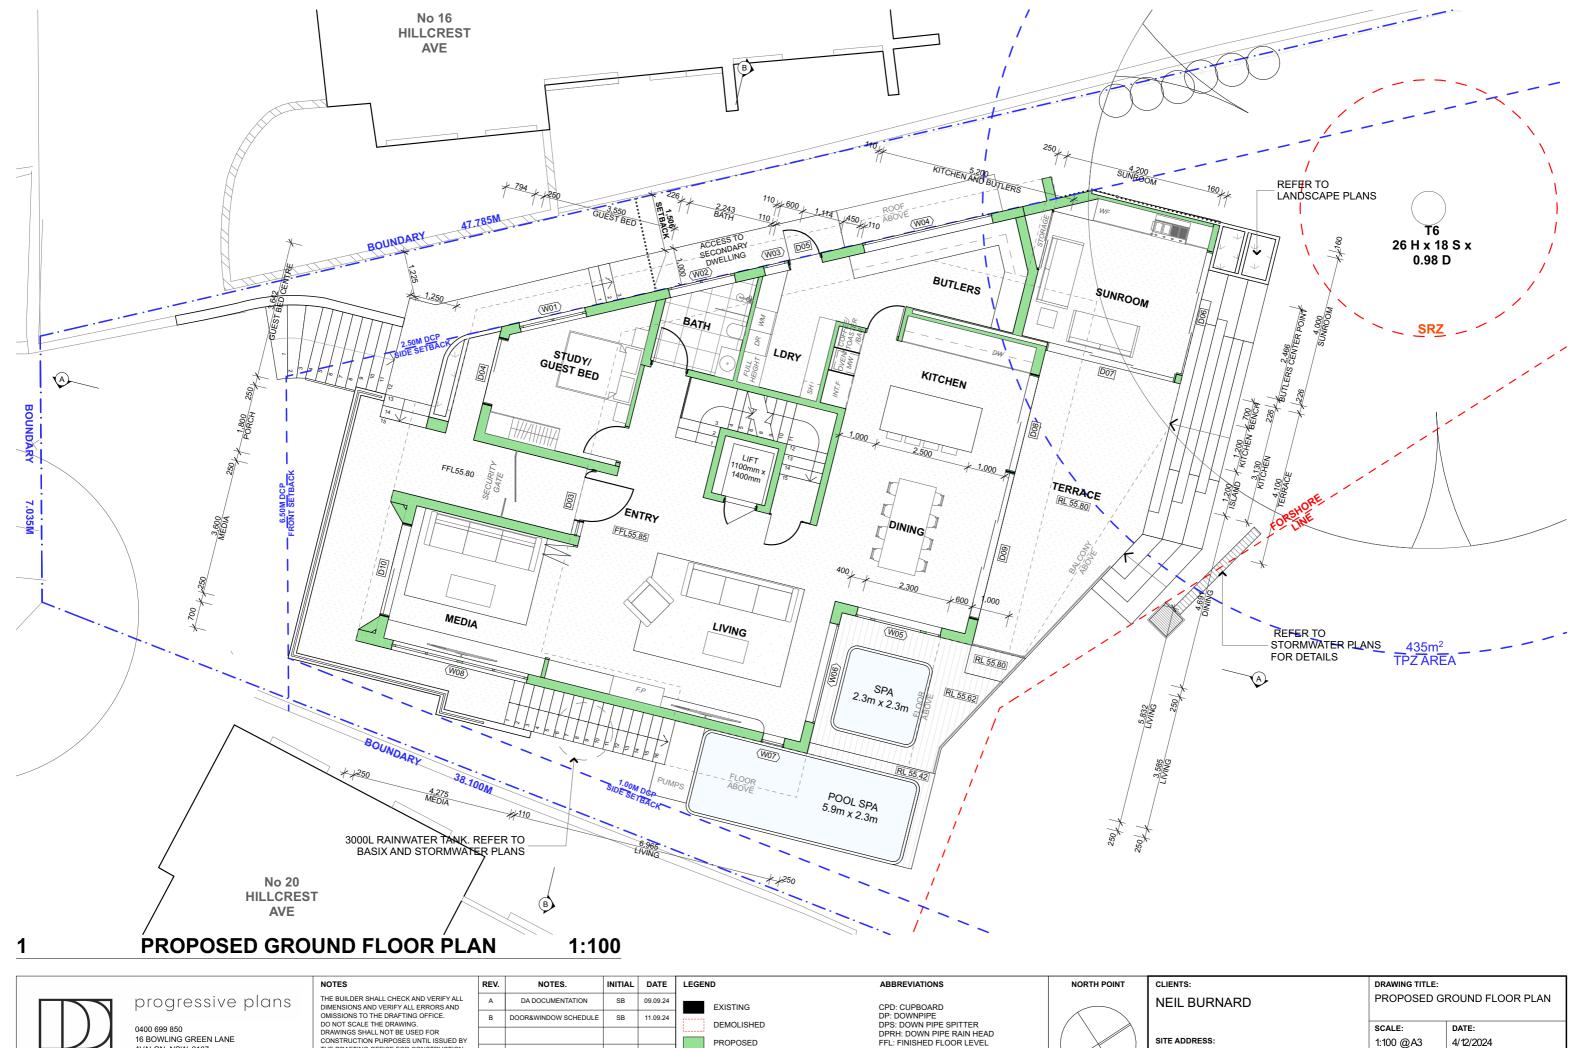




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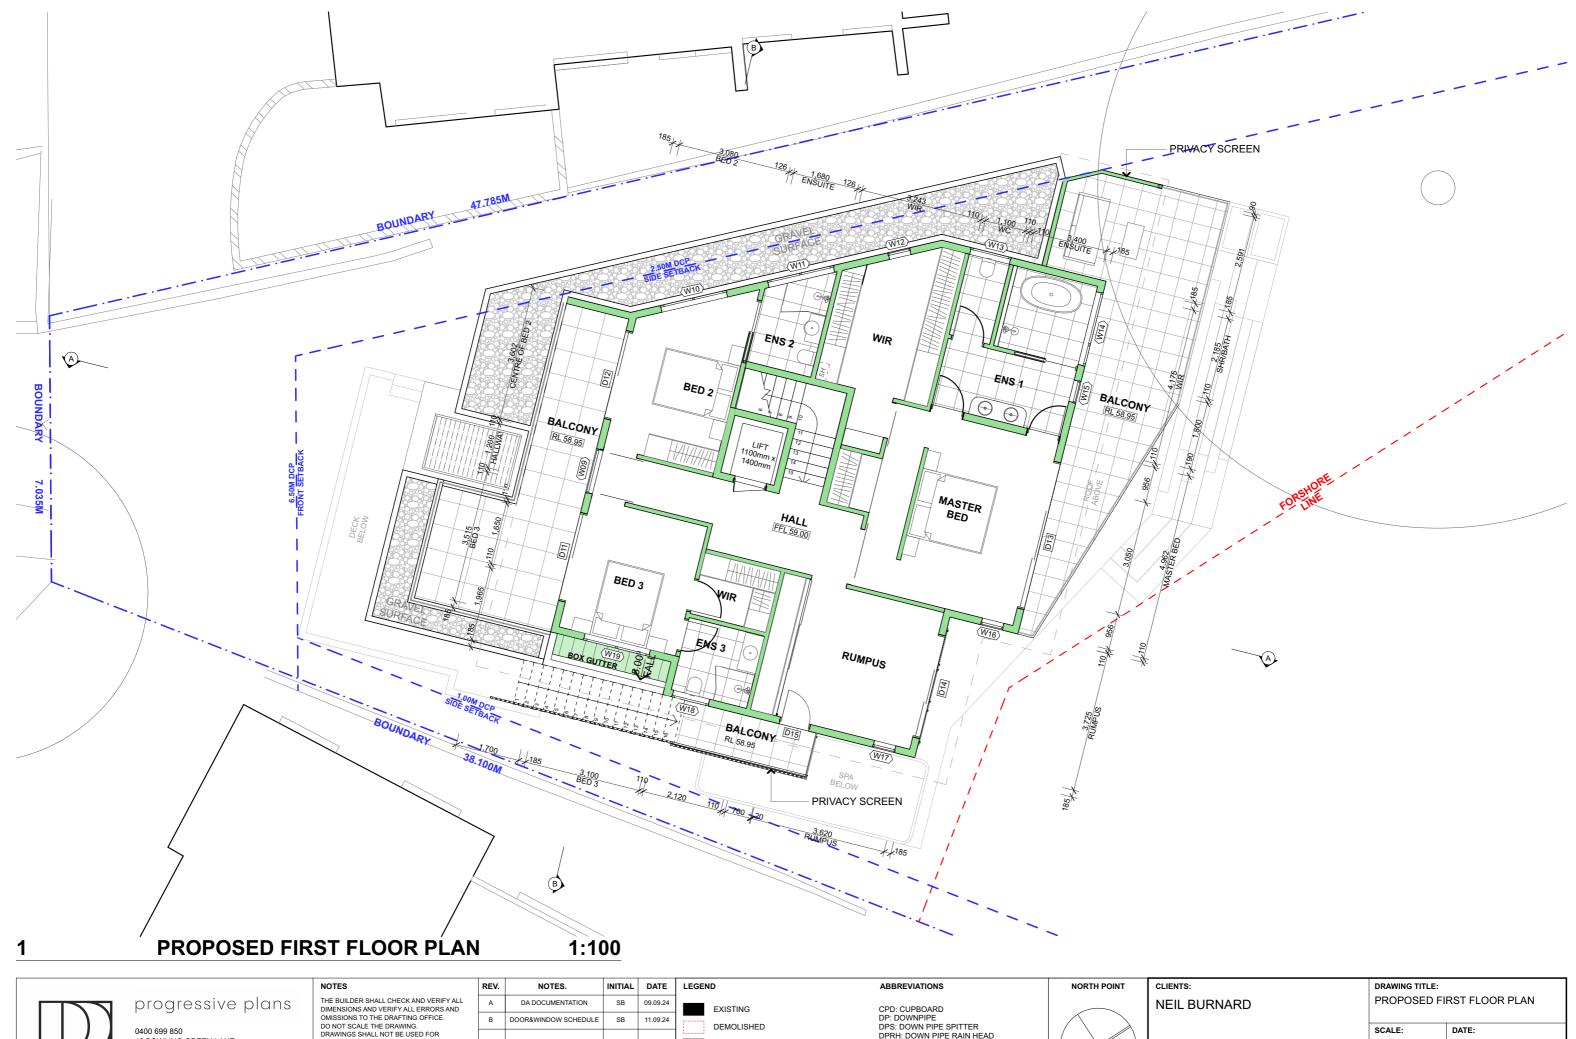
THE DRAFTING OFFICE FOR CONSTRUCTION
AND NOTED ON THE TITLE BLOCK.
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REV.	NOTES.	INITIAL	DAIL	LEGEND
Α	DA DOCUMENTATION	SB	09.09.24	EXISTING
В	DOOR&WINDOW SCHEDULE	SB	11.09.24	DEMOLISHED
				PROPOSED

CPD: CUPBOARD
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DPRH: DOWN PIPE RAIN HEAD
FFL: FINISHED FLOOR LEVEL
FW: FLOOR WASTE HWS: HOT WATER SYSTEM RL: REDUCED LEVEL SA: SMOKE ALARM



18 HILLCREST AVE MONA VALE, NSW, 2103 PROJECT NO: DRAWING NO: 1084 DA10

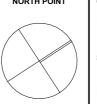




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Α	DA DOCUMENTATION	SB	09.09.24	EXISTING
В	DOOR&WINDOW SCHEDULE	SB	11.09.24	DEMOLISHED
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CPD: CUPBOARD
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RL: REDUCED LEVEL
SA: SMOKE ALARM




SITE ADDRESS: 18 HILLCREST AVE


MONA VALE, NSW, 2103

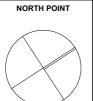
1:100 @A3 4/12/2024 PROJECT NO: DRAWING NO:

DA11

1084

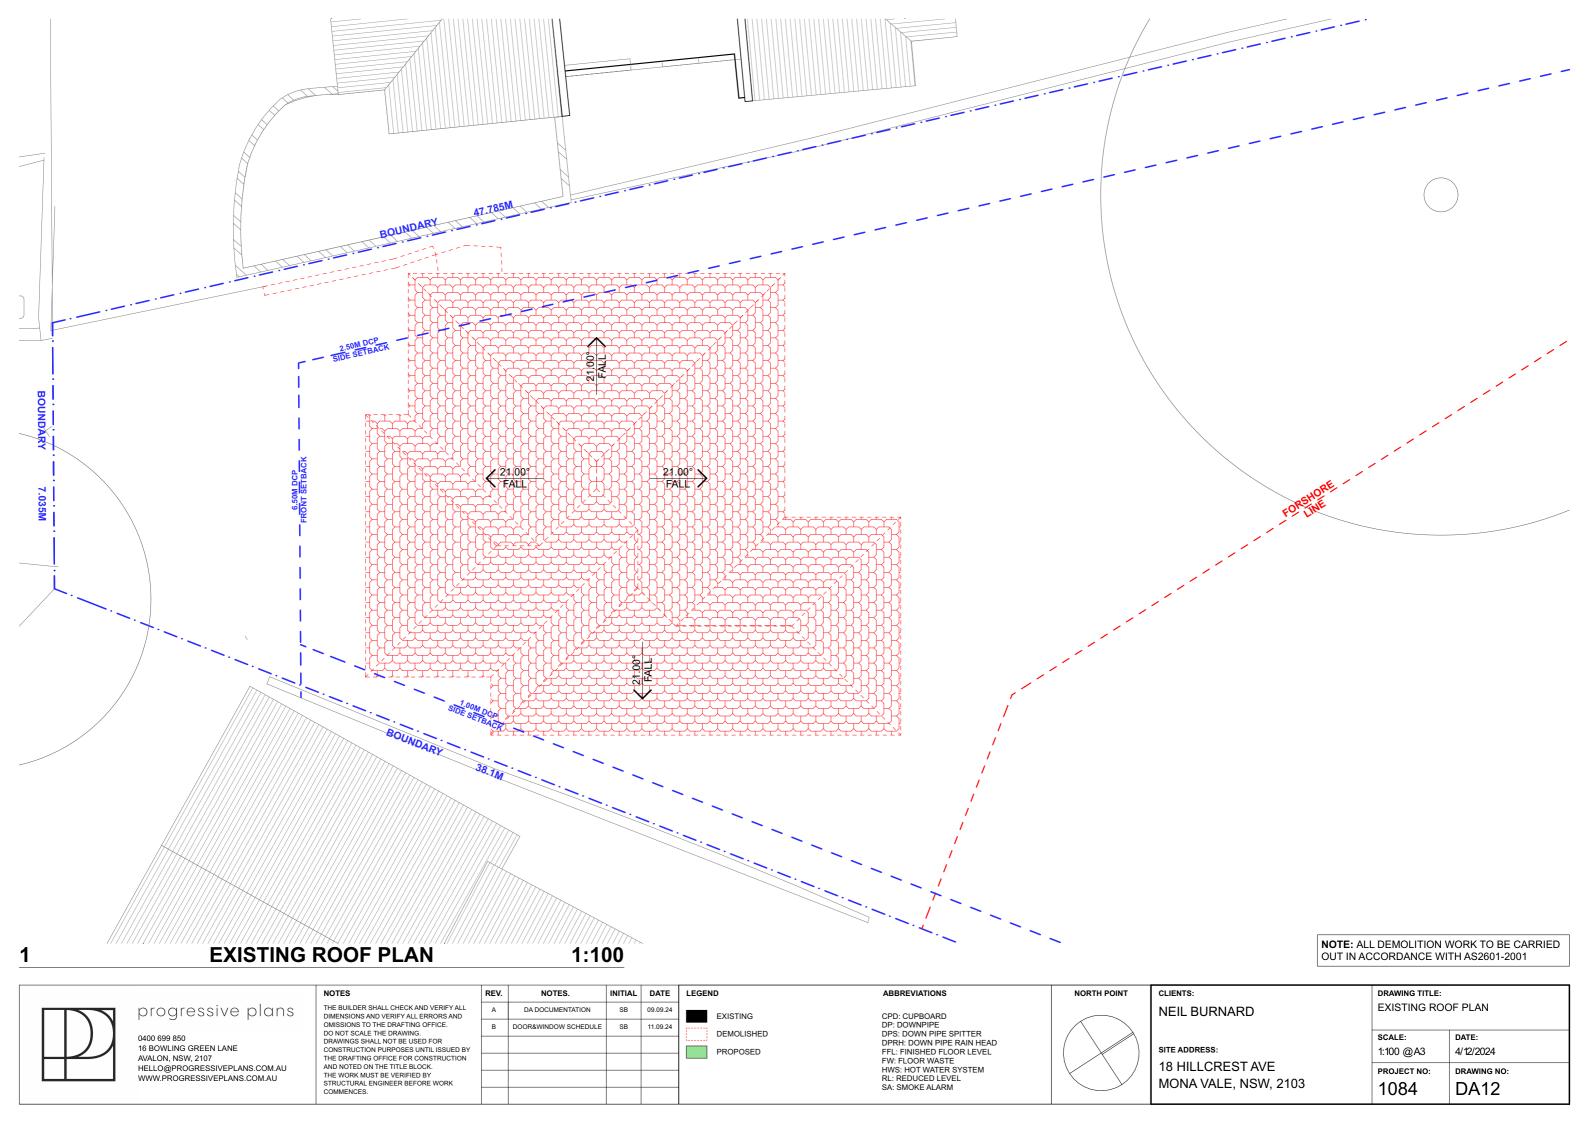

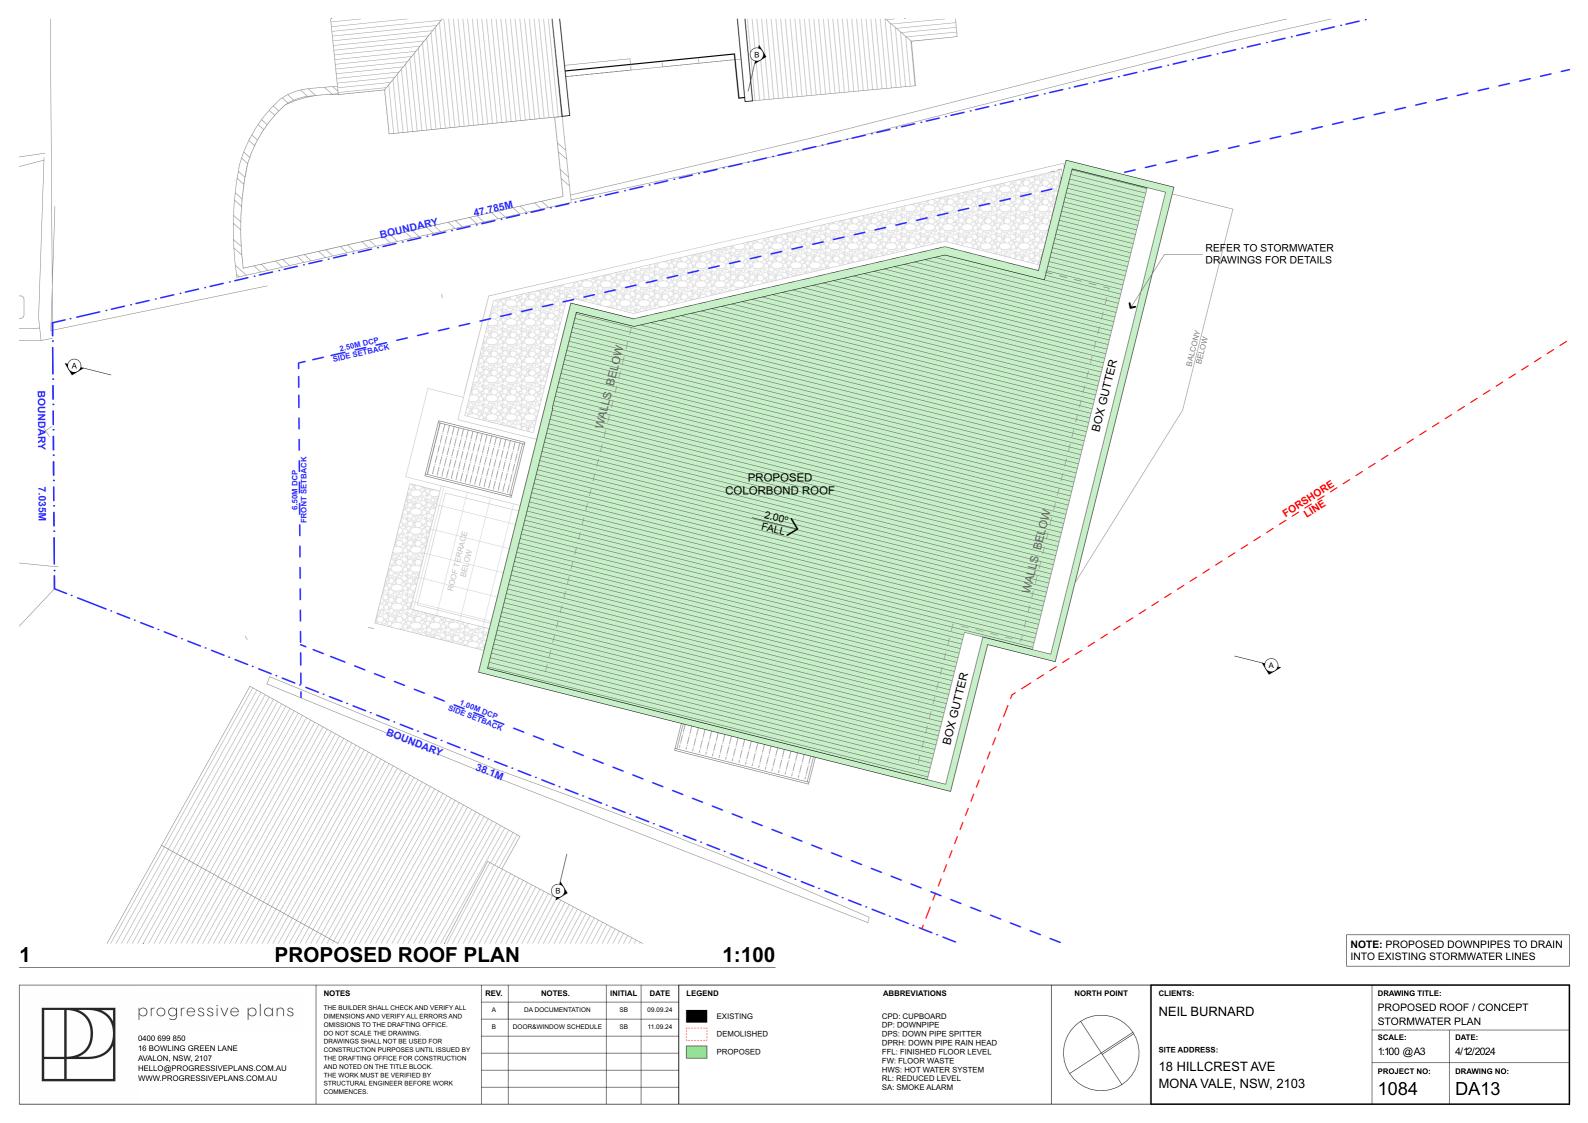

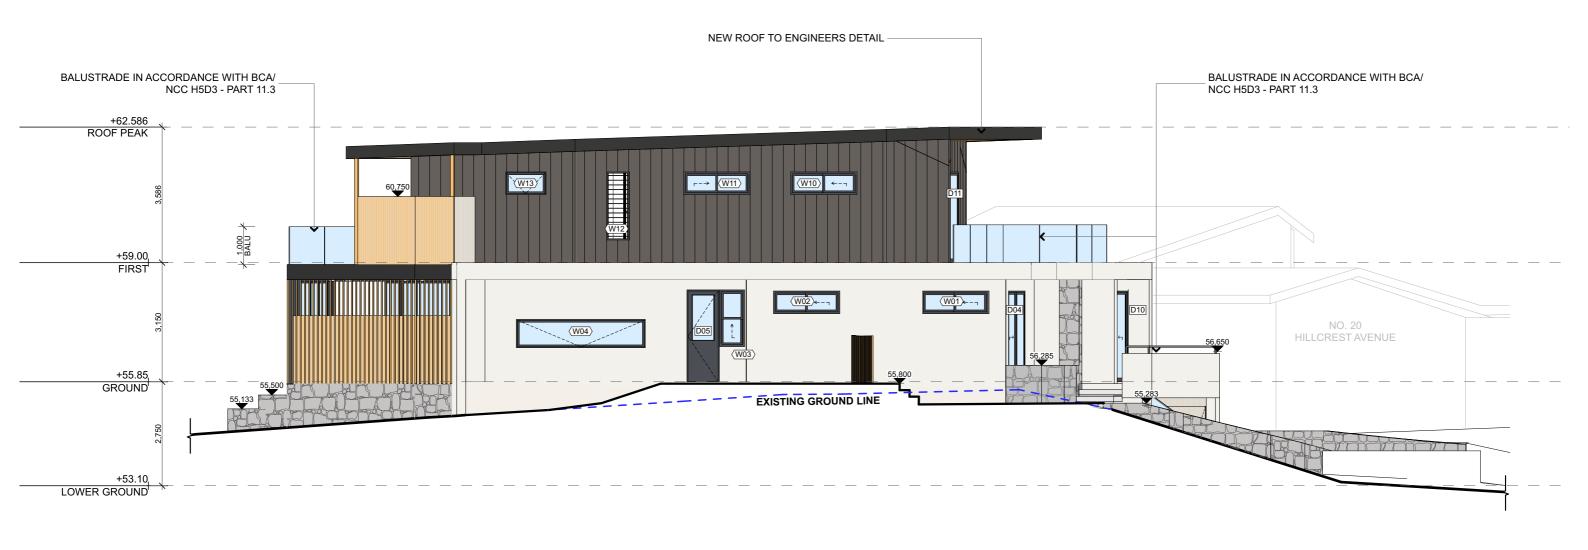

NORTH ELEVATION 1:100

NOTE: THE HEIGHT LIMIT IS BEST DISPLAYED IN THE SECTIONS (SHEETS DA16 & DA17) HEIGHT LIMIT PERSPECTIVE (SHEET DA22).

1084

NOTE: SITE BOUNDARIES & SETBACKS ARE BEST DISPLAYED ON FLOOR PLANS DUE TO THE EXTEND AND SHAPE OF THE LOT.



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REV.	NOTES.	INITIAL	DATE	LEGEND
A	DA DOCUMENTATION	SB	09.09.24	EXISTING CB WOODLAND GREY PANEL
В	DOOR&WINDOW SCHEDULE	SB	11.09.24	DEMOLISHED RENDERED WHITE FINISH
				CUT THROUGH SLATTED TIMBER FINSH PROPOSED
				CONCRETE FINISH TIMBER FINISH
				GLASS STONE CRAZY PAVING

ABBREVIATIONS


CPD: CUPBOARD
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FFL: FINISHED FLOOR LEVEL
HWS: HOT WATER SYSTEM
RL: REDUCED LEVEL

CLIENTS: NEIL BURNARD

SITE ADDRESS:
18 HILLCREST AVE
MONA VALE, NSW, 2103

SCALE: DATE: 1:100 @A3 4/12/2024	
1·100 @ 43 4/12/2024	

DA14

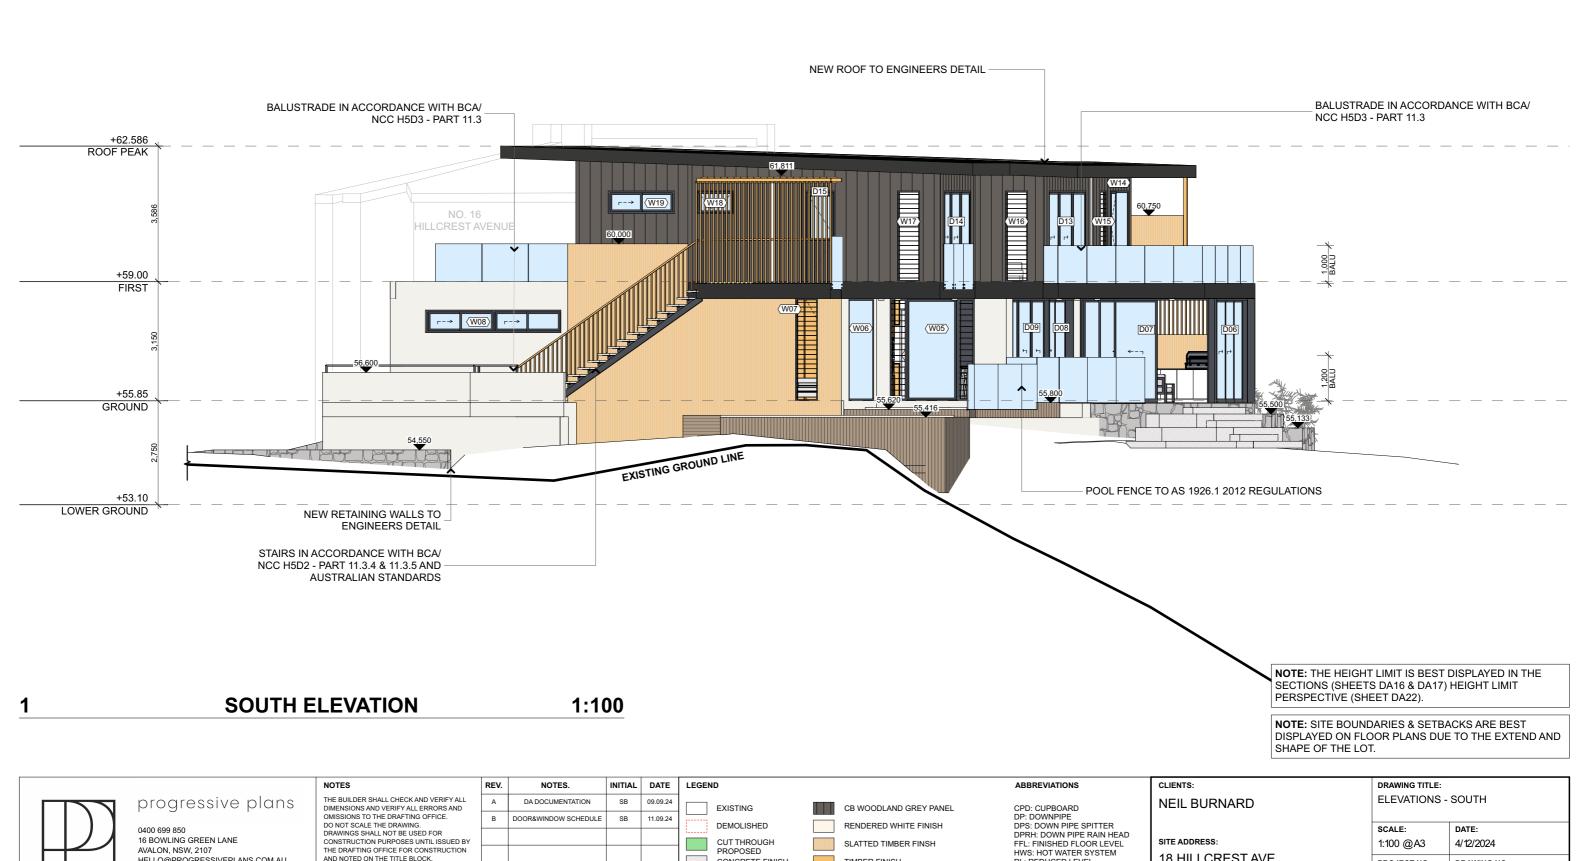

CUT THROUGH PROPOSED

GLASS

CONCRETE FINISH

SLATTED TIMBER FINSH

TIMBER FINISH

STONE CRAZY PAVING

SITE ADDRESS:

RL: REDUCED LEVEL

18 HILLCREST AVE

MONA VALE, NSW, 2103

4/12/2024

DRAWING NO:

DA15

1:100 @A3

PROJECT NO:

1084


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В	DOOR&WINDOW SCHEDULE	SB	11.09.24		DEMOLISHED	RENDERED WHITE FINISH
					CUT THROUGH PROPOSED	SLATTED TIMBER FINSH
				0.004.003.00	CONCRETE FINISH	TIMBER FINISH
					GLASS	STONE CRAZY PAVING
				l		


ABBREVIATIONS

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RL: REDUCED LEVEL

CLIENTS: NEIL BURNARD

SITE ADDRESS: 18 HILLCREST AVE MONA VALE, NSW, 2103

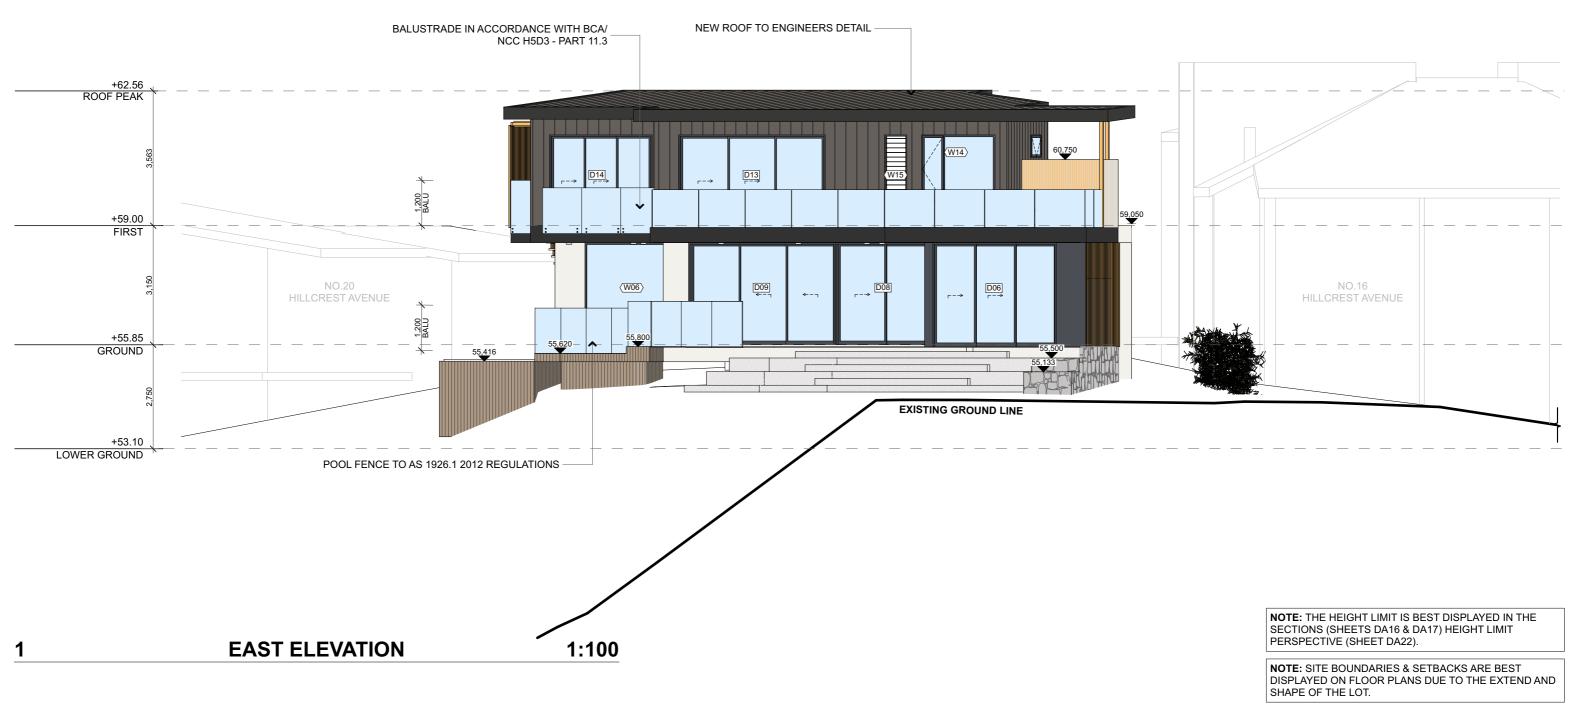DRAWING TITLE:				
ELEVATIONS - EAST				
SCALE:	DATE:			
1:100 @A3	4/12/2024			
PROJECT NO:	DRAWING NO:			
1084	DA16			

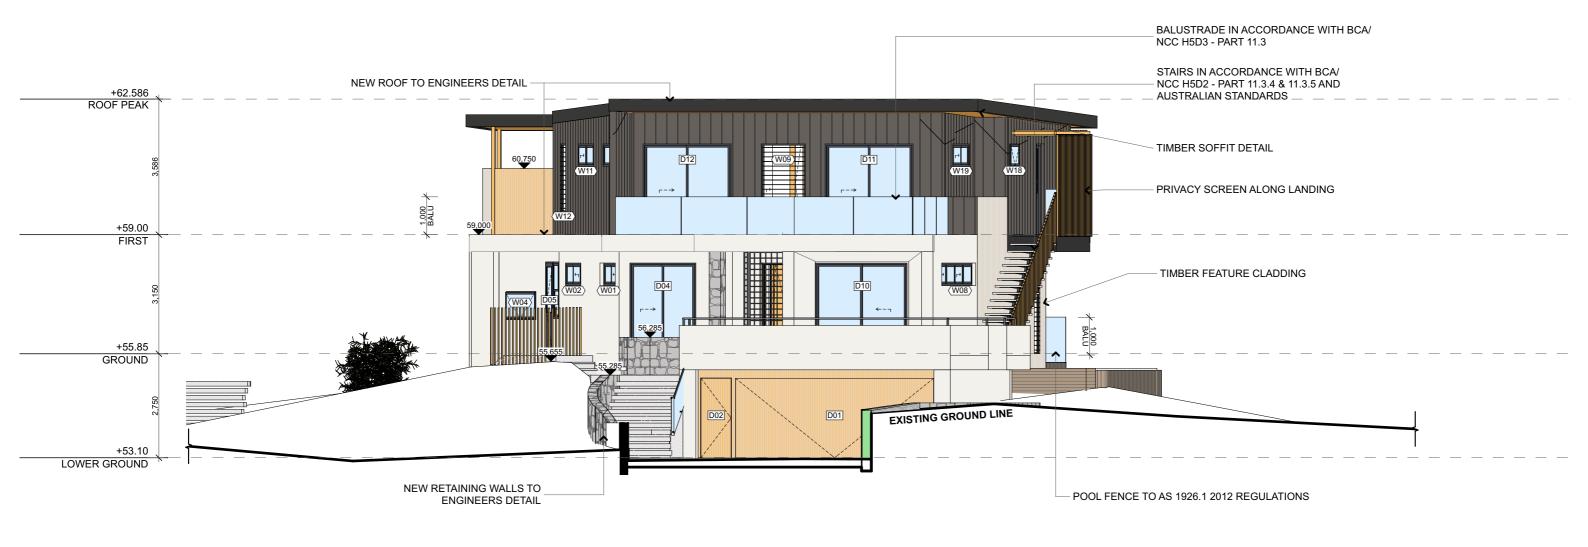

WEST ELEVATION 1:100

NOTE: THE HEIGHT LIMIT IS BEST DISPLAYED IN THE SECTIONS (SHEETS DA16 & DA17) HEIGHT LIMIT PERSPECTIVE (SHEET DA22).

NOTE: SITE BOUNDARIES & SETBACKS ARE BEST DISPLAYED ON FLOOR PLANS DUE TO THE EXTEND AND SHAPE OF THE LOT.



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Α	DA DOCUMENTATION	SB	09.09.24	EXISTING	CB WOODLAND GREY PANEL
В	DOOR&WINDOW SCHEDULE	SB	11.09.24	DEMOLISHED R	RENDERED WHITE FINISH
				CUT THROUGH S	SLATTED TIMBER FINSH
				The state of the s	TIMBER FINISH
				GLASS S	STONE CRAZY PAVING
l		I	I		

ABBREVIATIONS


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DPS: DOWN PIPE SPITTER
DPRH: DOWN PIPE RAIN HEAD
FFL: FINISHED FLOOR LEVEL
HWS: HOT WATER SYSTEM
BL: DEDITION FOR LEVEL RL: REDUCED LEVEL

CLIENTS: **NEIL BURNARD**

SITE ADDRESS: 18 HILLCREST AVE MONA VALE, NSW, 2103

DRAWING TITLE:			
ELEVATIONS - WEST			
SCALE:	DATE:		
SCALE.	DATE.		
1:100 @A3	4/12/2024		
PROJECT NO:	DRAWING NO:		

1084 **DA17**

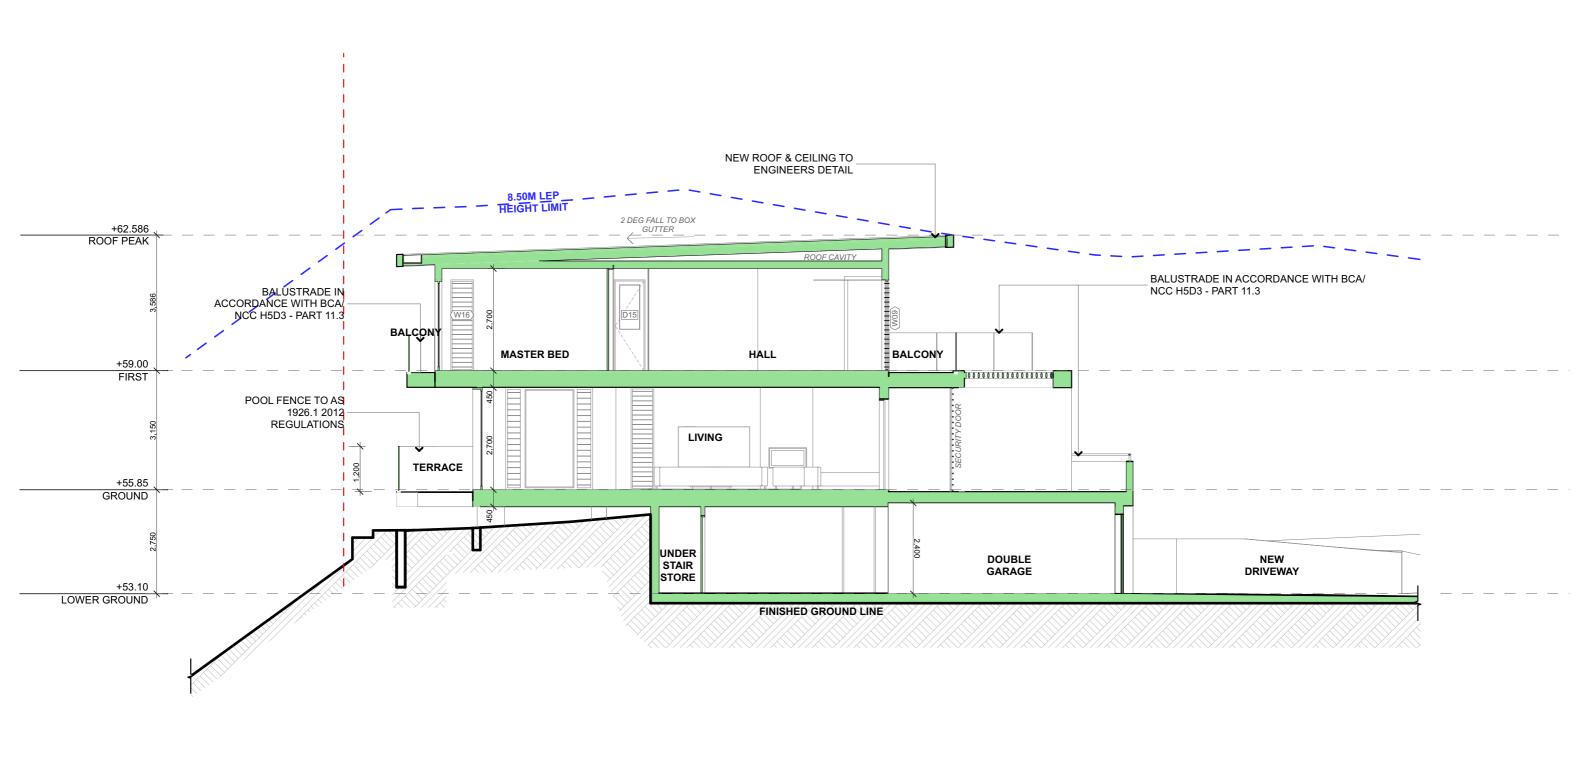

SECTION A 1:100

> NOTE: SITE BOUNDARIES & SETBACKS ARE BEST DISPLAYED ON FLOOR PLANS DUE TO THE EXTEND AND SHAPE OF THE LOT.



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A	DA DOCUMENTATION	SB	09.09.24	EXISTING
В	DOOR&WINDOW SCHEDULE	SB	11.09.24	DEMOLISHED
				PROPOSED

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DPRH: DOWN PIPE RAIN HEAD
FFL: FINISHED FLOOR LEVEL
HWS: HOT WATER SYSTEM
BY DEDITION FOR EVEL


RL: REDUCED LEVEL

ABBREVIATIONS

CLIENTS: **NEIL BURNARD** SITE ADDRESS: 18 HILLCREST AVE DRAWING TITLE: SECTION - A DATE: 1:100 @A3 4/12/2024

MONA VALE, NSW, 2103

PROJECT NO: DRAWING NO: 1084 **DA18**

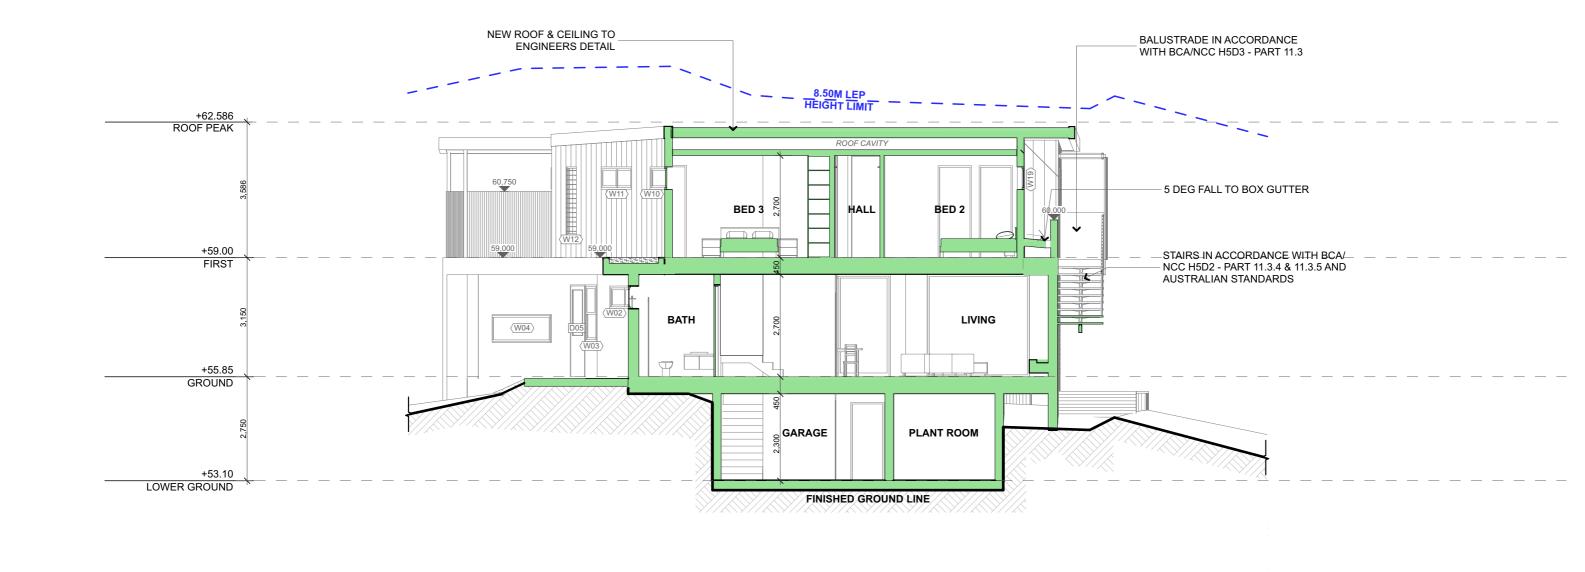

1 SECTION B 1:100

NOTE: SITE BOUNDARIES & SETBACKS ARE BEST DISPLAYED ON FLOOR PLANS DUE TO THE EXTEND AND SHAPE OF THE LOT.



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Α	DA DOCUMENTATION	SB	09.09.24	EXISTING
В	DOOR&WINDOW SCHEDULE	SB	11.09.24	DEMOLISHED
				PROPOSED

ABBREVIATIONS

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DPS: DOWN PIPE SPITTER
DPRH: DOWN PIPE RAIN HEAD
FFL: FINISHED FLOOR LEVEL
HWS: HOT WATER SYSTEM
RL: REDUCED LEVEL

CLIENTS: NEIL BURNARD SITE ADDRESS: 18 HILLCREST AV

DRAWING TITLE:		
SECTION - B		
SCALE:	DATE:	

SITE ADDRESS.		
18 HILLCREST AVE		
MONA VALE, NSW, 2103		

1:100 @A3 4/12/2024

PROJECT NO: DRAWING NO: DA19





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COMMENCES.

Α	DA DOCUMENTATION	SB	09.09.24
В	DOOR&WINDOW SCHEDULE	SB	11.09.24


SITE ADDRESS:

18 HILLCREST AVE MONA VALE, NSW, 2103 4/12/2024

NTS

PROJECT NO: DRAWING NO:

1084 **DA20**

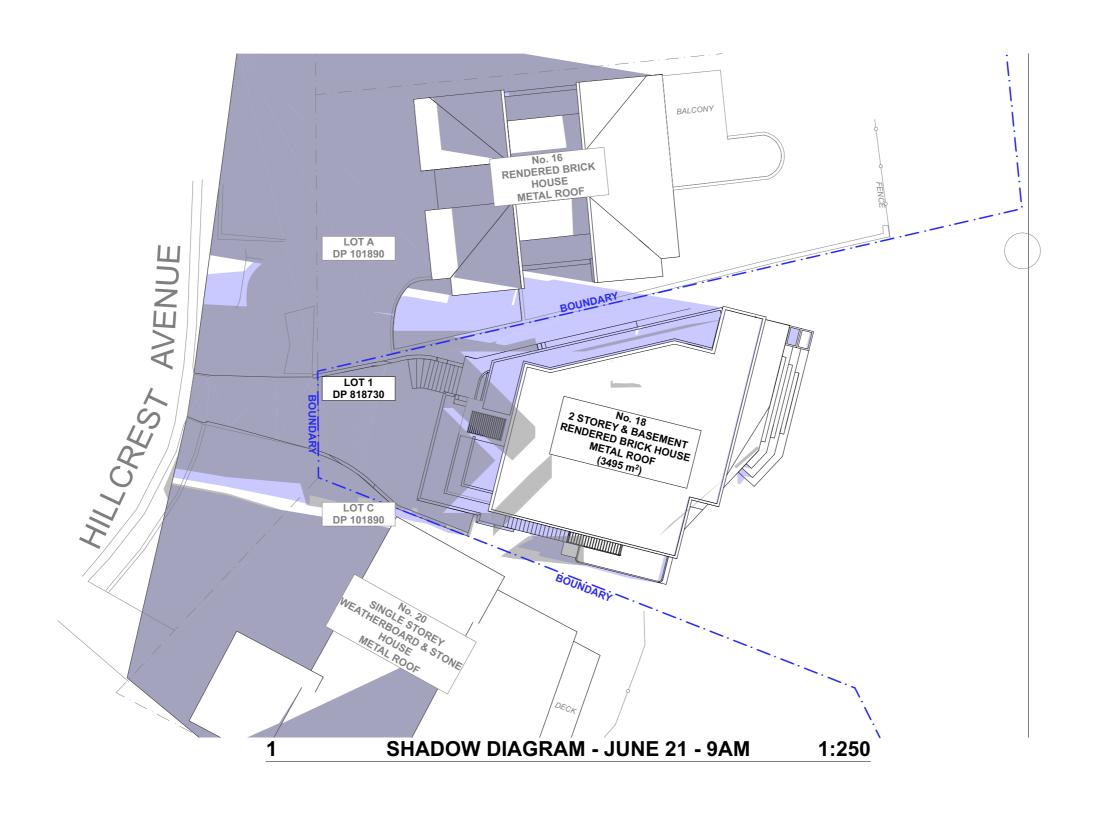



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REV.	NOTES.	INITIAL	DATE	LEGEND
Α	DA DOCUMENTATION	SB	09.09.24	EXISTING SHADOWS
В	DOOR&WINDOW SCHEDULE	SB	11.09.24	PROPOSED SHADOW REDUCTIONS
				PROPOSED SHADOW ADDITIONS

ABBREVIATIONS DP: DEPOSIT PLAN SP: STRATA PLAN NORTH POINT

CLIENTS: **NEIL BURNARD**


SITE ADDRESS: 18 HILLCREST AVE MONA VALE, NSW, 2103 DRAWING TITLE: SHADOW DIAGRAM - JUNE 21ST -9AM SCALE: 1:250 @A3 4/12/2024

DRAWING NO:

DA21

PROJECT NO:

1084

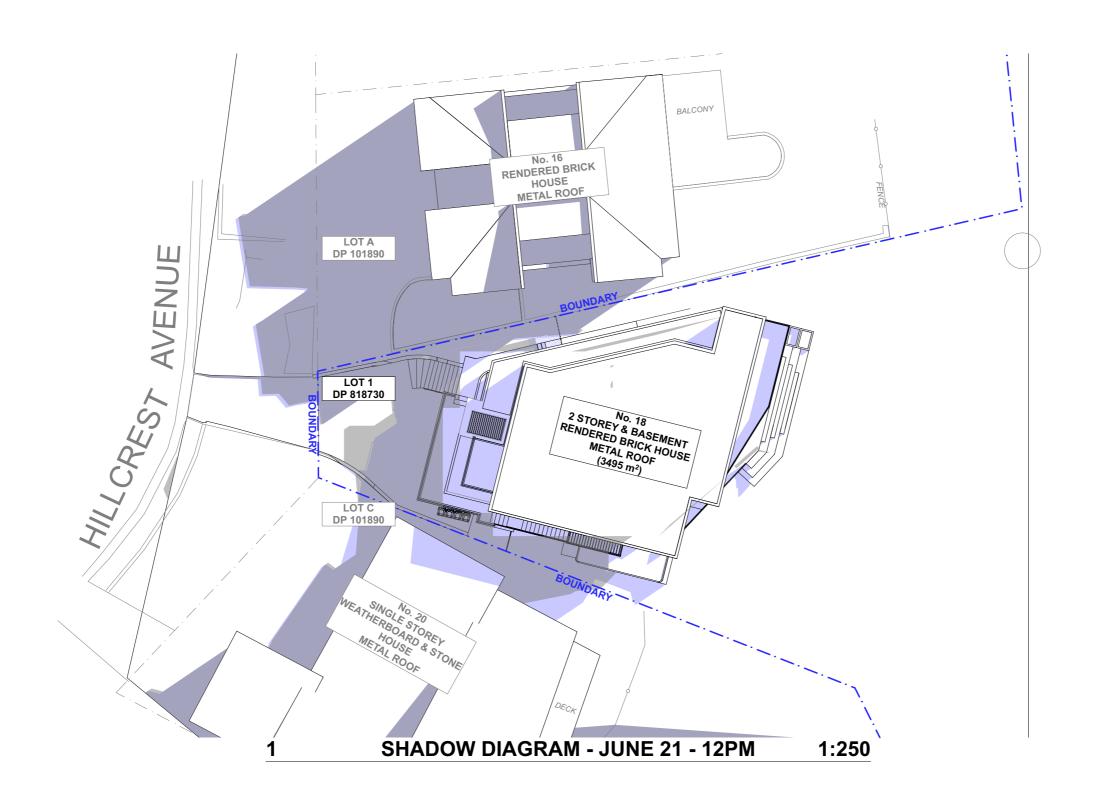



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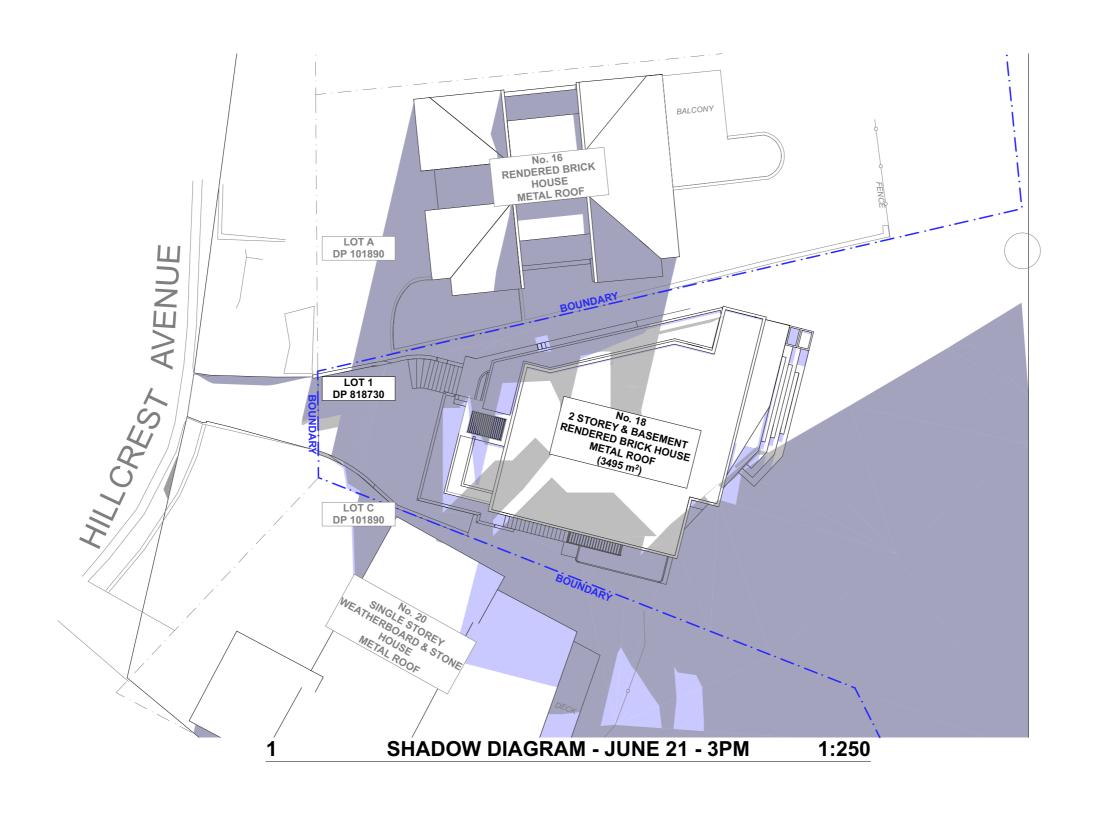
REV.	NOTES.	INITIAL	DATE	LEGEND
Α	DA DOCUMENTATION	SB	09.09.24	EXISTING SHADOWS
В	DOOR&WINDOW SCHEDULE	SB	11.09.24	PROPOSED SHADOW REDUCTIONS
				FROFOSED SHADOW REDUCTIONS
				PROPOSED SHADOW ADDITIONS
		1		

ABBREVIATIONS	
DP: DEPOSIT PLAN SP: STRATA PLAN	

NORTH POINT	CLIENTS:
	NEIL BURNARD
	SITE ADDRESS:
	18 HILLCREST AVE

SHADOW DIAGRAM - JUNE 21ST -12PM SCALE: 1:250 @A3 4/12/2024 PROJECT NO: DRAWING NO: MONA VALE, NSW, 2103 1084 DA22

DRAWING TITLE:






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COMMENCES.

REV.	NOTES.	INITIAL	DATE	LEGEND
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В	DOOR&WINDOW SCHEDULE	SB	11.09.24	PROPOSED SHADOW REDUCTIONS
				FROF OSED STIADOW REDUCTIONS
				PROPOSED SHADOW ADDITIONS


ABBREVIATIONS DP: DEPOSIT PLAN SP: STRATA PLAN



CLIENTS: **NEIL BURNARD**

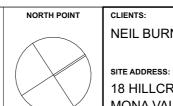18 HILLCREST AVE MONA VALE, NSW, 2103 1084

DRAWING TITLE: SHADOW DIAGRAM - JUNE 21ST -3PM SCALE: 4/12/2024 1:250 @A3 PROJECT NO: DRAWING NO: **DA23**

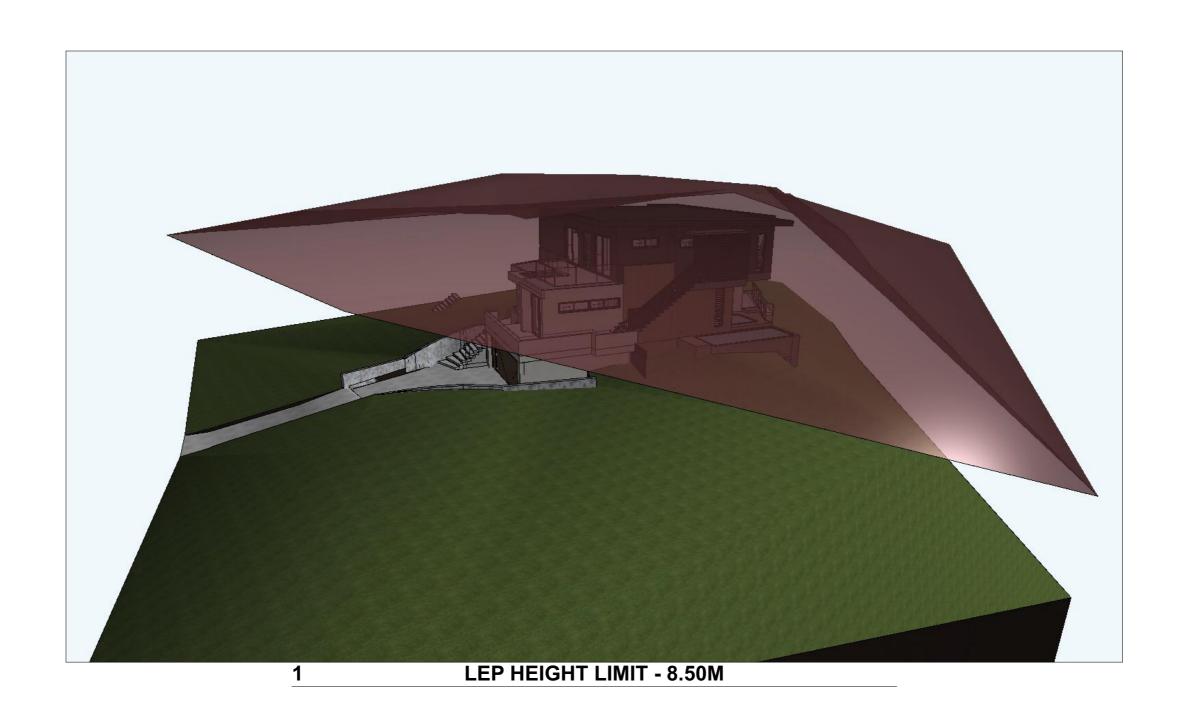



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STRUCTURAL ENGINEER BEFORE WORK
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V.	NOTES.	INITIAL	DATE	LEGEND		
	DA DOCUMENTATION	SB	09.09.24	EXISTING		CB WOODLAND GREY PANEL
1	DOOR&WINDOW SCHEDULE	SB	11.09.24	DEMOLISHED	_	RENDERED WHITE FINISH
				CUT THROUGH		SLATTED TIMBER FINSH
				PROPOSED CONCRETE FINISH		TIMBER FINISH
				GLASS	*	STONE CRAZY PAVING

ABBREVIATIONS

CPD: CUPBOARD
DP: DOWNPIPE
DPS: DOWN PIPE SPITTER
DPRH: DOWN PIPE RAIN HEAD
FFL: FINISHED FLOOR LEVEL
HWS: HOT WATER SYSTEM
RL: REDUCED LEVEL

CLIENTS: **NEIL BURNARD** SITE ADDRESS: 18 HILLCREST AVE MONA VALE, NSW, 2103

DRAWING TITLE:				
LEP HEIGHT LIMIT				
SCALE:	DATE:			
1:100 @A3	4/12/2024			
PROJECT NO:	DRAWING NO:			
	DRAWING NO:			
1084	DA24			



Single Dwelling

Certificate number: 1766586S

This certificate confirms that the proposed development will meet the NSW government's requirements for sustainability, if it is built in accordance with the commitments set out below. Terms used in this certificate, or in the commitments, have the meaning given by the document entitled "BASIX Definitions" dated 10/09/2020 published by the Department. This document is available at www.basix.nsw.gov.au

Secretary
Date of issue: Saturday, 28 September 2024
To be valid, this certificate must be submitted with a development application or lodged with a complying development certificate application within 3 months of the date of issue.



Brainst address		
Project address		
Project name	18 Hillcrest Avenue Mona Vale	
Street address	18 HILLCREST Avenue MONA VALE 2103	
Local Government Area	Northern Beaches Council	
Plan type and plan number	Deposited Plan DP818730	
Lot no.	1	
Section no.	-	
Project type		
Project type	dwelling house (detached)	
No. of bedrooms	4	
Site details		
Site area (m²)	3495	
Roof area (m²)	130	
Conditioned floor area (m²)	213.0	
Unconditioned floor area (m²)	23.2	
Total area of garden and lawn (m²)	100	
Roof area of the existing dwelling (m²)	0	

Project summary		
Project name	18 Hillcrest Avenue Mona Vale	
Street address	18 HILLCREST Avenue MONA	VALE 2103
ocal Government Area	Northern Beaches Council	
Plan type and plan number	Deposited Plan DP818730	
ot no.	1	
Section no.	-	
Project type	dwelling house (detached)	
No. of bedrooms	4	
Project score		
Vater	✓ 40	Target 40
hermal Performance	✓ Pass	Target Pass
Energy	✔ 84	Target 72
Materials	✓ -68	Target n/a
	· · · · · · · · · · · · · · · · · · ·	

Assessor details and therr	nal loads			
Assessor number	HERA10205			
Certificate number S48QEENU8N				
Climate zone	56			
Area adjusted cooling load (MJ/ 10 m².year)				
Area adjusted heating load (MJ/ m².year)	19			
Project score				
Water	✓ 40	Target 40		
Thermal Performance	✓ Pass	Target Pass		
Energy	✔ 84	Target 72		
Materials	✓ -68	Target n/a		
	-			

Water Commitments	Show on DA plans	Show on CC/CDC plans & specs	Certifier check
Landscape			
The applicant must plant indigenous or low water use species of vegetation throughout 70 square metres of the site.	~	~	
Fixtures			
The applicant must install showerheads with a minimum rating of 4 star (> 4.5 but <= 6 L/min plus spray force and/or coverage tests) in all showers in the development.		~	~
The applicant must install a toilet flushing system with a minimum rating of 5 star in each toilet in the development.		~	~
The applicant must install taps with a minimum rating of 5 star in the kitchen in the development.		~	
The applicant must install basin taps with a minimum rating of 5 star in each bathroom in the development.		~	
Alternative water			
Rainwater tank			
The applicant must install a rainwater tank of at least 3000 litres on the site. This rainwater tank must meet, and be installed in accordance with, the requirements of all applicable regulatory authorities.	~	~	~
The applicant must configure the rainwater tank to collect rain runoff from at least 130 square metres of the roof area of the development (excluding the area of the roof which drains to any stormwater tank or private dam).		~	~
The applicant must connect the rainwater tank to:			
 at least one outdoor tap in the development (Note: NSW Health does not recommend that rainwater be used for human consumption in areas with potable water supply.) 		-	-

Water Commitments	Show on DA plans	Show on CC/CDC plans & specs	Certifier check
The swimming pool must not have a volume greater than 8.5 kilolitres.	~	~	
The swimming pool must be outdoors.	~	~	
Outdoor Spa			
The spa must not have a volume greater than 1.65 kilolitres.	~	~	
The spa must be shaded.		~	

NOTES

Thermal Performance and Materials commitments	Show on DA plans	Show on CC/CDC plans & specs	Certifier check
Simulation Method			
Assessor details and thermal loads			
The applicant must attach the certificate referred to under "Assessor Details" on the front page of this BASIX certificate (the "Assessor Certificate") to the development application and construction certificate application for the proposed development (or, if the applicant is applying for a complying development certificate for the proposed development, to that application). The applicant must also attach the Assessor Certificate to the application for an occupation certificate for the proposed development.			
The Assessor Certificate must have been issued by an Accredited Assessor in accordance with the Thermal Comfort Protocol.			
The details of the proposed development on the Assessor Certificate must be consistent with the details shown in this BASIX certificate, including the Cooling and Heating loads shown on the front page of this certificate and the "Construction" and "Glazing" tables below.			
The applicant must show on the plans accompanying the development application for the proposed development, all matters which the Assessor Certificate requires to be shown on those plans. Those plans must bear a stamp of endorsement from the Accredited Assessor to certify that this is the case. The applicant must show on the plans accompanying the application for a construction certificate (or complying development certificate, if applicable), all thermal performance specifications set out in the Assessor Certificate, and all aspects of the proposed development which were used to calculate those specifications.	~	~	~
The applicant must construct the development in accordance with all thermal performance specifications set out in the Assessor Certificate, and in accordance with those aspects of the development application or application for a complying development certificate which were used to calculate those specifications.		~	~
The applicant must show on the plans accompanying the development application for the proposed development, the locations of ceiling fans set out in the Assessor Certificate. The applicant must show on the plans accompanying the application for a construction certificate (or complying development certificate, if applicable), the locations of ceiling fans set out in the Assessor Certificate.	~	~	~

Thermal Performance and Materials commitments	Show on DA plans	Show on CC/CDC plans & specs	Certifier check
Construction			
The applicant must construct the floors, walls, roofs, ceilings and glazing of the dwelling in accordance with the specifications listed in the tables below.	~	~	~
The applicant must show through receipts that the materials purchased for construction are consistent with the specifications listed in the tables below.			~

Construction	Area - m²	Insulation
floor - concrete slab on ground, conventional slab.	92	none
garage floor - concrete slab on ground, waffle pod slab.	92	none
external wall: cavity brick; frame: no frame.	161	foil-foam composite board
external wall: framed (metal clad); frame: timber - H2 treated softwood.	122	fibreglass batts or roll
internal wall: single skin masonry; frame: no frame.	93	none
internal wall: plasterboard; frame: timber - H2 treated softwood.	127	none
ceiling and roof - flat ceiling / pitched roof, framed - metal roof, timber - H2 treated softwood.	130	ceiling: fibreglass batts or roll; roof: foil backed blanket.

Thermal Performance and Materials commitments		Show on CC/CDC plans & specs	Certifier check
Glazing			
The applicant must install windows, glazed doors and skylights as described in the table below, in accordance with the specifications listed in the table.		~	>

Frames	Maximum area - m2
aluminium	96.55
timber	0
uPVC	0
steel	0
composite	0

Glazing	Maximum area - m2
single	0
double	96.55
triple	0



progressive plans

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В	DOOR&WINDOW SCHEDULE	SB	11.09.24	DEMOLIS	
				PROPOS	
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EXISTING DEMOLISHED

ABBREVIATIONS

CPD: CUPBOARD
DP: DOWNPIPE
DPS: DOWN PIPE SPITTER
DPRH: DOWN PIPE RAIN HEAD
FEL: FINISHED FLOOR LEVEL
FW: FLOOR WASTE
HWS: HOT WATER SYSTEM
RL: REDUCED LEVEL
SA: SMOKE ALARM



CLIENTS: **NEIL BURNARD**

SITE ADDRESS: 18 HILLCREST AVE MONA VALE, NSW, 2103

DRAWING TITLE: BASIX	
\$9.85 ; 1:1.72 @A3	DATE: 4/12/2024
PROJECT NO: 1084	DA25

Energy Commitments	Show on DA plans	Show on CC/CDC plans & specs	Certifier check
Hot water			
The applicant must install the following hot water system in the development, or a system with a higher energy rating: electric heat pump with a performance of 31 to 35 STCs or better.	•	~	~
Cooling system			
The applicant must install the following cooling system, or a system with a higher energy rating, in at least 1 living area: 1-phase airconditioning - ducted; Energy rating: 3 Star (old label)		~	~
The applicant must install the following cooling system, or a system with a higher energy rating, in at least 1 bedroom: 1-phase airconditioning - ducted; Energy rating: 3 Star (old label)		~	~
Heating system			
The applicant must install the following heating system, or a system with a higher energy rating, in at least 1 living area: 1-phase airconditioning - ducted; Energy rating: 3 Star (old label		~	~
The applicant must install the following heating system, or a system with a higher energy rating, in at least 1 bedroom: 1-phase airconditioning - ducted; Energy rating: 3 Star (old label		~	~
Ventilation			
The applicant must install the following exhaust systems in the development:			T
At least 1 Bathroom: individual fan, ducted to façade or roof; Operation control: manual on / timer off			
Kitchen: individual fan, ducted to façade or roof; Operation control: manual switch on/off		J	
Laundry: individual fan, ducted to façade or roof; Operation control: manual on / timer off		•	-
Artificial lighting		•	
The applicant must ensure that a minimum of 80% of light fixtures are fitted with fluorescent, compact fluorescent, or light-emitting-diode (LED) lamps.		~	~
Natural lighting			
The applicant must install a window and/or skylight in the kitchen of the dwelling for natural lighting.	~		~
The applicant must install a window and/or skylight in 4 bathroom(s)/toilet(s) in the development for natural lighting.	~	~	~
Swimming pool			
The applicant must install the following heating system for the swimming pool in the development (or alternatively must not install any heating system for the swimming pool): electric heat pump		~	
The applicant must install the following pump for the swimming pool in the development, or a pump with a higher energy rating: single speed with a performance of 4 stars.		>	
The applicant must install a timer for the swimming pool pump in the development.		>	
Outdoor spa			
The applicant must install the following heating system for the spa in the development (or alternatively must not install any heating system for the spa): electric heat pump		~	
The applicant must install a timer for the spa pump in the development.		>	
Alternative energy			
The applicant must install a photovoltaic system as part of the development. The applicant must connect this system to the development's electrical system.	~	~	~
The photovolatic system must consist of: • photovolatic collectors with the capacity to generate at least 4 peak kilowatts of electricity, installed at an angle between 0 degrees and 10 degrees to the horizontal facing west	•	•	,
Other			
The applicant must install a fixed outdoor clothes drying line as part of the development.		~	
Legend			
In these commitments, "applicant" means the person carrying out the development.			
Commitments identified with a v in the "Show on DA plans" column must be shown on the plans accompanying the development applic development application is to be lodged for the proposed development).	ation for the pr	roposed development (i	f a
Commitments identified with a 🗸 in the "Show on CC/CDC plans and specs" column must be shown in the plans and specifications accertificate / complying development certificate for the proposed development.	ompanying the	application for a constr	uction
Commitments identified with a 🗸 in the "Certifier check" column must be certified by a certifying authority as having been fulfilled, before final) for the development may be issued.	a final occupa	ation certificate (either in	nterim or



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HOTES


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				PROPOSED	

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RL: REDUCED LEVEL
SA: SMOKE ALARM



CLIENTS: NEIL BURNARD

SITE ADDRESS: 18 HILLCREST AVE MONA VALE, NSW, 2103

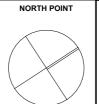DRAWING TITLE: BASIX DATE: 1:1.72 @A3 4/12/2024 PROJECT NO: DRAWING NO: 1084 DA26

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