

#### CONTENTS


PERSPECTIVES, MATERIALS & FINISHES SURVEY
SITE ANALYSIS & WASTE MANAGEMENT PLAN LOWER FLOOR PLAN GROUND FLOOR PLAN FIRST FLOOR PLAN ROOF PLAN ELEVATIONS, N, S ELEVATIONS, E ELEVATIONS, W SECTIONS A-A, B-B SECTIONS C-C SECTIONS D-D FLOOR AREA PLAN OPEN SPACE & LANDSCA DING PLAN SOLAR JUNE 21 - 9AM DA3 DA4 DA5 DA6 DA7


SOLAR JUNE 21 - 9AM SOLAR JUNE 21 - 12PM SOLAR JUNE 21 - 3PM BASIX

# private residence

# 21 wattle ave, fairlight


additions and alterations development application architectural perspectives

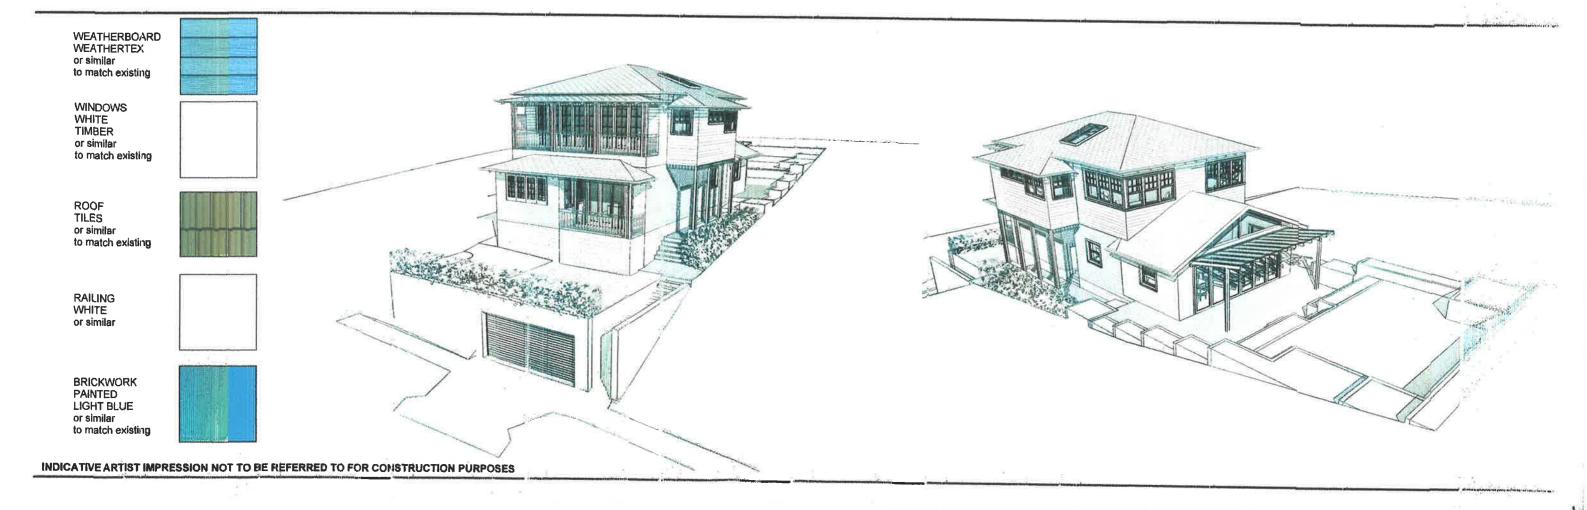


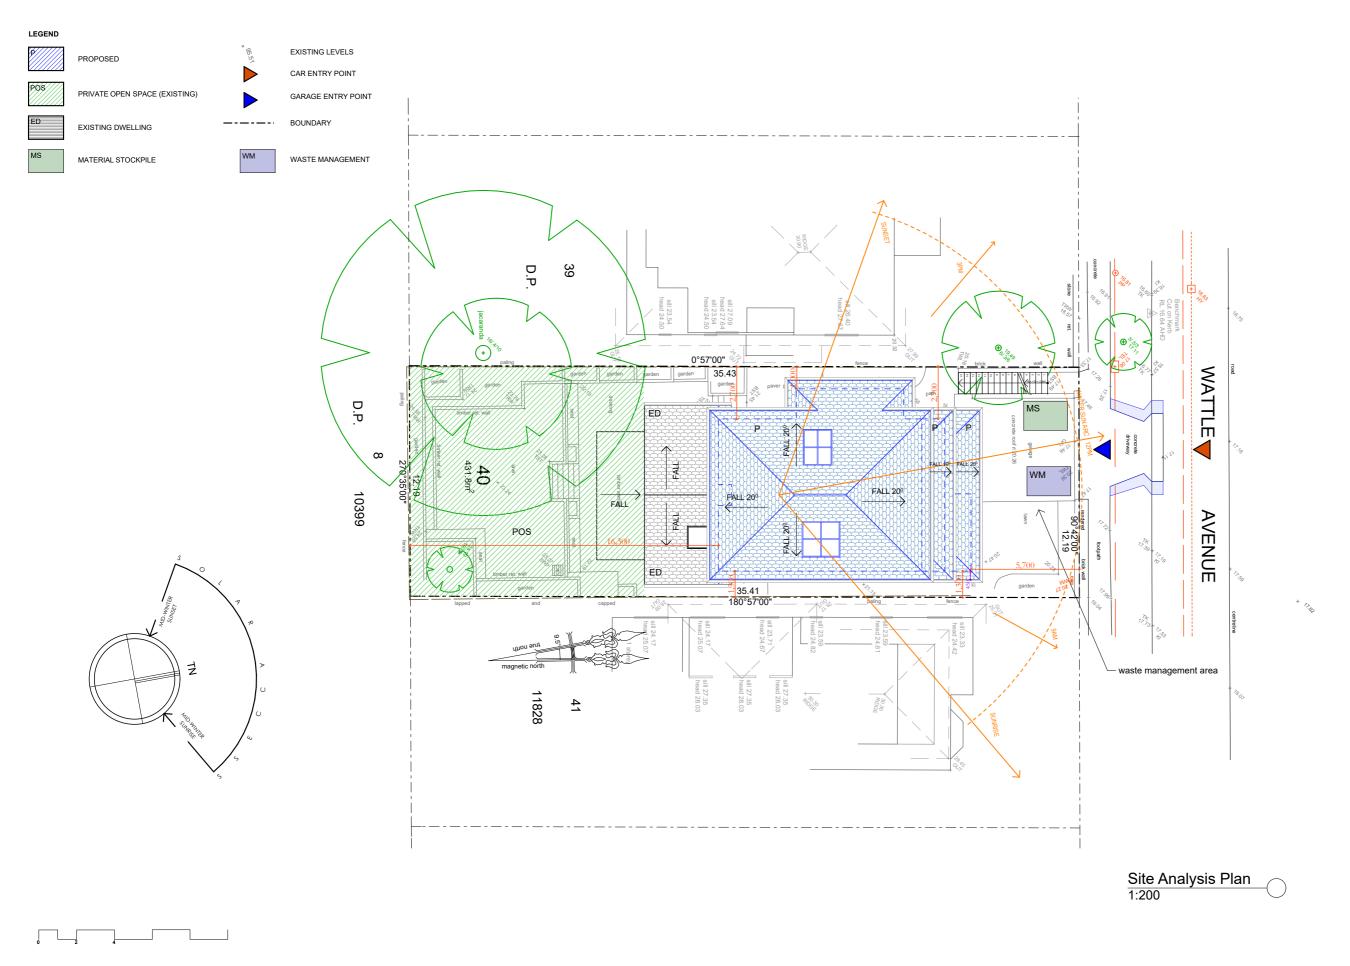

DO NOT SCALE DRAWINGS. CHECK ALL DIMENSIONS ON SITE. FIGURED DIMENSIONS TAKE PRECEDENCE. PROJECT: 21 Wattle Avenue, Fairlight, DA The builder shall check and verify all dimensions and verify all errors and omissions to the Architect. Do not scale the drawings.

Drawings shall not be used for construction purposes until issued by the Architect for construction. sketchArc 2094, NSW SCALE: PROJECT NUMBER: 1712 Alterations & Additions 180919 Po Box 377 Manly 1655 m : 0422 521 871 sketchArc DRAWN/DESIGNED PB / MP LOT 40 in DP 11828 - 431.8m2 = Demolition DA e : power@sketcharc.com.au DA3 w : www.sketcharc.com.au Private REV DATE DESCRIPTION

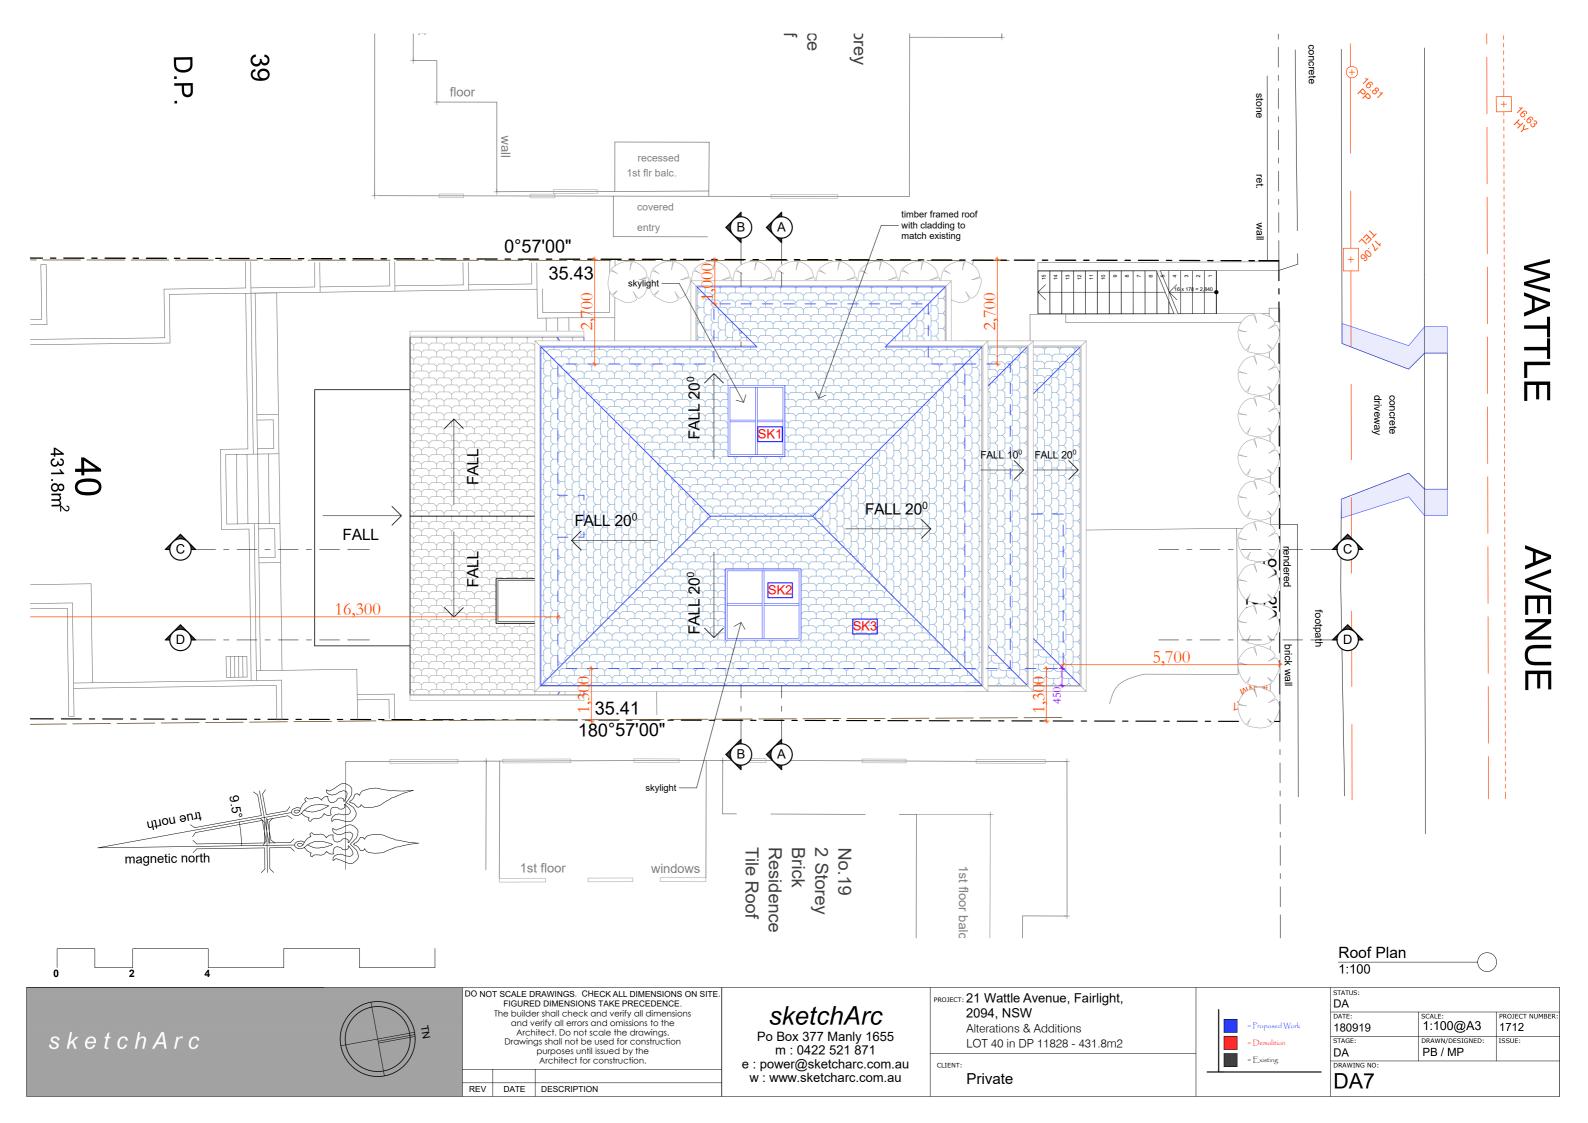

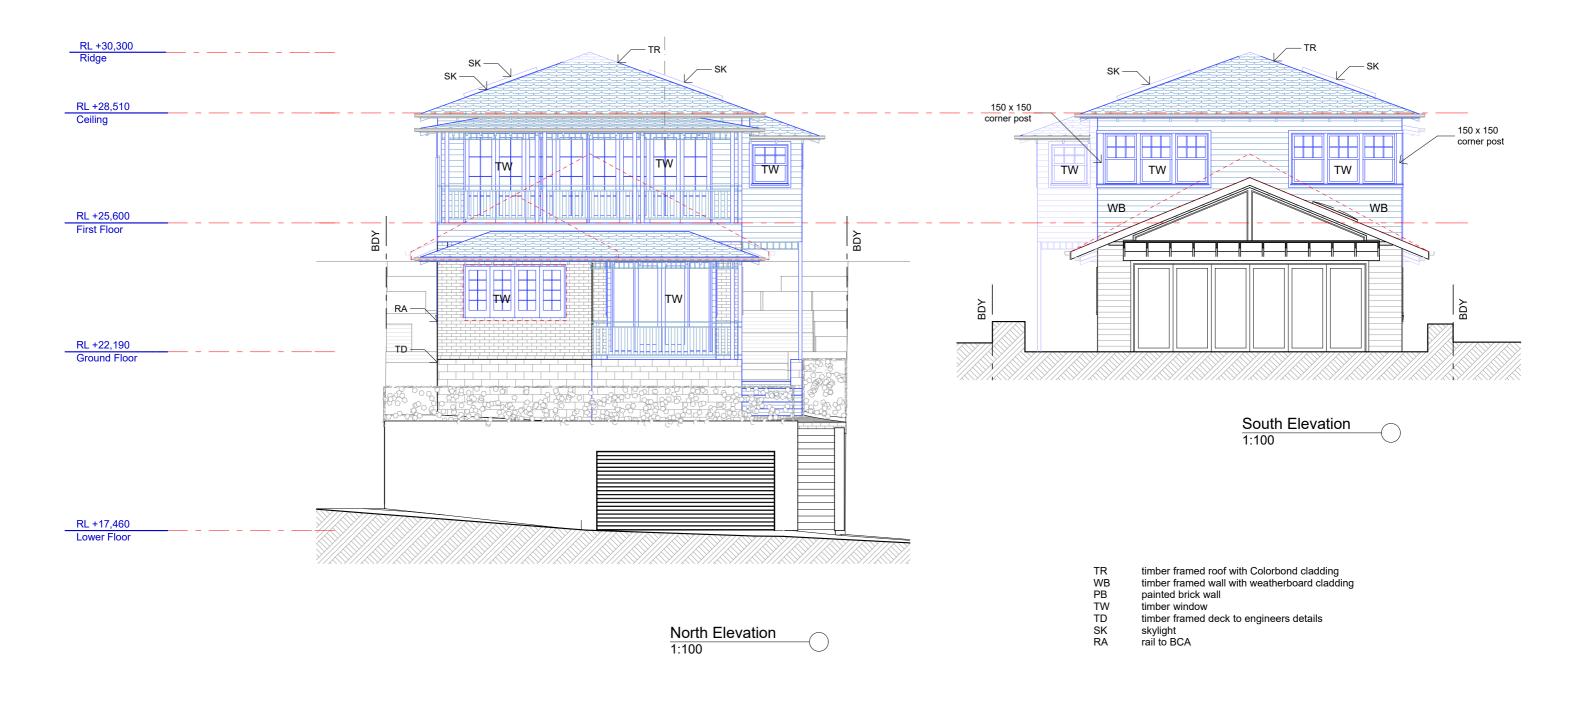



# DO NOT SCALE DRAWINGS. CHECK ALL DIMENSIONS ON SITE. FIGURED DIMENSIONS TAKE PRECEDENCE. The builder shall check and verify all dimensions and verify all errors and omissions to the Architect. Do not scale the drawings. Drawings shall not be used for construction purposes until issued by the Architect for construction. REV DATE DESCRIPTION


## sketchArc

Po Box 377 Manly 1655 m: 0422 521 871 e: power@sketcharc.com.au w: www.sketcharc.com.au

PROJECT: 21 Wattle Avenue, Fairlight,	
2094, NSW	
Alterations & Additions	
LOT 40 in DP 11828 - 431.8m2	
CLIENT:	7
Private	

STATUS:		
DA		
DATE:	SCALE:	PROJECT NUMBER:
180919	1:100@A3	1712
STAGE:	DRAWN/DESIGNED:	ISSUE:
DA	PB / MP	
DRAWING NO:	•	
DA8		

TR WB PB TW TD SK RA timber framed roof with Colorbond cladding timber framed wall with weatherboard cladding painted brick wall timber window timber framed deck to engineers details skylight rail to BCA

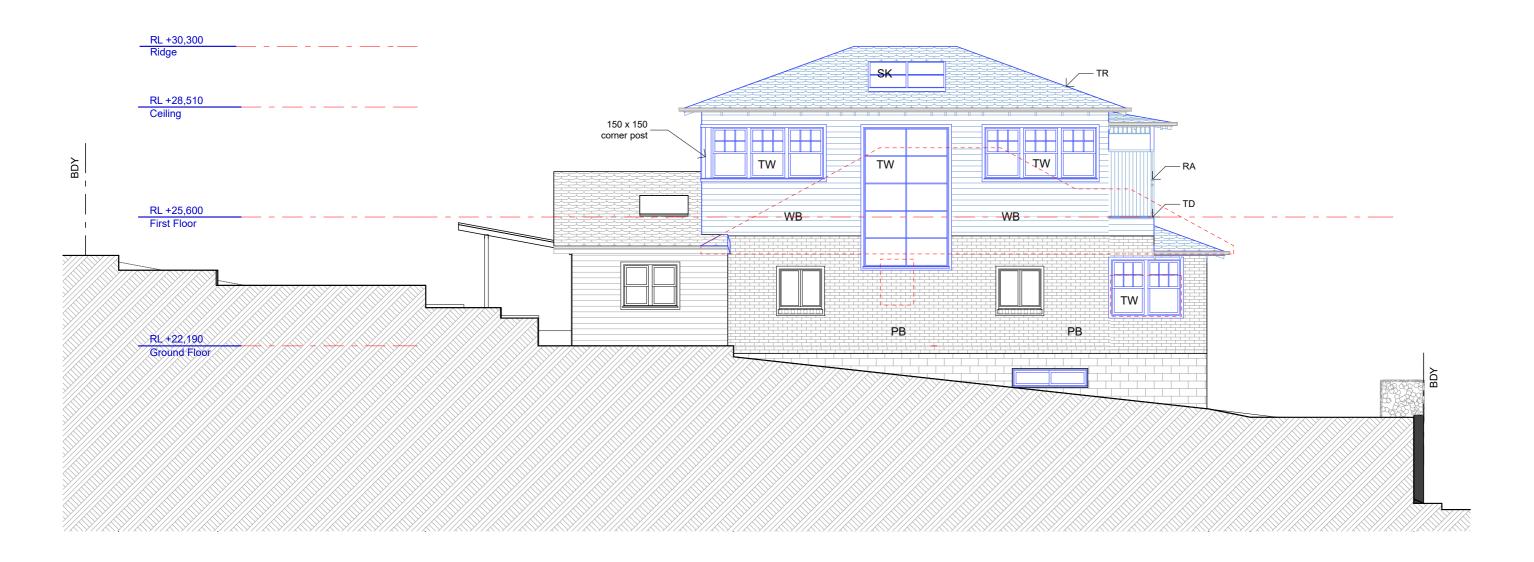

East Elevation 1:100



DO NOT SCALE DRAWINGS. CHECK ALL DIMENSIONS ON SITE. FIGURED DIMENSIONS TAKE PRECEDENCE. The builder shall check and verify all dimensions and verify all errors and omissions to the Architect. Do not scale the drawings.
Drawings shall not be used for construction
purposes until issued by the
Architect for construction. sketchArc REV DATE DESCRIPTION

## sketchArc

Po Box 377 Manly 1655 m : 0422 521 871 e : power@sketcharc.com.au w : www.sketcharc.com.au PROJECT: 21 Wattle Avenue, Fairlight, 2094, NSW Alterations & Additions LOT 40 in DP 11828 - 431.8m2 Private

	STATUS:
	DA
	DATE:
= Proposed Work	180919
= Demolition	STAGE:
= Existing	DA
Laberry	DRAWING NO:
	DVO

SCALE: 1:100@A3 PROJECT NUMBER: 1712 DRAWN/DESIGNED: PB / MP DA9

WB PB TW TD SK RA skylight rail to BCA RL +30,300 RL +28,510 Ceiling \_ 150 x 150 corner post TW TD -RL +25,600 WB WB First Floor ΡВ PB TD -RL +22,190 Ground Floor WB RL +17,460



## DO NOT SCALE DRAWINGS. CHECK ALL DIMENSIONS ON SITE. FIGURED DIMENSIONS TAKE PRECEDENCE. The builder shall check and verify all dimensions and verify all errors and omissions to the Architect. Do not scale the drawings. Drawings shall not be used for construction purposes until issued by the Architect for construction. sketchArc REV DATE DESCRIPTION

# sketchArc

Po Box 377 Manly 1655 m : 0422 521 871 e : power@sketcharc.com.au w : www.sketcharc.com.au PROJECT: 21 Wattle Avenue, Fairlight, 2094, NSW Alterations & Additions LOT 40 in DP 11828 - 431.8m2 Private



West Elevation


1:100

timber framed roof with Colorbond cladding timber framed wall with weatherboard cladding

timber framed deck to engineers details


painted brick wall timber window

TR

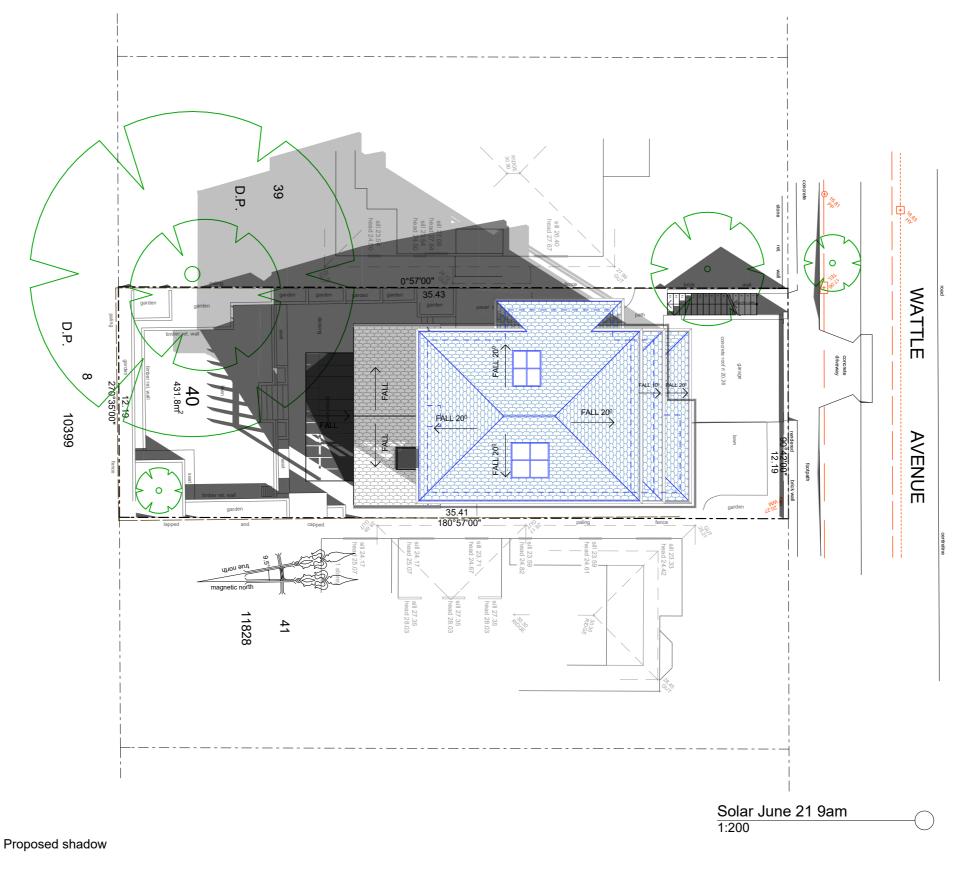




Existing shadow

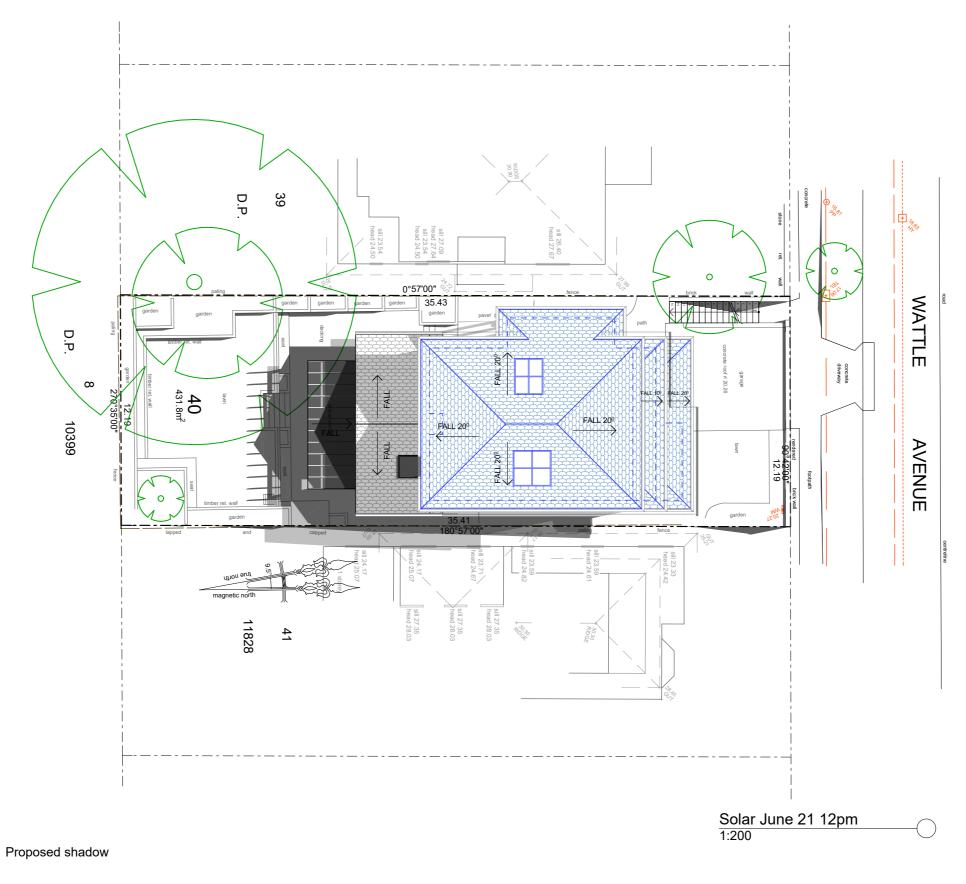



Existing shadow

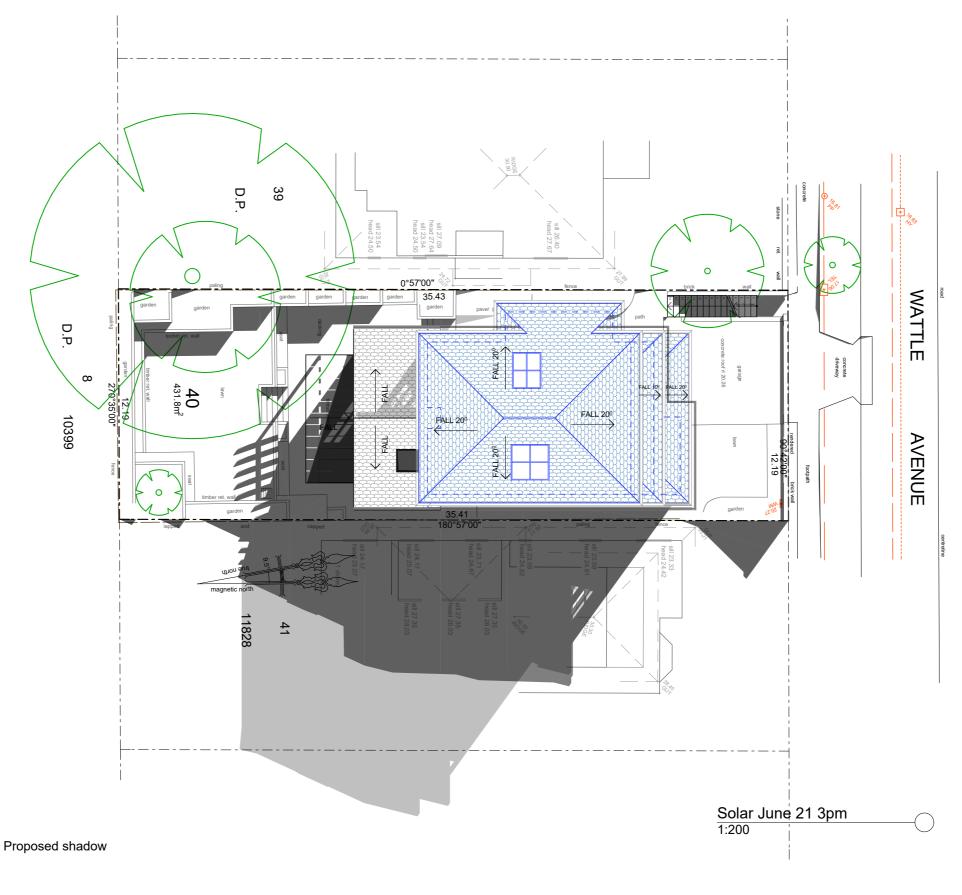



Existing shadow



Building Sustainability Index www.basix.nsw.gov.au

#### **Alterations and Additions**

Certificate number: A324632\_05

This certificate confirms that the proposed development will meet the NSW government's requirements for sustainability, if it is built in accordance with the commitments set out below. Terms used in this certificate, or in the commitments, have the meaning given by the document entitled "BASIX Alterations and Additions Definitions" dated 06/10/2017 published by the Department. This document is available at www.basix.nsw.gov.au

#### Secretary

Date of issue: Thursday, 03, October 2019 To be valid, this certificate must be lodged within 3 months of the date of issue.

NSW	anning &
GOVERNMENT EN	vironment

Project address	
Project name	21 Wattle Ave - DA_05
Street address	21 Wattle Avenue Fairlight 2094
Local Government Area	Manly Council
Plan type and number	Deposited Plan 11828
Lot number	40
Section number	
Project type	
Dwelling type	Separate dwelling house
Type of alteration and addition	My renovation work is valued at \$50,000 or more, and does not include a pool (and/or spa).

Fixtures and systems			Show on DA Plans	Show on CC/CDC Plans & specs	Certifier Check
Lighting					•
The applicant must ensure a minimum of 40% of new or altered light fixtures are fitted with fluorescent, compact fluorescent, or light-emitting-diode (LED) lamps.					<b>~</b>
Fixtures			1		
The applicant must ensure new or altered show	werheads have a flow rate no greater than 9 litres	per minute or a 3 star water rating.		✓	✓
The applicant must ensure new or altered toiler	ts have a flow rate no greater than 4 litres per ave	erage flush or a minimum 3 star water rating.		<b>✓</b>	<b>~</b>
The applicant must ensure new or altered taps	have a flow rate no greater than 9 litres per minu	ute or minimum 3 star water rating.		<b>✓</b>	
Construction					Certifier Check
	ed construction (floor(s), walls, and ceilings/roofs) ation is not required where the area of new construction is not required where the area of new construction already exists.		~	<b>~</b>	V
			_		•
Construction	Additional insulation required (R-value)	Other specifications			ľ
Construction suspended floor with enclosed subfloor: framed (R0.7).	,	Other specifications	_		Ť
suspended floor with enclosed subfloor:	Additional insulation required (R-value)  R0.60 (down) (or R1.30 including	Other specifications	_		·
suspended floor with enclosed subfloor: framed (R0.7).	Additional insulation required (R-value)  R0.60 (down) (or R1.30 including construction)	Other specifications			·
suspended floor with enclosed subfloor: framed (R0.7). floor above existing dwelling or building.	Additional insulation required (R-value)  R0.60 (down) (or R1.30 including construction)  nil	Other specifications	_		·

### Legend

In these commitments, "applicant" means the person carrying out the development.

Commitments identified with a "\"" in the "Show on DA plans" column must be shown on the plans accompanying the development application for the proposed development (if a development application is to be lodged for the proposed development).

Commitments identified with a "\" in the "Show on CC/CDC plans & specs" column must be shown in the plans and specifications accompanying the application for a construction certificate / complying development certificate for the proposed development.

Commitments identified with a "v" in the "Certifier check" column must be certified by a certifying authority as having been fulfilled, before a final occupation certificate for the development may be issued.

Each window or glazed door with improved frames, or pyrolytic low-e glass, or clear/air gap/clear glazing, or toned/air gap/clear glazing must have a U-value and a Solar Heat Gain Coefficient (SHGC) no greater than that listed in the table below. Total system U-values and SHGCs must be calculated in accordance with National Fenestration Rating Council (NFRC) conditions. The description is provided for information only. Alternative systems with complying U-value and SHGC may be substituted.						<b>✓</b>	<b>✓</b>			
For projections described in millimetres, the leading edge of each eave, pergola, verandah, balcony or awning must be no more than 500 mm above the head of the window or glazed door and no more than 2400 mm above the sill.						<b>✓</b>	<b>~</b>	<b>✓</b>		
	ons described own in the tab		he ratio o	f the projection	on from the wall to the h	eight above	the window or glazed door sill must be at	<b>✓</b>	<b>✓</b>	<b>~</b>
Pergolas with polycarbonate roof or similar translucent material must have a shading coefficient of less than 0.35.					of less than 0.35.		<b>~</b>	~		
					e window or glazed door ens must not be more th		ch they are situated, unless the pergola also		<b>✓</b>	<b>✓</b>
	and glazed		lazing r	equireme	nts			-		
Window / do no.	oor Orientatio	n Area of glass	Oversha	,	Shading device		Frame and glass type			
110.		inc. frame (m2)	Height (m)	Distance (m)						
W1	N	3.7	0	0	eave/verandah/pergol >=600 mm	a/balcony	improved aluminium, single pyrolytic low-e, (U-value: 4.48, SHGC: 0.46)			
W1A	E	1	0	0	projection/height abov >=0.23	e sill ratio	improved aluminium, single pyrolytic low-e, (U-value: 4.48, SHGC: 0.46)			
W2	E	2.8	0	0	eave/verandah/pergol >=600 mm	a/balcony	improved aluminium, single pyrolytic low-e, (U-value: 4.48, SHGC: 0.46)			
W3	N	6.2	0	0	eave/verandah/pergol	a/balcony	improved aluminium, single clear, (U-value:			
					>=900 mm		6.44, SHGC: 0.75)			
W3A	E	0.6	0	0	eave/verandah/pergol >=900 mm		improved aluminium, single clear, (U-value: 6.44, SHGC: 0.75)			
W3B	W	0.6	0	0	eave/verandah/pergol >=900 mm	a/balcony	improved aluminium, single clear, (U-value: 6.44, SHGC: 0.75)			
W4	N	7.8	0	0	eave/verandah/pergol >=900 mm	a/balcony	improved aluminium, single clear, (U-value: 6.44, SHGC: 0.75)			
W5	N	7.8	0	0	eave/verandah/pergol >=900 mm	a/balcony	improved aluminium, single clear, (U-value: 6.44, SHGC: 0.75)			
W6	E	4.2	0	0	eave/verandah/pergol >=600 mm	a/balcony	improved aluminium, single pyrolytic low-e, (U-value: 4.48, SHGC: 0.46)			
W7	E	8.6	0	0	eave/verandah/pergol >=600 mm	a/balcony	improved aluminium, single pyrolytic low-e, (U-value: 4.48, SHGC: 0.46)			
W8	E	4.2	0	0	eave/verandah/pergol >=600 mm	a/balcony	improved aluminium, single pyrolytic low-e, (U-value: 4.48, SHGC: 0.46)			
W9	S	3.9	0	0	eave/verandah/pergol >=600 mm	a/balcony	improved aluminium, single clear, (U-value: 6.44, SHGC: 0.75)			
W10	S	3.9	0	0	eave/verandah/pergol >=600 mm	a/balcony	improved aluminium, single clear, (U-value: 6.44, SHGC: 0.75)			
W11	W	4.2	0	0	eave/verandah/pergol >=600 mm	a/balcony	improved aluminium, single pyrolytic low-e, (U-value: 4.48, SHGC: 0.46)			
W12	S	1	0	0	eave/verandah/pergol >=600 mm	a/balcony	improved aluminium, single clear, (U-value: 6.44, SHGC: 0.75)			
W13	W	2	0	0	eave/verandah/pergol >=600 mm	a/balcony	improved aluminium, single pyrolytic low-e, (U-value: 4.48, SHGC: 0.46)			
W14	W	1.3	0	0	eave/verandah/pergol	a/balcony	improved aluminium, single pyrolytic low-e,			
					>=600 mm		(U-value: 4.48, SHGC: 0.46)			
W15	N	1.1	0	0	eave/verandah/pergol >=600 mm	a/balcony	improved aluminium, single pyrolytic low-e, (U-value: 4.48, SHGC: 0.46)			
Skylights										
	nt must install	the skylight	ts in acco	rdance with t	he specifications listed in	n the table h	elow	./	./	
• • •		, 0			n to each skylight:	ii tile table b	Glow.	· ·	V	· /
Each skyligh the table bel		natch the d	escription	, or, have a l	J-value and a Solar Hea	t Gain Coeff	ficient (SHGC) no greater than that listed in		<b>✓</b>	<b>✓</b>
External awnings and louvres must fully shade the skylight above which they are situated when fully drawn or closed.					fully drawn or closed.		<b>✓</b>	<b>✓</b>		
Skylights	glazing red	quiremen	nts					]		
Skylight nun	mber Area o	of glazing nme (m2)	Shading	g device		Frame and	glass type			
S1 2.8 external adjustable awning or blind aluminium, moulded plastic single clear, (or U-value: 6.21, SHGC: 0.808)										
S2	3.7		externa	external adjustable awning or blind aluminium, moulded plastic single clear, (or U-value:						

The applicant must install the windows, glazed doors and shading devices, in accordance with the specifications listed in the table below.

Relevant overshadowing specifications must be satisfied for each window and glazed door. The following requirements must also be satisfied in relation to each window and glazed door:

DO NOT SCALE DRAWINGS. CHECK ALL DIMENSIONS ON SITE. FIGURED DIMENSIONS TAKE PRECEDENCE. The builder shall check and verify all dimensions and verify all errors and omissions to the

REV DATE DESCRIPTION

Architect. Do not scale the drawings.
Drawings shall not be used for construction purposes until issued by the Architect for construction.

sketchArc Po Box 377 Manly 1655

Windows and glazed doors

m: 0422 521 871 e : power@sketcharc.com.au w:www.sketcharc.com.au

PROJECT: 21 Wattle Avenue, Fairlight, 2094, NSW Alterations & Additions

LOT 40 in DP 11828 - 431.8m2

= Existing



sketchArc

Private