

SHADOW DIAGRAM

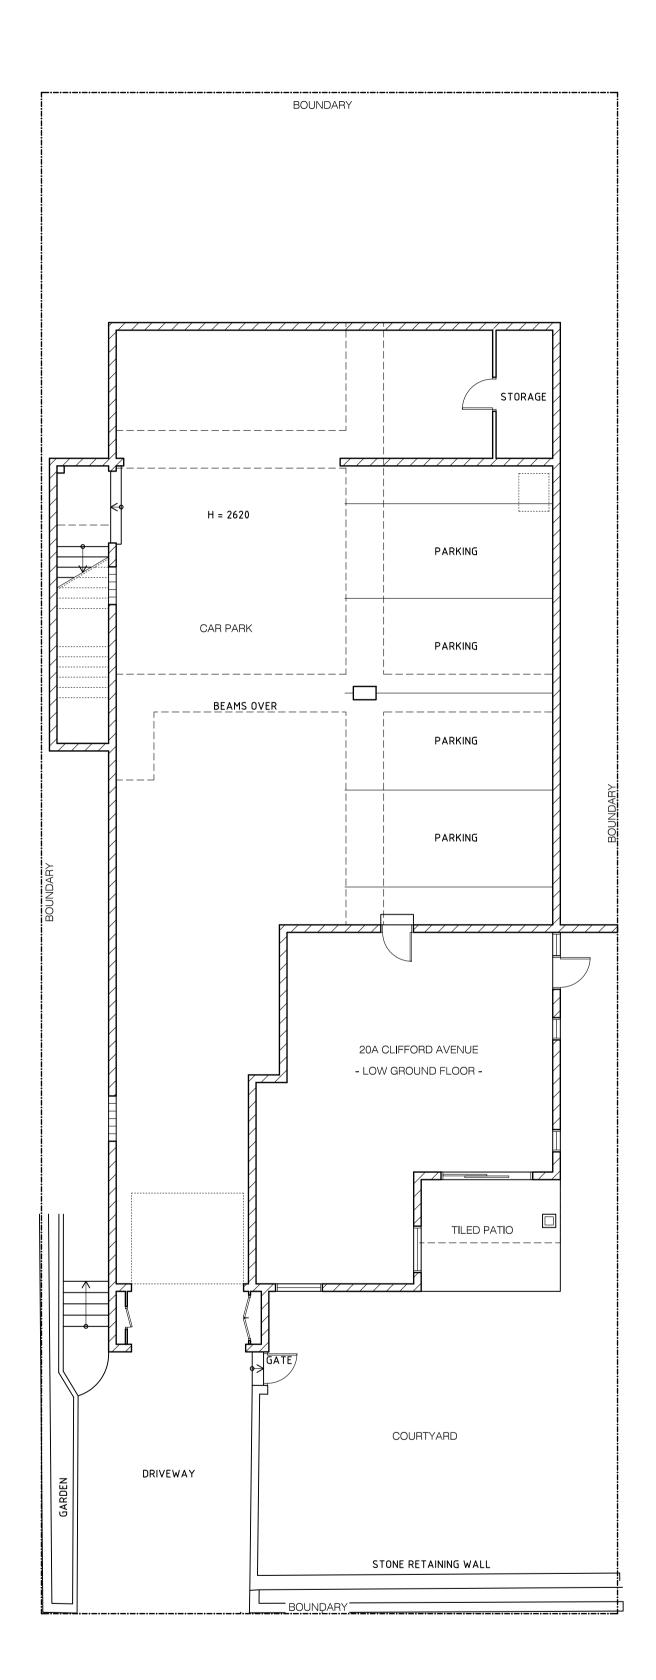
SCALE 1:100

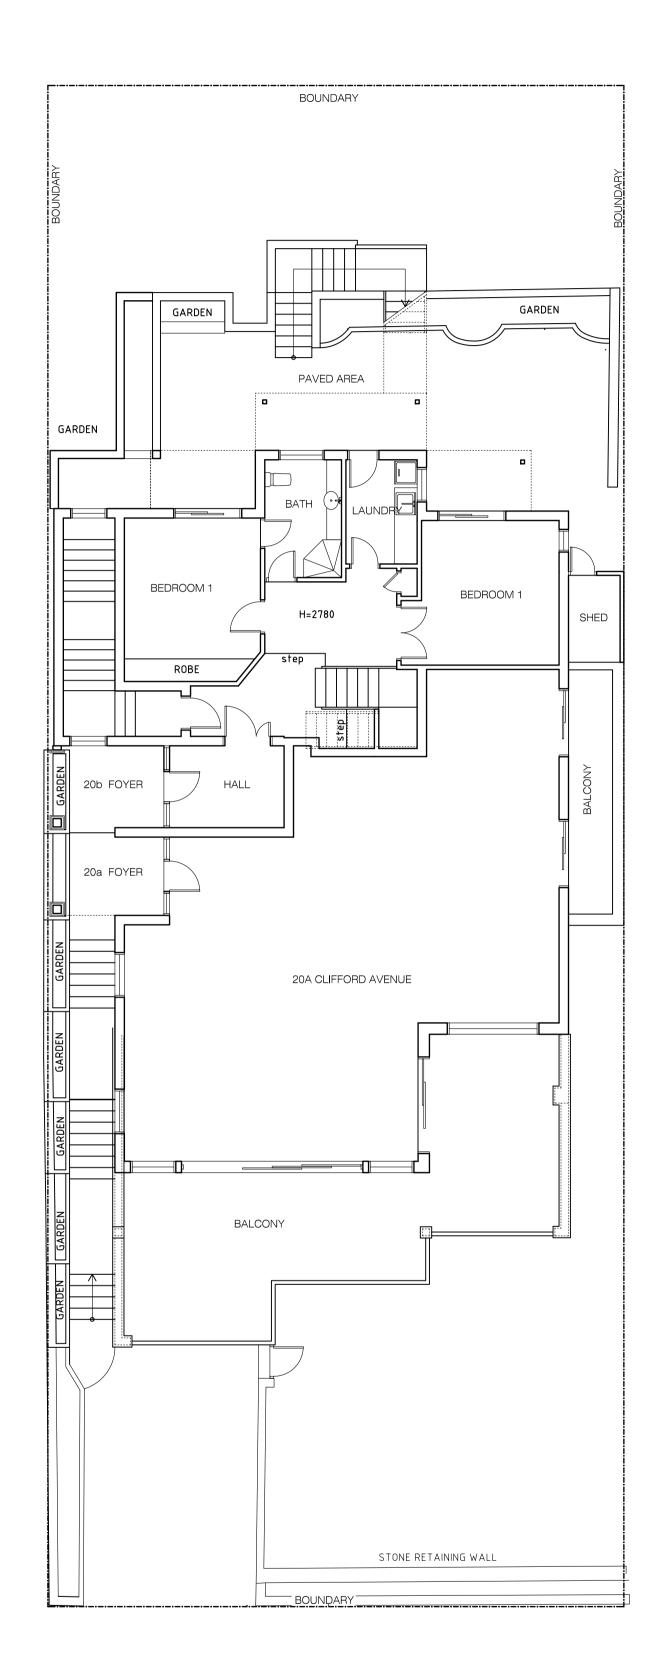
1. BUILDER TO CHECK AND CONFIRM ALL NECESSARY DIMENSIONS ON SITE PRIOR TO CONSTRUCTION . DO NOT SCALE THE DRAWING. 2. ALL DIMENSIONS THAT RELATE TO SITE BOUNDARIES, SETBACKS AND EASEMENTS ARE SUBJECT TO VERIFICATION BY A SITE SURVEY. 3. ALL WORK TO BE IN ACCORDANCE WITH BUILDING CODE oF AUSTRALIA & TO THE SATISFACTION OF LOCAL COUNCIL REQUIREMENTS. PROJECT ADDRESS: 2-20 Clifford Ave. 4. ALL TIMBER CONSTRUCTION TO BE IN ACCORDANCE TO TIMBER FRAMING CODE. Fairlight 5. ROOF WATER & SUB SOIL DRAINAGE TO BE DISPOSED OF IN THE APPROVED MANNER OR AS A DIRECTED BY LOCAL COUNCIL. ROOF WATER & SOB SOIL DRAINAGE TO BE DISPOSED OF IN THE APPROVED MANNER OR AS A DIRECTED BY LOCAL COUNCIL 6. ALL ELECTRICAL POWER & LIGHT OUTLETS TO BE DETERMINED BY OWNER.
 MAKE GOOD AND REPAIR ALL EXISTING FINISHES DAMAGED BY NEW WORK. REUSE EXISTING MATERIAL WHERE POSSIBLE.
 ALL NEW DOWN PIPES ARE TO BE CONNECTED TO THE EXISTING STORM WATER SYSTEM.
 COPYRIGHT OF ALL PLANS BELONGS TO 'HIGH DESIGN' – Architectural Design CLIENT:

SHAD	DOW DIAGRAM – JUNE 21			
TIME	AZIMUTH	ALTITUDE		
		-		
9 am	43° NE	18° 32°		
12 noon	0° N			
3 pm	43° NW	18°		

	Jan, 2022 DRAWN BY: B. V.	CHECKED	DESIGN	- ABN 51 476 054 183 and drafting service fax : 9981 55 56
	DRAWING No.	ISSUE		
	1-4 978 21	20.01.22	HGF	 hdesign. com. au esign.com.au

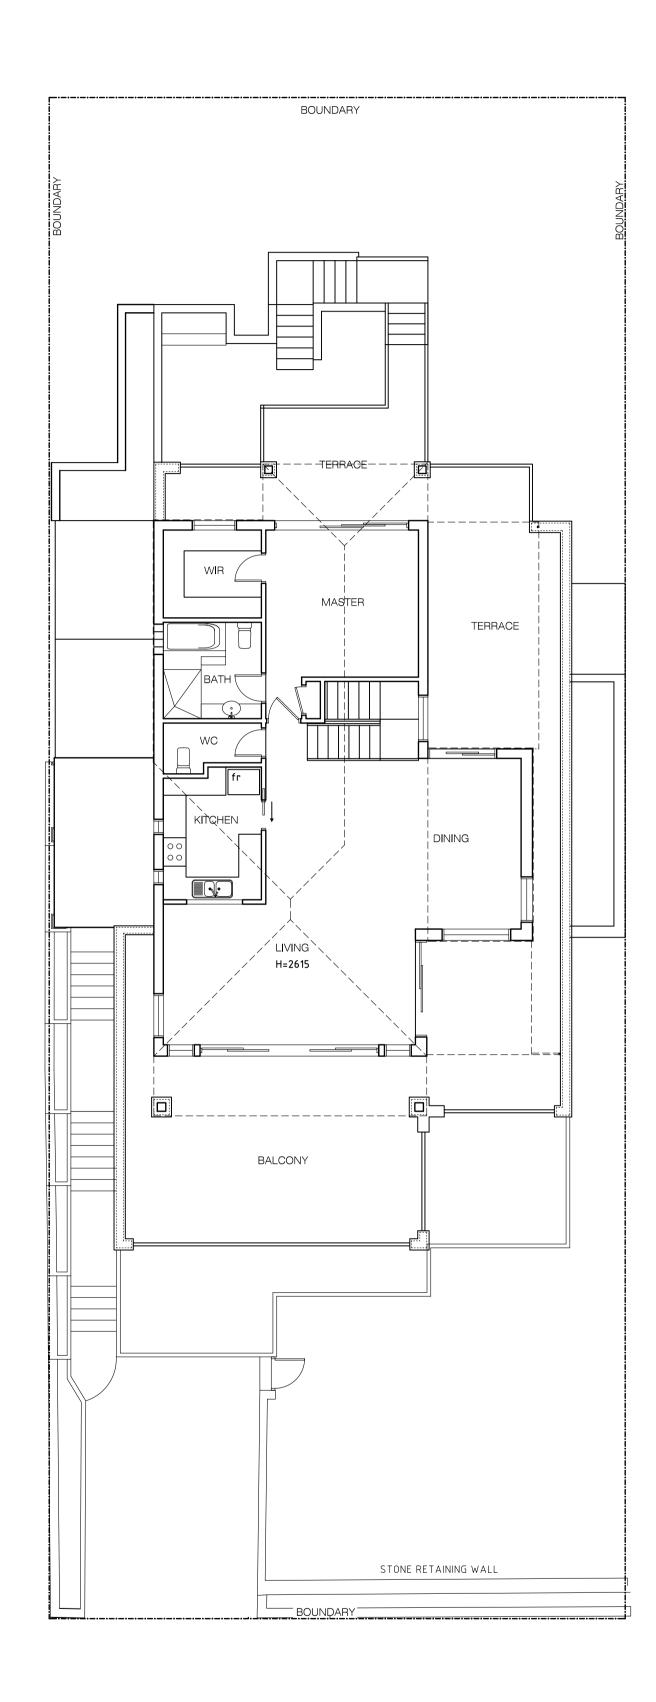
EXISTING LOWER GROUND FLOOR PLAN SCALE 1:100





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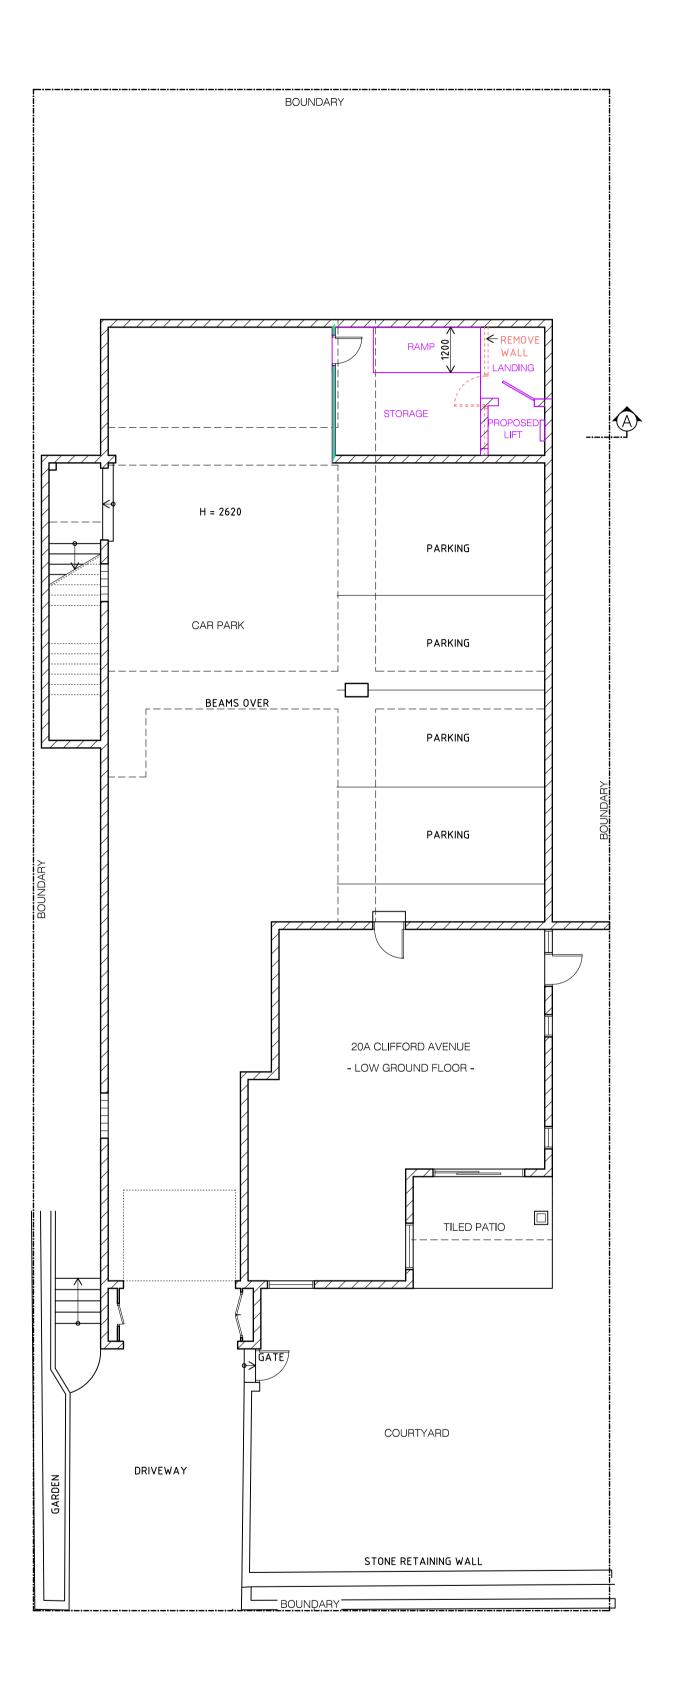


EXISTING UPPER GROUND FLOOR PLAN SCALE 1:100

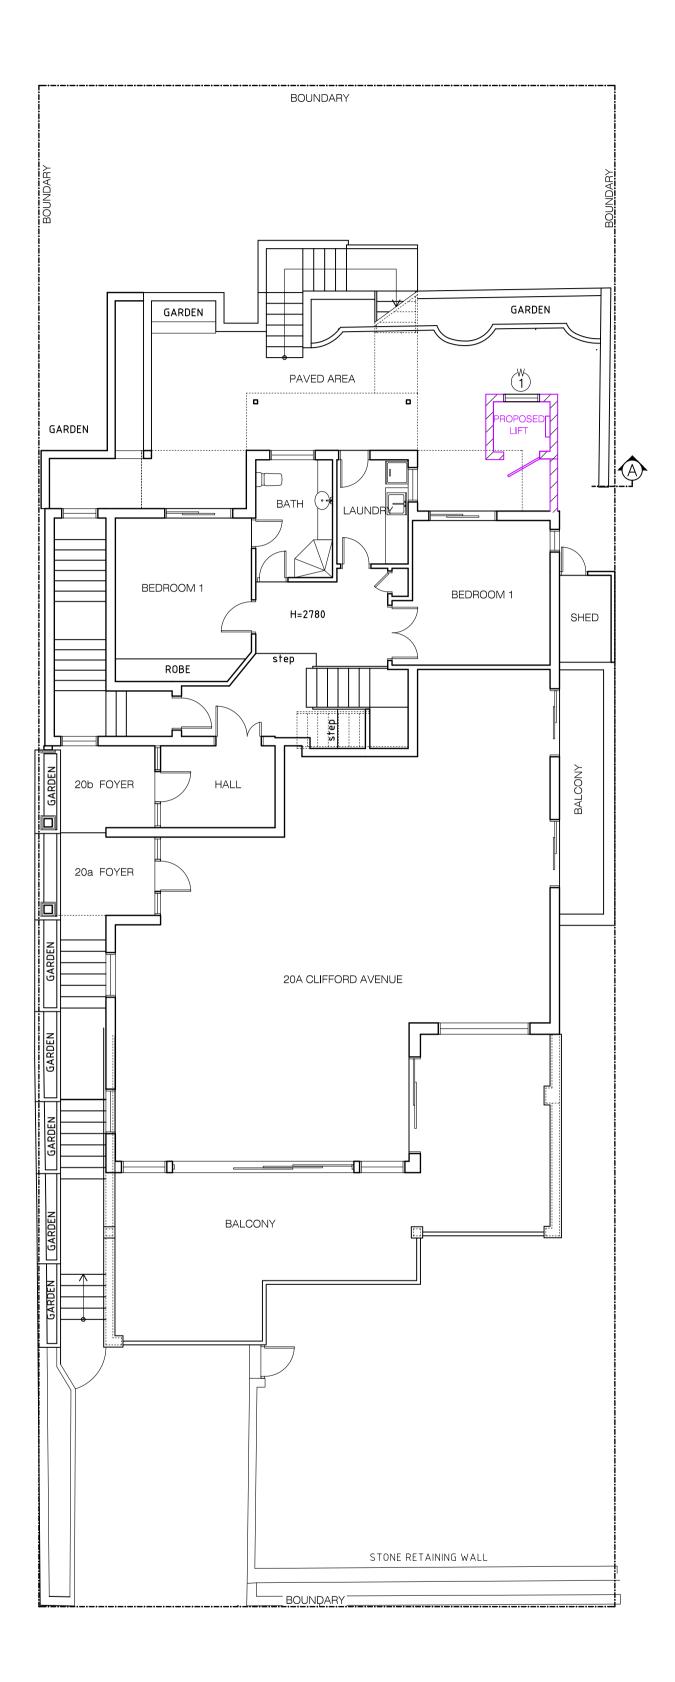
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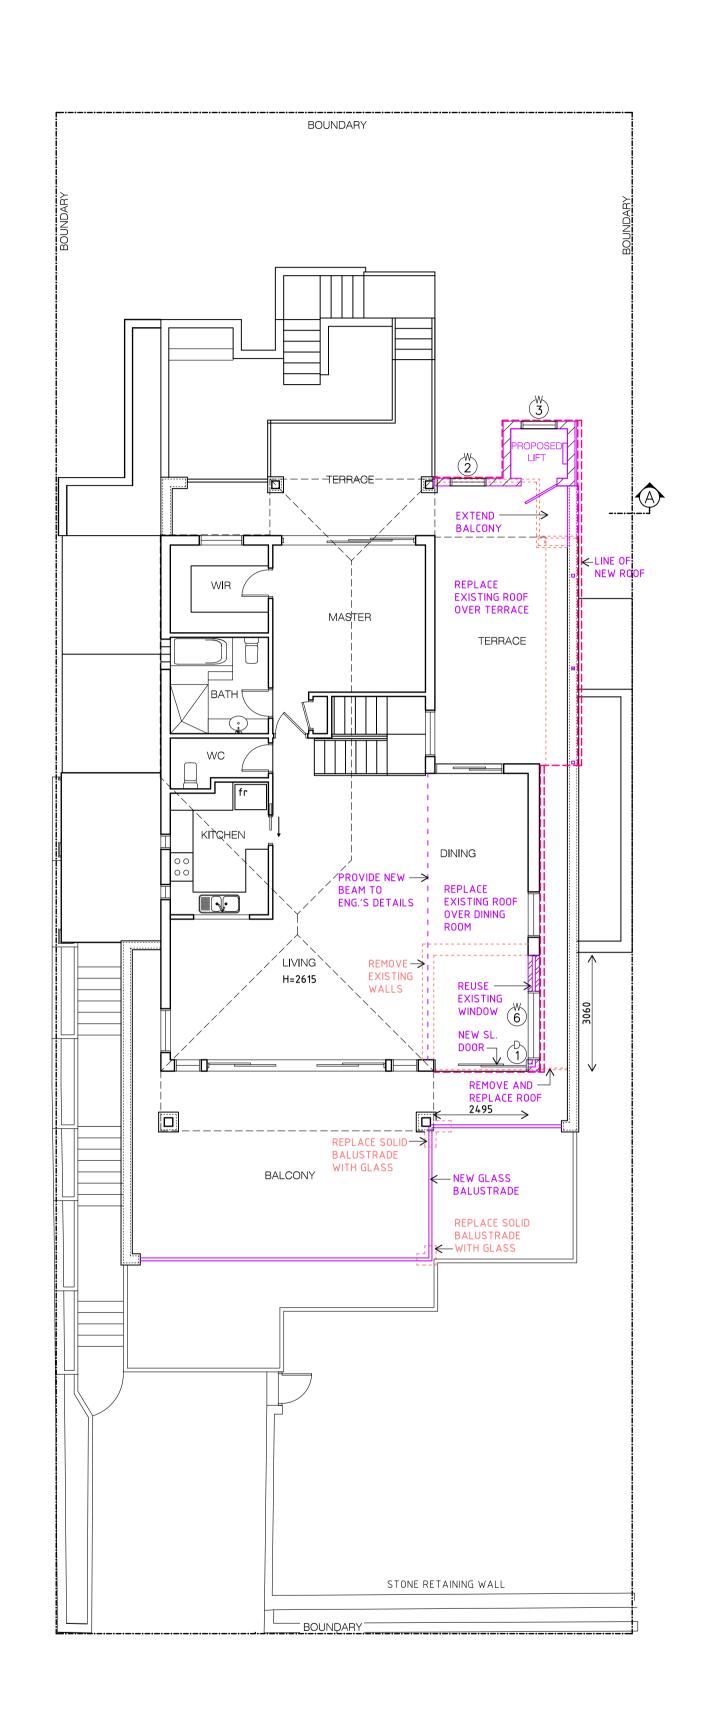
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EXISTING FIRST FLOOR PLAN



PROPOSED LOWER GROUND FLOOR PLAN SCALE 1:100





PROPOSED UPPER GROUND FLOOR PLAN SCALE 1:100

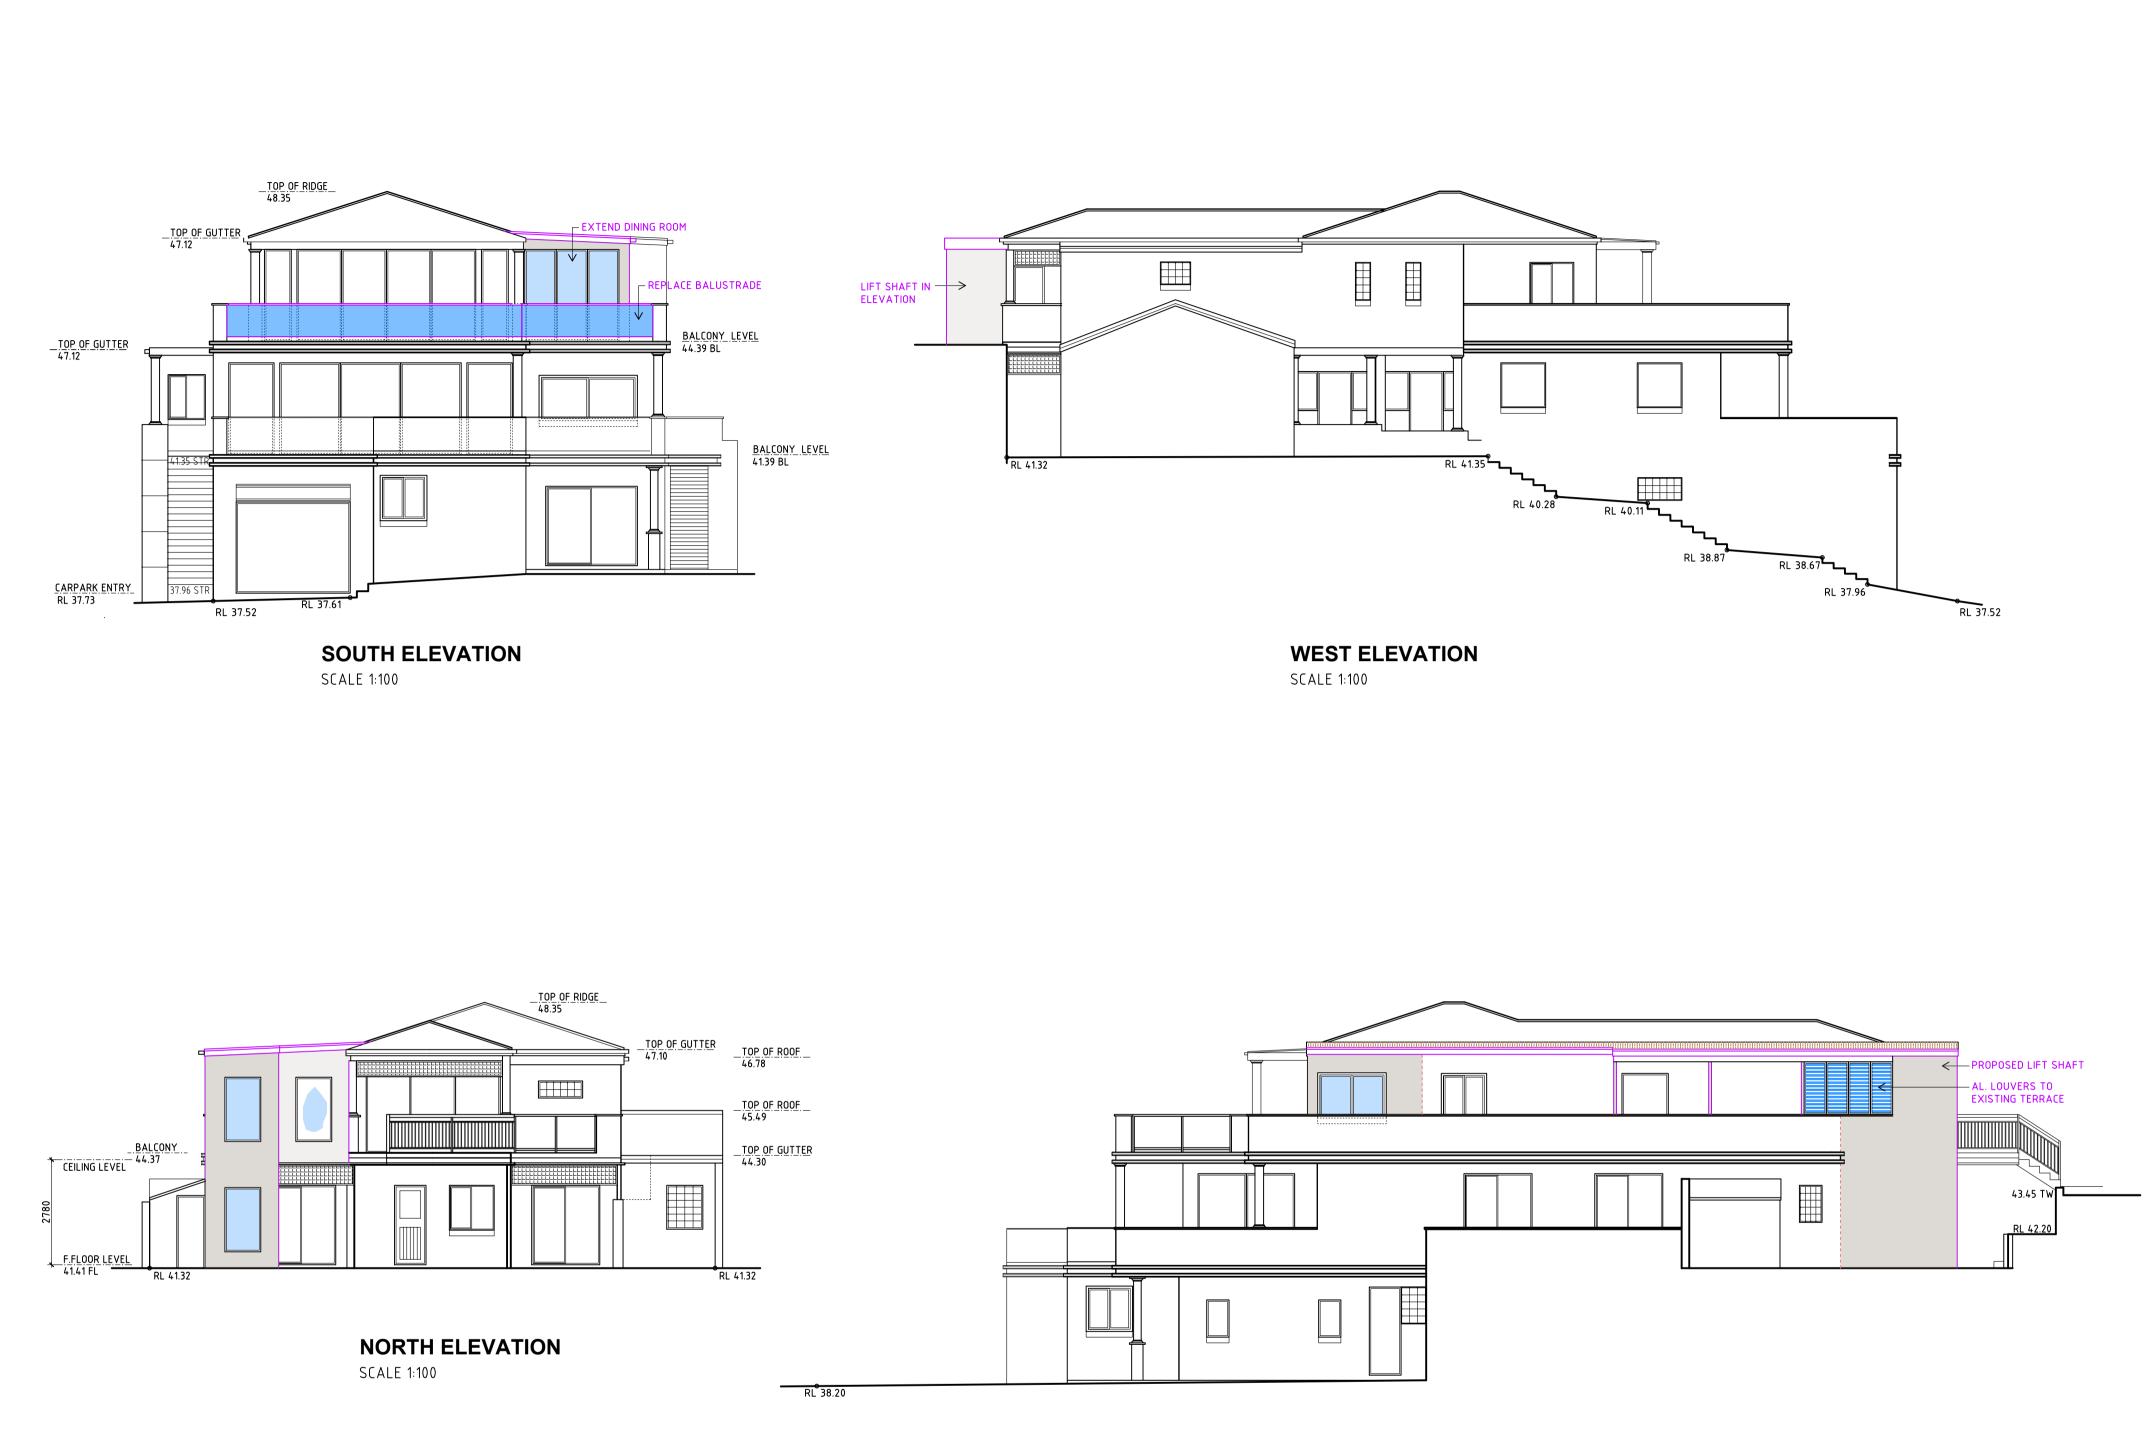
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PROPOSED FIRST FLOOR PLAN

SCALE 1:100

site area 613 sqm existing floor area 324 sqm or 53 % proposed floor area 9 sqm or 1.5 % total floor area 333 sqm or 54.5 %

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