

STORMWATER ROOF PLAN

KEY

DOWN PIPE (SPREADER)

--- DOWN PIPE 90mm

FIRST FLUSH DIVERTER

100mm DIA STORM WATER PIPE TO STORAGE TANK

90mm DIA STORM WATER

DISCARD PIPE TO SERVICE PIT STORMWATER PIPE

60mm DIA BLEED PIPE

---- EXISTING STORMWATER PIPE

GALVANISED STEEL RHS PIPE TO KERB

DRAINAGE GRATE

GRATED PIT 150mm

RW/T ---- RAIN WATERTANK

- N DOUBT ASK

STORMWATER MANAGEMENT PLAN

Scale 1:200

HYDRAULIC NOTES

THE CONTRACTOR SHALL GIVE NOTICE TO COUNCIL'S ENGINEER IN ACCORDANCE WITH COUNCIL'S SPECIFICATIONS WHEN INSPECTIONS ARE

WHERE DEPTH OF STORMWATER DRAINAGE PITS EXCEEDS 1.2m, HOT DIPPED

GALVANISED STEEL STEP IRONS SHALL BE PROVIDED.
ALL PITS SHALL BE PRECAST CONCRETE WITH GRATE OR APPROVED EQUIVALENT UNLESS NOTED OTHERWISE.

STORMWATER CONNECTION TO COUNCIL'S DRAINAGE SYSTEM SHALL BE DONE UNDER THE SUPERVISION OF COUNCIL'S ENGINEER.

ALL STORMWATER PIPES BELOW AND INCLUDING 2250 SHALL BE UPVC OR APPROVED EQUIV. UNLESS NOTED OTHERWISE.

ALL PIPES ABOVE 2250 SHALL BE REINFORCED CONCRETE WITH RUBBER RING JOINTS UNLESS NOTED OTHERWISE.

RING JOINTS UNLESS NOTED OTHERWISE.

7. MINIMUM PIPE COVER TO BE 700mm UNLESS NOTED OTHERWISE.

8. ALL PIPES TO BE LAID AND COVERED WITH SAND TO A MINIMUM DEPTH EQUAL TO THE PIPE DIAMETER, BUT NOT LESS THAN 300mm.

9. IN SANDY SOILS THE EXCAVATED SOIL MAY BE REUSED.

10. ALL 1000 SUBSOIL DRAINAGE TO BE PLACED A MINIMUM OF 650mm BELOW EDINGLED SUBSOIL PROVINCES AND COVERED MATERIA. FINISHED SURFACE LEVELS AND COVERED WITH A MINIMUM OF 500mm GRAVEL.

12. PIPE BEDDING SUPPORT SHALL BE H1 UNLESS NOTED OTHERWISE.
13. STORMWATER GRATES AND MANHOLE CLASSES SHALL BE IN ACCORDANCE

14. WITH AS3996

15. WHERE PIPE GRADES ARE NOT SHOWN ON DRAWINGS, MINIMUM PIPE GRADES SHALL BE 1% UNO.

16. PIPE GRADES INDICATED ON DRAWINGS ARE MINIMUM GRADES. IF MINIMUM.

GRADES CANNOT BE ACHIEVED CONTACT

17. THE DESIGN ENGINEER PRIOR TO PLACEMENT

RAINWATER TANK NOTES

1. ALL WORK TO BE CARRIED OUT IN ACCORDANCE WITH AS. 3500.3.2. 2.THIS PLAN TO BE READ IN CONJUNCTION WITH THE BASIX CERTIFICATE NUMBER LISTED IN BASIX/NATHERS NOTES.

3.A TOTAL RAINWATER TANK STORAGE CAPACITY OF 2,000 LITRES IS PROVIDED VIA ONE SLIMLINE TANK CONSISTING OF AN APPROX SIZE 685mm WIDE X 2,060mm L X 1,905mm H WATER TANK CONNECTED TO THE FOLLOWING:

 ALL TOILETS IN THE DEVELOPEMNT.
 THE COLD WATER TAP THAT SUPPLIES EACH CLOTHES WASHER IN THE DEVELOPMENT. - AT LEAST ONE OUTDOOR TAP IN THE DEVELOPMENT (NOTED: NSW HEALTH DOES NOT

RECOMMEND THAT RAINWATER BE USED FOR HUMAN CONSUMPTION.)
4. ALL PIPE AND DOWN PIPES TO BE PRESUSSURE GRADE PIPES TO 500mm ABOVE MAXIMUM WATER LEVEL OF RAIN WATERTANKS.

GUTTER NOTES

- 1. ALL GUTTERS TO HAVE A MINIMUM CROSS SECTION AS OUTLINED IN TABLE 1.
- 2. ALL GUTTER GRADIENTS TO BE NOT LESS THAN 1:500
- 3. TOP OF FASCIA TO BE A MINIMUM OF 15mm ABOVE GUTTER SLOTTED OVERFLOW

4. DOWNPIPE SIZES TO BE IN ACCORDANCE WITH TABLE 1.

CATCHMENT AREAS FOR INDIVIDUAL DOWNPIPES AND GUTTERS GUTTER mm2 **PLAN VIEW** AREA INC DOWNPIPE | AVERAGE RECURRENCE (CROSS AREA m2 SLOPE **INTERVAL 1 IN 20 YEAR** SECTION) 30.4 28.6 7700 90mm 200mm/hr 30.4 В 28.6 7700 90mm 200mm/hr 23.3 7700 21.9 200mm/hr 90mm D 22.5 27.5 7700 90mm 200mm/hr 23.1 24.6 7700 200mm/hr F 90mm F 23.1 27.5 7700 90mm 200mm/hr G 24.8 23.3 7700 90mm 200mm/hr Н 26 27.7 7700 90mm 200mm/hr 22.8 24.3 7700 90mm 200mm/hr 31.4 33.4 7700 90mm 200mm/hr

PRELIMINARY ONLY NOT FOR CONSTRUCTION ISSUED FOR D.A.



OFFICE - 39 GAVENLOCK ROAD TUGGERAH 2259 P.O. BOX 5240 CHITTAWAY BAY N.S.W. 2261 Tel: (02) 4352 1189 Fax: (02) 4352 1198 Builders Lic. 158741C ABN 65 687 862 151

(C) This drawing and design remains the property of CLASSIC COUNTRY COTTAGES and may not be copied in whole or in part without prior approval of CLASSIC COUNTRY COTTAGES


PROPOSED NEW DWELLING 19 CORKERY CRESCENT **ALLAMBIE HEIGHTS**


FOR

T. MANION & S. DAVIS

DATE MAR. 2023 SCALE 1:200

JOB No.

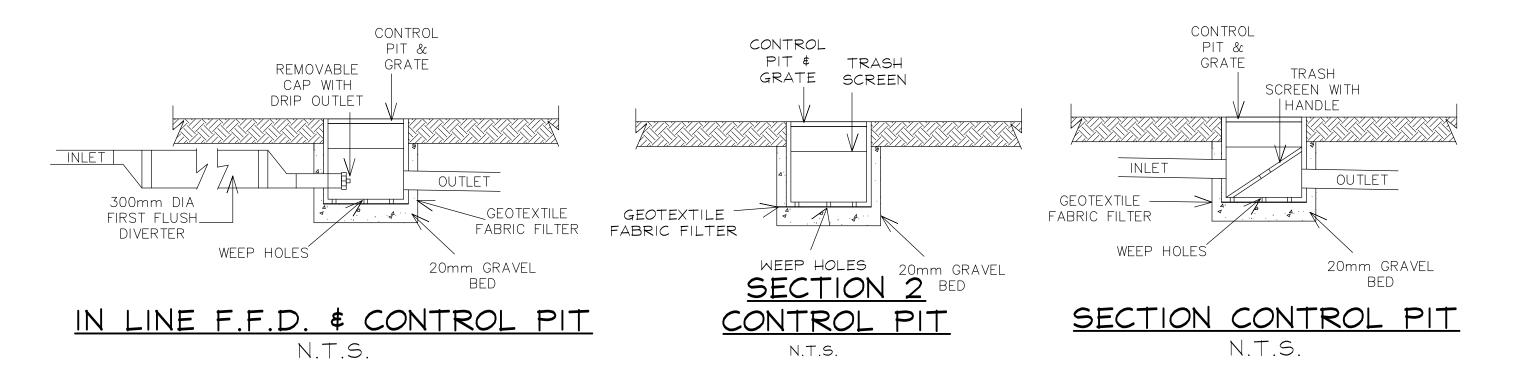

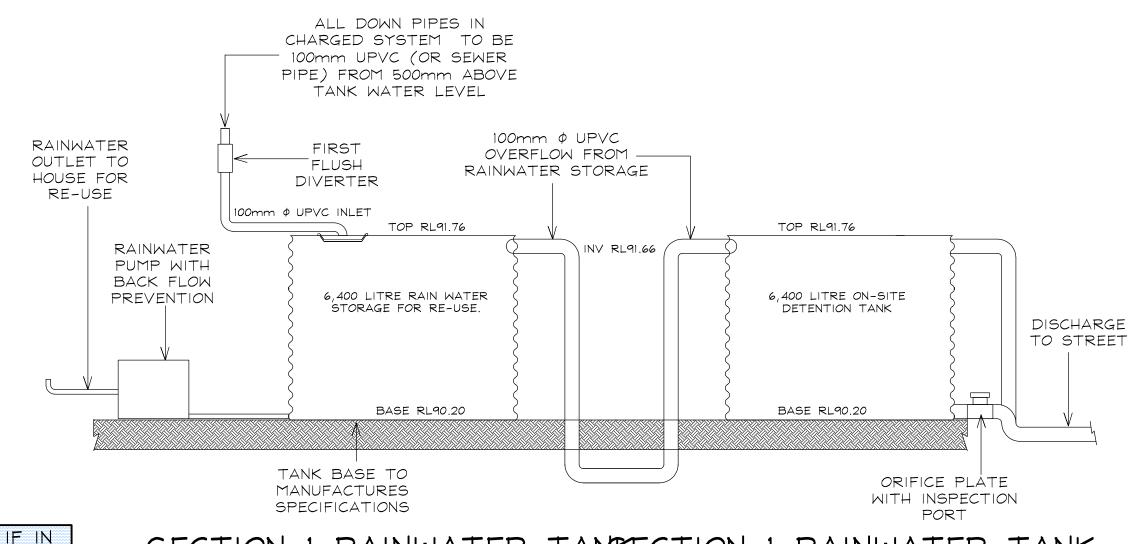

SECTION 1 RAINWATER TANKECTION 1 RAINWATER TANK

N.T.S

PRELIMINARY ONLY
NOT FOR
CONSTRUCTION
ISSUED FOR D.A.



OFFICE - 39 GAVENLOCK ROAD TUGGERAH 2259
P.O. BOX 5240 CHITTAWAY BAY N.S.W. 2261
Tel: (02) 4352 1189 Fax: (02) 4352 1198
Builders Lic. 158741C ABN 65 687 862 151

© This drawing and design remains the property of CLASSIC COUNTRY COTTAGES and may not be copied in whole or in part without prior approval of CLASSIC COUNTRY COTTAGES

PROJECT

PROPOSED NEW DWELLING 19 CORKERY CRESCENT ALLAMBIE HEIGHTS

FOR

T. MANION & S. DAVIS

DATE MAR. 2023 SCALE 1:200

JOB No.

DWG. No.

0

REV

N.T.S

DOUBT

ASK