


5 / 45-55 Epsom Road Rosebery NSW 2018

02 8662 9300 Ρ info@core.engineering core.engineering


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ABN 34 620 484 602

ELECTRICAL • FIRE • HYDRAULIC • MECHANICAL • STRUCTURAL• CIVIL • FACADES

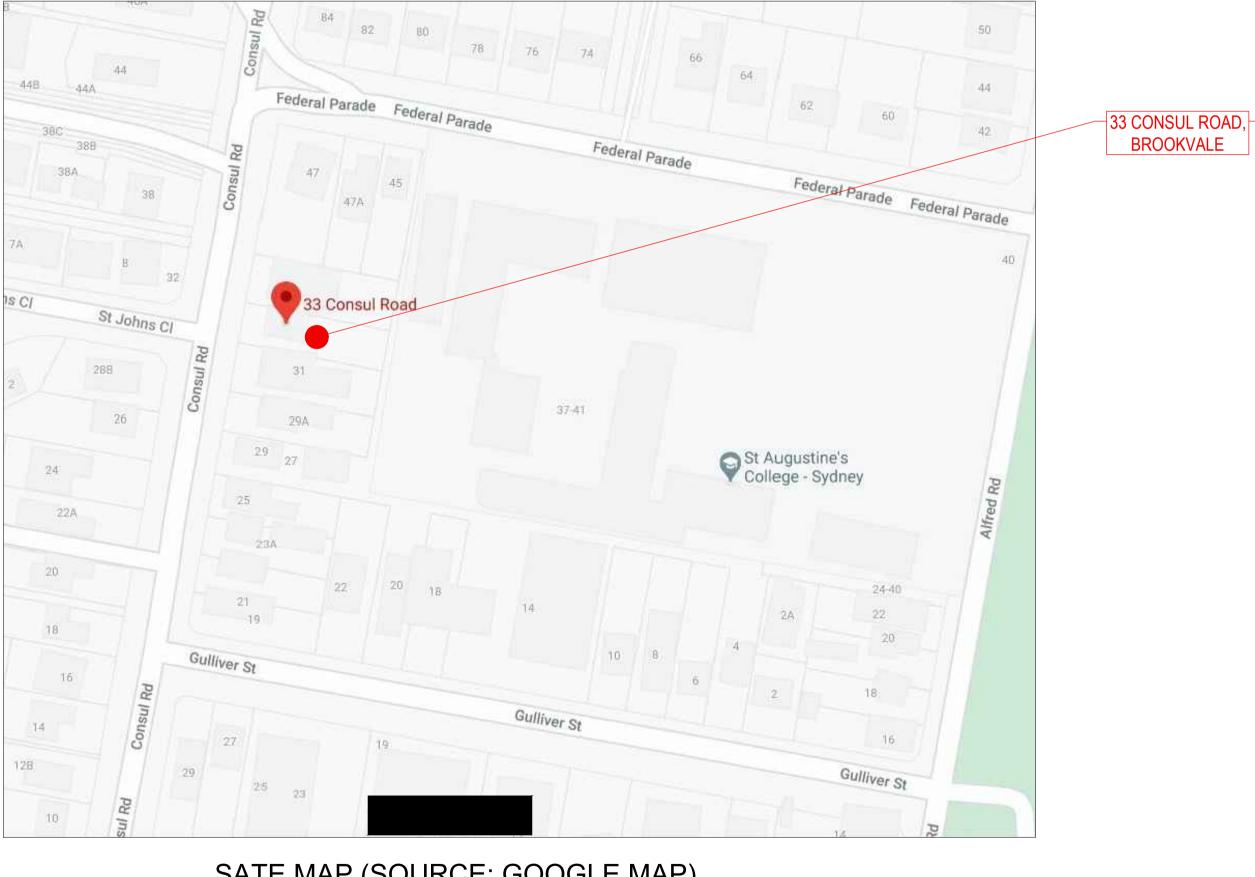

SATE MAP (SOURCE: GOOGLE MAP)

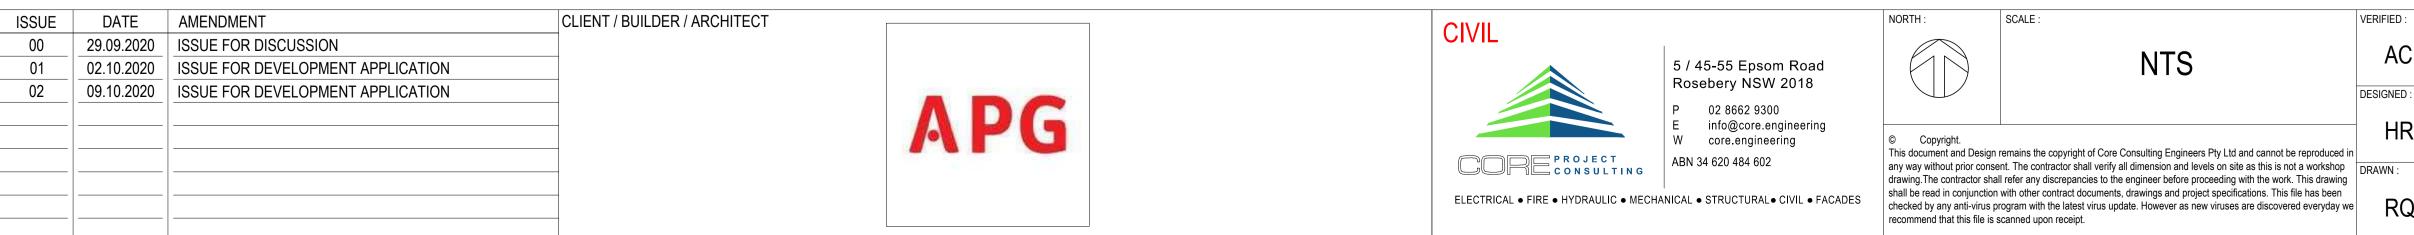

PROJECT ADDRESS: PROPOSED CARPARK A7. 33 CONSUL ROAD, BROOKVALE

DRAWING INDEX & COVER SHEET: CIVIL

PROJECT No.	DWG No.	DWG TITLES	REVISION
2290	C000	COVER SHEET & DRAWING INDEX	02
	C001	GENERAL NOTES	02
	C002	DIAL B4 YOU DIG INVESTIGATION	02
	C003	WASTE MANAGEMENT PLAN	02
	C100	SEDIMENTATION & EROSION CONTROL PLAN	02
	C101	AREA ANALYSIS & SEC DETAILS	02
	C102	STANDARD DETAILS LAYBACK & CARPARK	02
	C200	CONCEPT STORMWATER MANAGEMENT PLAN	02
	C201	OSD & SILT ARRESTOR & MISC DETAILS	02
	C202	MISC DETAILS	02
	C300	LANDSCAPE PLAN	02
	C301	PROPOSED PLANTS	02



SITE LAYOUT (SOURCE: SIX MAPS)

Plotted by: Ammar Khalid

ISSUE FOR DA DRAWING TITLE : DATE : SCALE : 12/09/2020 N.T.S AC **COVER SHEET & DRAWING INDEX** PROJECT No : **REVISION** : 2290 02 HR PROJECT : PROPOSED CARPARK A7. DRAWING No : 33 CONSUL ROAD, BROOKVALE C000 RQ

EXISTING UNDERGROUND SERVICES NOTES

THE LOCATIONS OF UNDERGROUND SERVICES SHOWN IN THIS SET OF DRAWINGS HAVE BEEN PLOTTED FROM SURVEY INFORMATION AND SERVICE AUTHORITY INFORMATION. THE SERVICE INFORMATION HAS BEEN PREPARED ONLY TO SHOW THE APPROXIMATE POSITIONS OF ANY KNOWN SERVICES AND MAY NOT BE AS CONSTRUCTED OR ACCURATE.CARDNO CAN NOT GUARANTEE THAT THE SERVICES INFORMATION SHOWN ON THESE DRAWINGS ACCURATELY INDICATES THE PRESENCE OR ABSENCE OF SERVICES OR THEIR LOCATION AND WILL ACCEPT NO LIABILITY FOR INACCURACIES IN THE SERVICES INFORMATION SHOWN FROM ANY CAUSE WHATSOEVER.

CONTRACTORS SHALL TAKE DUE CARE WHEN EXCAVATING ONSITE INCLUDING HAND EXCAVATION WHERE NECESSARY. CONTRACTORS ARE TO CONTACT THE RELEVANT SERVICE AUTHORITY PRIOR TO COMMENCEMENT OF EXCAVATION WORKS. CONTRACTORS ARE TO UNDERTAKE A SERVICES SEARCH, PRIOR TO COMMENCEMENT OF WORKS ON SITE. SEARCH RESULTS ARE TO BE KEPT ON SITE AT ALL TIMES.

COMMUNICATIONS - DUTY OF CARE NOTE

COMMUNICATIONS AND DATA PROVIDER PLANS SHOW ONLY THE PRESENCE OF CABLES AND PLANT. THEY ONLY SHOW THEIR POSITION RELATIVE TO ROAD BOUNDARIES. PROPERTY FENCES ETC. AT THE TIME OF INSTALLATION AND EACH PROVIDER DOES NOT WARRANT OR HOLD OUT THAT SUCH PLANS ARE ACCURATE THEREAFTER DUE TO CHANGES THAT MAY OCCUR OVER TIME. DO NOT ASSUME DEPTH OR ALIGNMENT OF CABLES OR PLANT AS THESE VARY SIGNIFICANTLY. THE CONTRACTOR HAS A DUTY OF CARE WHEN EXCAVATING NEAR COMMUNICATIONS AND DATA CABLES AND PLANT.

BEFORE USING MACHINE EXCAVATORS COMMUNICATIONS PLANT MUST FIRST BE PHYSICALLY EXPOSED BY SOFT DIG POTHOLING TO IDENTIFY IT'S LOCATION, PROVIDERS WILL SEEK COMPENSATION FOR DAMAGES CAUSED TO IT'S PROPERTY AND LOSSES CAUSED TO THE PROVIDERS AND IT'S CUSTOMERS.

TELSTRA - DUTY OF CARE NOTE

TELSTRA'S PLANS SHOW ONLY THE PRESENCE OF CABLES AND PLANT. THEY ONLY SHOW THEIR POSITION RELATIVE TO ROAD BOUNDARIES, PROPERTY FENCES ETC. AT THE TIME OF INSTALLATION AND TELSTRA DOES NOT WARRANT OR HOLD OUT THAT SUCH PLANS ARE ACCURATE THEREAFTER DUE TO CHANGES THAT MAY OCCUR OVER TIME. DO NOT ASSUME DEPTH OR ALIGNMENT OF CABLES OR PLANT AS THESE VARY SIGNIFICANTLY. THE CONTRACTOR HAS A DUTY OF CARE WHEN EXCAVATING NEAR TELSTRA CABLES AND PLANT. BEFORE USING MACHINE EXCAVATORS TELSTRA PLANT MUST FIRST BE PHYSICALLY EXPOSED BY SOFT DIG POTHOLING TO IDENTIFY IT'S LOCATION TELSTRA WILL SEEK COMPENSATION FOR DAMAGES CAUSED TO IT'S PROPERTY AND LOSSES CAUSED TO TELSTRA AND IT'S CUSTOMERS.

BULK EARTHWORKS NOTES

- STRIP ALL TOPSOIL/ORGANIC MATERIAL FROM CONSTRUCTION AREA AND REMOVE FROM SITE OR STOCK PILE AS DIRECTED BY SUPERINTENDENT.
- EXCAVATED MATERIAL TO BE USED AS STRUCTURAL FILL PROVIDED THE PLACEMENT MOISTURE CONTENT OF THE MATERIAL IS +/- 2% OF THE OPTIMUM MOISTURE CONTENT.

COMPACT FILL AREAS AND SUBGRADE TO NOT LESS THAN: LOCATION STANDARD DRY DENSITY (AS 1289 E 5.1.1.) UNDER BUILDING SLABS ON GROUND 98% UNDER ROADS AND CARPARKS 98% LANDSCAPED AREAS UNLESS NOTED OTHERWISE 98%

- 4. FOR NON COHESIVE MATERIAL, COMPACT TO 75% DENSITY INDEX.
- BEFORE PLACING FILL, PROOF ROLL EXPOSED SUBGRADE WITH AN 8 TONNE (MIN) DEADWEIGHT SMOOTH DRUM VIBRATORY ROLLER TO DETECT THEN REMOVE SOFT SPOTS (AREAS WITH MORE THAN 2mm MOVEMENT UNDER ROLLER).
- FREQUENCY OF COMPACTION TESTING SHALL BE NOT LESS THAN :-(A) 1 TEST PER 200m³ OF FILL PLACED PER 300 LAYER OF FILL. (B) 3 TESTS PER VISIT

(C) 1 TEST PER 1000m² OF EXPOSED SUBGRADE "LEVEL 1" TESTING SHALL BE TESTING IN ACCORDANCE WITH AS 3798 (1996).

- FILLING TO BE PLACED IN MAXIMUM 150mm LOOSE LAYERS AND COMPACTED AS SPECIFIED
- 8 NO FILLING SHALL TAKE PLACE TO EXPOSED SUBGRADE UNTIL THE AREA HAS BEEN PROOF ROLLED IN THE PRESENCE OF CARDNO AND APPROVAL GIVEN IN WRITING THAT FILLING CAN PROCEED.

EROSION AND SEDIMENT CONTROL NOTES

GENERAL INSTRUCTIONS

- REPRESENT THE MINIMUM REQUIREMENT ONLY.
- DIRECTED BY THE SUPERINTENDENT. a. LOCAL AUTHORITY REQUIREMENTS b. EPA REQUIREMENTS
- 3. MAINTAIN THE EROSION CONTROL DEVICES TO THE SATISFACTION OF THE SUPERINTENDENT AND THE LOCAL AUTHORITY. 4. WHEN STORMWATER PITS ARE CONSTRUCTED, PREVENT SITE RUNOFF ENTERING UNLESS SEDIMENT FENCES ARE ERECTED AROUND PITS.
- LAND DISTURBANCE
- UNDERTAKEN IN THE FOLLOWING SEQUENCE: a. INSTALL A SEDIMENT FENCE ALONG THE BOUNDARIES AS SHOWN ON
- PLAN. REFER DETAIL.
- TRAPS AS SHOWN ON PLAN.

EROSION CONTROL

- CONTROL.
- ACTIVITIES.

SEDIMENT CONTROL

- FENCING.
- 10 WORKING DAYS FROM PLACEMENT.
- STRUCTURE.
- REHABILITATED.
- MATERIALS AND LITTER.

OTHER MATTERS

- INSTALLED OUTSIDE THE DRIP LINE b. ENSURING THAT NOTHING IS NAILED TO THEM
- STOCKPILES WITHIN THE DRIP LINE EXCEPT UNDER THE FOLLOWING CONDITIONS.
- GREATER
- FILL LAYERS OF MORE THAN 300 MILLIMETRES DEPTH
- THE SOIL AROUND THEM.

		AMENDMENT		
ISSUE	DATE	AMENDMENT	CLIENT / BUILDER / ARCHITECT	
00	29.09.2020	ISSUE FOR DISCUSSION		
01	02.10.2020	ISSUE FOR DEVELOPMENT APPLICATION		
02	09.10.2020	ISSUE FOR DEVELOPMENT APPLICATION		

THE CONTRACTOR SHALL BE SOLELY RESPONSIBLE FOR THE CONTROL OF EROSION AND SEDIMENTATION TO THE SATISFACTION OF COUNCIL, NSW OFFICE OF WATER, OFFICE OF ENVIRONMENT AND HERITAGE. THE EROSION AND SEDIMENTATION CONTROLS SHOWN ON THE DRAWINGS SHALL ONLY BE USED AS A GUIDE BY THE CONTRACTOR, AND SHALL

2. THE CONTRACTOR SHALL ENSURE THAT ALL SOIL AND WATER MANAGEMENT WORKS ARE LOCATED AS DOCUMENTED OR AS OTHERWISE

ALL WORK SHALL BE GENERALLY CARRIED OUT IN ACCORDANCE WITH

C. NSW DEPARTMENT OF HOUSING MANUAL "MANAGING URBAN STORMWATER, SOILS AND CONSTRUCTION", 4th EDITION, MARCH 2004.

5. CONTRACTOR IS TO ENSURE ALL EROSION & SEDIMENT CONTROL DEVICES ARE MAINTAINED IN GOOD WORKING ORDER AND OPERATE EFFECTIVELY. REPAIRS AND OR MAINTENANCE SHALL BE UNDERTAKEN AS REQUIRED, PARTICULARLY FOLLOWING STORM EVENTS.

6. WHERE PRACTICAL, THE SOIL EROSION HAZARD ON THE SITE WILL BE KEPT AS LOW AS POSSIBLE. TO THIS END, WORKS SHOULD BE

b. CONSTRUCT STABILISED CONSTRUCTION ENTRANCE TO LOCATION AS DETERMINED BY SUPERINTENDENT/ENGINEER. REFER DETAIL. c. INSTALL SEDIMENT BASIN AS SHOWN ON PLAN (D) INSTALL SEDIMENT

d. UNDERTAKE SITE DEVELOPMENT WORKS IN ACCORDANCE WITH THE ENGINEERING PLANS. WHERE POSSIBLE, PHASE DEVELOPMENT SO THAT LAND DISTURBANCE IS CONFINED TO AREAS OF WORKABLE SIZE.

7. DURING WINDY WEATHER, LARGE, UNPROTECTED AREAS WILL BE KEPT MOIST (NOT WET) BY SPRINKLING WITH WATER TO KEEP DUST UNDER

8. FINAL SITE LANDSCAPING WILL BE UNDERTAKEN AS SOON AS POSSIBLE AND WITHIN 20 WORKING DAYS FROM COMPLETION OF CONSTRUCTION

9. STOCKPILES WILL NOT BE LOCATED WITHIN 2 METRES OF HAZARD AREAS, INCLUDING LIKELY AREAS OF CONCENTRATED OR HIGH VELOCITY FLOWS SUCH AS WATERWAYS. WHERE THEY ARE BETWEEN 2 AND 5 METRES FROM SUCH AREAS, SPECIAL SEDIMENT CONTROL MEASURES SHOULD BE TAKEN TO MINIMISE POSSIBLE POLLUTION TO DOWNSLOPE WATERS, E.G. THROUGH INSTALLATION OF SEDIMENT

0. ANY SAND USED IN THE CONCRETE CURING PROCESS (SPREAD OVER THE SURFACE) WILL BE REMOVED AS SOON AS POSSIBLE AND WITHIN

11. WATER WILL BE PREVENTED FROM ENTERING THE PERMANENT DRAINAGE SYSTEM UNLESS IT IS RELATIVELY SEDIMENT FREE, I.E. THE CATCHMENT AREA HAS BEEN PERMANENTLY LANDSCAPED AND/OR ANY LIKELY SEDIMENT HAS BEEN FILTERED THROUGH AN APPROVED

12. TEMPORARY SOIL AND WATER MANAGEMENT STRUCTURES WILL BE REMOVED ONLY AFTER THE LANDS THEY ARE PROTECTING ARE

13. ACCEPTABLE RECEPTORS WILL BE PROVIDED FOR CONCRETE AND MORTAR SLURRIES. PAINTS, ACID WASHINGS, LIGHT-WEIGHT WASTE

14. ANY EXISTING TREES WHICH FORM PART OF THE FINAL LANDSCAPING PLAN WILL BE PROTECTED FROM CONSTRUCTION ACTIVITIES BY:

a. PROTECTING THEM WITH BARRIER FENCING OR SIMILAR MATERIALS

c. PROHIBITING PAVING, GRADING, SEDIMENT WASH OR PLACING OF

(I) ENCROACHMENT ONLY OCCURS ON ONE SIDE AND NO CLOSER TO THE TRUNK THAN EITHER 1.5 METRES OR HALF THE DISTANCE BETWEEN THE OUTER EDGE OF THE DRIP LINE AND THE TRUNK, WHICH EVER IS THE

(II) A DRAINAGE SYSTEM THAT ALLOWS AIR AND WATER TO CIRCULATE THROUGH THE ROOT ZONE (E.G. A GRAVEL BED) IS PLACED UNDER ALL (III) CARE IS TAKEN NOT TO CUT ROOTS UNNECESSARILY NOR TO COMPACT

STORMWATER DRAINAGE NOTES

STORMWATER DESIGN CRITERIA: (A) AVERAGE RECURRENCE INTERVAL:

- 100 YEAR ARI ROOFED AREAS TO SURCHARGE PIT 10 YEAR ARI PAVEMENTS (MINOR SYSTEM)
- 100 YEAR ARI OVERLAND FLOW PATHS (MAJOR SYSTEM)
- (B) RAINFALL INTENSITIES: TIME OF CONCENTRATION: **5 MINUTES** 100 YEAR ARI 193mm/hr
- 10 YEAR ARI 280mm/hr
- 2. PIPES 375 DIA. AND LARGER TO BE REINFORCED CONCRETE CLASS '2' APPROVED SPIGOT AND SOCKET WITH RUBBER RING JOINTS. U.N.O.
- 3. PIPES 300 DIA AND LESS SHALL BE DWV GRADE (CLASS SN8) uPVC WITH SOLVENT WELDED JOINTS.
- 4. ALL PIPES ARE TO BE UNIFORMLY SUPPORTED ALONG THE LENGTH OF THE BARREL BY SUITABLE FILL MATERIAL. REFER TO BEDDING SUPPORT TYPE.
- 5. PIPES WITH SOCKETS SHALL BE LAID IN BEDDING WHERE SUITABLE RECESSES HAVE BEEN PROVIDED TO ENSURE PIPES DO NOT BEAR ON THEIR SOCKETS.
- 6. ALL STORMWATER DRAINAGE LINES UNDER PROPOSED BUILDING SLABS TO BE UPVC PRESSURE PIPE GRADE 6. ENSURE ALL VERTICALS AND DOWNPIPES ARE uPVC PRESSURE PIPE, GRADE 6 FOR A MIN OF 3.0m IN HEIGHT.
- PIPES TO BE INSTALLED TO TYPE HS1 SUPPORT IN ACCORDANCE WITH AS 3725 (2007) IN ALL CASES BACKFILL TRENCH WITH SAND TO 300mm ABOVE PIPE. WHERE PIPE IS UNDER PAVEMENTS BACKFILL REMAINDER OF TRENCH TO UNDERSIDE OF PAVEMENT WITH SAND OR APPROVED GRANULAR MATERIAL COMPACTED IN 150mm LAYERS TO MINIMUM 98% STANDARD MAXIMUM DRY DENSITY IN ACCORDANCE WITH AS 1289 5.2.1. (OR A DENSITY INDEX OF NOT LESS THAN 75).
- 8. REFER TO AS/NRS 3725:2007 TABLE B1 FOR REQUIRED FILL DEPTHS ABOVE PIPE BARREL PRIOR TO USE OF COMPACTION MACHINERY OR TRAVERSING OF PIPES BY GENERAL SITE EQUIPMENT.
- 9. WHERE WORKING METHODS REQUIRE HIGHER CLASS PIPE, THE CONTRACTOR SHALL REFER TO AS 3725 (2007) TO DETERMINE THE APPROPRIATE PIPE CLASS. PROPOSED PIPE CLASS SHALL BE REVIEWED BY CORE PRIOR TO INSTALLATION.
- 10. ALL INTERNAL WORKS WITHIN PROPERTY BOUNDARIES ARE TO COMPLY WITH THE REQUIREMENTS OF AS 3500 3.1 (2003) AND AS/NZS 3500 3.2 (2003).
- 11. PRECAST PITS MAY BE USED EXTERNAL TO THE BUILDING SUBJECT TO APPROVAL BY CORE.
- 12. ENLARGERS, CONNECTIONS AND JUNCTIONS TO BE PREFABRICATED FITTINGS WHERE PIPES ARE LESS THAN 300 DIA.
- 13. WHERE SUBSOIL DRAINS PASS UNDER FLOOR SLABS AND VEHICULAR PAVEMENTS, UNSLOTTED uPVC SEWER GRADE PIPE IS TO BE USED.
- 14. CARE IS TO BE TAKEN WITH LEVELS OF STORMWATER LINES. GRADES SHOWN ARE NOT TO BE REDUCED WITHOUT APPROVAL.
- 15. GRATES AND COVERS SHALL CONFORM TO AS 3996.
- 16. ALL BOX CULVERTS SHALL BE STRUCTURALLY DESIGNED BY THE MANUFACTURER AND DELIVERED TO SITE AS FIT FOR PURPOSE.
- 17. AT ALL TIMES DURING CONSTRUCTION OF STORMWATER PITS, ADEQUATE SAFETY PROCEDURES SHALL BE TAKEN TO ENSURE AGAINST THE POSSIBILITY OF PERSONNEL FALLING DOWN PITS.
- 18. ALL EXISTING STORMWATER DRAINAGE LINES AND PITS THAT ARE TO REMAIN ARE TO BE INSPECTED AND CLEANED. DURING THIS PROCESS ANY PART OF THE STORMWATER DRAINAGE SYSTEM THAT WARRANTS REPAIR SHALL BE REPORTED TO THE SUPERINTENDENT/ENGINEER FOR FURTHER DIRECTIONS.

SITEWORKS NOTES

- . ORIGIN OF LEVELS:- REFER SURVEY DRAWING AND SETOUT PLAN.
- 2. CONTRACTOR MUST VERIFY ALL DIMENSIONS AND EXISTING LEVELS ON SITE PRIOR TO COMMENCEMENT OF WORK. ANY DISCREPANCIES TO BE REPORTED TO CORE.
- 3. MAKE SMOOTH CONNECTION WITH EXISTING WORKS.
- 4. ALL TRENCH BACKFILL MATERIAL SHALL BE COMPACTED TO THE SAME DENSITY AS THE ADJACENT MATERIAL.
- 5. ALL SERVICE TRENCHES UNDER VEHICULAR PAVEMENTS SHALL BE BACKFILLED WITH SAND TO 300mm ABOVE PIPE. WHERE PIPE IS UNDER PAVEMENTS BACKFILL REMAINDER OF TRENCH TO UNDERSIDE OF PAVEMENT WITH SAND OR APPROVED GRANULAR MATERIAL COMPACTED IN 150mm LAYERS TO MINIMUM 98% MODIFIED MAXIMUM DRY DENSITY IN ACCORDANCE WITH AS 1289 5.2.1. (OR A DENSITY INDEX OF NOT LESS THAN 75)
- 6. PROVIDE 10mm WIDE EXPANSION JOINTS BETWEEN BUILDINGS AND ALL CONCRETE OR UNIT PAVEMENTS.
- 7. ASPHALTIC CONCRETE SHALL CONFORM TO R.M.S. SPECIFICATION R116.
- 8. ALL BASECOURSE MATERIAL SHALL BE IGNEOUS ROCK QUARRIED MATERIAL TO COMPLY WITH R.M.S. FORM 3051, COMPACTED TO MINIMUM 98% MODIFIED DENSITY IN ACCORDANCE WITH AS 1289 5.2.1 FREQUENCY OF COMPACTION TESTING SHALL NOT BE LESS THAN 1 TEST PER 50m³ OF BASECOURSE MATERIAL PLACED.
- 9. ALL SUB-BASE COURSE MATERIAL SHALL BE IGNEOUS ROCK QUARRIED MATERIAL TO COMPLY WITH R.M.S. FORM 3051, AND COMPACTED TO MINIMUM 95% MODIFIED DENSITY IN ACCORDANCE WITH A.S 1289 5.2.1 FREQUENCY OF COMPACTION TESTING SHALL NOT BE LESS THAN 1 TEST PER 50m³ OF SUB-BASE COURSE MATERIAL PLACED.
- 10. AS AN ALTERNATIVE TO THE USE OF IGNEOUS ROCK AS A SUB-BASE MATERIAL IN (9) A CERTIFIED RECYCLED CONCRETE MATERIAL COMPLYING WITH R.M.S. FORM 3051 WILL BE CONSIDERED. SUBJECT TO MATERIAL SAMPLES AND APPROPRIATE CERTIFICATIONS BEING PROVIDED TO THE SATISFACTION OF CARDNO.
- 11. SHOULD THE CONTRACTOR WISH TO USE A RECYCLED PRODUCT THIS SHALL BE CLEARLY INDICATED IN THEIR TENDER AND THE PRICE DIFFERENCE BETWEEN AN IGNEOUS PRODUCT AND A RECYCLED PRODUCT SHALL BE CLEARLY INDICATED.
- 12. WHERE NOTED ON THE DRAWINGS THAT WORKS ARE TO BE CARRIED BY OTHERS. (eq. ADJUSTMENT OF SERVICES), THE CONTRACTOR SHALL BE RESPONSIBLE FOR THE CO-ORDINATION OF THESE WORKS.

CIVIL		NORTH :	SCALE :	VERIFIED :
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	P 02 8662 9300 E info@core.engineering			
W CORE PROJECT AB		any way without prior cons	n remains the copyright of Core Consulting Engineers Pty Ltd and cannot be reproduced in sent. The contractor shall verify all dimension and levels on site as this is not a workshop all refer any discrepancies to the engineer before proceeding with the work. This drawing	DRAWN :
ELECTRICAL • FIRE • HYDRAULIC • MECHA	∣ NICAL ● STRUCTURAL● CIVIL ● FACADES	shall be read in conjunctio	n with other contract documents, drawings and project specifications. This file has been program with the latest virus update. However as new viruses are discovered everyday we	RC

Plotted by: Ammar Khalid

DRAWING TITLE DATE : SCALE : 12/09/2020 N.T.S **GENERAL NOTES** PROJECT No : **REVISION** : 2290 02 PROJECT PROPOSED CARPARK A7. DRAWING No 33 CONSUL ROAD, BROOKVALE C001

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ISSUE FOR DA

LEGEND:



VERIZON BUSINESS

NOTE:

- * THIS PLAN IS SHOULD BE USED FOR INDICATIVE PURPOSES ONLY.
- * BEFORE WORKS ARE CARRIED OUT THE CONTRACTOR SHOULD CONTACT DIAL BEFORE YOU DIG TO OBTAIN AN UPDATED PLAN.
- * IF THE SERVICES ARE OBSERVED ON SITE AND NOT SEEN ON DIAL BEFORE YOU DIG PLANS. UNDERGROUND UTILITY MAPPING SHOULD BE DONE TO EXPLORE UNDERGROUND SERVICES.
- * THIS PLAN DOES NOT RELEASE ANY OTHER CONTRACTOR FROM HIS RESPONSIBILITIES. THIS PLAN SHOULD NOT BE CONSIDERED AS A DIAL BEFORE YOU DIG MAP.
- * THIS PLAN IS DRAWN ON THE BASIS OF AVAILABLE INFORMATION, INVESTIGATION REGARDING OTHER SERVICE SHALL BE DONE BY THE CONTRACTOR.


DIAL BEFORE YOU DIG REFERENCE DETAILS: JOB NO.: 1935313 USER REF NO .: NOT SUPPLIED WORKING ON BEHALF OF: PRIVATE ENQUIRY DATE: 04/09/2020

00 29.09.2020 ISSUE FOR DISCUSSION 01 02.10.2020 ISSUE FOR DEVELOPMENT APPLICATION

ISSUE DATE AMENDMENT

01



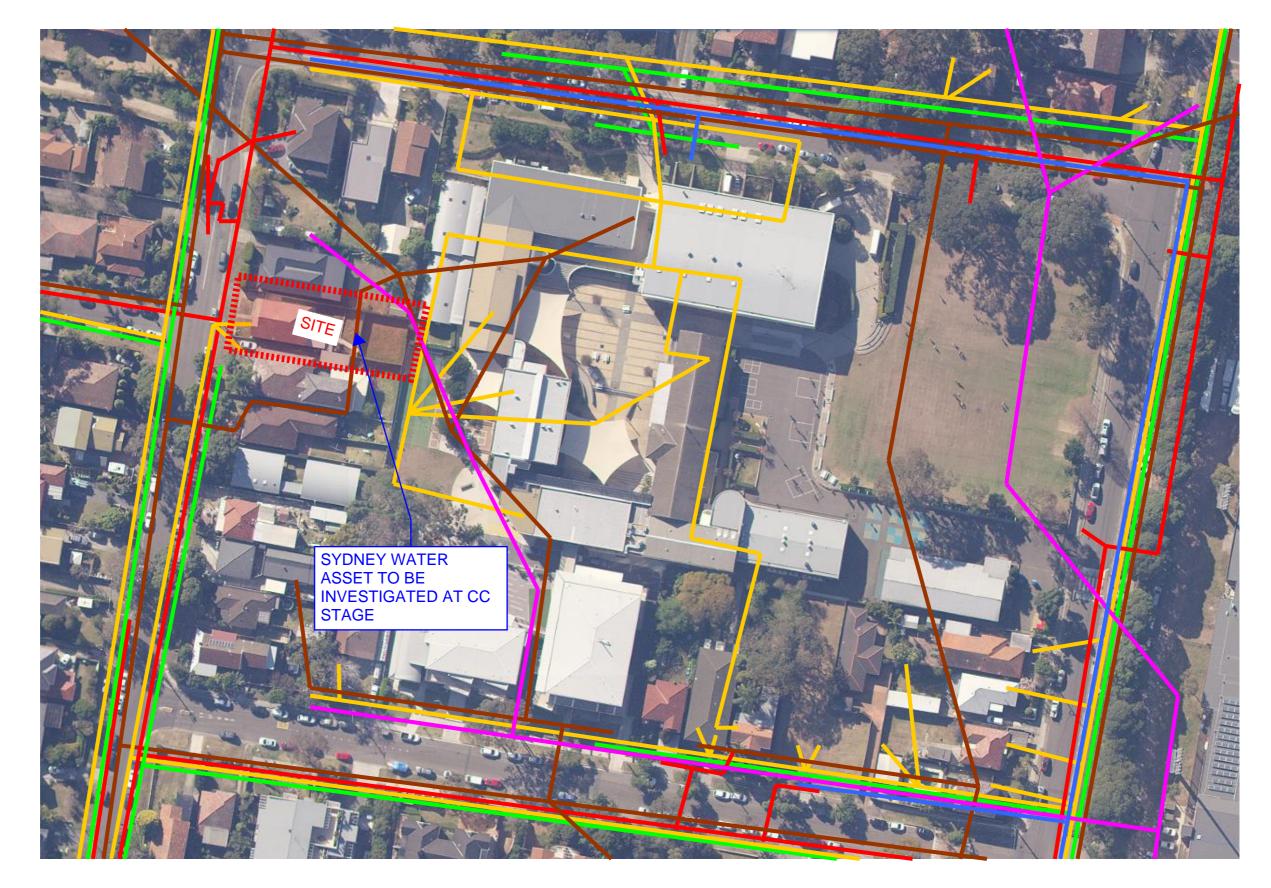

CLIENT / BUILDER / ARCHITECT

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ISSUE FOR DISCUSSION

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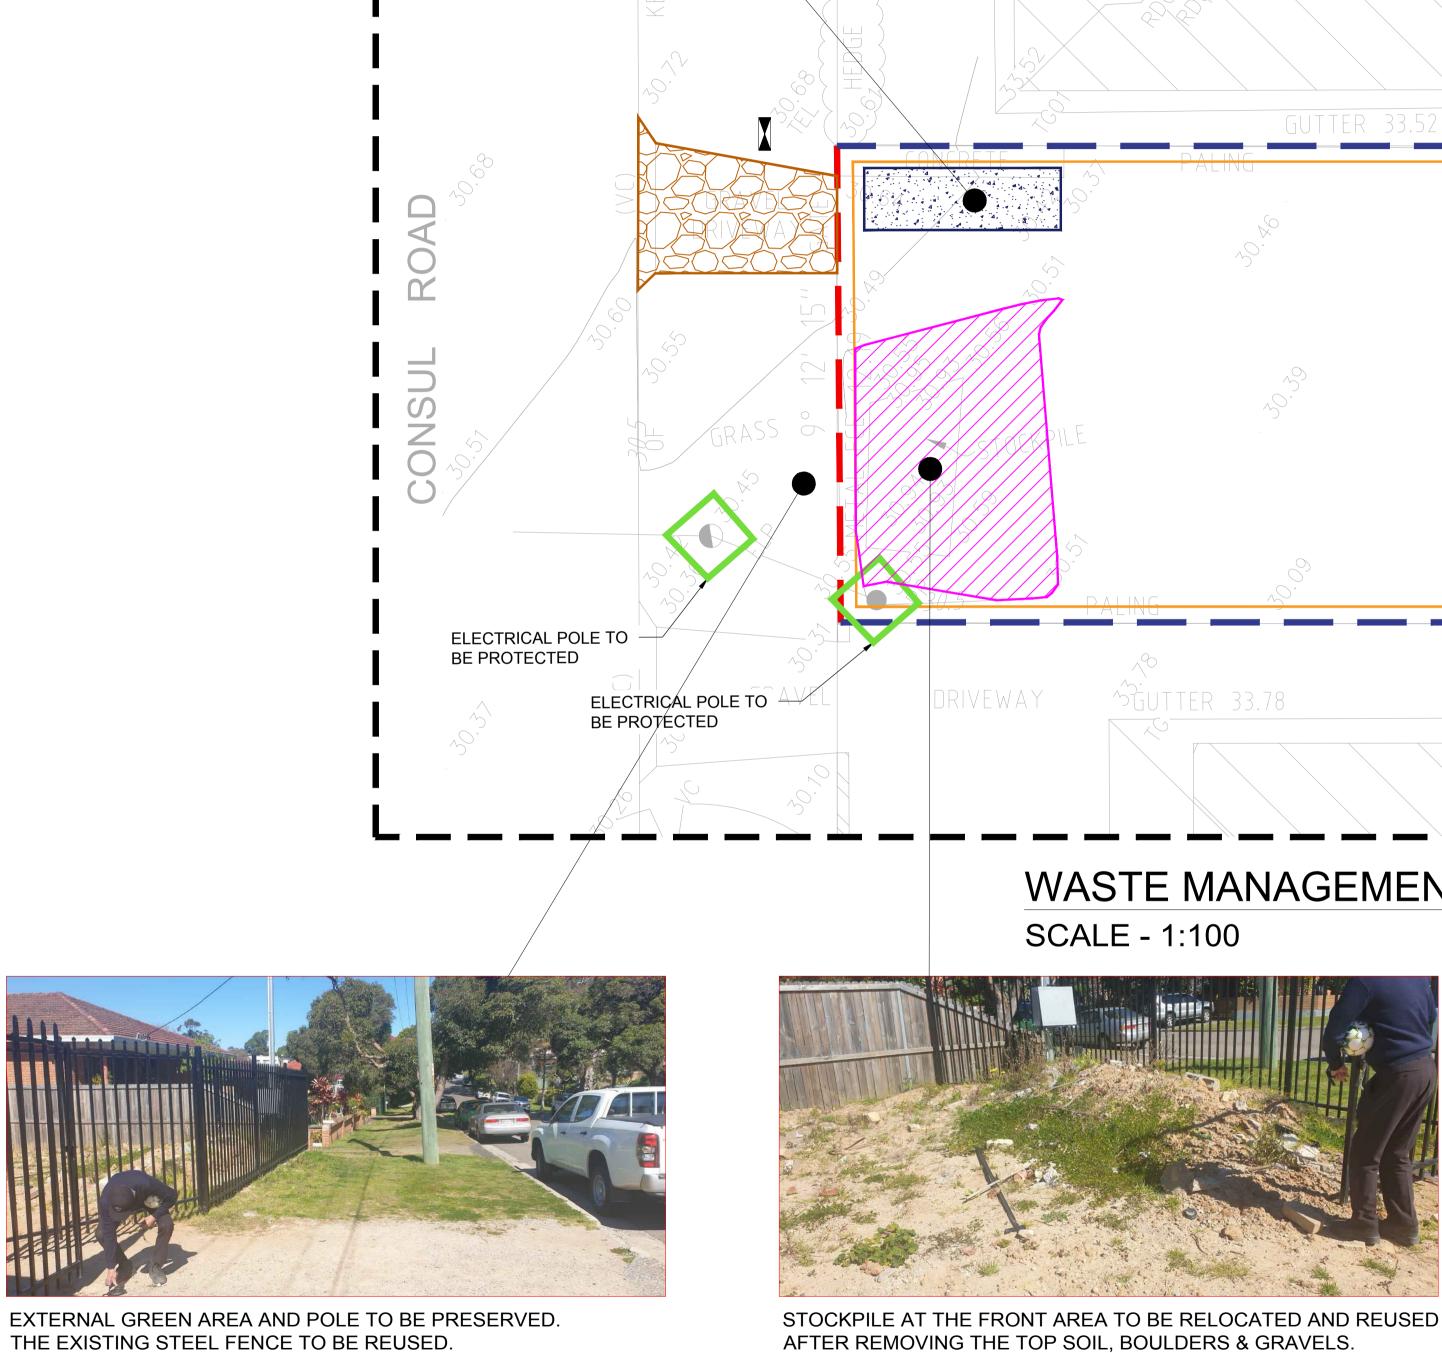
EXISTING CONCRETE TO BE REMOVED AND SEND TO RECYCLING FACILITY. BRICKS TO BE REUSED IN CONSTRUCTION OF OSD & PITS. CAN ALSO BE USED IN SET OUT DURING INITIAL WORK.

		GREEN AREA AND POLE TO BE PRESI ING STEEL FENCE TO BE REUSED.	ERVED.	STOCKPILE AT THE FRONT ARE AFTER REMOVING THE TOP SC	
	DATE	AMENDMENT	CLIENT / BUILDER / ARCHITECT		
-	29.09.2020	ISSUE FOR DISCUSSION ISSUE FOR DEVELOPMENT APPLICATION			
-	09.10.2020	ISSUE FOR DEVELOPMENT APPLICATION			
-				APG	

ISSUE 00

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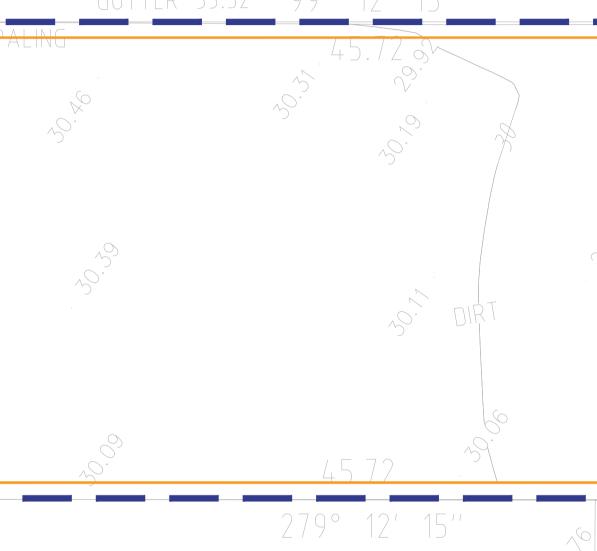





EXISTING CAVITY TO BE FILLED AND GRADED WITH AVAILABLE TOP SOIL (STOCKPILE) AFTER CLEANING THE DEBRIS.



EXISTING CAVITY TO BE FILLED AND GRADED WITH AVAILABLE TOP SOIL (STOCKPILE) AFTER CLEANING THE DEBRIS.



WASTE MANAGEMENT PLAN

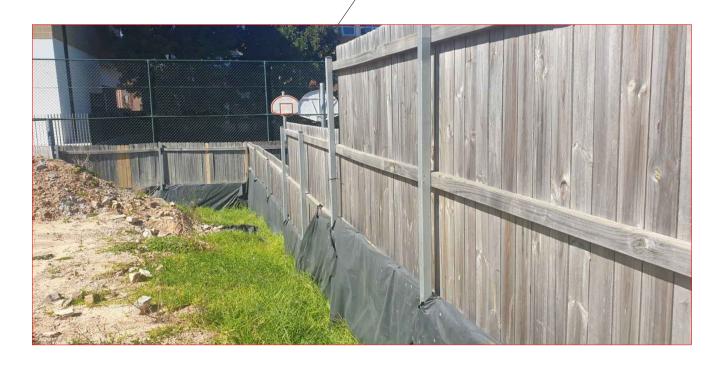


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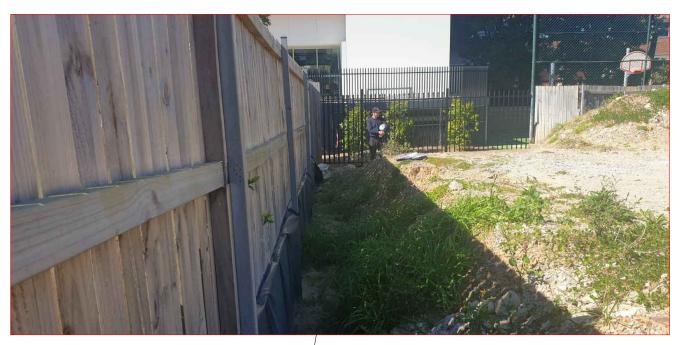
GARAGE

GRASS AND VEGETATION TO BE REMOVED. EXISTING CAVITY TO BE FILLED AND GRADED WITH AVAILABLE TOP SOIL (STOCKPILE) AFTER CLEANING THE DEBRIS.


Plotted by: Ammar Khalid





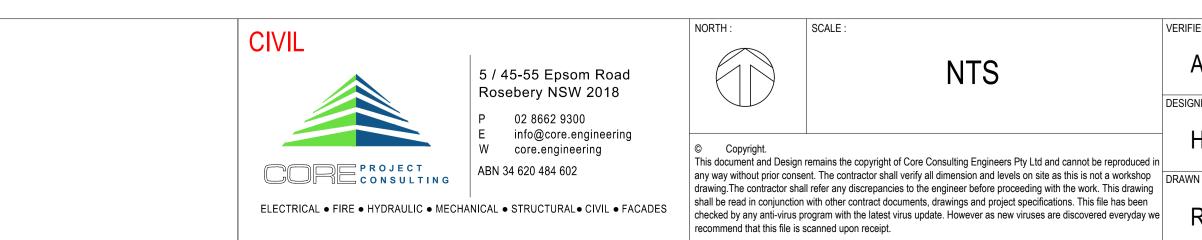


EXISTING TOPSOIL TO BE CLEANED FROM WASTE, GRAVELS & CLEAN SOIL IS TO BE USED AS BACKFILL IN THE CAVITIES PRESENT ALONG THE TWO SIDES OF THE BOUNDARY. NOTE THE FILL IS TO BE COMPACTED AND GRADED AS PER PROPOSED DRIVEWAY PLAN.

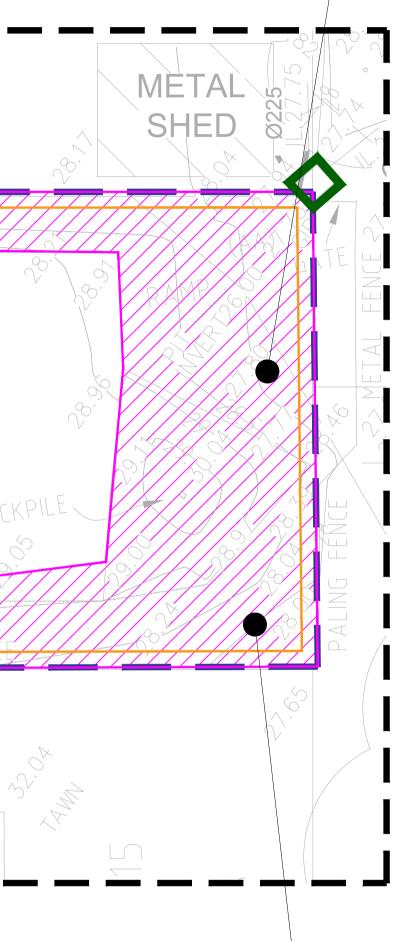

EXISTING TOPSOIL TO BE CLEANED FROM WASTE, GRAVELS CLEAN SOIL IS TO BE USED AS BACKFILL IN THE CAVITY PRESENT ALONG THE TWO SIDES OF THE BOUNDARY. NOTE THE FILL IS TO BE COMPACTED AND GRADED AS PER PROPOSED DRIVEWAY PLAN.

ISSUE FOR DA

IED :	DRAWING TITLE :	DATE :	SCALE :
AC	WASTE MANAGEMENT PLAN	12/09/2020	1:100
SNED :		PROJECT No :	REVISION :
HR	PROJECT :	2290	02
/N :	PROPOSED CARPARK A7.	DRAWING No :	
RQ	33 CONSUL ROAD, BROOKVALE	C003	3

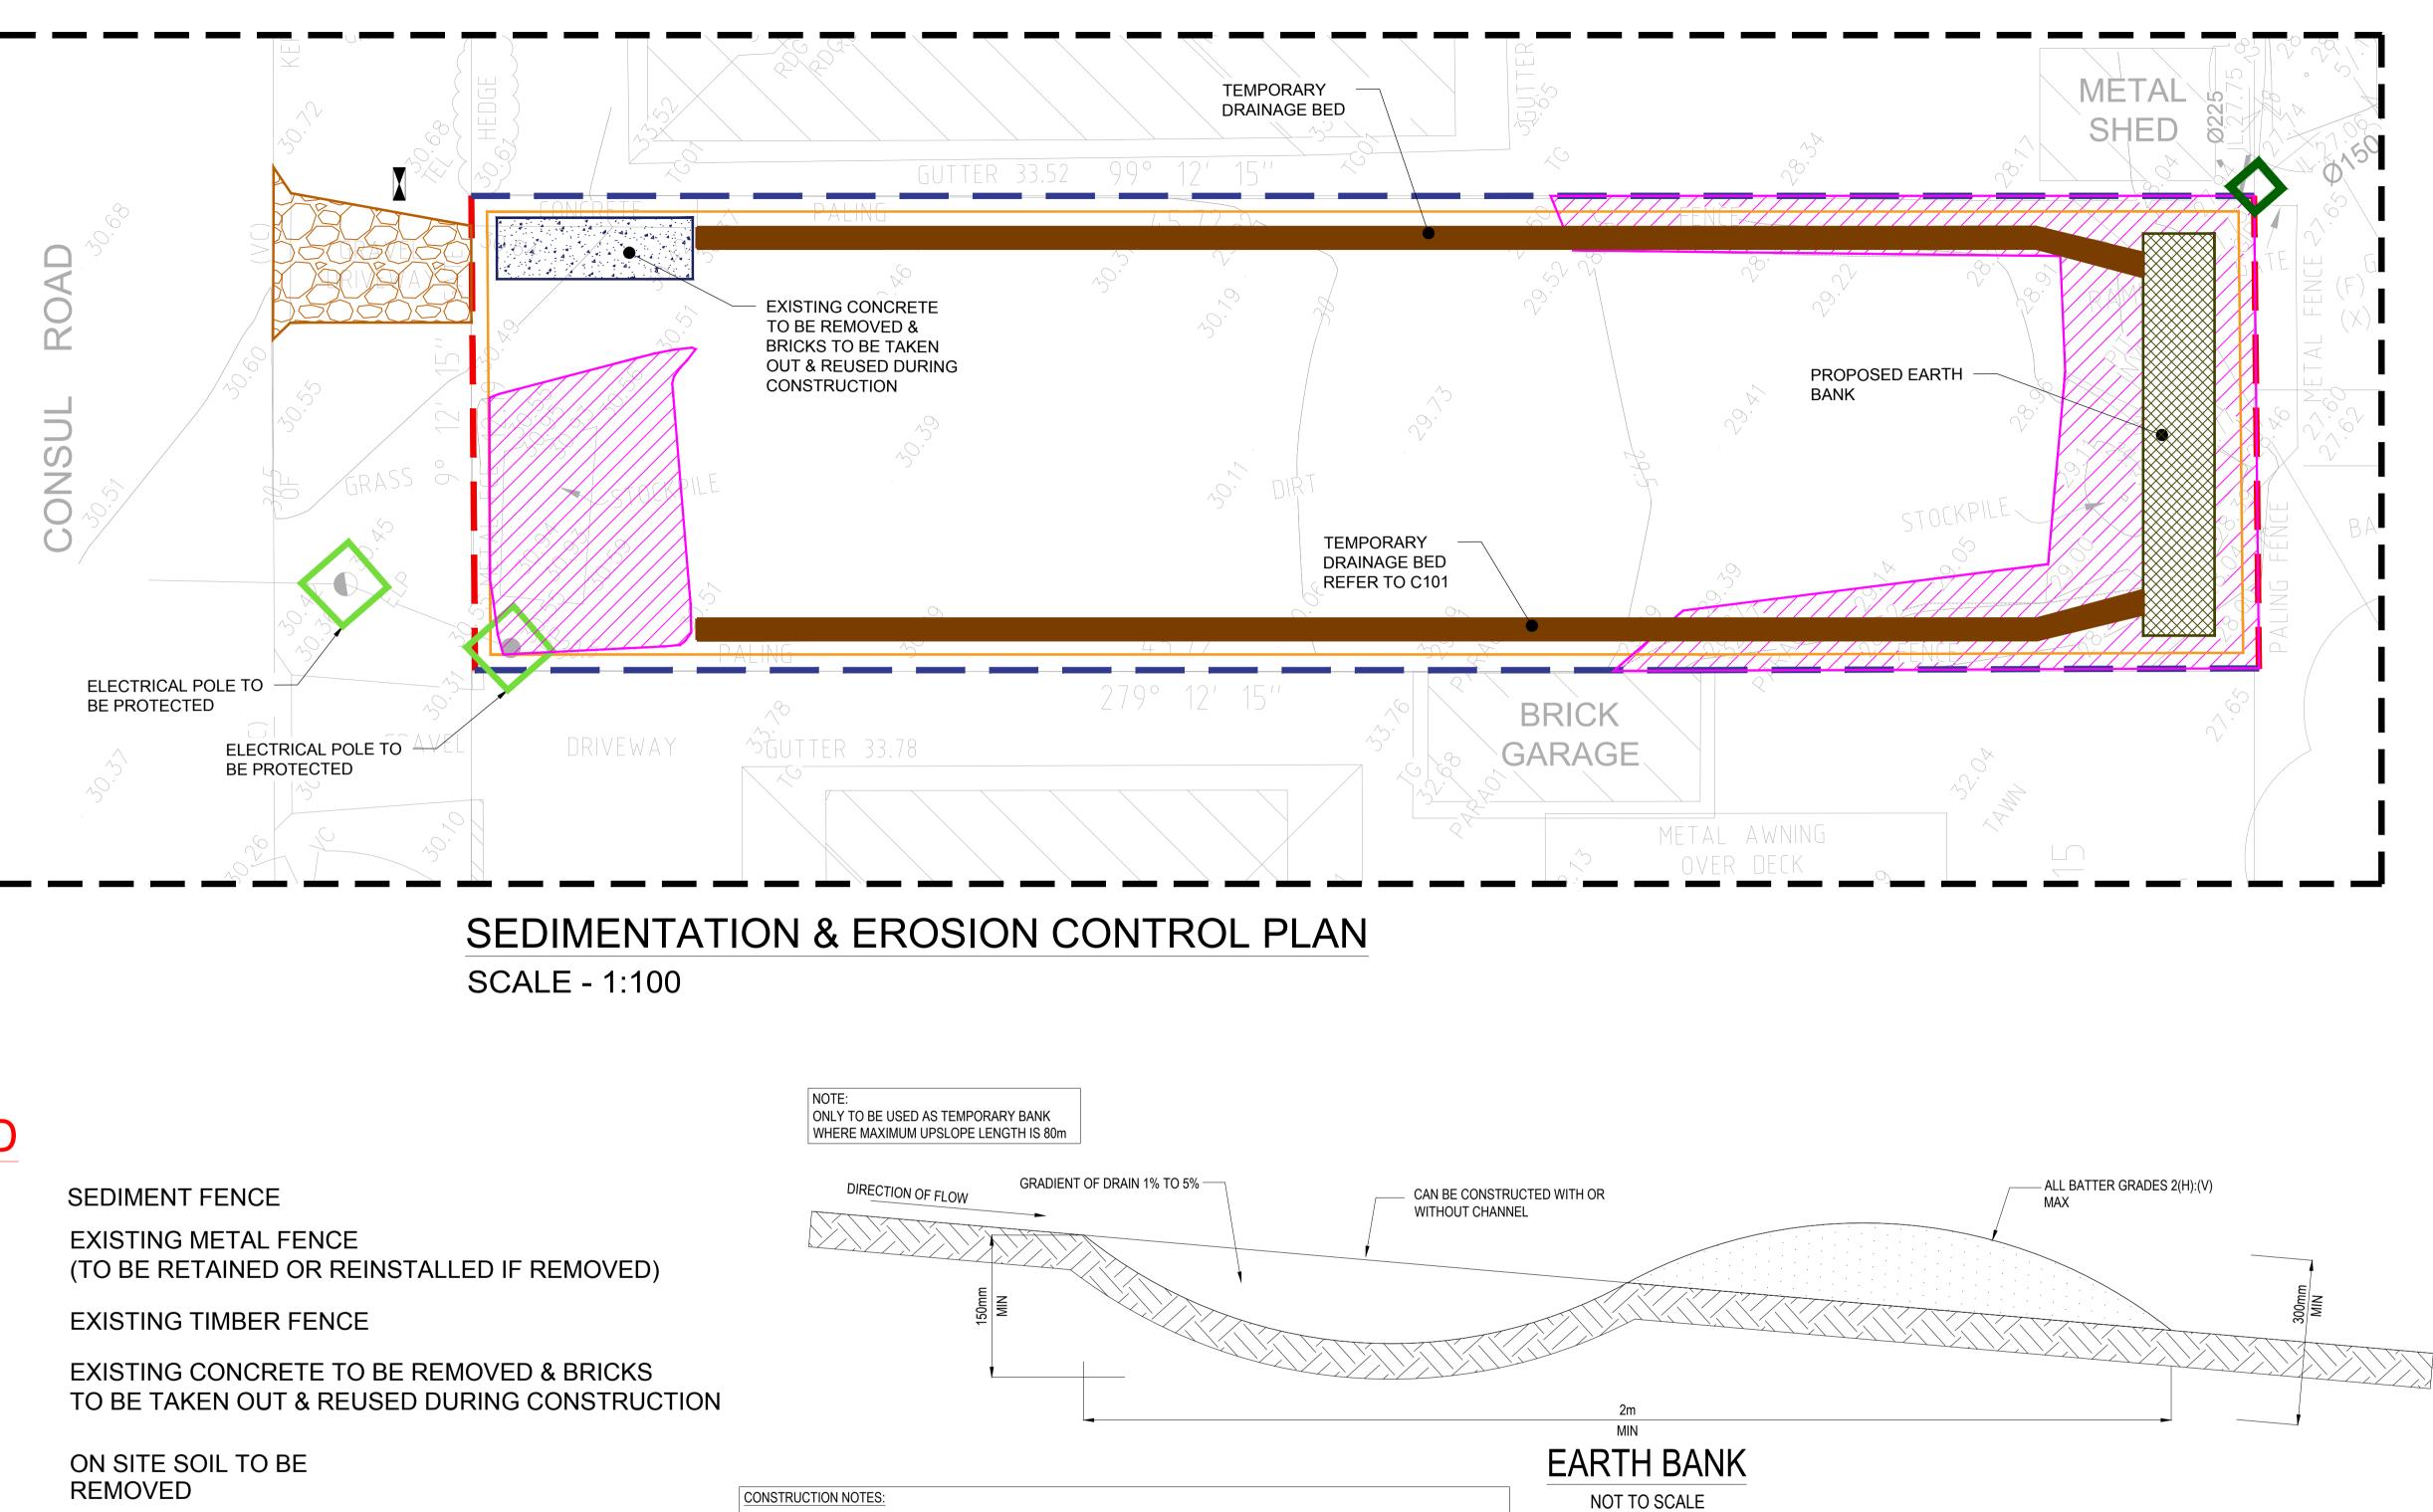

LEGEND














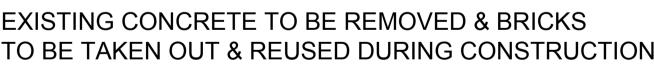

REMOVED

PIT TO BE PRESERVED **REFER TO DETAIL**

EXISTING GRAVEL DRIVEWAY TO BE RECONSTRUCTED AT COMPLETION STAGE

4

ISSUE	DATE	AMENDMENT	CLIENT / BUILDER / ARCHITECT		
00	29.09.2020	ISSUE FOR DISCUSSION			
01	02.10.2020	ISSUE FOR DEVELOPMENT APPLICATION			
02	09.10.2020	ISSUE FOR DEVELOPMENT APPLICATION			
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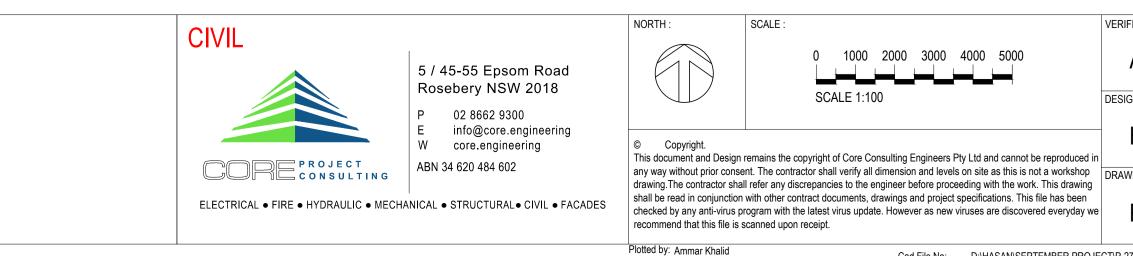
BUILD WITH GRADIENTS BETWEEN 1% AND 5%

AVOID REMOVING TREES AND SHRUBS IF POSSIBLE- WORK AROUND THEM

ENSURE THE STRUCTURES ARE FREE OF PROJECTIONS OR OTHER IRREGULARITIES THAT COULD IMPEDE WATER FLOW BUILD THE DRAINS WITH CIRCULAR, PARABOLIC OR TRAPEZOIDAL CROSS SECTIONS, NOT V SHAPED


ENSURE THE BANKS ARE PROPERLY COMPACTED TO PREVENT FAILURE

COMPLETE PERMANENT OR TEMPORARY STABILISATION WITHIN 10 DAYS OF CONSTRUCTION




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AC	SEDIMENTATION & EROSION	12/09/2020	1:100
IGNED :	CONTROL PLAN	PROJECT No :	REVISION :
HR	PROJECT :	2290	02
WN :	PROPOSED CARPARK A7.	DRAWING No :	
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ISSUE FOR DA

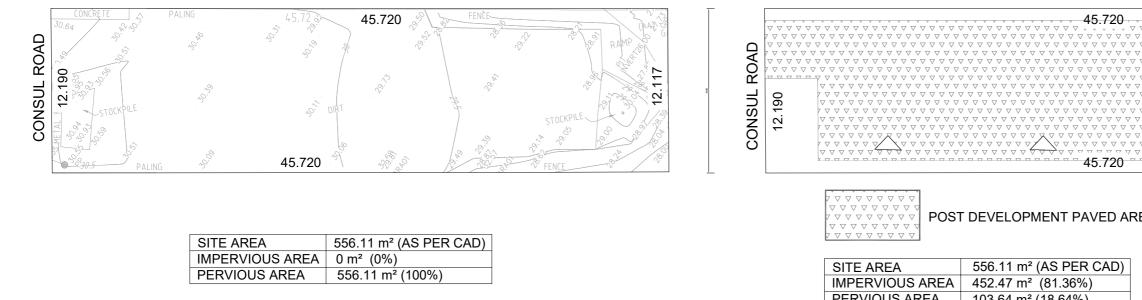


WITH COUNCIL DCP. FURTHER COUNCIL OSD CHECKLIST IS ALSO PROVIDED AS PART OF THIS DA DOCUMENTATION.

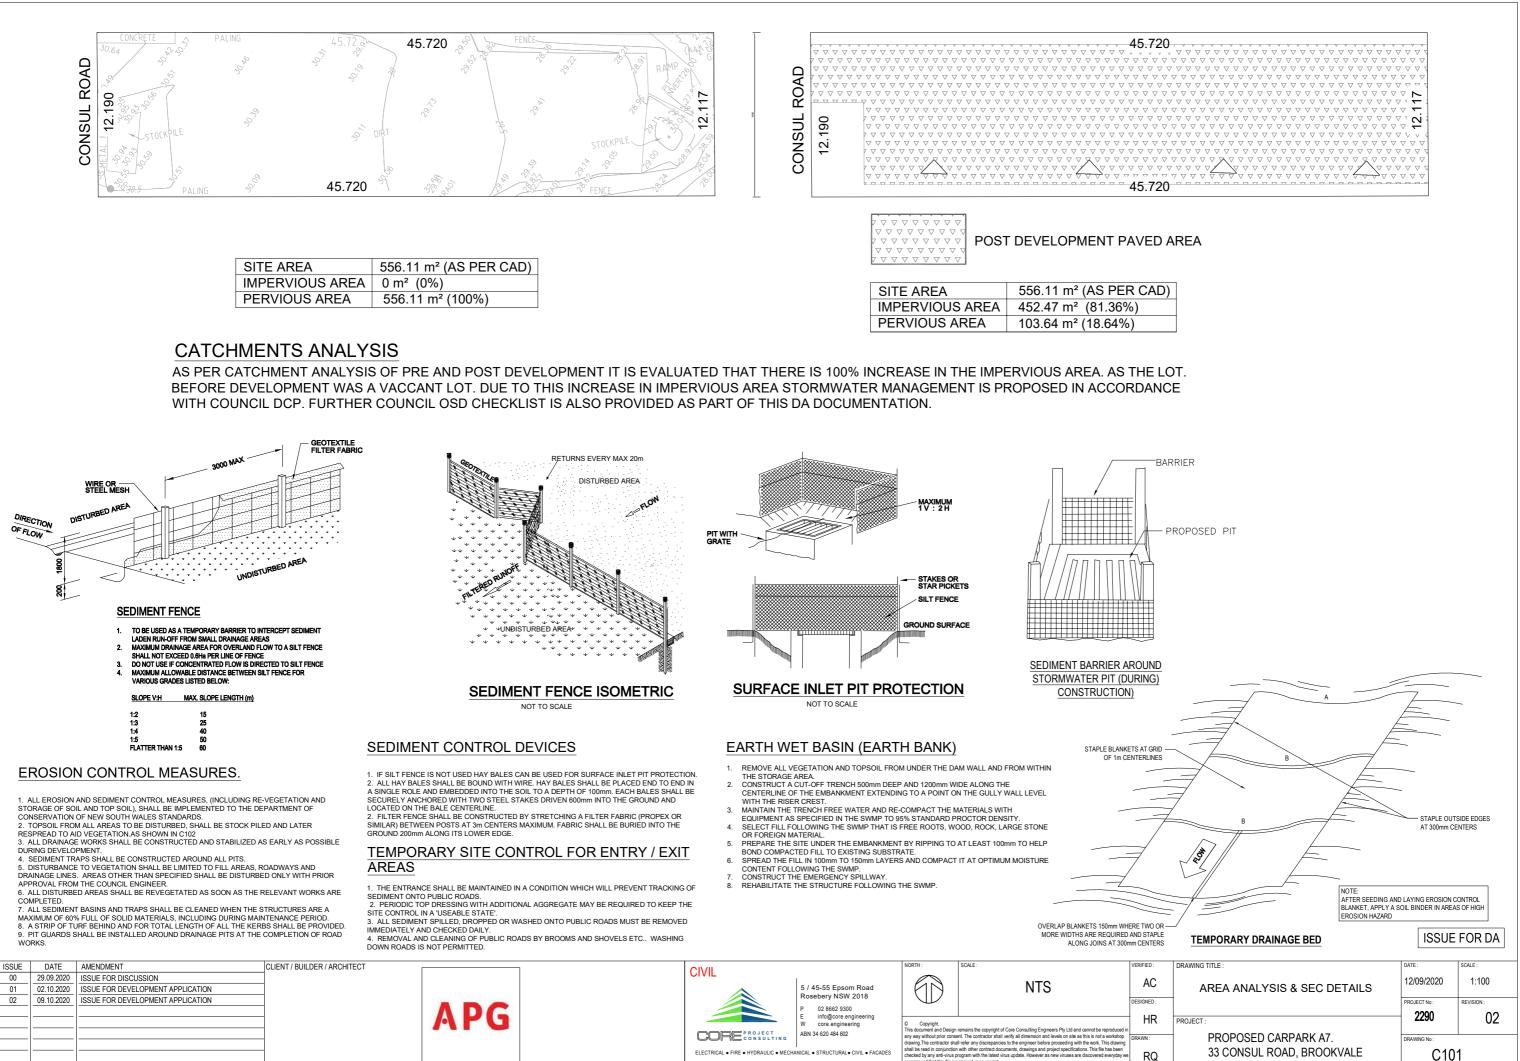

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ted by: Hasan Rana


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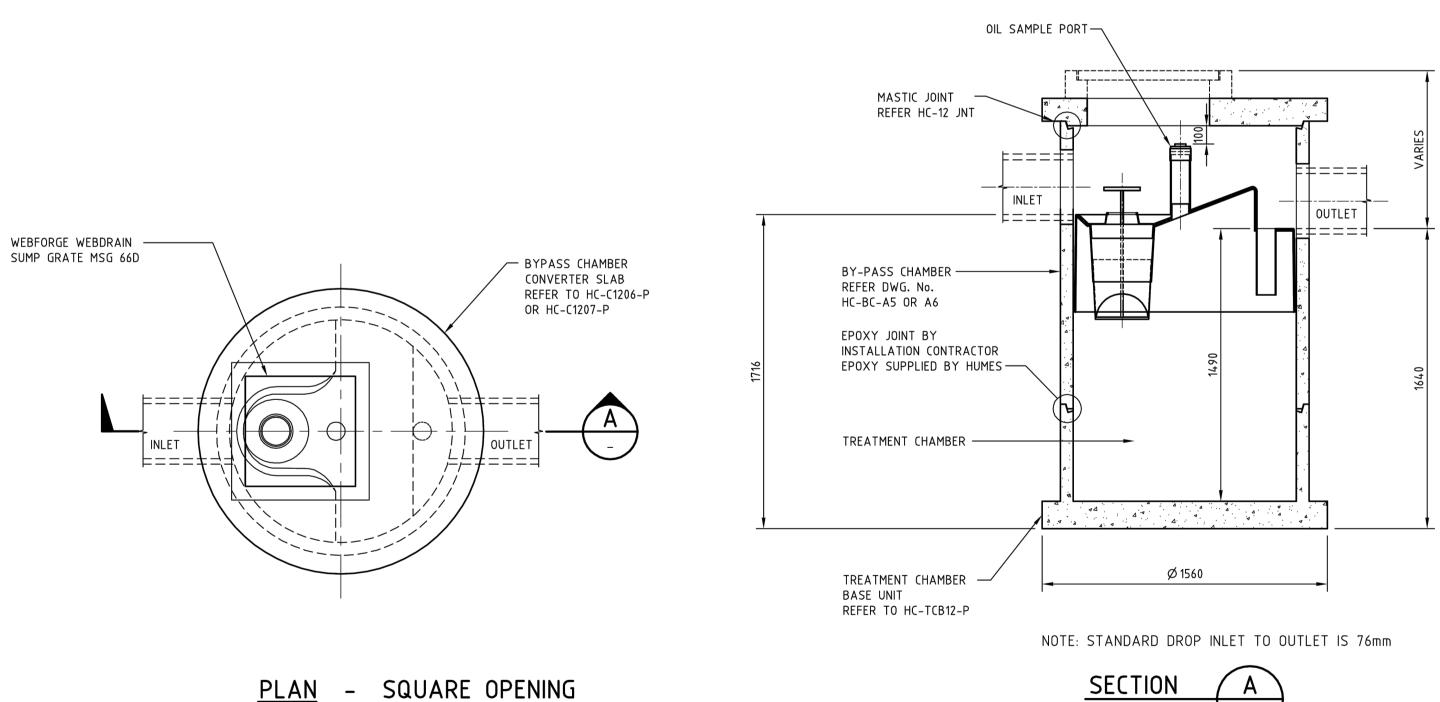
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ISSUE FOR			
AWING TITLE :	DATE :	SCALE :	
STANDARD DETAILS	12/09/2020	1:100	
	PROJECT No : 2290	REVISION :	
OJECT :	2290	02	
PROPOSED CARPARK A7. 33 CONSUL ROAD, BROOKVALE	DRAWING No:	2	

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STORMWATER MANAGEMENT PLAN SCALE - 1:100

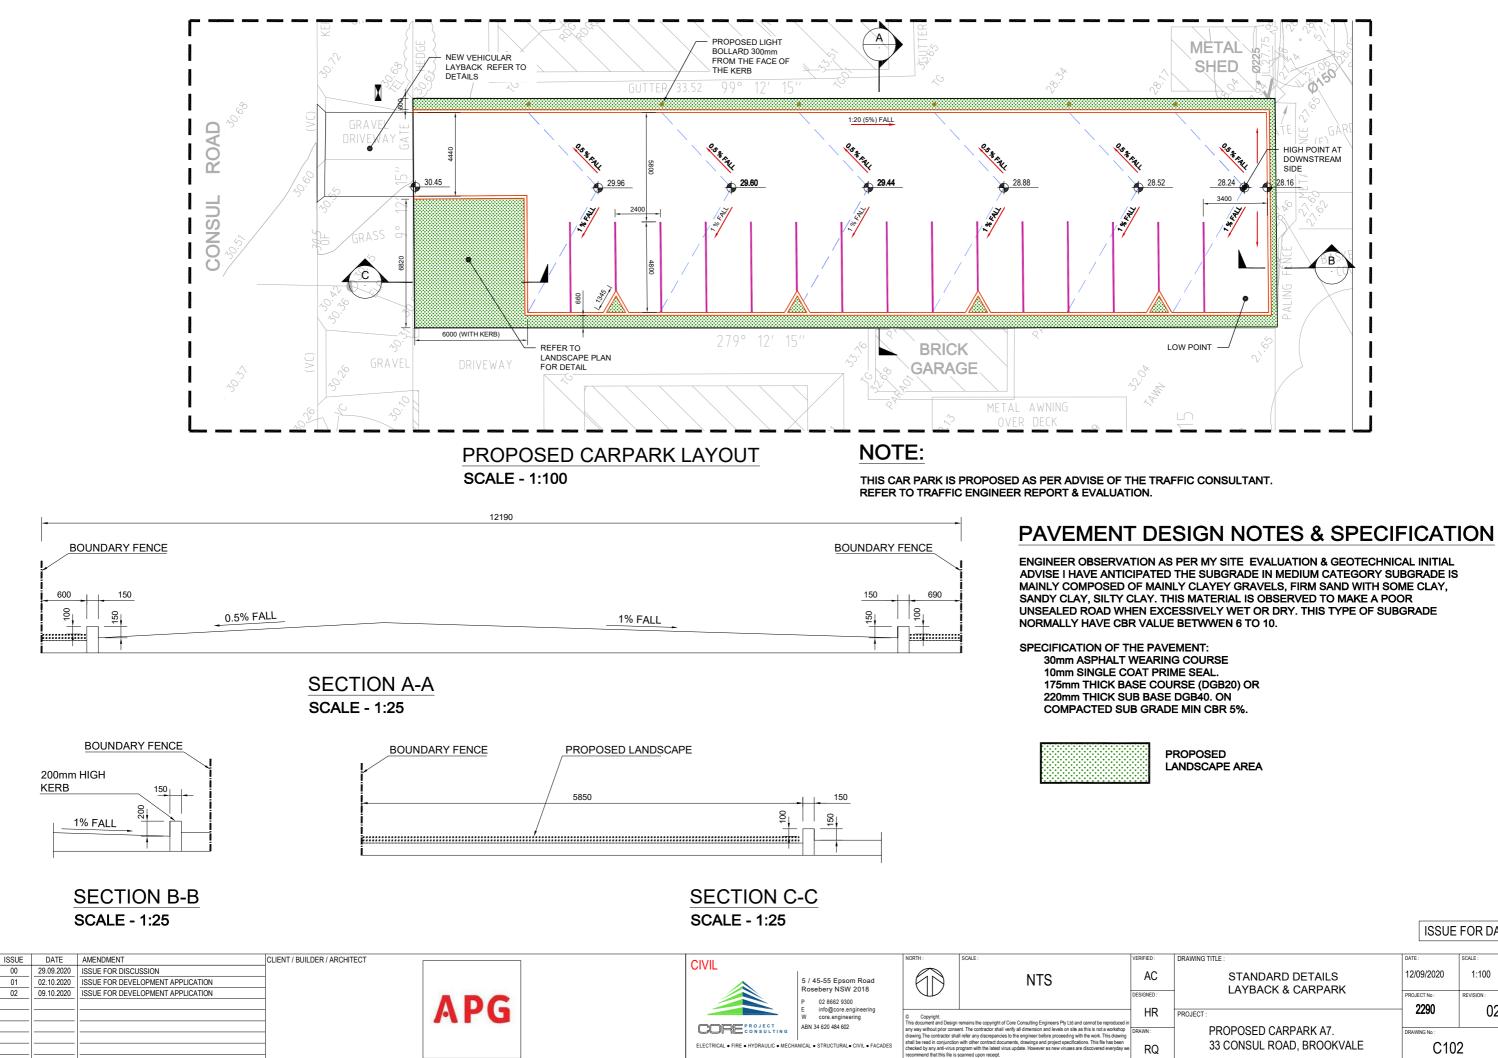

PLAN (PREFERRED) SCALE 1:20

NOTE:

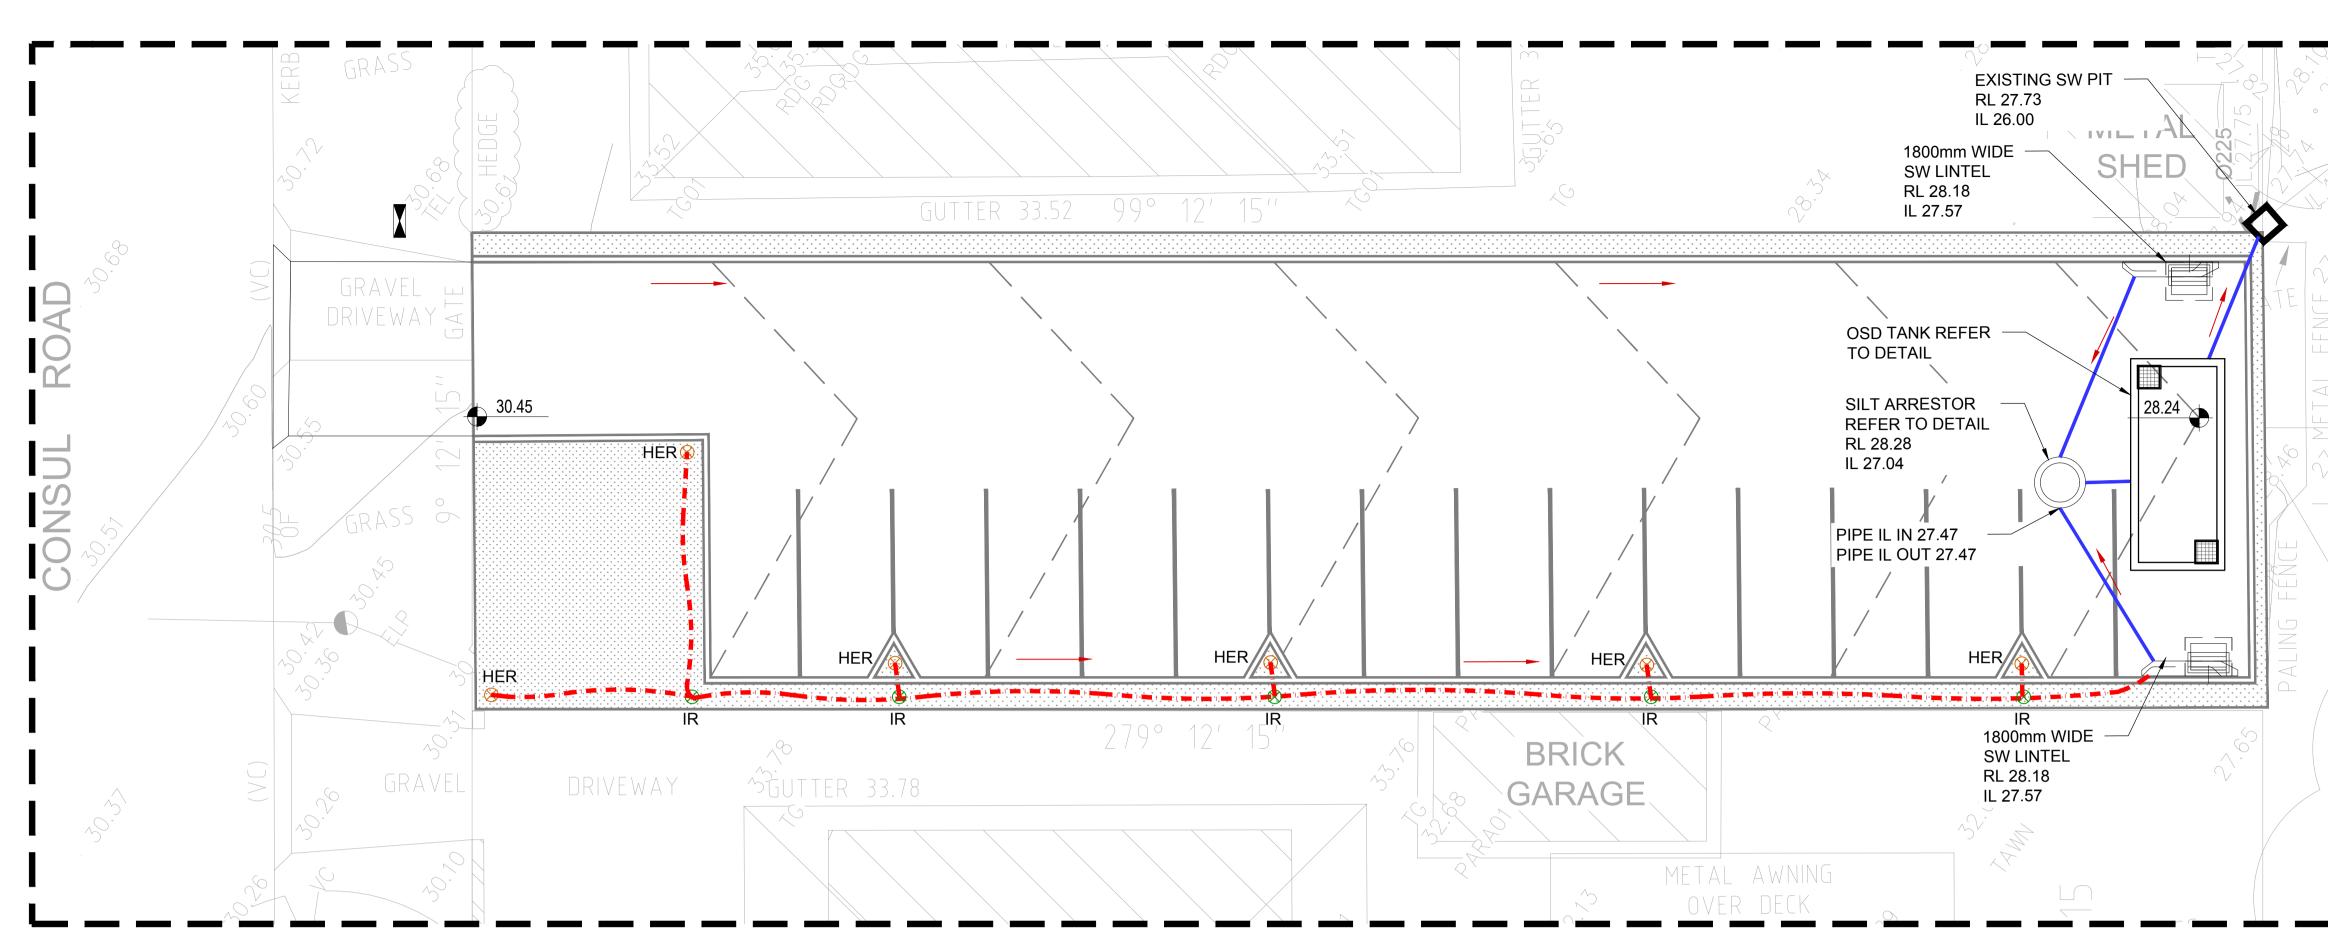THE PRODUCT SPECIFICATIONS ARE AS PER MANUFACTURER / PROVIDER INFORMATION

ISSUE	DATE	AMENDMENT	CLIENT / BUILDER / ARCHITECT	
00	29.09.2020	ISSUE FOR DISCUSSION		
01	02.10.2020	ISSUE FOR DEVELOPMENT APPLICATION		
02	09.10.2020	ISSUE FOR DEVELOPMENT APPLICATION		
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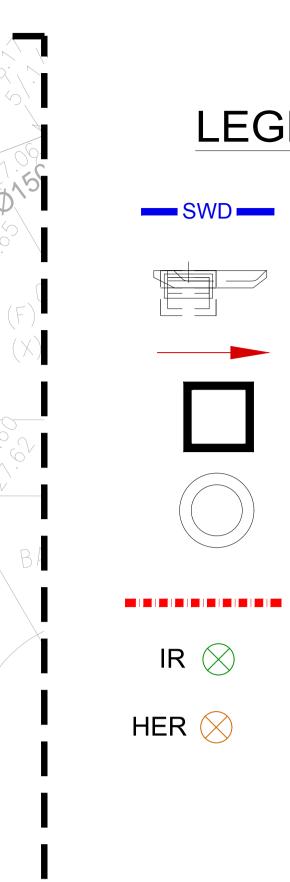


HUMECEPTOR STC 2 (INLET) MODEL PROPOSED SILT SRRESTOR

NOTE:

CONCEPT PROVIDED FOR ILLUSTRATION DETAIL DECOMENTATION.

		NORTH :	SCALE :	VERIFIED :	DRAWING TITLE :	DATE :	SCALE :
CIVIL	5 / 45-55 Epsom Road Rosebery NSW 2018		NTS	AC	CONCEPT STORMWATER MANAGEMENT PLAN	12/09/2020	1:100
	P 02 8662 9300 E info@core.engineering W core.engineering	© Copyright.		DESIGNED :	PROJECT :	PROJECT No :	REVISION :
CORE PROJECT CONSULTING ELECTRICAL • FIRE • HYDRAULIC • MECHA	ABN 34 620 484 602	This document and Desi any way without prior con drawing. The contractor s shall be read in conjunct checked by any anti-virus	sign remains the copyright of Core Consulting Engineers Pty Ltd and cann onsent. The contractor shall verify all dimension and levels on site as this shall refer any discrepancies to the engineer before proceeding with the v ction with other contract documents, drawings and project specifications. T us program with the latest virus update. However as new viruses are discre e is scanned upon receipt.	is not a workshop work. This drawing This file has been	PROPOSED CARPARK A7. 33 CONSUL ROAD, BROOKVALE	DRAWING No :	0
		Plotted by: Ammar Khalid	d Cad Eila Na: DI/HASANI/S			·	



LEGENDS

STORM WATER DRAIN LINE (Ø150)

SW-PIT WITH LINTEL

FLOW DIRECTION


EXISTING SW PIT

SILT ARRESTOR

Ø100 SUBSOIL DRAINAGE LINE- (AGI LINE)

(IR) INTERMEDIATE RISER (HER)HIGH END RISER

ISSUE FOR DA

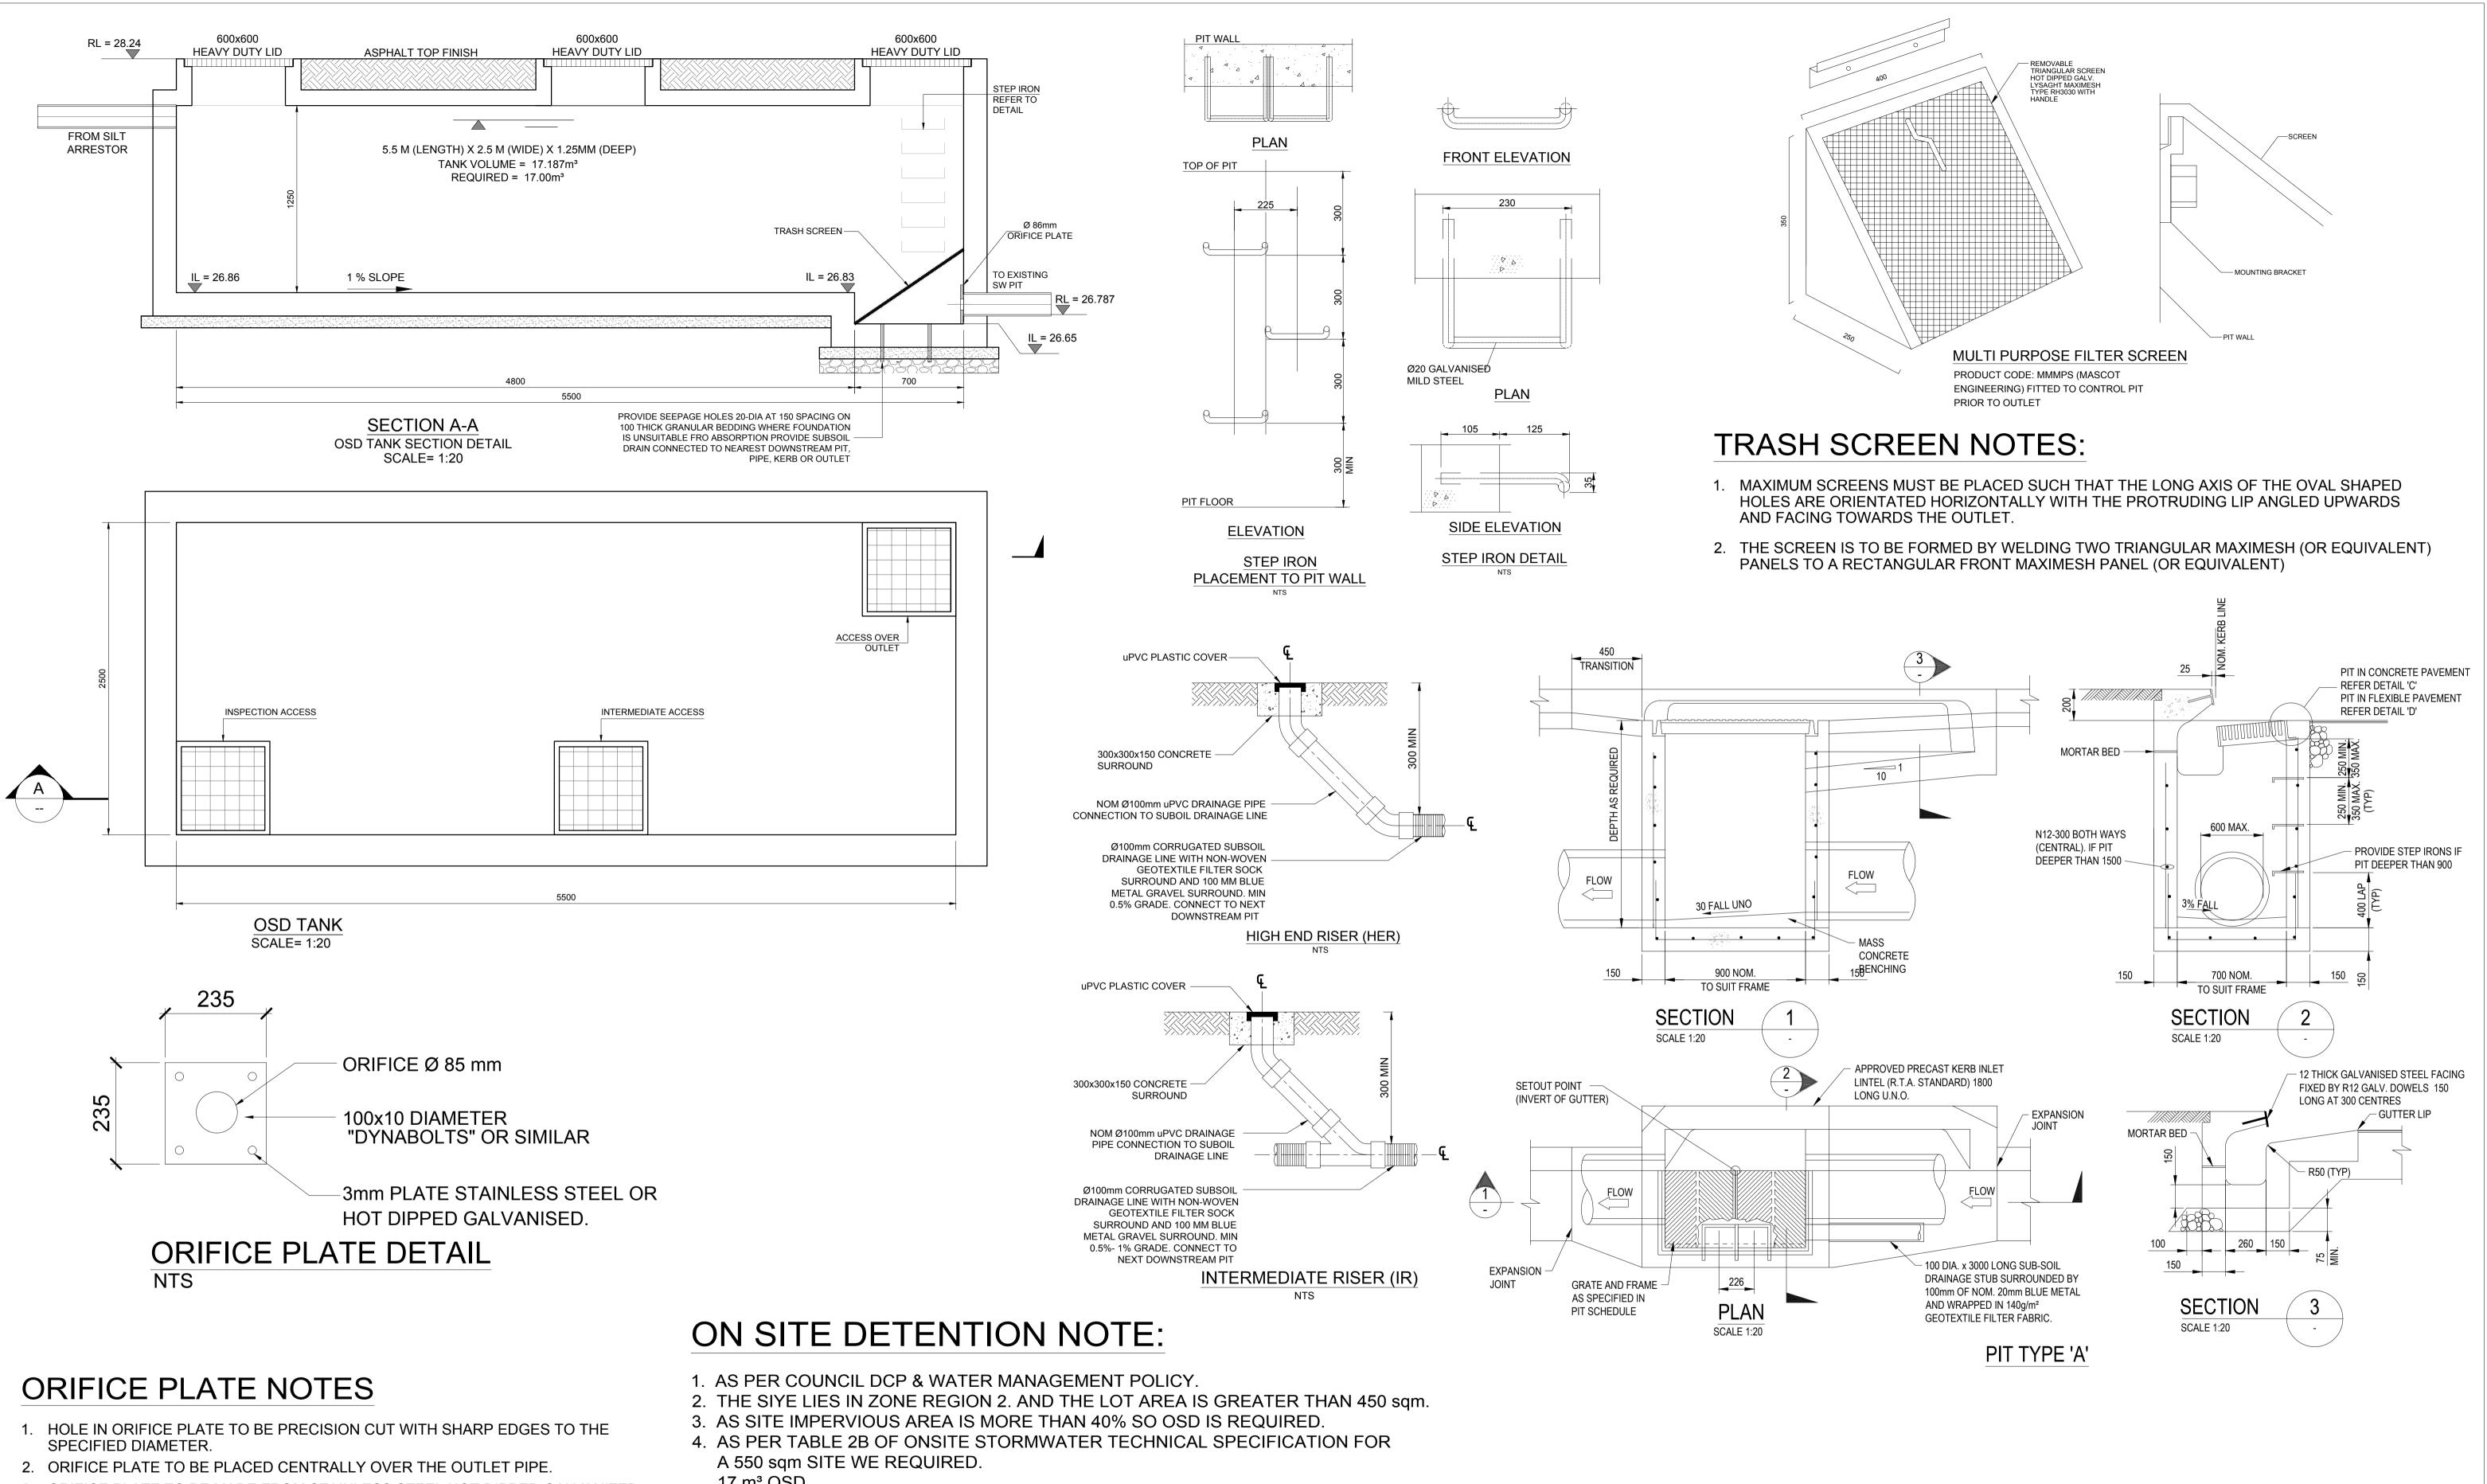

- 3. ORIFICE PLATE TO BE MADE FROM STAINLESS STEEL HOT DIPPED GALVANIZED OR OTHERS NOT ACCEPTABLE.
- 4. OUTLET PIPE TO BE CAST INTO THE WALL OF THE PIT.
- 5. HOLE IN THE PLATE TO BE CENTRALLY PLACED.

- 17 m³ OSD
- Q5 (EXISTING) 17 l/s Q100 (EXISTING) 33 l/s

ISSUE	DATE	AMENDMENT	CLIENT / BUILDER / ARCHITECT	CIVIL		NORTH :	SCALE :	VERIF
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02	09.10.2020	ISSUE FOR DEVELOPMENT APPLICATION			Rosebery NSW 2018			DESI
					P 02 8662 9300 E info@core.engineering			4
					W core.engineering	© Copyright.		í.
				CORECONSULTING	ABN 34 620 484 602	any way without prior conse	remains the copyright of Core Consulting Engineers Pty Ltd and cannot be reproduced in ent. The contractor shall verify all dimension and levels on site as this is not a workshop	DRAV
				ELECTRICAL • FIRE • HYDRAULIC • MECHA	NICAL • STRUCTURAL• CIVIL • FACADES	shall be read in conjunction	all refer any discrepancies to the engineer before proceeding with the work. This drawing a with other contract documents, drawings and project specifications. This file has been	1
						checked by any anti-virus p recommend that this file is	program with the latest virus update. However as new viruses are discovered everyday we scanned upon receipt.	1
						Plotted by: Ammar Khalid		

5. FROM TABLE 3, FOR 17 I/sec 85mm ORIFICE PLATE IS REQUIRED WITH 1.25 M OSD.




1. THAN 3M.

INTERMEDIATE ACCESS IS PROVIDED BECAUSE THE LENGTH OF OSD IS GREATER


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AC	OSD & SILT ARRESTOR AND MISC DETAILS	12/09/2020	1:100
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WN :	PROPOSED CARPARK A7.	DRAWING No :	
RQ	33 CONSUL ROAD, BROOKVALE	C20 ⁻	1

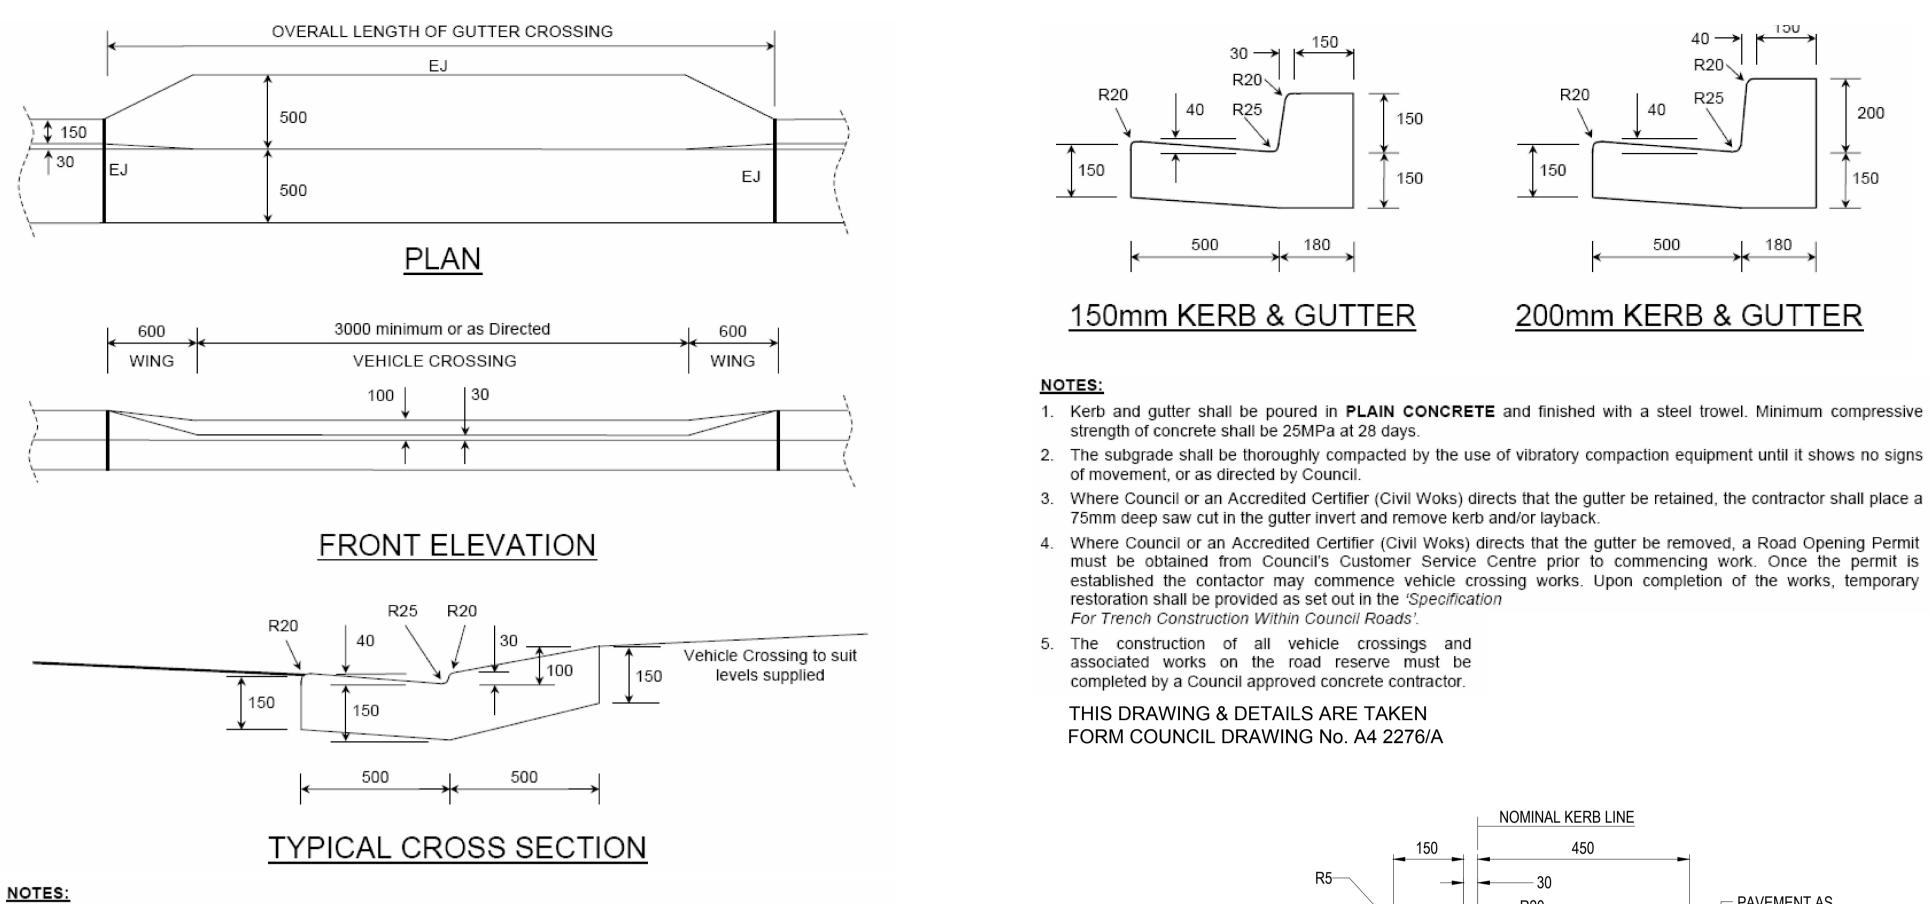

- 1. Layback and gutter shall be poured in PLAIN CONCRETE and finished with a steel trowel. Minimum compressive strength of concrete shall be 25MPa at 28 days. Industrial/commercial properties shall increase the depth of concrete to 180mm and provide SL82 mesh with 30mm top cover.
- The subgrade shall be thoroughly compacted by the use of vibratory compaction equipment until it shows no signs of movement, or as directed by Council.
- Vehicle crossing to be constructed in accordance with levels and specifications issued by Council.
- Kerbing to be constructed in accordance with Council Plan A4 2276/A and specifications. 5. Where Council or an Accredited Certifier (Civil Woks) directs that the gutter be retained, the contractor shall place a
- 75mm deep saw cut in the gutter invert and remove kerb and/or layback.
- Where Council or an Accredited Certifier (Civil Woks) directs that the gutter be removed, a Road Opening Permit must be obtained from Council's Customer Service Centre prior to commencing work. Once the permit is established the contactor may commence vehicle crossing works. Upon completion of the works, temporary restoration shall be provided as set out in the 'Specification' Not to Scale. All Dimensions in Millimetres. For Trench Construction Within Council Roads'.
- The construction of all vehicle crossings and associated works on the road reserve must be completed by a Council approved concrete contractor.
- EJ Expansion Joint 10mm Mastic.
- R Radius


THIS DRAWING & DETAILS ARE TAKEN FORM COUNCIL DRAWING No. A4 2276/B

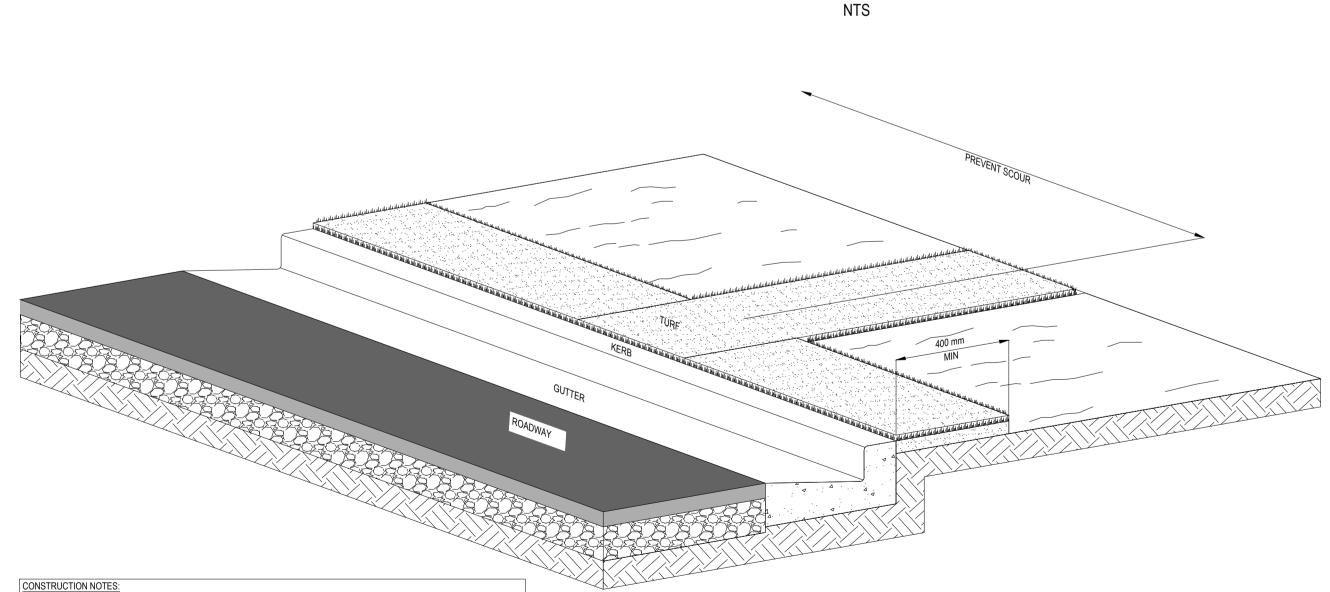

- INSTALL A 400mm MINIMUM WIDE ROLL OF TURF ON THE FOOTPATH NEXT TO THE KERB AND AT THE SAME LEVEL AS THE TOP OF THE KERB
- LAY 1.4m LONG TURF STRIPS NORMAL TO THE KERB EVERY 10m

REHABILITATE DISTURBED SOIL BEHIND THE KERB

	ISSUE	DATE	AMENDMENT	CLIENT / BUILDER / ARCHITECT
	00	29.09.2020	ISSUE FOR DISCUSSION	
	01	02.10.2020	ISSUE FOR DEVELOPMENT APPLICATION	
	02	09.10.2020	ISSUE FOR DEVELOPMENT APPLICATION	
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VARIES (75 MIN) **REFER TO DESIGN PAVEMENT SECTIONS**

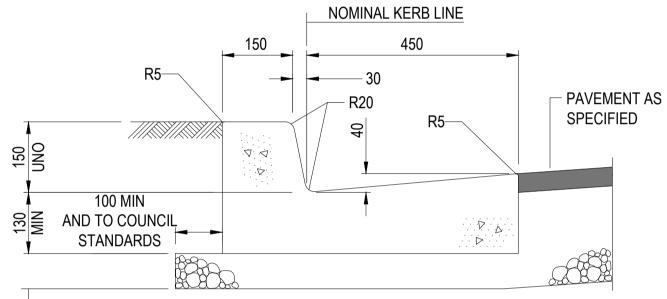KERB & GUTTER (KG)

KERBSIDE TURF STRIP NOT TO SCALE TYPICAL DETAIL FOR ILLUSTRATION

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FORMWORK

THE FORMS SHALL BE ALIGNED TRUE TO GRADE AND WITH OUT IRREGULARITIES. THE TOLERANCE SHALL BE ±15mm PROVIDED THAT VARIATIONS IN LEVELS ARE NOT LOCAL AND ORE OVER LENGTH OF 3 METERS OR MORE.

FORMS SHALL BE CONSTRUCTED SO THAT THEY CAN BE REMOVED WITHOUT DAMAGING THE CONCRETE AND SHALL BE ADEQUATELY BRACED. THE INNER SURFACE OF FORMS SHALL BE ADEQUATELY OILED TO ENSURE THE NON-ADHESION OF THE CONCRETE. THE MATERIAL USED FOR FORMS FOR THE EXPOSED SURFACES SHALL BE DRESSED SOFT WOOF TIMBER.

TIMBER PEGS OF 50mm x 50mm-DIMENSION MINIMUM MUST BE PROVIDED FOR THE SUPPORT OF ALL FORMWORK. THE USE OF STEEL PEGS FOR THE SUPPORT OF FORMWORK IS PROHIBITED

MATERIALS

CONCRETE"

THE MINIMUM COMPRESSIVE STRENGTH Fc OF THE CONCRETE SHALL BE 25 MPa AT 28 DAYS IN ACCORDANCE WITH AS 3600 - 2009 " CONCRETE STRUCTURES" JOINTS

FOR HAND PLACED KERB AND GUTTER EXPANSION JOINT 10mm THICK FOR THE FULL DEPTH OF THE KERB AND GUTTER SHALL BE PROVIDED AT INTERVALS NOT EXCEEDING 6m.

FOR MACHINE PLACED KERB AND GUTTER, EXPANSION JOINTS 6mm THICK SHALL BE PROVIDED AT INTERVALS OF 6m AND CONSTRUCTION JOINTS SHALL BE FORMED EVERY 3m FOR THE FULL DEPTH OF THE KERB AND GUTTER.

JOINTS ARE ALSO REQUIRED WHERE THE GUTTER ABUTS GULLY PITS AND GUTTER CROSSINGS. EXPANSION JOINTS SHALL CONSIST OF PERFORMED JOINTING MATERIAL BITUMINOUS FIBERBOARD.

TOLERANCE

TOLERANCE ON THE LEVEL OF KERB AND GUTTER CONSTRUCTION BOTH HORIZONTAL AND VERTICAL SHALL BE PLUS OR MINUS 10mm.

KERB AND GUTTER

THECONSTRUCTION OF CONCRETE KERB AND GUTTER IS TO BE IN ACCORDANCE WITH AS 2876 - 2000 " CONCRETE KERBS AND CHANNELS (GUTTERS) - MANUALLY OR MACHINE PLACED " UNLESS OTHERWISE INDICATED BELOW.

KERB AND GUTTER DETAIL DOCUMENTED BELOW.

LEVELS CONSTRUCTION.

PLACING CONCRETE

THE CONCRETE SHALL BE PLACED SO AS TO AVOID SEGREGATION AND SHALL BE ADEQUATELY COMPACTED. CARE SHALL BE TAKEN TO FILL EVERY PART OF THE FORMS AND TO WORK TO COARSER AGGREGATE BACK FROM THE FACE. EXPOSED SURFACES SHALL BE FINISHED WITH A STEEL FLOAT, AND CORNERS AND EDGES SHALL BE NEATLY ROUNDED WITH A NOISING TOOL. CONCRETE SHALL NOT BE DISTURBED AFTER IT HAS BEEN IN THE FORMS FOR TWENTY (20) MINUTES. FINISH

AFTER REMOVAL OF THE FORMS, MINOR OR POROUS SECTIONS OR HOLES SHALL BE REPAIRED WITH A 3 TO 1 SAND AND CEMENT MORTAR MIX. THE EXPOSED SURFACES SHALL THEN BE RUBBED WITH A WOODEN FLOAT AND CLEAN WATER TO LEAVE THE SURFACES SMOOTH AND UNIFORM IN COLOR AND APPEARANCE.

BACKFILLING

AFTER REMOVAL OF FORMWORK THE FOOTWAY BEHIND THE KERB SHALL BE NEATLY TRIMMED. FILLED AND OR TURFED TO MAKE A SMOOTH CONNECTION TO THE UNDISTURBED NATURE STRIP.


READY MIXED CONCRETE SHALL CONFORM TO THE PROVISIONS OF AS 1379 - 2007 " READY MIXED

KERB AND GUTTER SHALL BE IN ACCORDANCE WITH COUNCIL DRAWING NUMBER A4 2267/A/ AS

DESIGN PLAN ARE TO BE PREPARED BY THE APPLICANT AND APPROVED BY THE COUNCIL PRIOR TO

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/N :	PROPOSED CARPARK A7.	DRAWING No :	
RQ	33 CONSUL ROAD, BROOKVALE	C2	02

ISSUE FOR DA

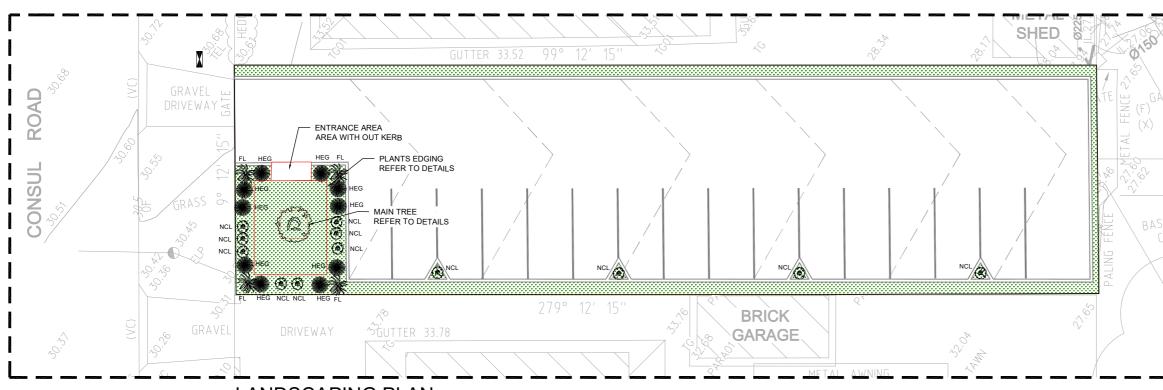

LANDSCAPING PLAN SCALE - 1:100

NOTES:

REFER THIS WITH LANDSCAPE SPECIFICATION + DETAILS PLAN PREPARED IN ACCORDANCE WITH THE LANDSCAPE GUIDELINES OUTLINED IN NORTHERN BEACHES

COUNCIL'S D.C.P READ THIS IN CONJUNCTION WITH THE ARCHITECTURAL SURVEY, STRUCTURAL, HYDRAULIC DRAWINGS AND DETAILS ALL BOUNDARY FENCING WHERE IN POOR CONDITION 1.8M LAPPED AND CAPPED TIMBER FENCING OR EQUIVALENT POLLUTION CONTRL, EROSION CONTROL AND TREE PROTECTION MEASURES AS DETAILED OR SPECIFIED SHALL BE IN PLACE PRIOR TO CONSTRUCTION & MAINTAINED DURING THE ENTIRE DURATION OF CONSTRUCTION CONCRETE EDGING TO BE PROVIDED BETWEEN TURF

GARDEN BED/ MULCH

ALL GARDEN BEDS TO BE PROVIDED WITH 300MM GARDEN SOIL MIX. ALL TURF AREAS ARE TO BE PROVIDED WITH 50MM TURF UNDERLAY SOIL MIX IRRIGATION TO BE PROVIDED TO GARDEN BEDS LINE TO BE 200MM BELOW FINISHED SUBFACE LEVELS PROVIDE ORGANIC MULCH TO PLANTING AREAS (MIN 75MM) AND IN ACCORDANCE WITH AS 4454

MAINTENANCE

AREAS AND GARDEN BEDS.

MAINTAIN ALL LANDSCAPE AREAS TO ENSURE PLANT HEALTH AND OCCUPANT SAFTEY FOR A PERIOD OF 6 MONTHS BEGINING FROM THE DATE OF PRACTICAL COMPLETION FERTILISE ALL PLANT MATERIAL. PRUNING. WATERING. REPLACMENT OF FAILED PLANTS. TREAT DISEASES & PESTS TOPPING UP OF MULCH AND WEEDING GARDEN BEDS

GENERAL

ISSUE DATE AMENDMENT

29.09.2020

09.10.2020

01 02.10.2020

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02

THE FOLLOWING ITEMS ARE NOT INCLUDED IN THE LANDSCAPE PLANS OR SPECIFICATIONS REFER TO BUILDING SPECIFICATIONS AND ARCHITECTURAL PLANS FOR DETAILS PAVING DETAILS GARDEN FURNITURE OR LIGHTING LANDSCAPE PLAN DETAILED IN ACCORDANCE WITH BASIX CERTIFICATE REQUIREMENT MIN 15 m2 COMMITMENT

ISSUE FOR DISCUSSION

GENERAL NOTES:

1/. ALL AREAS WITHIN A DEVELOPMENT NOT OCCUPIED BY BUILDING, DRIVEWAY OR SERVICES AREAS

WILL REQUIRE TO BE LANDSCAPED. 2/.ALL EXISTING TREES ON THE SITE, ON THE NATURAL STRIP, AND CLOSE TO BOUNDARIES ON NEIGHBORING PROPERTIES SHOULD BE ACCURATELY PLOTTED ON PLANS PRESERVED IN ACCORDANCE WITH COUNCIL'S TREE PRESERVATION ORDER 3/.PROTECTIVE FENCING IS TO REMAIN IN PLACE UNTIL COMPLETION OF ALL BUILDING & HARD LANDSCAPE CONSTRUCTION. 4/.CONCRETE PAVING SHOULD BE 20MPA 100MM THICK FOR DRIVEWAYS, & 15MPA 75MM THICK FOR FOOTPATHS, PROVIDED ALL

- PAVING CONTROL JOINTS AT MAXIMUM 1800MM CENTRES. 5/. PAVING LEVELS SHALL BE A MAXIMUM 225MM BELOW SLAB FLOOR LEVELS TO 100MM MINIMUM IN
- LOCALIZED ARE SUCH AS DOORWAYS, & PROVIDED WITH 1:20 FALLS AWAY FROM THE BUILDING OTHER PAVING SHOULD BE USED WITH LENDING AUTHORITY APPROVAL. /.PROVIDED METAL, TIMBER OR MASONRY FENCING & GATES TO FRONT BOUNDARY INKEEPING WITH THAT ERECTED IN THE
- LOCALITY, PROVIDED SIDE & REAR BOUNDARY FENCING TO ENSURE PRIVACY & SAFETY. /.PROVIDED EXTERNAL LIGHTING FROM THE DWELLING TO ILLUMINATE THE ENTRANCE PATH & FRONT DOOR, REAR DOOR.
- PROVIDED CLOTHES DRYING LINE WITH PAVING FROM LAUNDRY TO CLOTHER-LINE PROVIDE A TAP STAND & GULLY TO THE FRONT & REAR OF THE DWELLING WHERE REQUIRED FIXED TO THE EXTERNAL WALL
- 0/. ALL LANDSCAPE WORKS ARE TO INCLUDE PROVISION FOR ADEQUATE DRAINAGE INCLUDING COLLECTION OR DISPERSAL OF STORM WATER RUN-OFF, PREVENTION OF PONDING OF WATER ON PAVEMENTS OR DISCHARGE OF RUN-OFF ONTO ADJOINING PROPERTY OR PUBLIC AREAS, WHERE POSSIBLE WATER SHOULD DRAIN TO PLANTING BEDS & LAWN AREAS AS A BASIC WATER CONSERVING STRATEGY

00. ALL LANDSCAPE CONSTRUCTION BE CARRIED OUT BY A QUALIFIED LANDSCAPE CONTRACTOR TO ENSURE THAT A SATISFACTORY STANDARD OF LANDSCAPING IS ACHIEVED.

SYMBOL	BOTANICAL NAME	PLANT NAME	CONTAINER SIZE (min)	QUANTITY	MATURITY HT/SPREAD
NCL	DICHOPOGON FIMBRIATUS	NODDING CHOCLATE LILY	5 Litre	12	0.5m -0.5m
FL	DIANELLA TASMANICA	FLAX LILY	5 Litre	4	0.45m - 0.05m
HEG	HEBE EMERELD GREEN	EMERELD GREEN HEBE	5 Litre	10	0.3m - 0.3m

MAIN TREE:

AS PER COUNCIL LANDSCAPE GUIDELINE WATER CUM TRISTANIOPISI LAURINA IS PROPOSED THIS TREE IS SELECTED FROM COUNCIL APPROVED LIST AND ILLUSTRATED IN C301

RECOMMENDATIONS FOR PLANTING TREES & SHRUBS

- IT IS ADVISABLE TO DIG A HOLE APPROXIMATELY TWICE THE SIZE OF THE POT THE PLANT IS IN
- THIS WILL GIVE THE PLANTS' ROOTS PLENTY OF ROOM TO SPREAD & DEVELOP
- TO ASSIST THE QUALITY OF SOIL DIG IN ORGANIC MATTER/COMPOST TO A DEPTH OF 200MM (IT IS NOT ADVISABLE TO GO DEEPER THAN THIS AS ORGANIC MATTER HAS TROUBLE BREAKING DOWN BEYOND THIS POINT AND CAN ACTUALLY RETARD PLANT GROWTH). ORGANIC MATTER WILL ENRICH SANDY SOILS & MAKE THEM MORE WATER RETENTIVE. IT WILL ALSO LOOSEN UP CLAY SOILS.
- BEYOND THIS POINT AND CAN ACTUALLY RETARD PLANT GROWTH). ORGANIC MATTER WILL ENRICH SAND
- WHEN PLANTING TREES BE SURE TO PLANT AT EXISTING SOIL LEVEL IF THE TRUNK IS COVERED WITH SOIL IT MAY ROT. IF THE ROOTS ARE EXPOSED THIS MAY LEAD TO THE DRYING OUT OF THE ROOT BALL.
- WATERING BOWLS' ASSISTS THE DIRECTION OF WATER ONTO THE ROOT ZONE AND MINIMIZES WASTAGE WHEN WATERING. WATERING BOWLS CAN BE MADE FROM LEFT OVER SOIL WHEN PLANTING.
- 'MULCHING AROUND PLANTS', SHRUB & TREES IS VERY EFFICIENT MAY TO KEEP THE ROOT ZONE COOL & MOIST IN SUMMER, HOWEVER KEEP IN MIND THAT MULCH MUST BE KEPT CLEAR OF THE TRUNK
- AREA AS THIS CAN LEAD COLLAR ROT & INSECT ATTACK. AFTER PLANTING WATER IN WELL & CONTINUE TO WATER ONCE A WEEK (3 TIMES A WEEK ON SUMMER)
- UNTIL THE PLANTS IS ESTABLISHED SEE TYPICAL DETAIL OF PLANTING

CLIENT / BUILDER / ARCHITECT CIVIL

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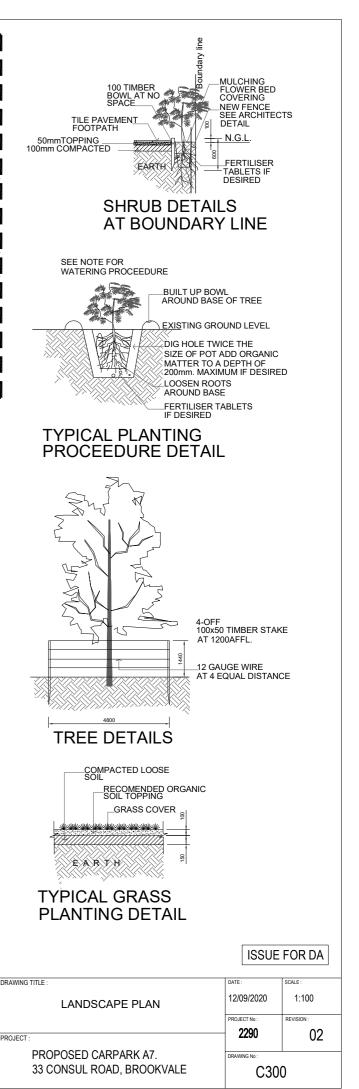
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ISSUE FOR DEVELOPMENT APPLICATION ISSUE FOR DEVELOPMENT APPLICATION

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Bronze Baby Flax

Phormium tenax Bronze Baby - botanical name



Evergreen erect tussock forming perennial (0.75m x 0.8m). Dwarf hybrid of P. tenax from New Zealand. Arching bronze purple strap-like sword shaped leaves. Red tubular flowers on erect stems in summer. Useful accent for its foliage contrast and vertical form. Suitable for coastal conditions. Prefers well drained soil in sun to semi-shade. Drought tolerant. Moderately frost tolerant.

Plant type	Perennial	
Sun/Shade tolerance	Full Sun, Part Shade	
Frost tolerance	Frost sensitive	
Soil type(s)	Sand, Loam	
Water rating	Low	
Plant origin	Non indigenous (New Zealand)	
Scale	Å	
	Wille W	

PLANT DESCRIPTION _ BRONZ BABY FLAX SOURCE : SYDNEY WATER

merald Green	Hebe	
ebe Emerald Gr	oon betwied some	
ebe Emerald G	Evergreen small compact shrub (0.3m	x 0.3m). Hybrid from New Zealand. Minute crowded green leaves. Insignificant flowers. Useful low border or iny site with we <mark>ll drained soil. Frost an</mark> d drought tolerant.
ALL ALL	Plant type	Shrub
	Sun/Shade tolerance	Full sun
	Frost tolerance	Frost hardy
	Soil type(s)	Sand, Loam, Clay
	Water rating	Low
	Plant origin	Non indigenous (New Zealand)
	Scale	

PLANT DESCRIPTION _ EMERALD GREEN HEBE SOURCE : SYDNEY WATER

Flax Lily

Dianella tasmanica - botanical name



Evergreen tufted perennial (0.45m x 0.5m) from NSW; Vic and Tas. Strap-like leaves; broadest of all Dianella species. Selected cultivar 'Emerald Arch' has broader arching leaves. Blue flowers with yellow anthers on branched stems in mid spring. Useful group planted as a border, understorey or for a tropical themed garden. Tolerates full sun to heavy shade. Frost and drought tolerant.

Plant type	Perennial	
Sun/Shade tolerance	Full Sun, Part Shade, Shade	
Frost tolerance	Frost hardy	
Soil type(s)	Sand, Clay, Loam	
Water rating	Low	
Plant origin	Non indigenous (NSW; Vic & Tas)	
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PLANT DESCRIPTION _ FLAX LILY SOURCE : SYDNEY WATER

DATE AMENDMENT CLIENT / BUILDER / ARCHITECT ISSUE 29.09.2020 ISSUE FOR DISCUSSION 00 02.10.2020 ISSUE FOR DEVELOPMENT APPLICATION 01 09.10.2020 ISSUE FOR DEVELOPMENT APPLICATION 02 APG

Nodding Chocola

Dichopogon fimbri




ate Lily	
iatus - botanical name	
with a tuft of dense fibres at the base. I	nial (0.5m x 0.4m) from NSW (including Sydney Cumberland Plain); Vic; SA and WA. Grass-like leaves surrounded Fragrant delicate mauve flowers with dark anthers on slender stems in spring. Two to six flowers on each stem ped in a rock or gravel garden or massed as understorey particularly in a bush garden or woodland setting. tolerant.
Plant type	Grass, Perennial
Sun/Shade tolerance	Full Sun, Part Shade
Frost tolerance	Frost hardy
Soil type(s)	Sand, Clay, Loam
Water rating	Low
Plant origin	Indigenous (NSW (Sydney Cumberland Plain); Vic; SA & WA)
Scale	à



PLANT DESCRIPTION _ NODDING CHOCLATE LILY SOURCE : SYDNEY WATER



TREE ILLUSTRATION _ WATER GUM_TRISTANIOPSIS- LAURINA SOURCE : SYDNEY WATER

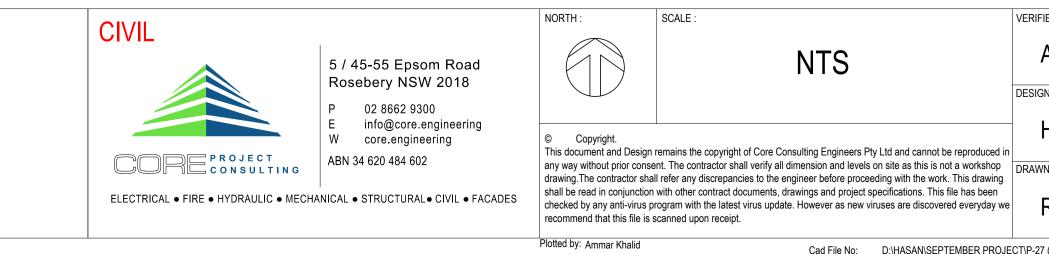



ISSUE FOR DA

RIFIED :	DRAWING TITLE :	DATE :	SCALE :
AC	PROPOSED PLANT	12/09/2020	N.T.S
SIGNED :		PROJECT No :	REVISION :
HR	PROJECT :	2290	02
WN :	PROPOSED CARPARK A7.	DRAWING No :	
RQ	33 CONSUL ROAD, BROOKVALE C301		1