DRAWING LIST

DRAWING NO.	DRAWING LIST
000	COVER PAGE
005	BASIX COMMITMENT
010	LOCATION PLAN
020	CUT&FILL PLAN
050	SITE ANALYSIS
120	GROUND FLOOR PLAN
130	LEVEL 1 PLAN
140	ROOF PLAN
200	ELEVATION
210	ELEVATION
300	SECTION
500	SHADOW DIAGRAM
510	SHADOW DIAGRAM
600	AREA CALCULATION
700	EXTERNAL FINISH SCHEDULE
800	PERSPECTIVE



DEVELOPMENT APPLICATION PROPOSED DWELLING AT LOT 02, 10 FERN CREEK ROAD, WARRIEWOOD

PREPARED FOR

SKYCORP AUSTRALIA

BASIX COMMITMENTS SUMMERY NOTES (TO BE READ IN CONJUNCTION WITH BASIX CERTIFICATE)												
	E	BASIX Certific	ate # 1266843S									
WATER	No hot water reticulation red	quired										
Fixtures	All shower heads	All toilets	All kitchen taps	All bathrooms taps								
Rating	3 Star(>4.5 But<=6L/Min)	4 star	5 star	5 star								
Alternate water sour	се											
Rain Water Tank	Туре	Size	Roof area connected	Connections								
	Individual RWT	2000L	100 m2	Outdoor tap for landscape only								
Swimming pool												
	Volume	Heated	Cover	Shaded								
ENERGY												
Hot water	Туре		Rating									
I	ndividual, gas instantaneous	3	5 star									
Mech. Ventilation	System		Operation Control									
Bath	Indiv. fan, ducted to facade	or roof	Manual Switch On/Off									
L'dry	Indiv. fan, ducted to facade	or roof	Manual Switch On/Off									
Kitchen	Indiv. fan, ducted to facade	or roof	Manual Switch On/Off									
Cooling System	Туре		Living areas	Bed rooms								
	1 Phase Air conditioning: Da	ay / Night Zoned	2.5 star (average zone)	2.5 star (average zone)								
Heating System	Туре		Living areas	Bed rooms								
	1 Phase Air conditioning: Da	ay / Night Zoned	2.5 star (average zone)	2.5star (average zone)								
Artificial Lighting	Primary type of artificial li	ghting is fluoresce	nt or light emitting diode (LE	D)								
	No. of Bed rms & study	No. of Living	Each Kitchen, Bath / Toilet	L'dry & Hallway								
	All	All	Yes	Yes								
Others	Indoor private Cloth Line		Not Required									
	Outdoor or sheltered Clot	h Line	Yes									
	Well ventilated Fridge spa	Ce	Yes									
	Kitchen Cook top / Oven		Gas Cook top + Electric Ov	en								
THERMAL	As per thermal simulati	on carried out b	y assessor									
	External Wall Insulation	n: R2.8										
stamped drawings)	Ceiling Insulation: R4.5	6										
			Colour (SA 0.475 - 0.7) + S	SS Foil (R1.3)								
	ALM-002-01 A: Aluminium B SG Clear / tint U=6.6 SHGC =0.441 - 0.539											
	All External doors & wi	ndows to be wea	ather sealed									
	Eaves / shading as per	drawings										

Main Office: Level 2, 68 Sophia Street, Surry Hills NSW 2010 Parramatta Office: Level 15, Deloitte Building, 60 Station Street, Parramatta NSW 2150 + 61 2 9283 0860 www.ptiarchitecture.com.au Nominated Registered Architect: Peter Israel (reg no 5064) ABN 90 050 071 022	 NOTE Contractors to verify all dimensions on site before any shop drawings or work is commenced. Figured dimensions to be taken in preference to scaled dwgs. This drawing is to be read in conjunction with the specification and engineers drawings. This drawing is the copyright of PTI Architecture Pty Ltd and may not be altered, reproduced or transmitted in any form or by any means, in part or				~	development application Survey issue		KC/PI 08.11.21 (GF/PI 11.11.21	SKYCORP AUSTRALIA	PROJECT LOTO2,10 FERN WARRIEWOOD DRAWING BASIX COMMIT
	in whole without the written permission of PTI Architecture Pty Ltd.	REV	DESCRIPTION	BY CHK DATE	REV	DESCRIPTION	BY	CHK DATE		

DAGIY COMMITMENITE CLIMMEDV NOTES

	NORTH	DRAWN		CHECKED	
CREEK ROAD,		DL, KC		PI/k	KC
)		PROJECT NO P563		SCALE @A1	
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		disc	stage.	dwg no.	revision

K:\PTI 2019\P563 - 10 Fern Creek Road & 6 - 6A Orchard Street, Warriewood\10_DRAWINGS (PTI)\00_STAGE - SK\01_PLN\20210608_Lots with new survery\20210713_lot02_NEWDA_2.pln Printed: 9/12/2021







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work is commenced.2. Figured dimensions to be taken in preference to scaled dwgs.3. This drawing is to be read in conjunction with the specification and engineers drawings.

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 REV

			A	DEVELOPMENT APPLICATION	DL	KC/PI	08.11.21	CLIENT	PROJECT
			В	SURVEY ISSUE	DL	GF/PI	11.11.21	SKYCORP AUSTRALIA	LOT02,10 FERN
									WARRIEWOOD
									LOCATION PLA
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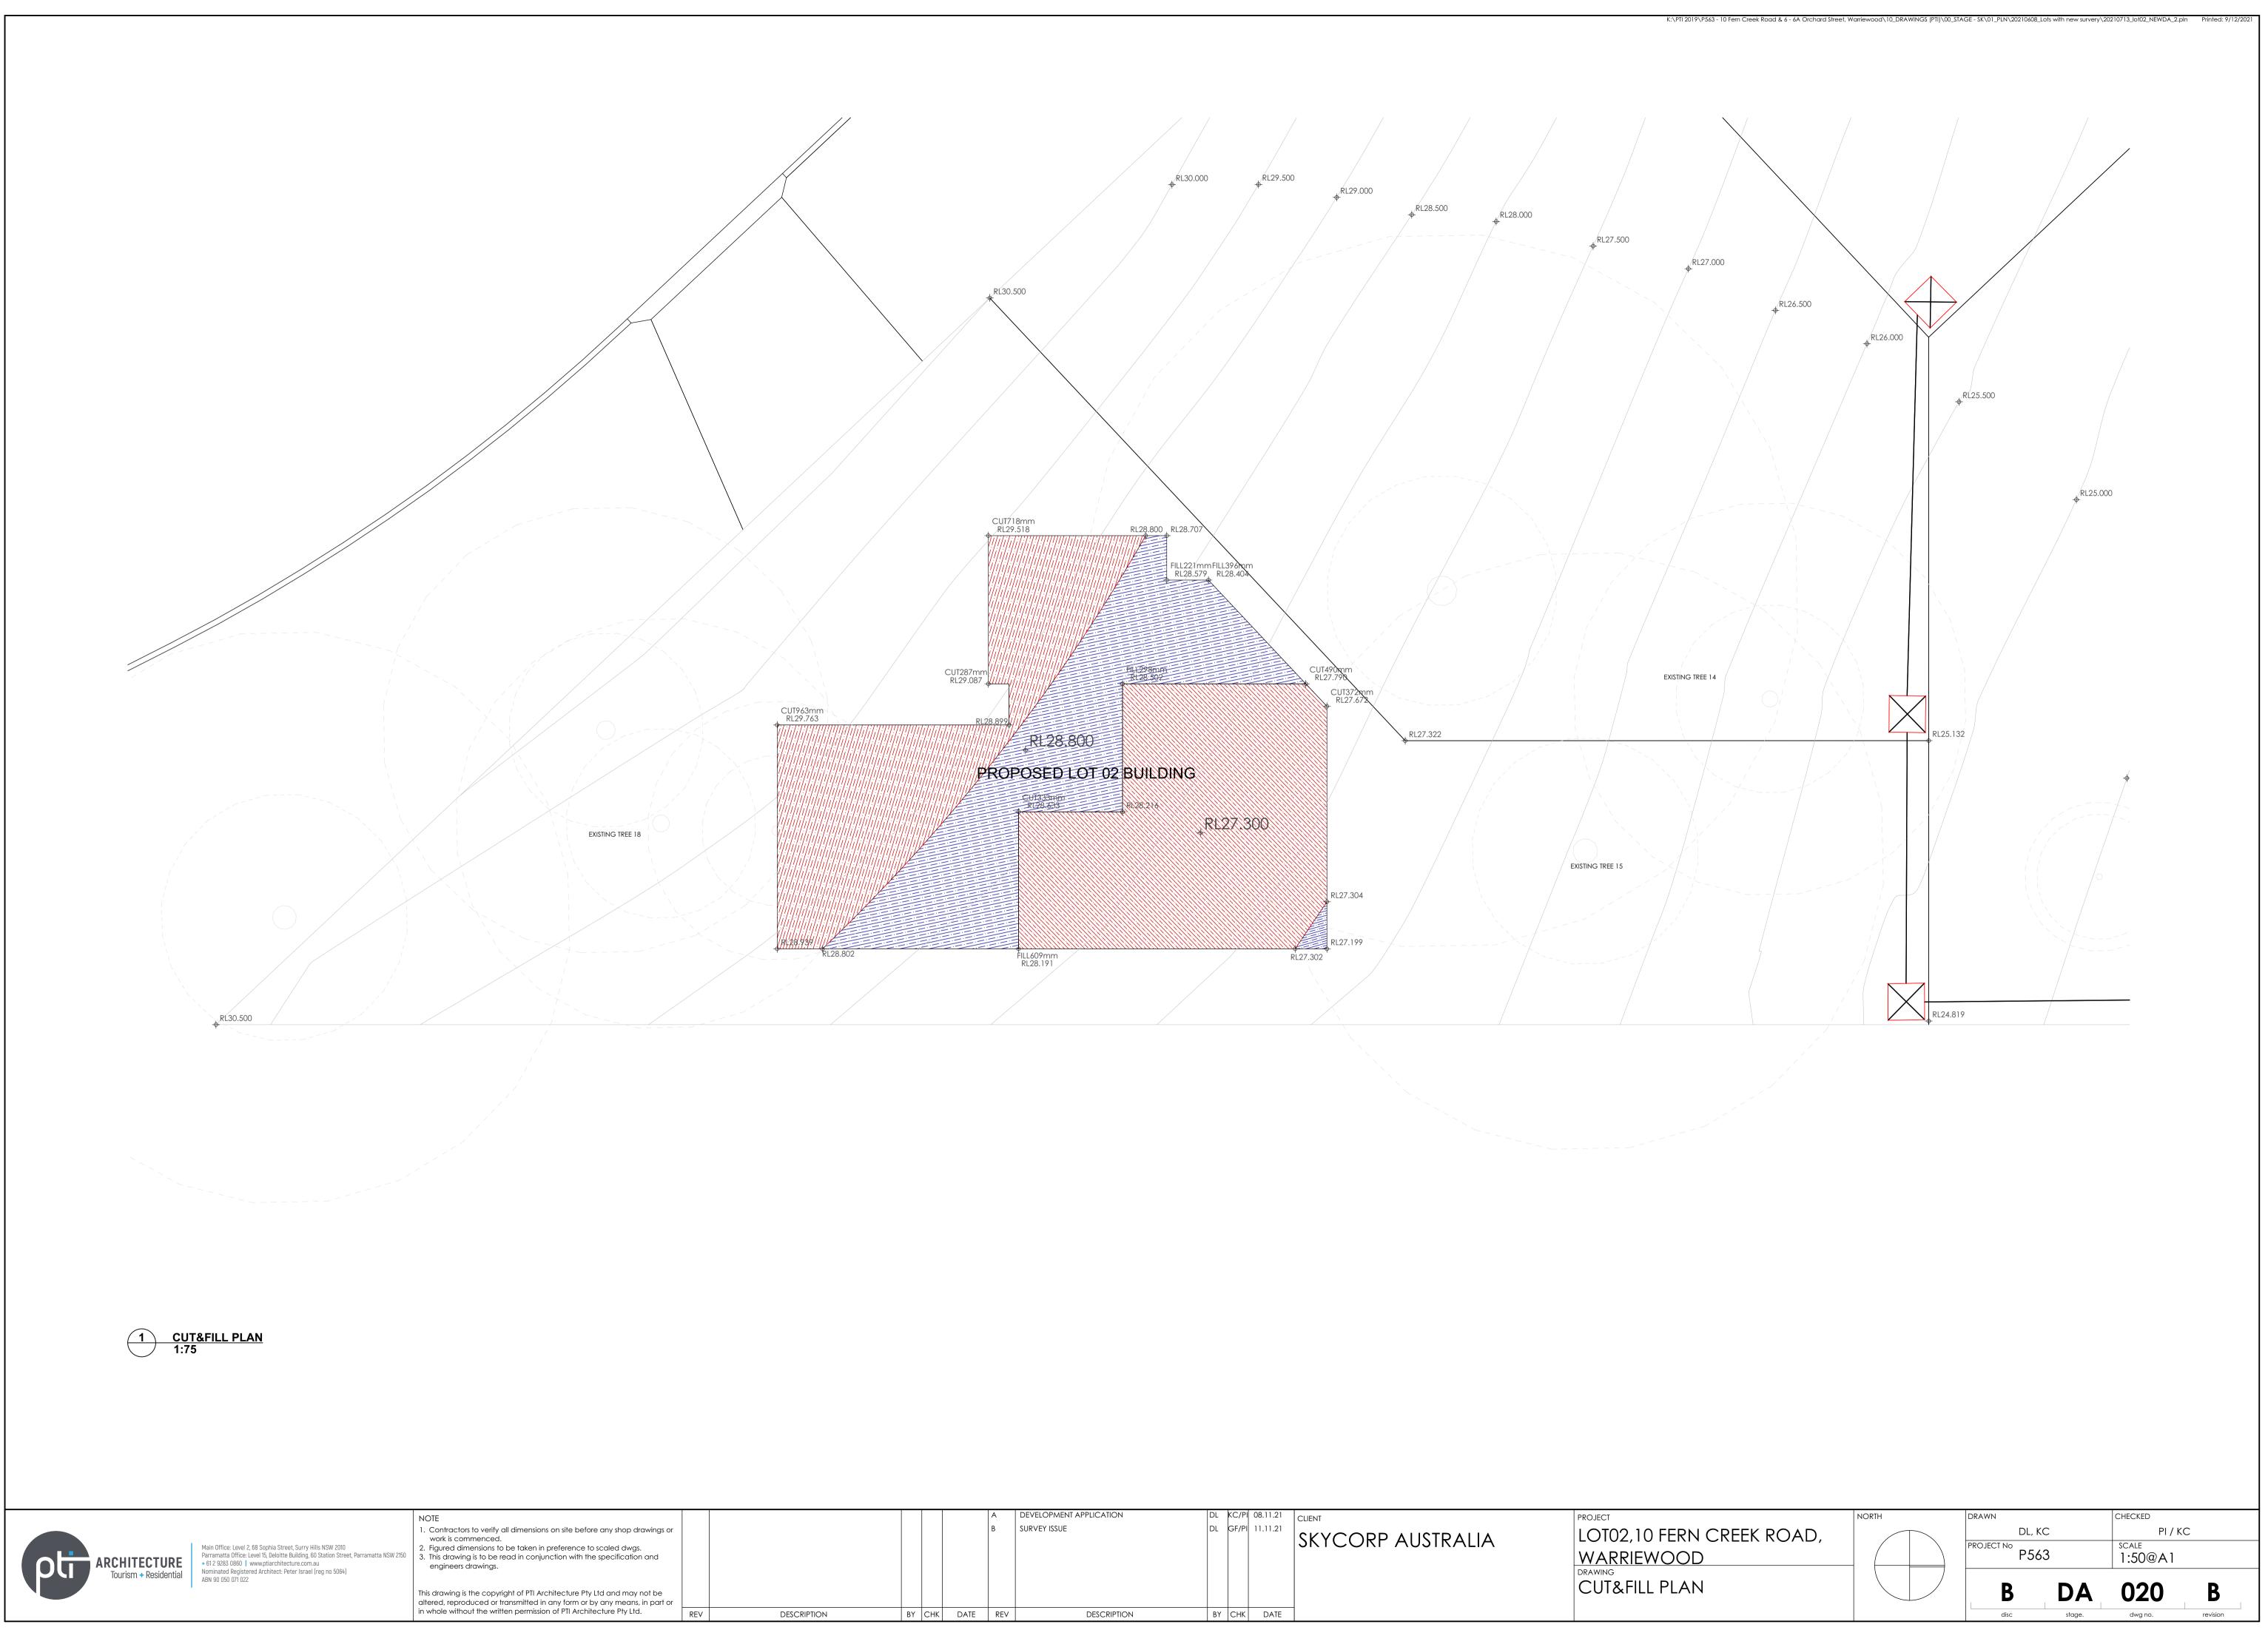
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 P563
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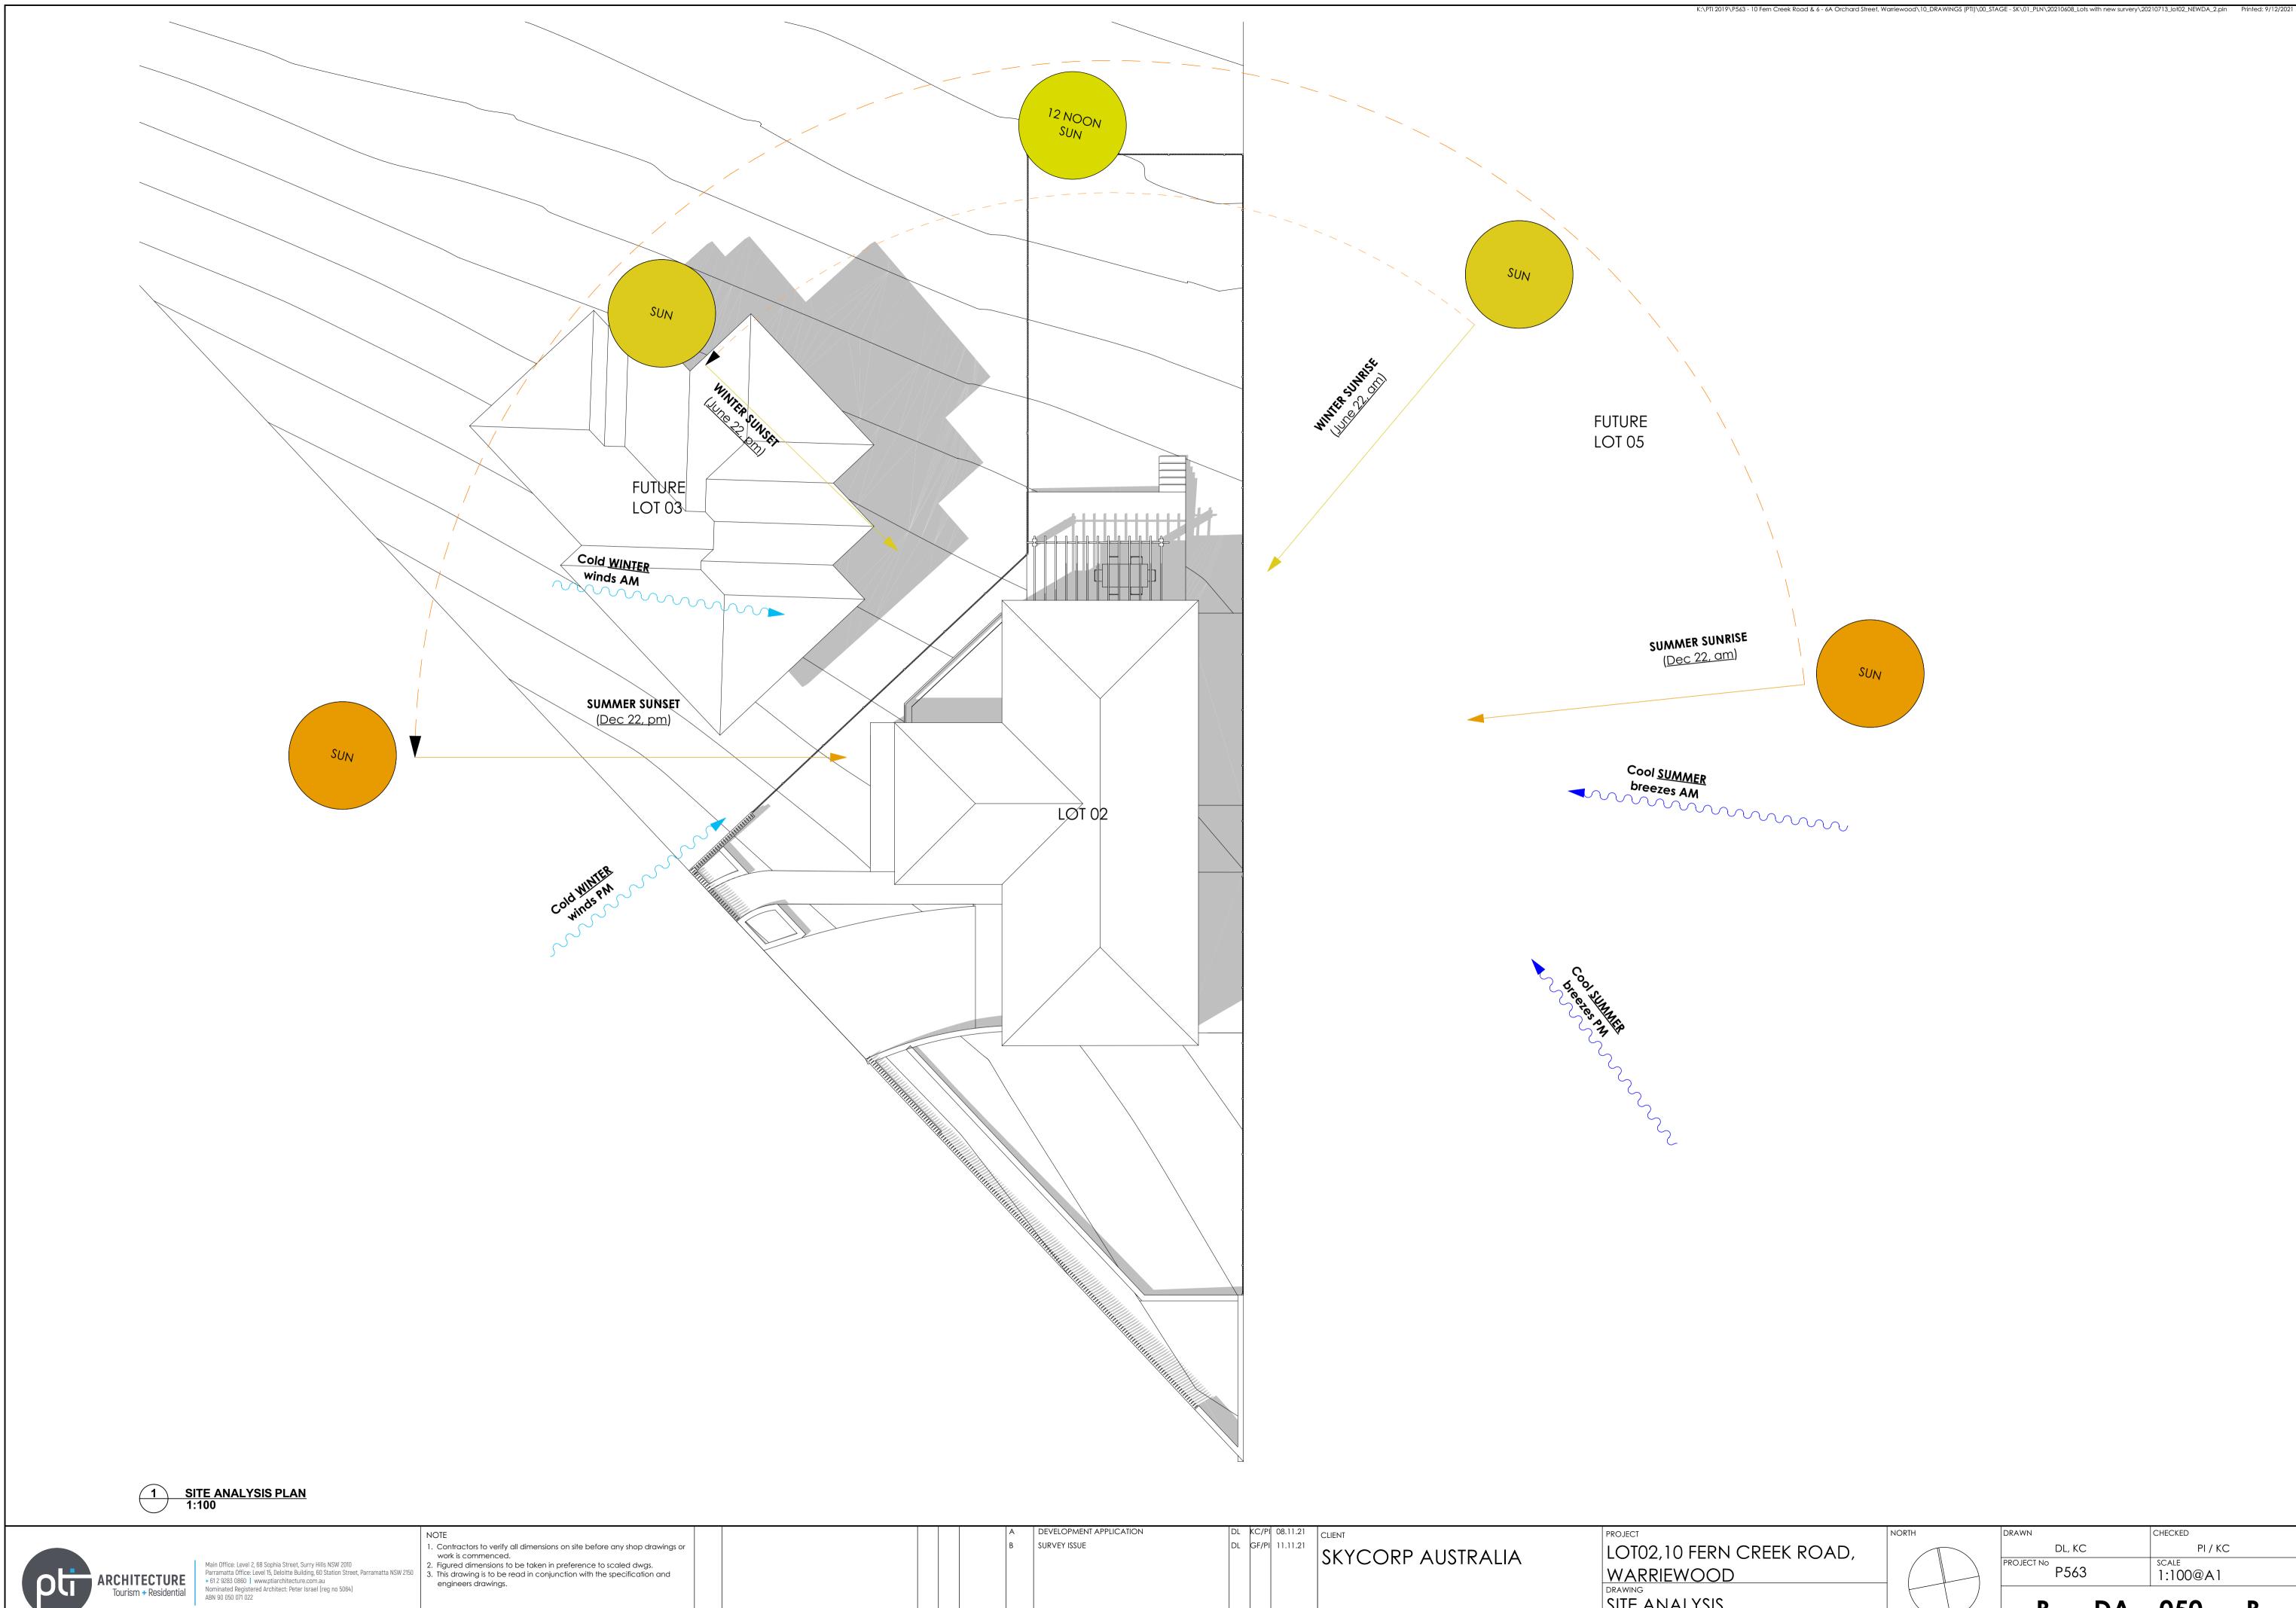
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			A B	DEVELOPMENT APPLICATION SURVEY ISSUE	DL	KC/PI GF/PI	08.11.21	SKYCORP AUSTRALIA	PROJECT LOTO2,10 FERN (WARRIEWOOD DRAWING CUT&FILL PLAN
BY	СНК	DATE	REV		BY	СНК	DATE		



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				В	SURVEY ISSUE	DL	GF/PI	11.11.21	SKYCORP AUSTRALIA	LOT02,10 FERN C WARRIEWOOD Drawing SITE ANALYSIS
1	BY	СНК	DATE	REV	DESCRIPTION	BY	СНК	DATE		

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			А	DEVELOPMENT APPLICATION	DL	KC/PI	08.11.21	CLIENT	PROJECT
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LEVEL 1 PLAN 1:75 1)-

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 ARCHITECTURE


 Tourism + Residential

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NOTE


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											WARRIEWOOD
											DRAWING
											LEVEL 1 PLAN
1	BY	СНК	DATE	REV	DESCRIPTION	BY	СНК		DATE		




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				A B	DEVELOPMENT APPLICATION SURVEY ISSUE		1 1	08.11.21	SKYCORP AUSTRALIA	PROJECT LOTO2,10 FERN C WARRIEWOOD DRAWING ELEVATION
ON	BY	СНК	DATE	REV	DESCRIPTION	BY	СНК	DATE		

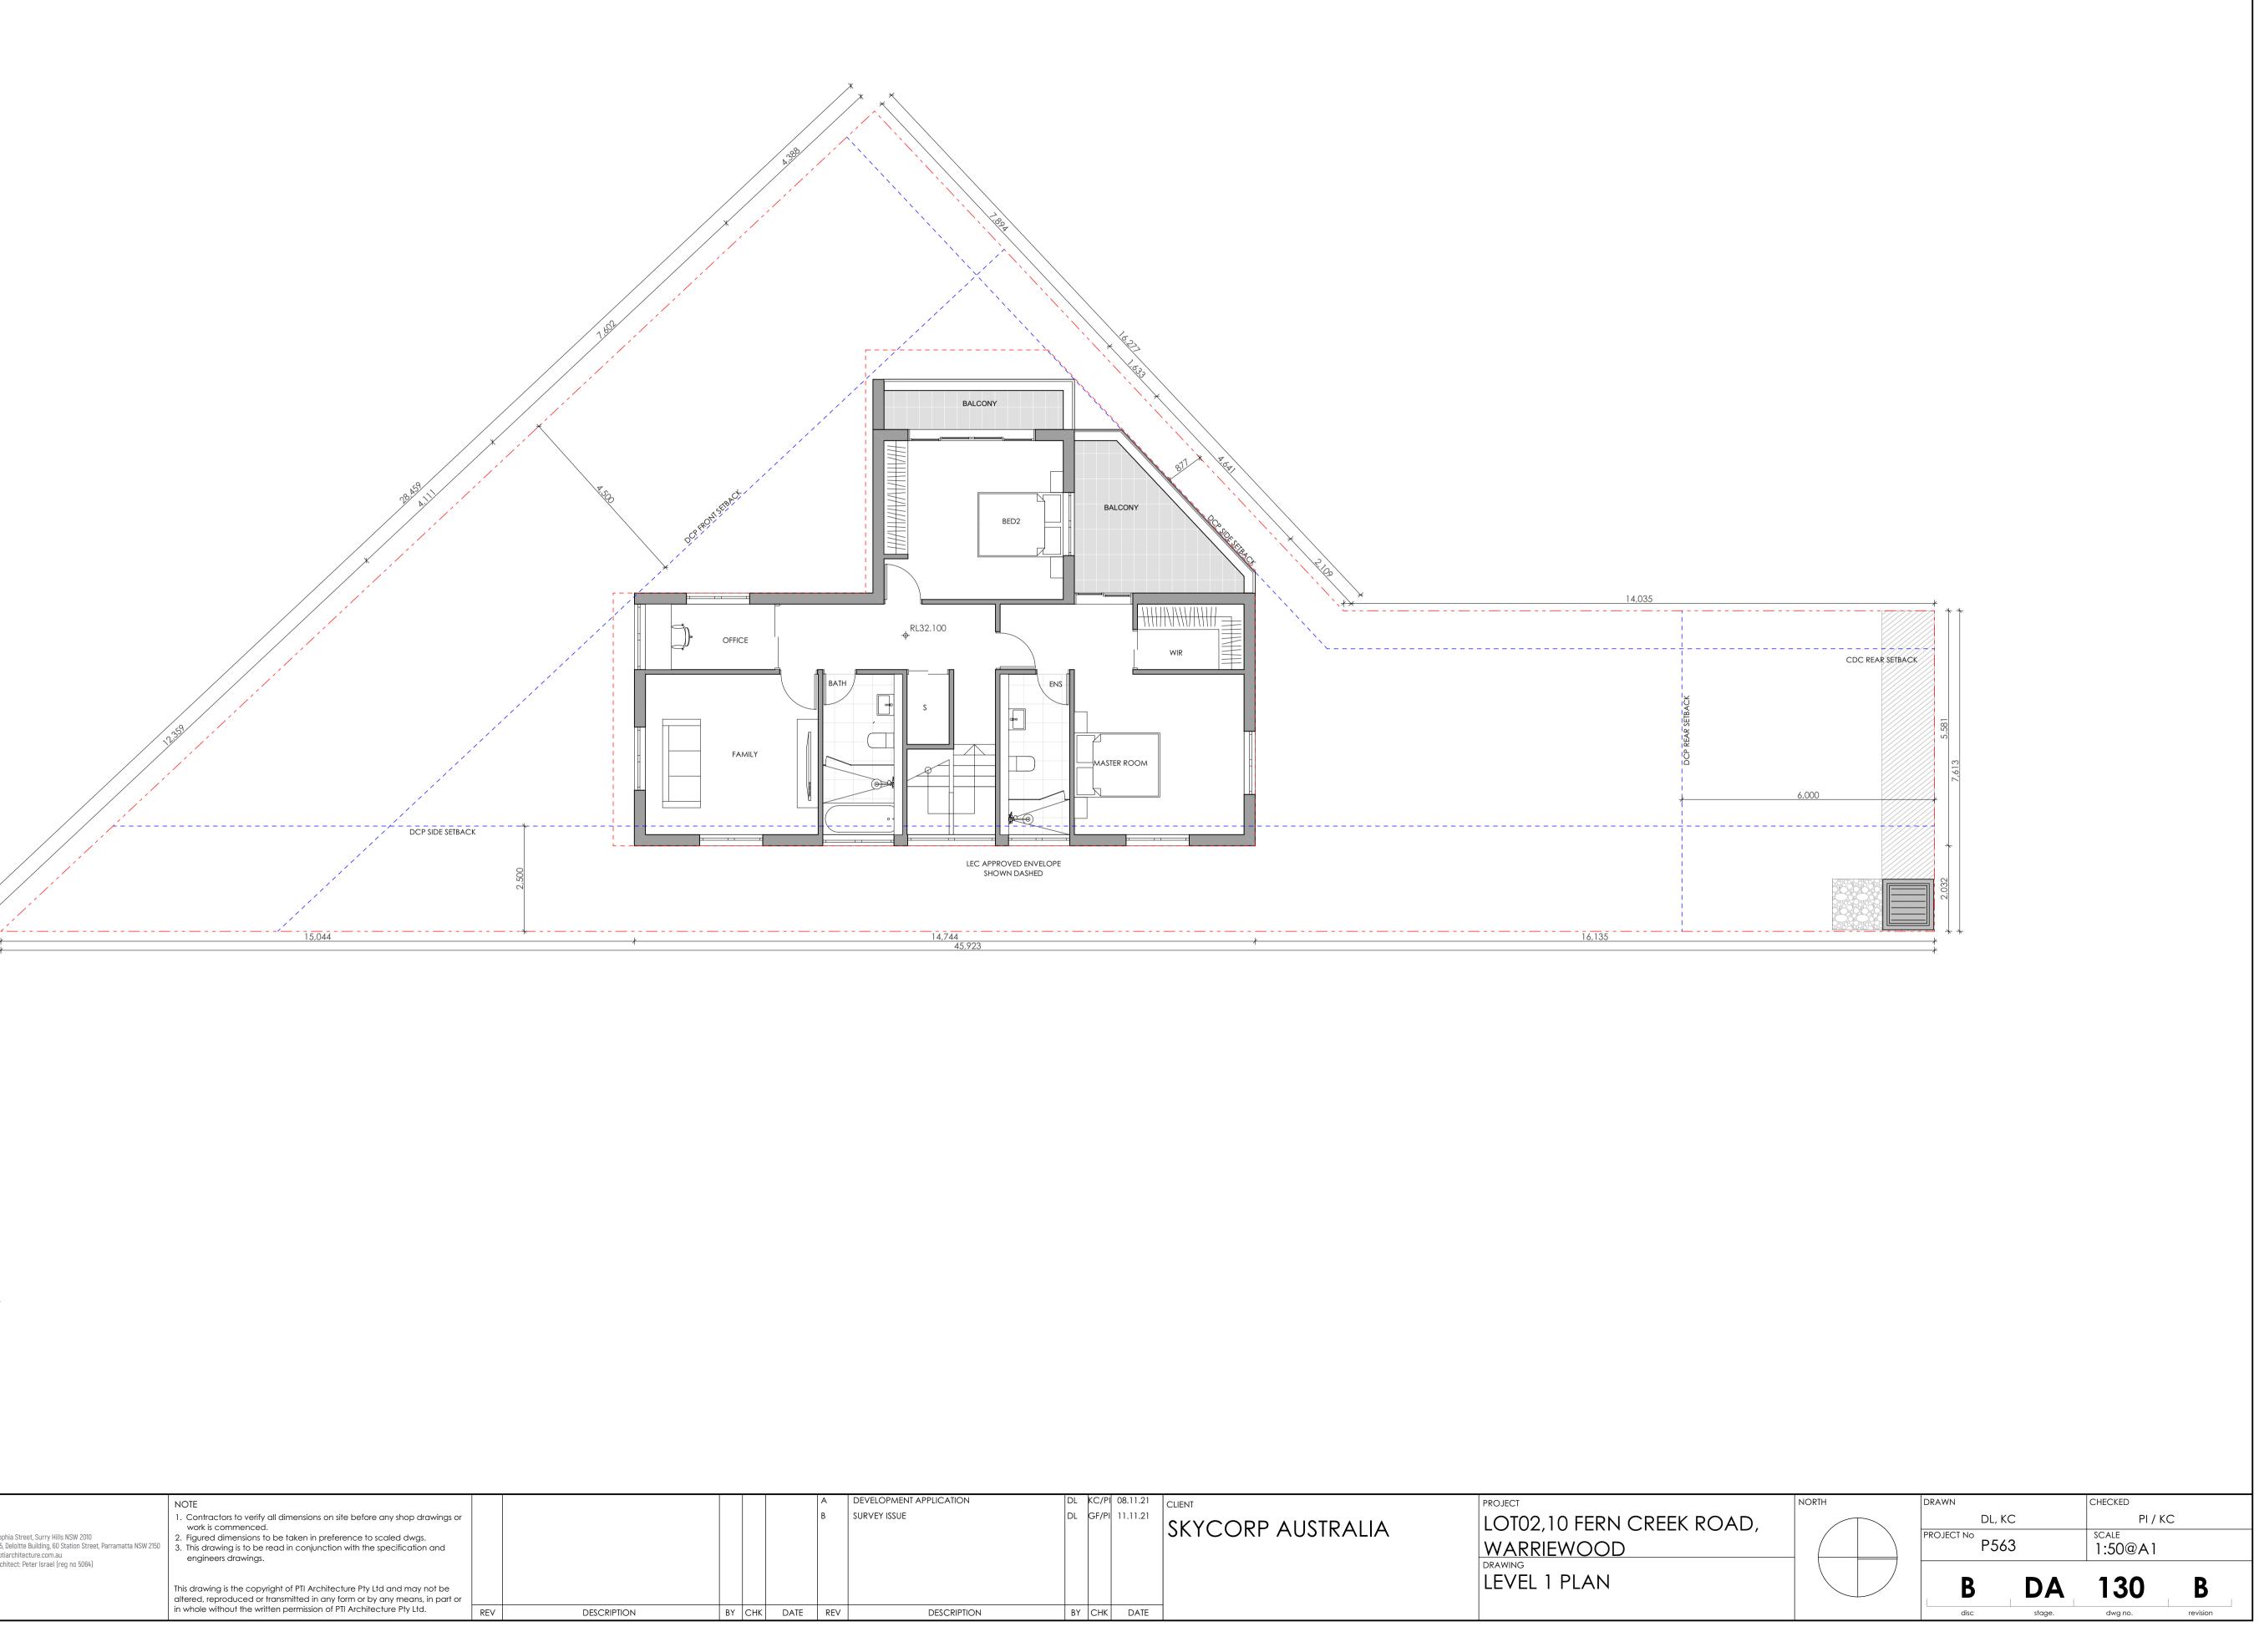

			K:\PTI 2019\P563 - 10 Fern Creek Road & 6 - 6A Orchard Street	, wanewood (10_DkAwings (Pii) (00_SIAGE - Sk (01_PLN (20210606_LOIS with new Suiv	ery\20210713_lot02_NEWDA_2.pln Printed: 9/12/2021
	10.5m DCP MAX. HEIGHT OF E	UILDING 	BOUNDARY		
		W18 927 × 800			
CL 34.900		W12 1,5 5 x 1, 00 W22 1 800 x VATURAL GROUND LINE AT BUILD			
N BY CHK DATE REV		SKYCORP AUSTRALIA	PROJECT LOTO2,10 FERN CREEK ROAD, WARRIEWOOD DRAWING ELEVATION	NORTH DRAWN DL, KC PROJECT No P563 BDA disc stage.	CHECKED PI / KC SCALE 1:100@A1 210 B dwg no. revision

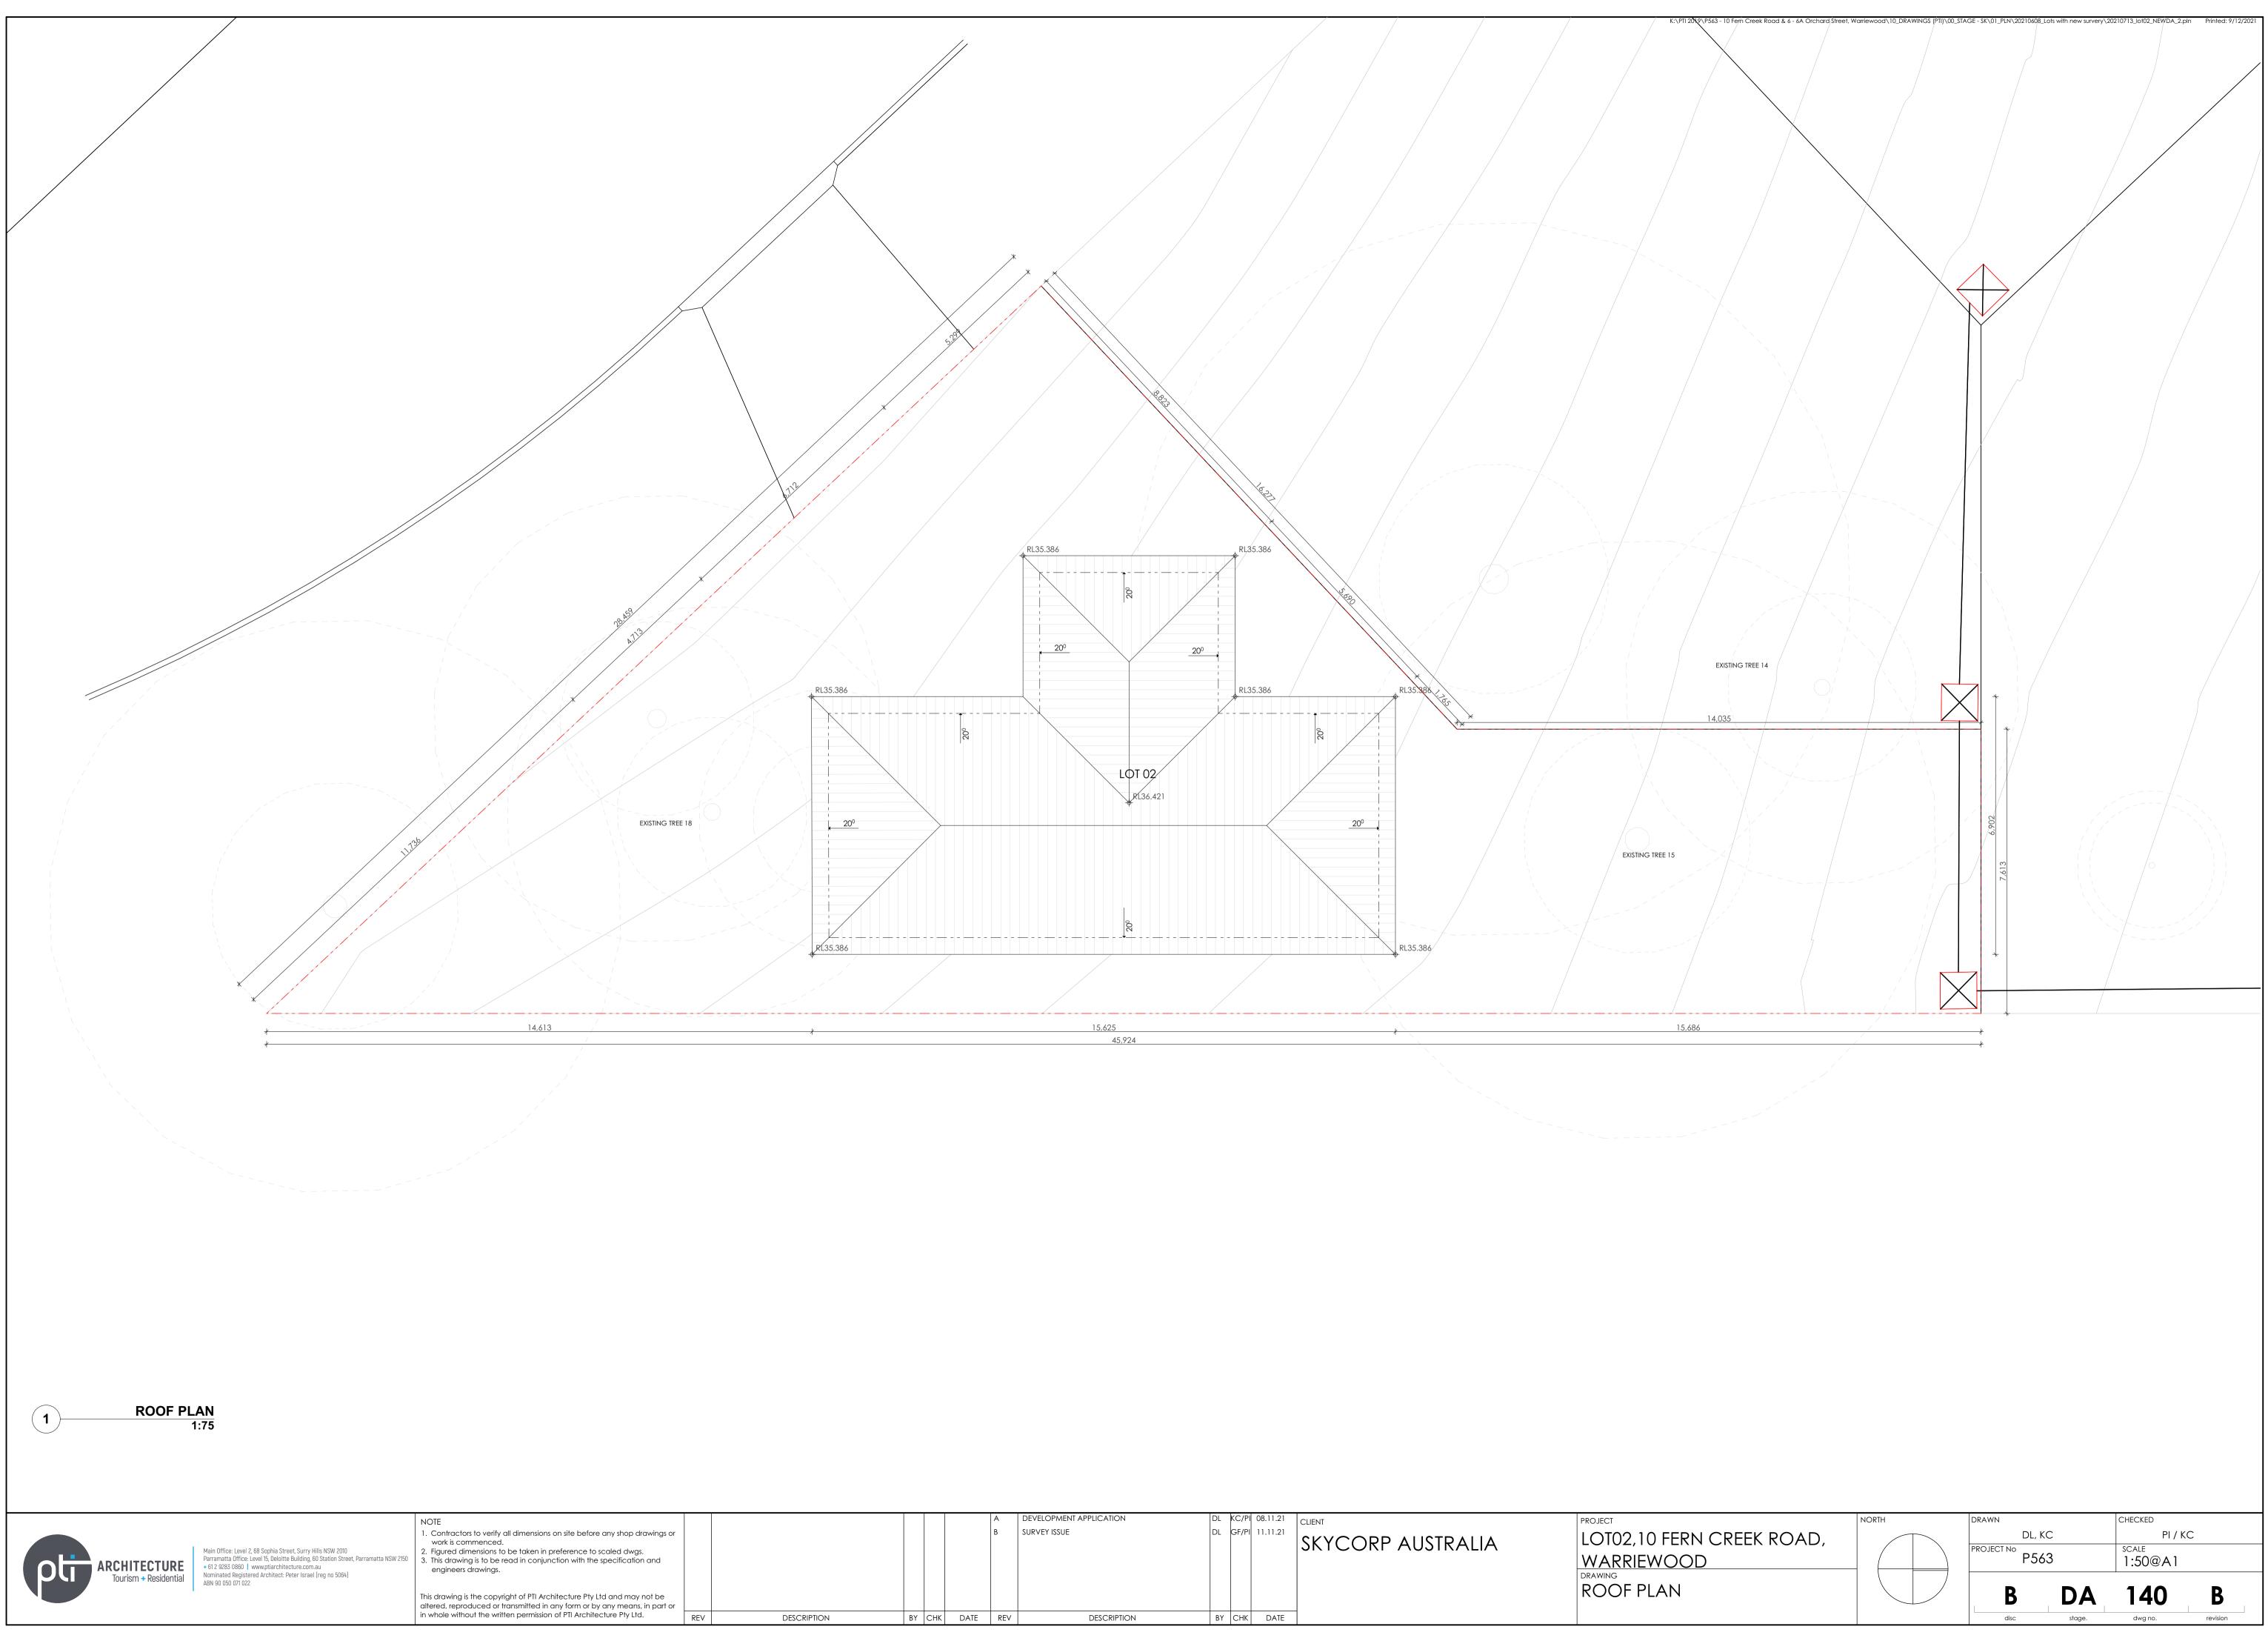




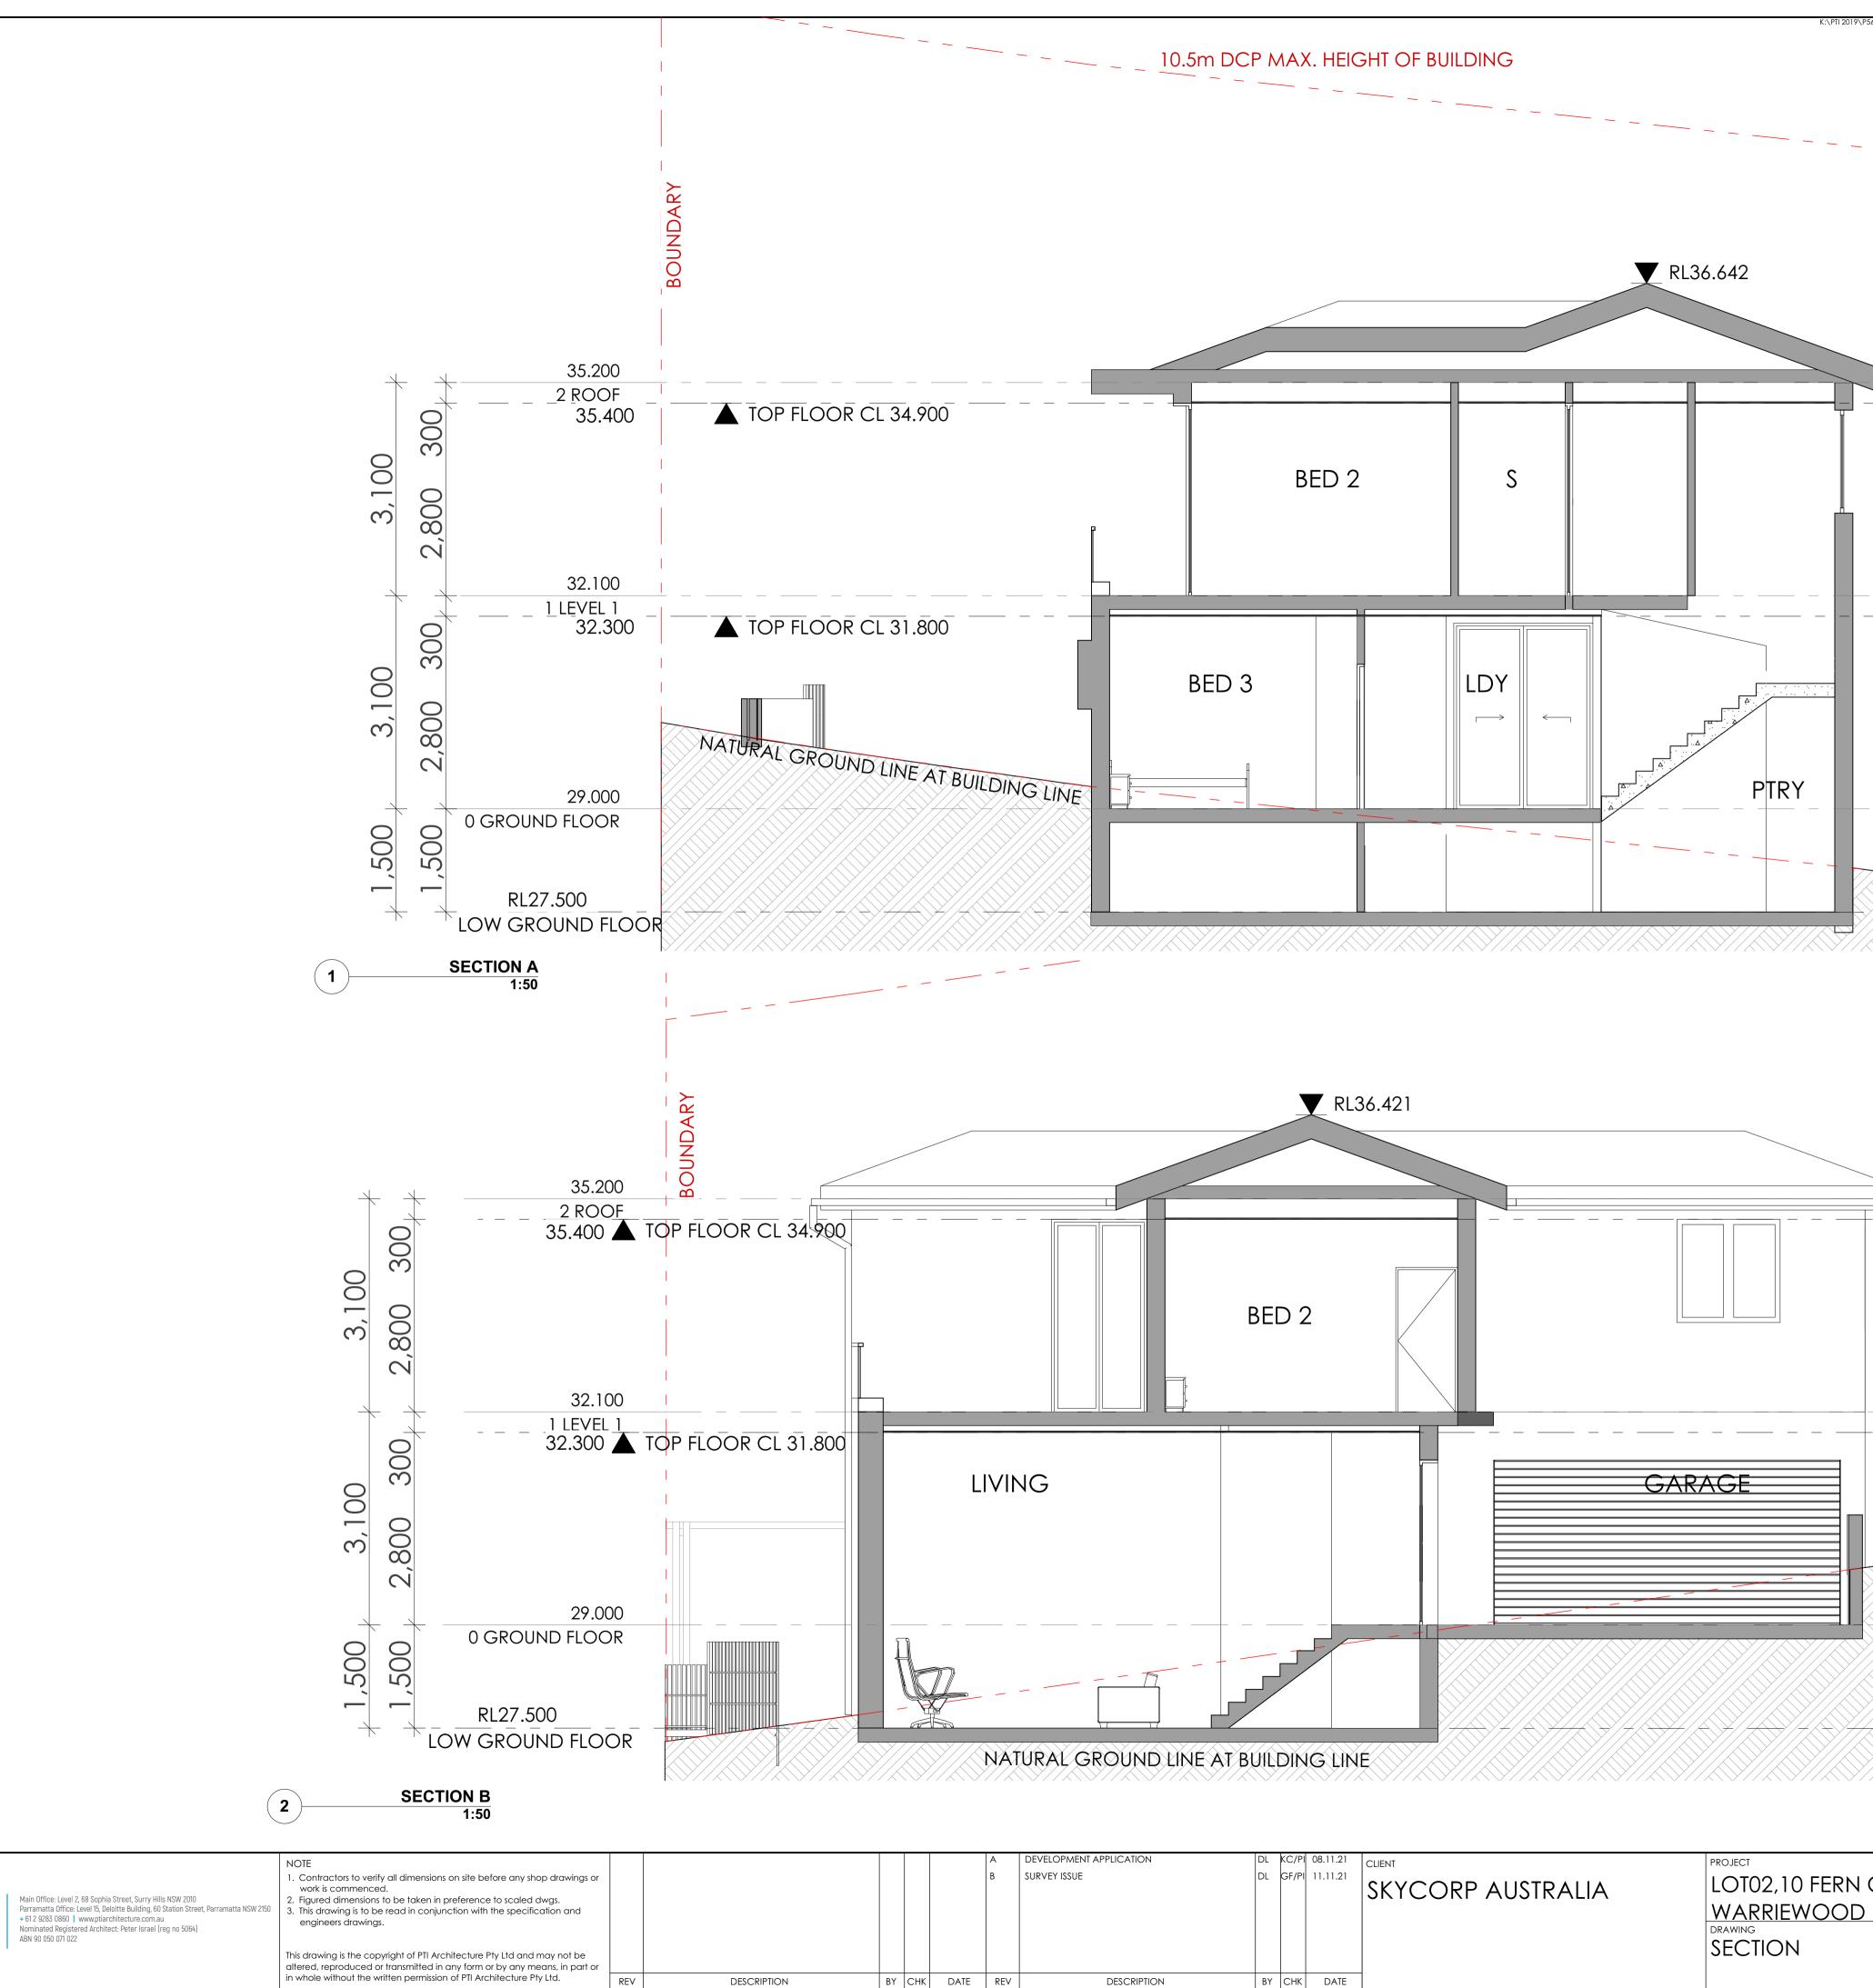

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\P563 - 10 Fern Creek Road & 6 - 6A Orchard Street, Wo	arriewood\10_DRAWINGS (PTI)\00_STA	GE - SK\01_PLN\20210608_Lots v	vith new survery\202107	13_lot02_NEWDA_2.pln	Printed: 9/12/2021
BOUNDARY					
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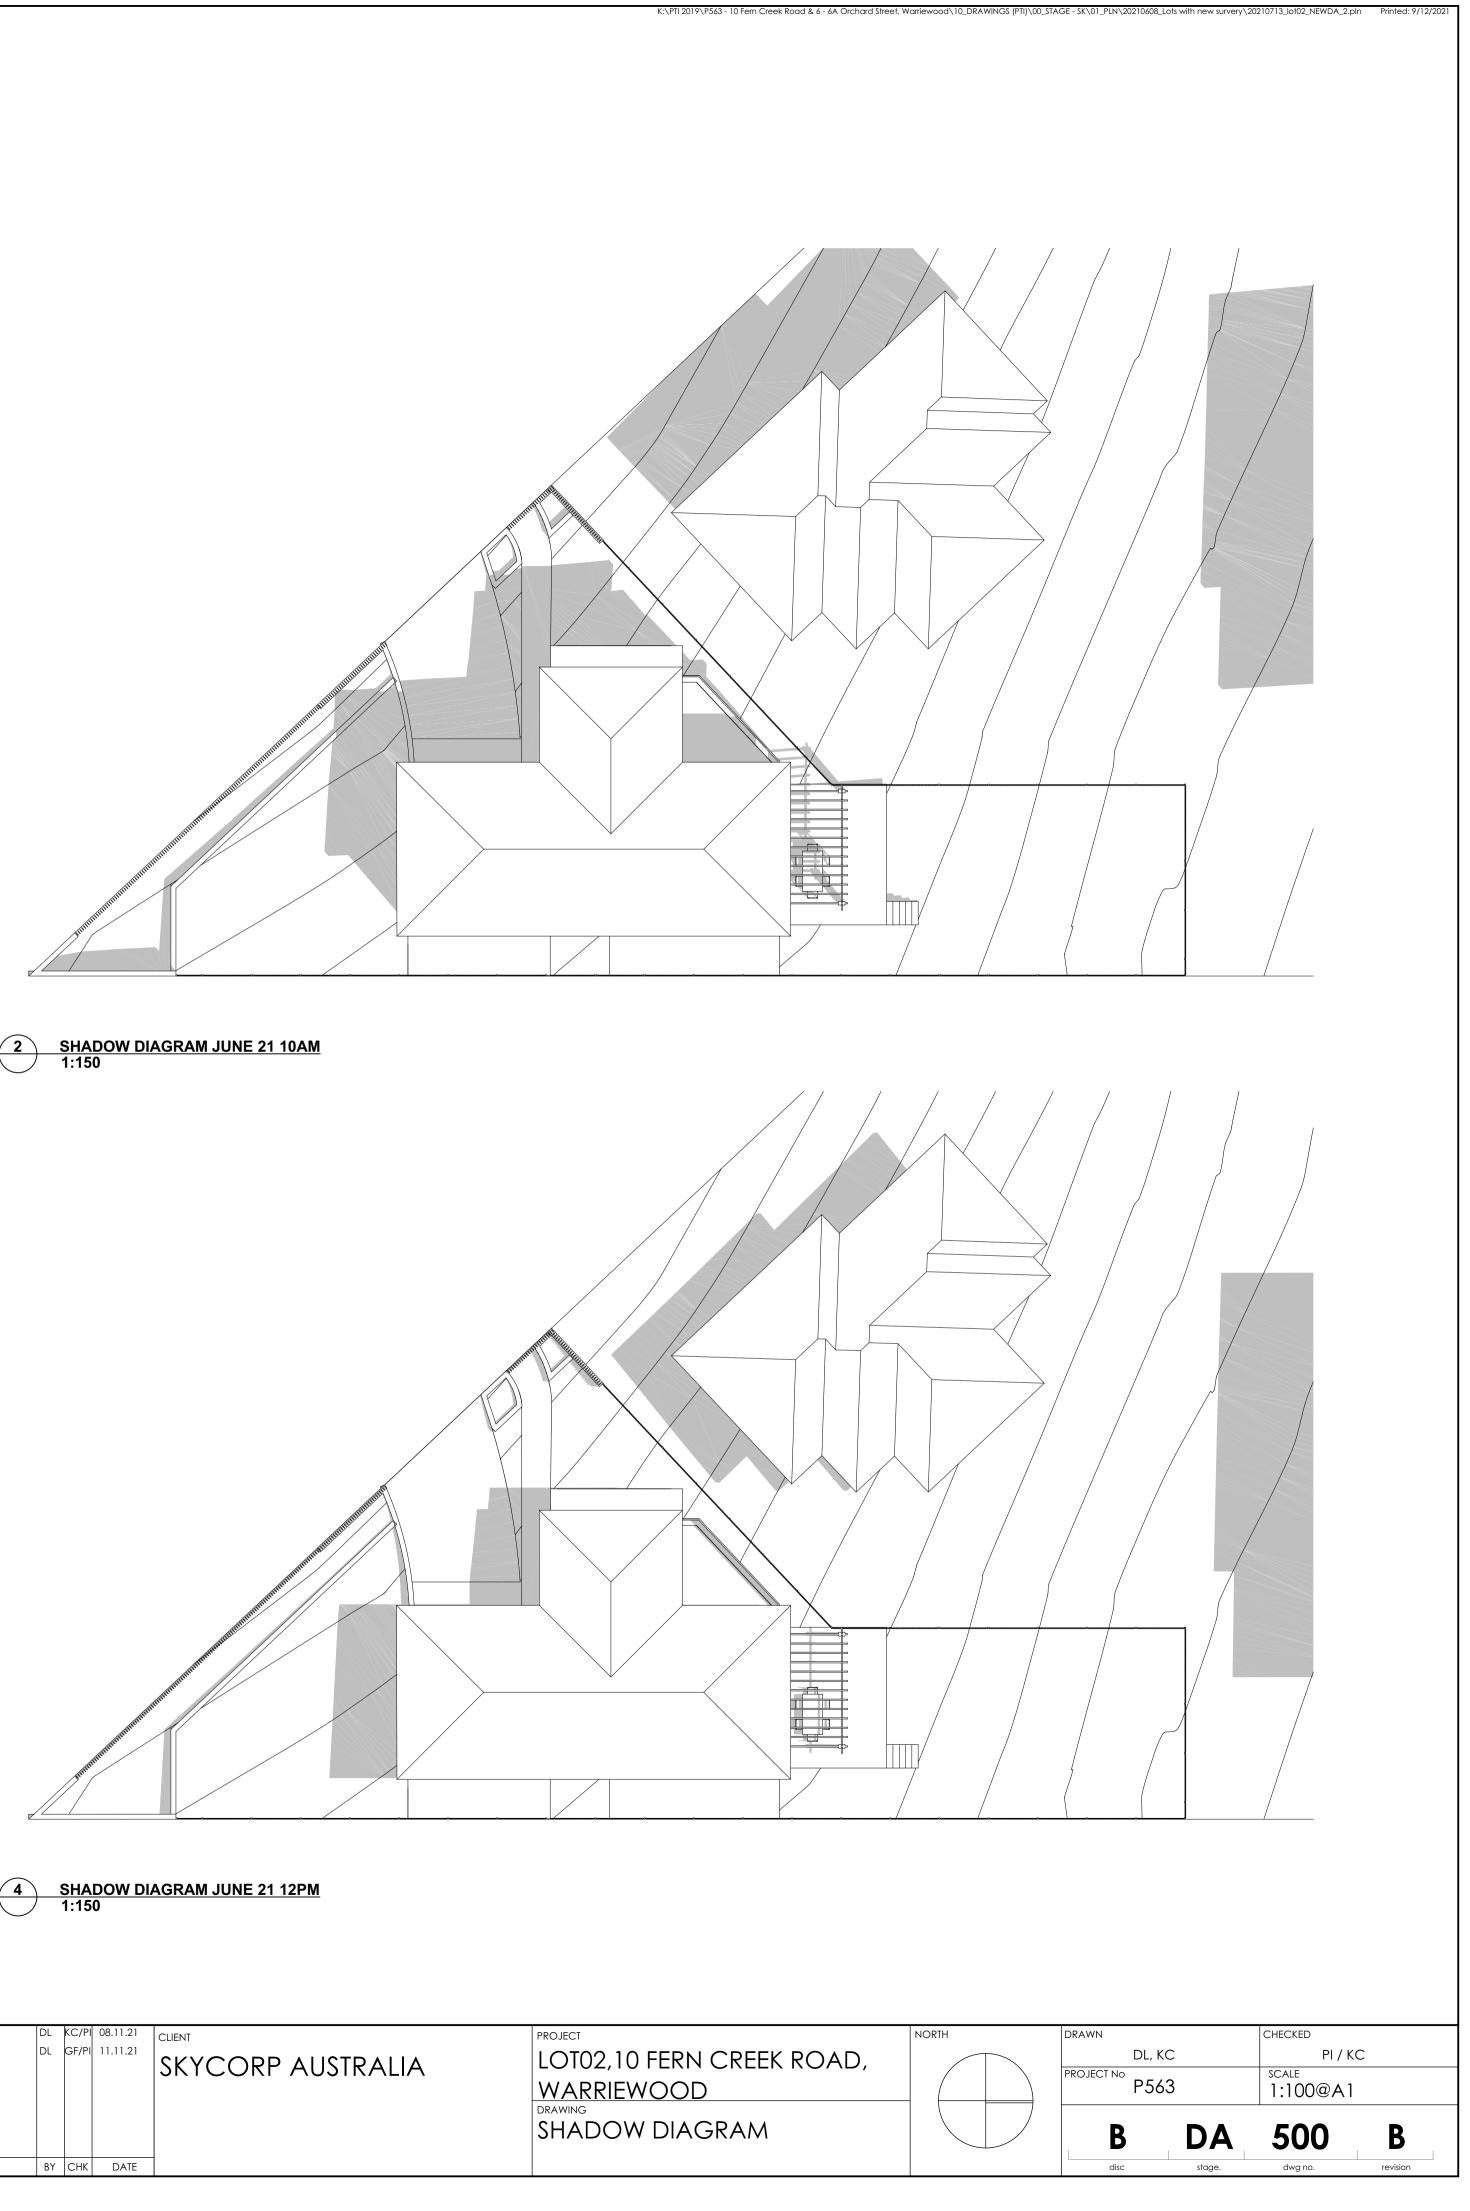


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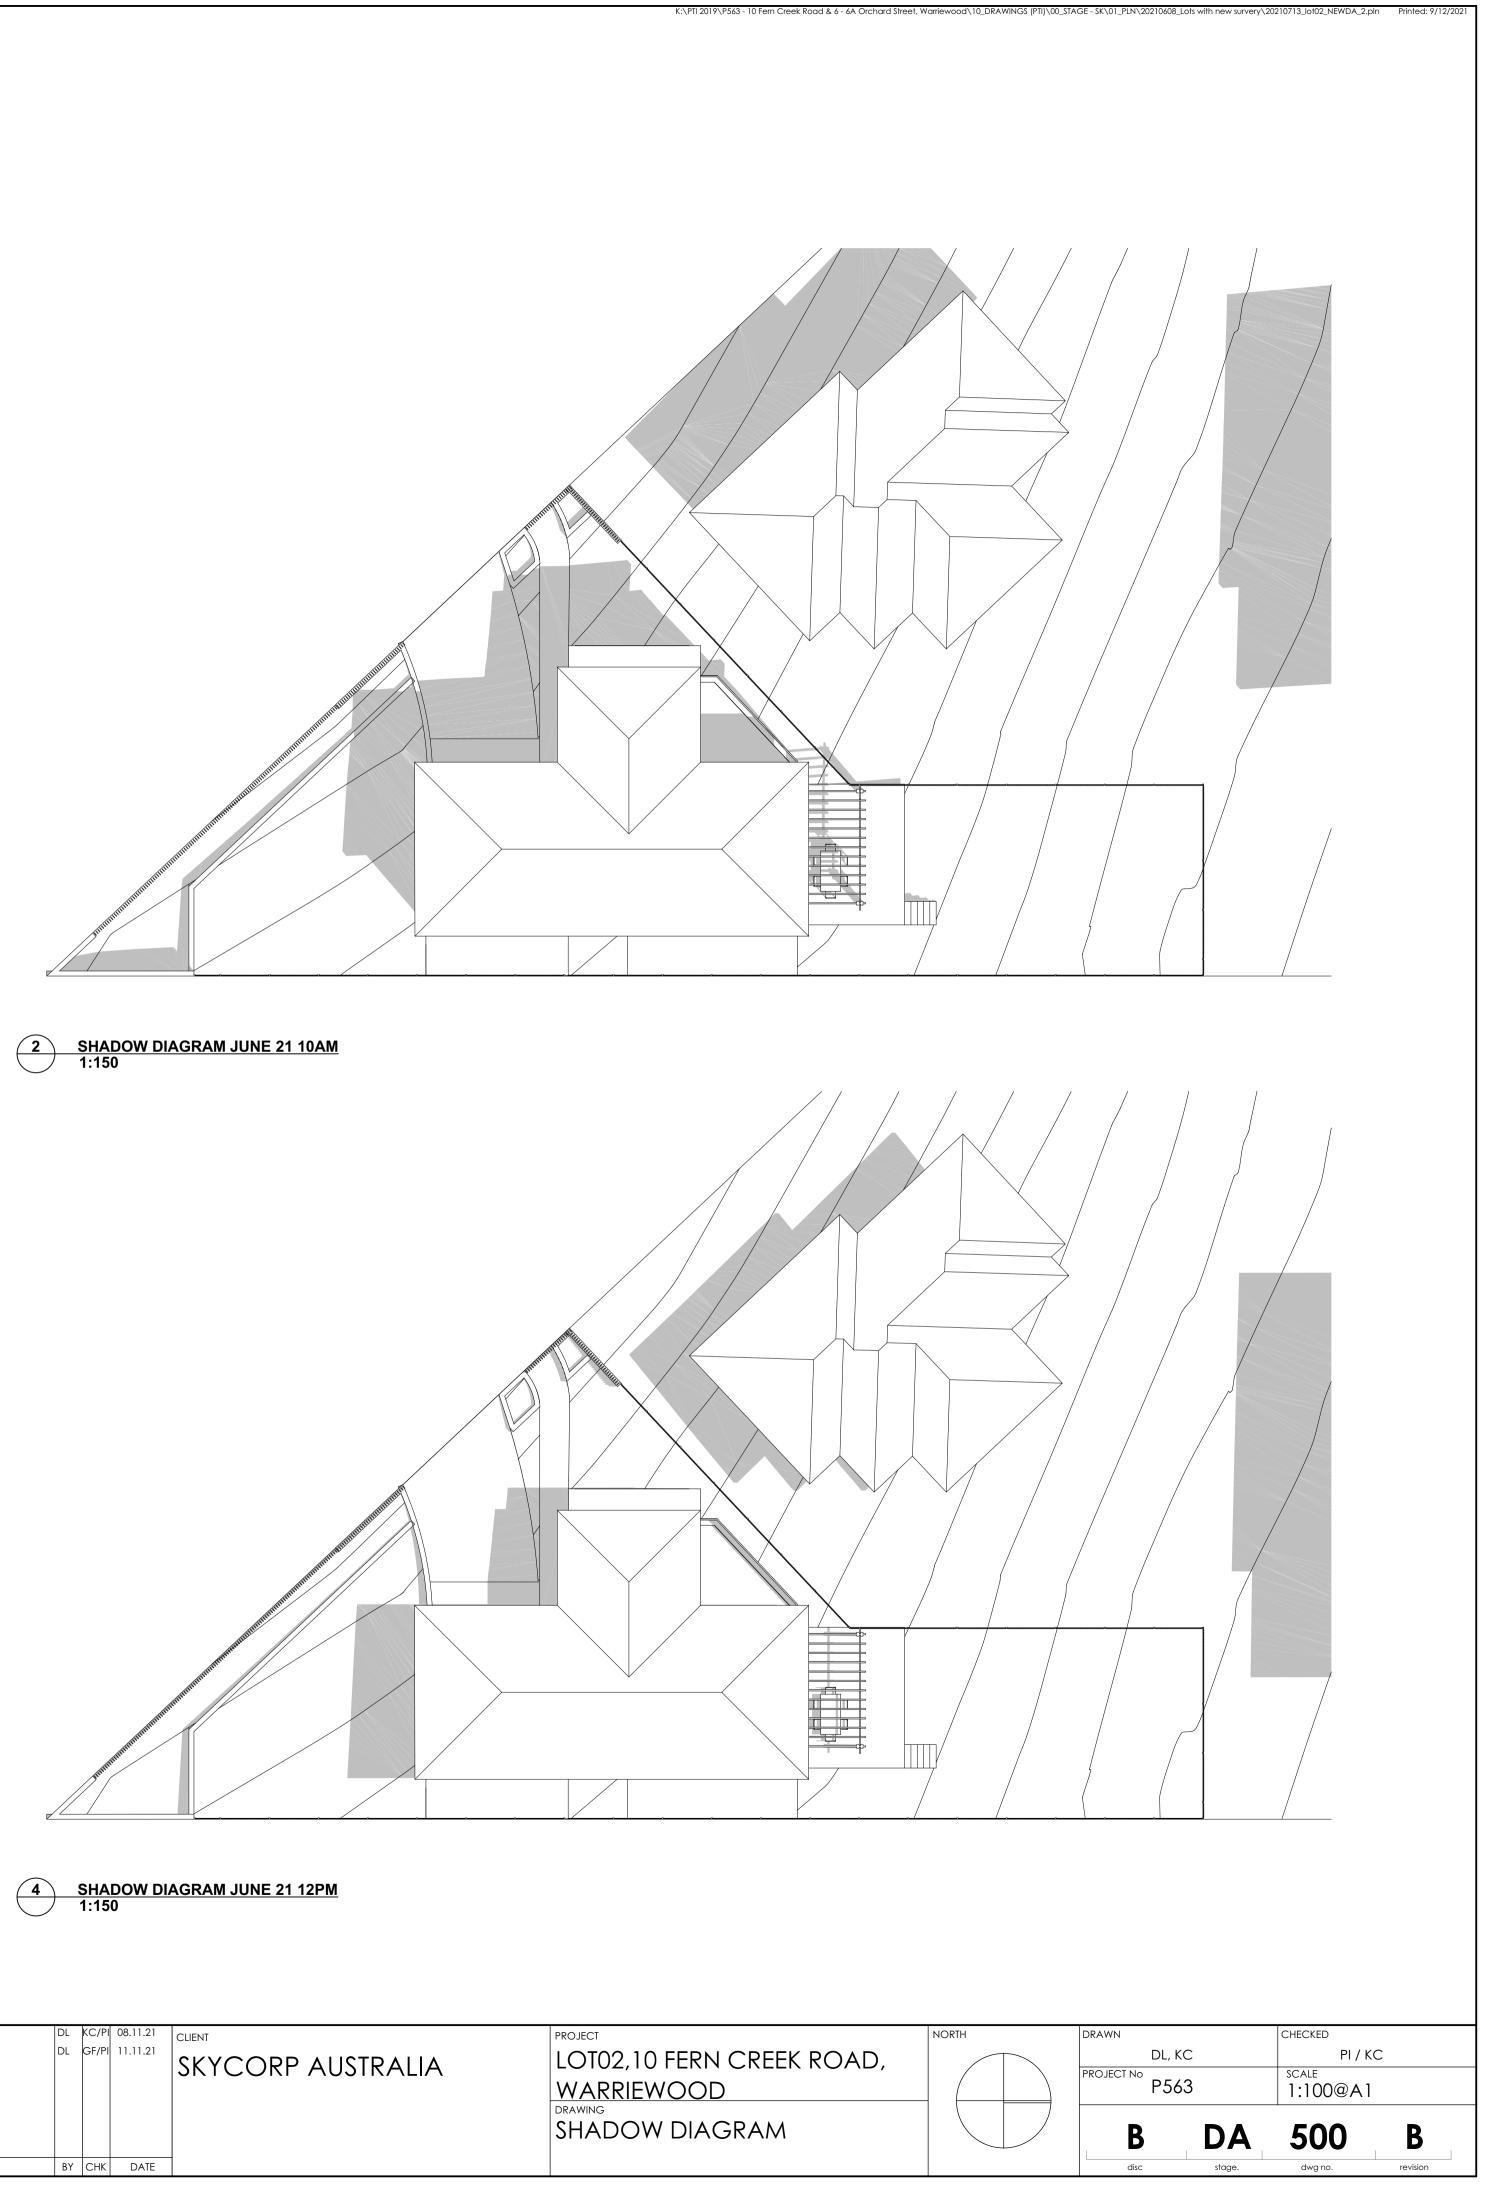
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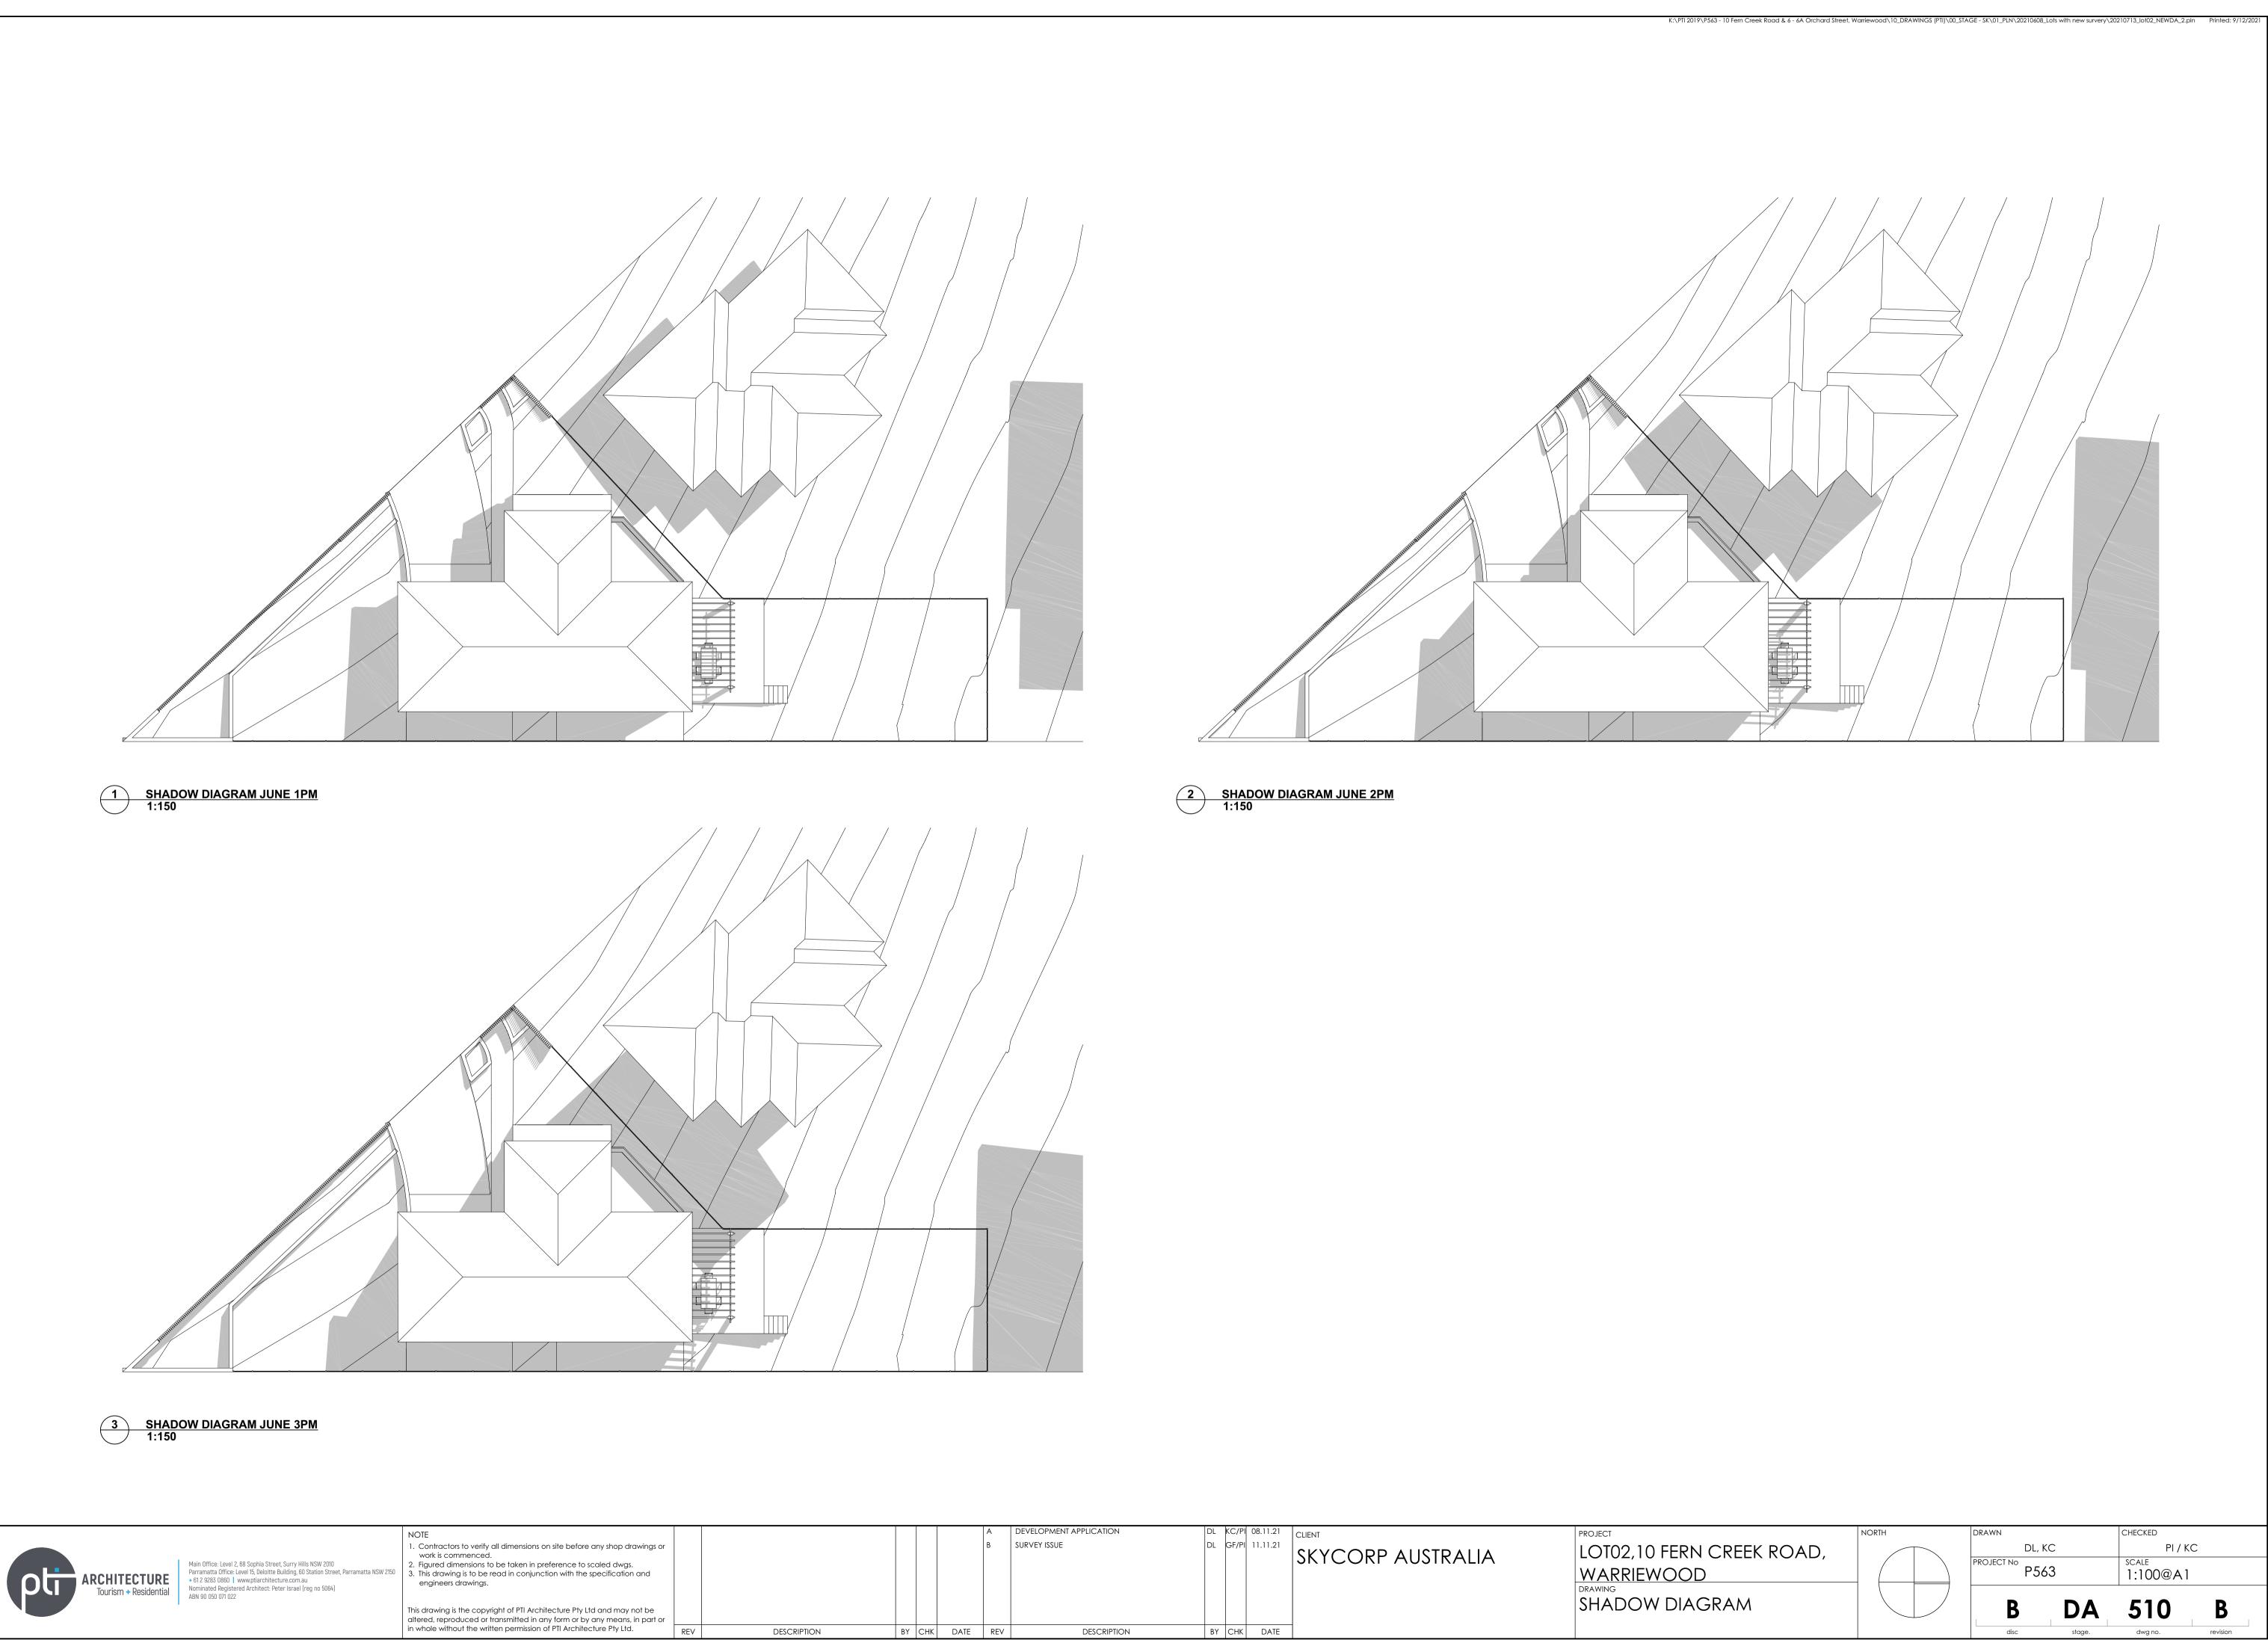
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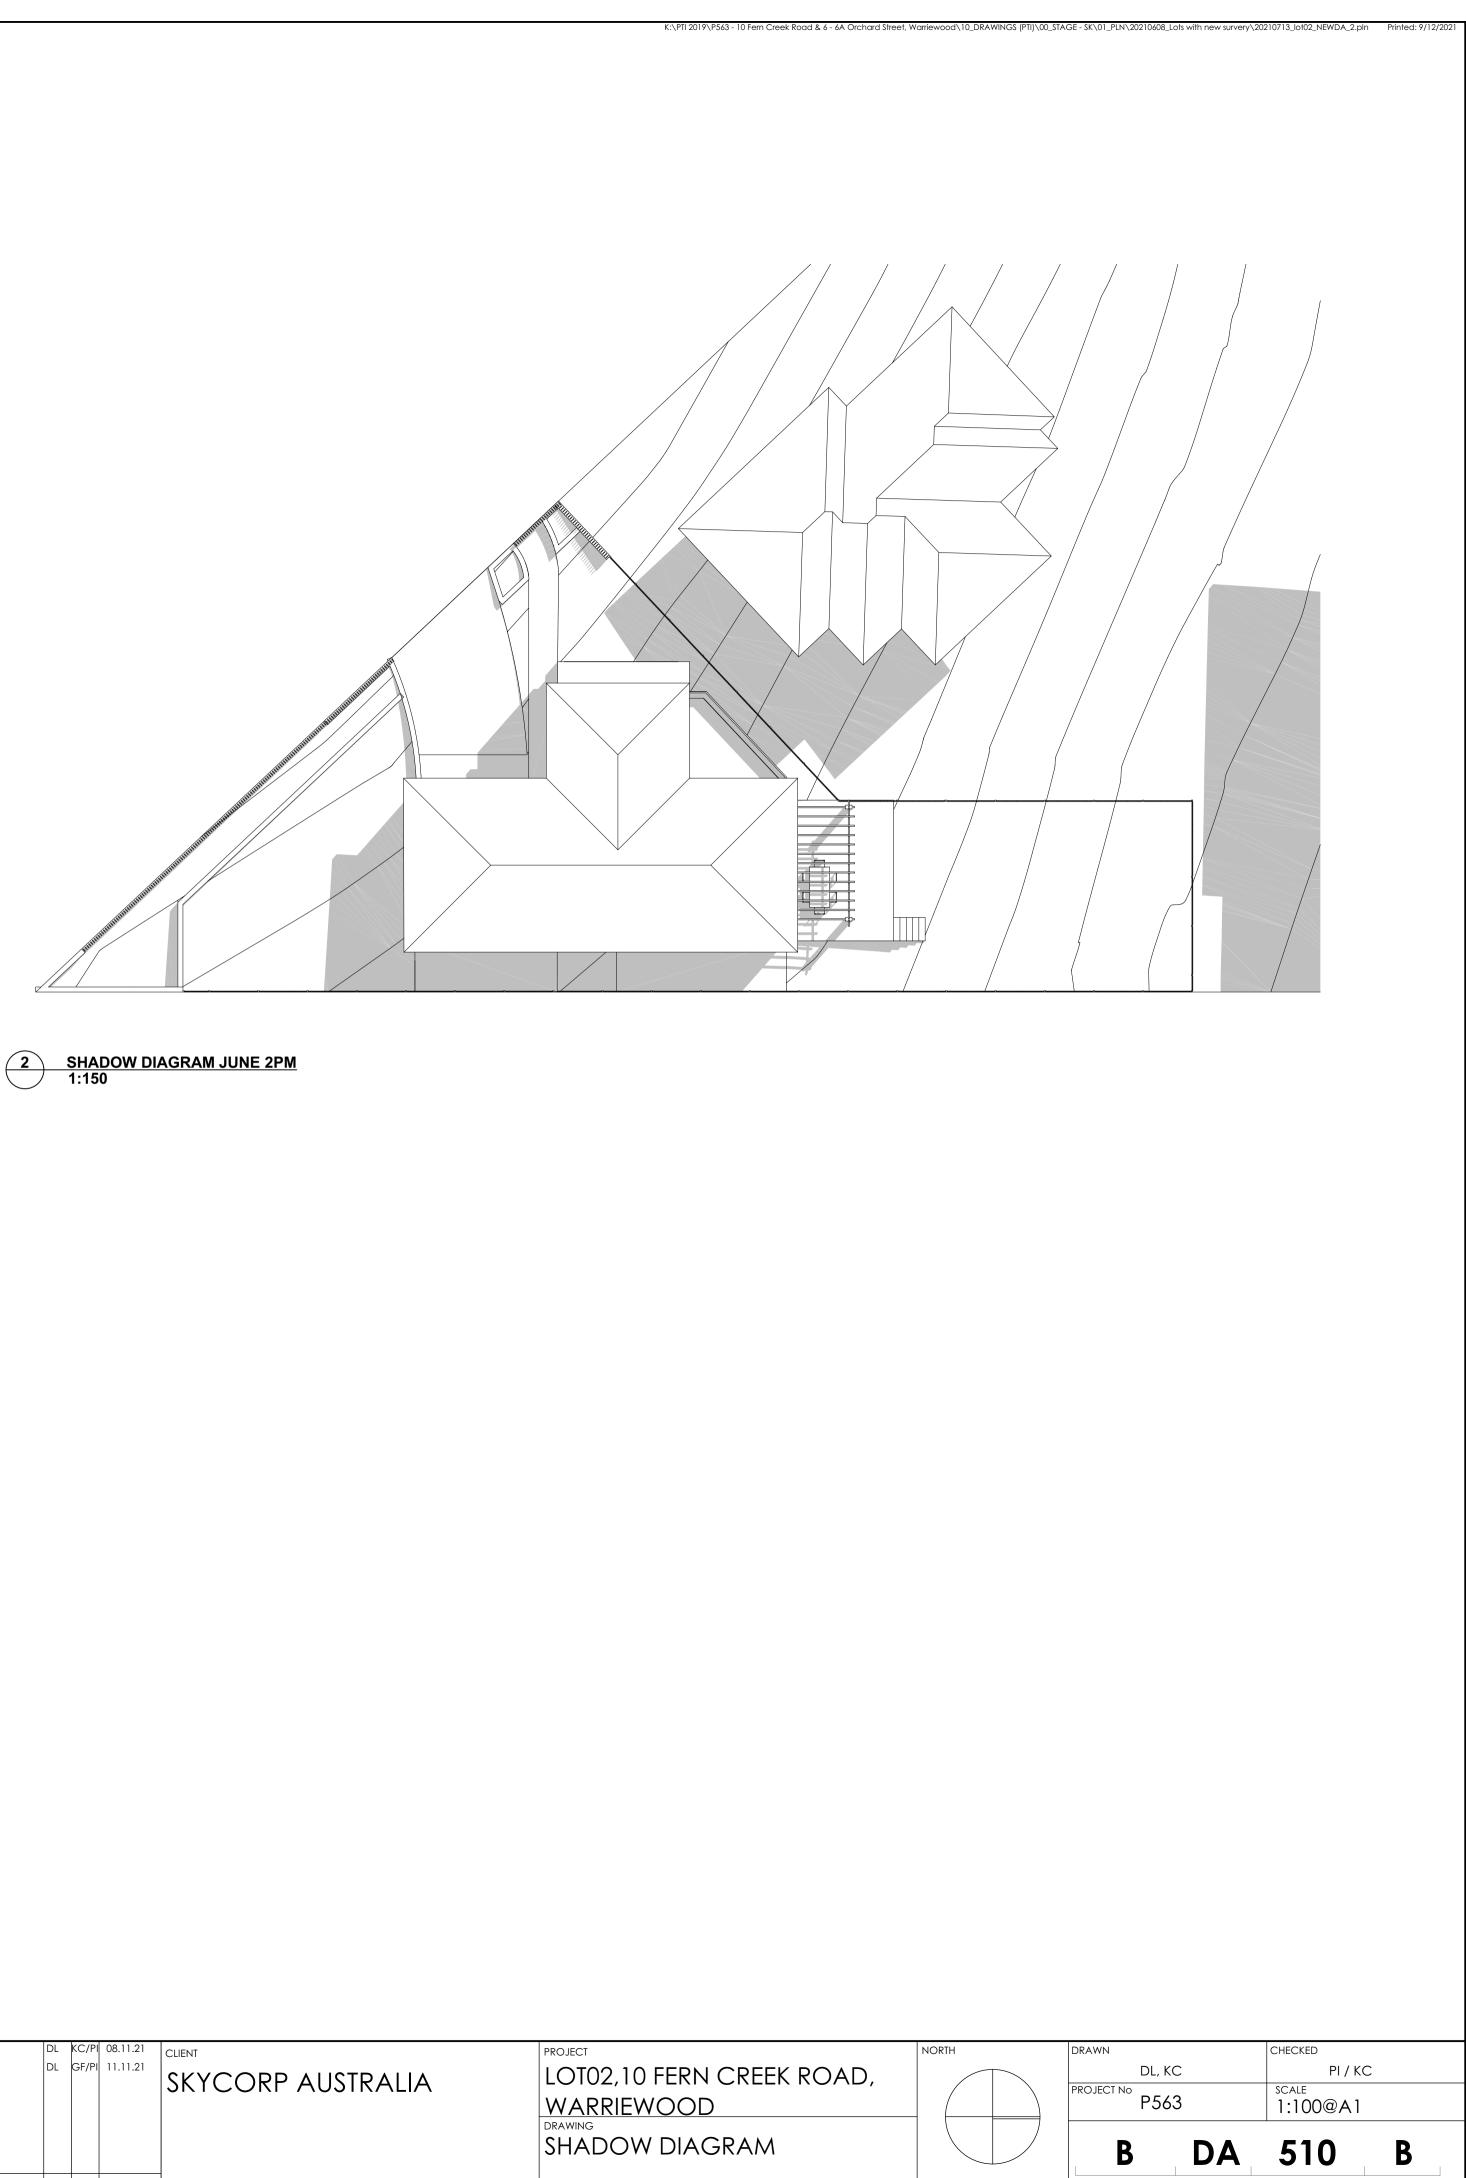
				А	DEVELOPMENT APPLICATION	DL	KC/PI	08.11.21	CLIENT	PROJECT
				В	SURVEY ISSUE	DL	GF/PI	11.11.21		LOT02,10 FERN C WARRIEWOOD DRAWING SHADOW DIAGR
N	ΒY	СНК	DATE	REV	DESCRIPTION	BY	СНК	DATE		

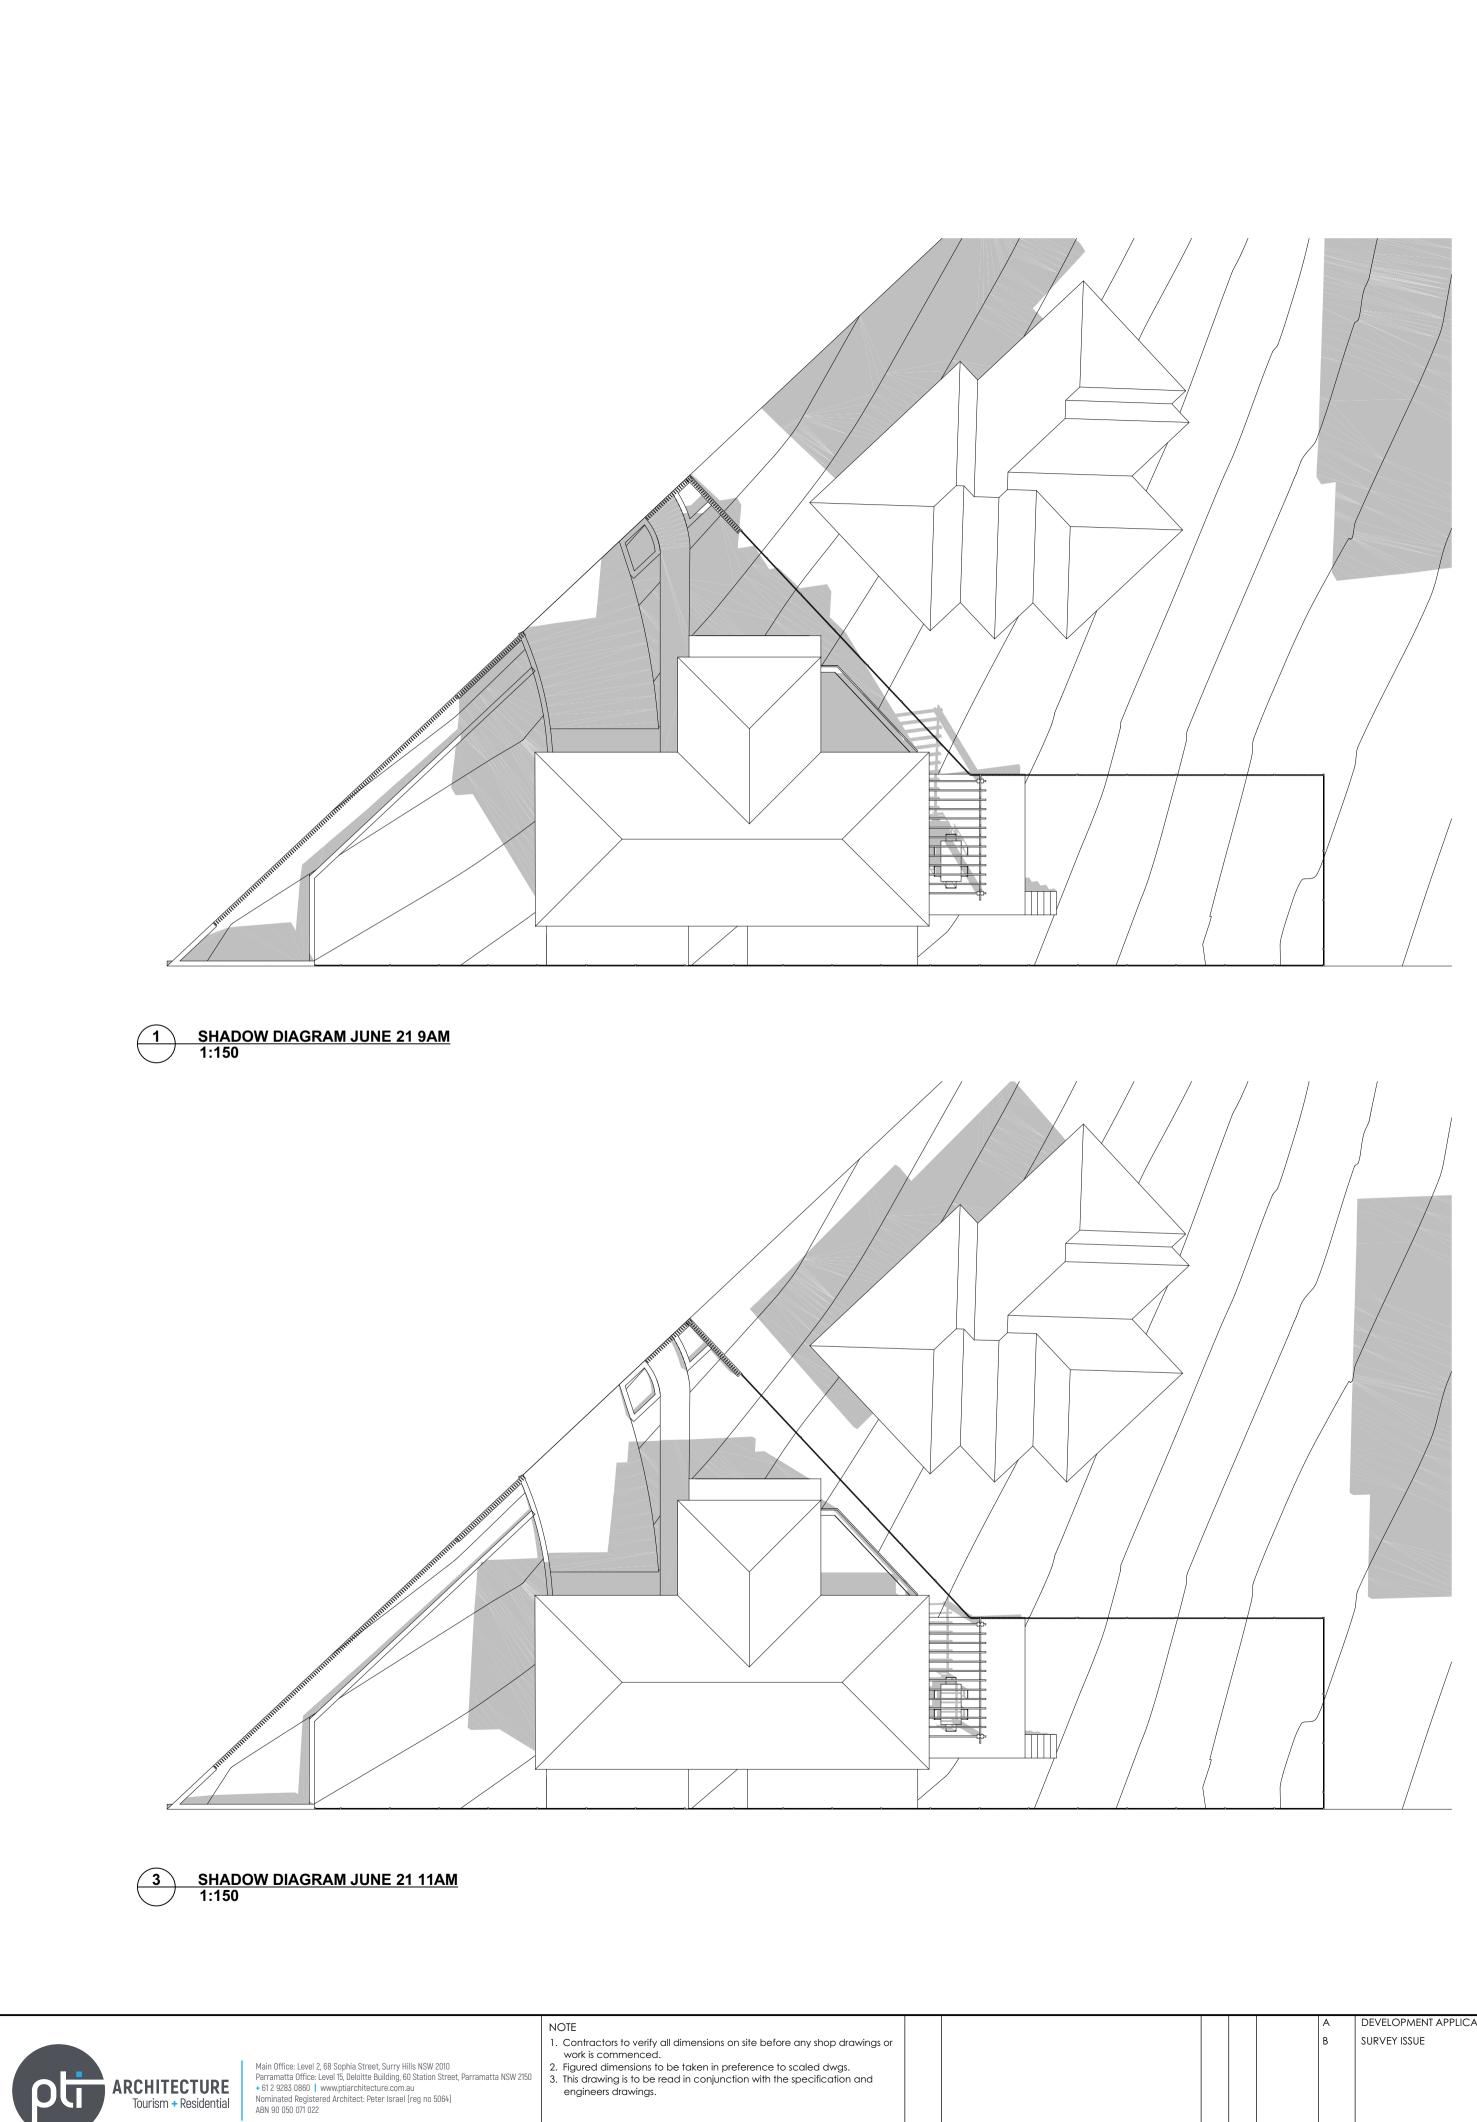











PROJECT INFORMATION - DEVELOPMENT APPLICATION		
SITE AREA (LOT 02) 460m ²	m/m ²	COMPLIANCE
PERMISSABLE GFA	N/A	Y
PROPOSED GFA	167m ²	
LOT WIDTH AT FRONT BUILDING LINE	23.7m	Y
LANDSCAPE REQUIRED LANDSCAPING AREA (45% OF SITE AREA) PROPOSED LANDSCAPING TOTAL AREA PROPOSED COMPLIANT LANDSCAPE AREA PROPOSED NON COMPLIANT LANDSCAPE AREA	207m ² 212m ² 144m ² 68m ²	Y
PRIVATE OPEN SPACE REQUIRED PRIVATE OPEN SPACE PROPOSED PRIVATE OPEN SPACE	24m ² 24m ²	Y








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		6
		7
RAMED GLAZING 3. COLORBOND MONUMENT METAL ROOF	4. AUSTRAL BRICKS BRAHMAN GRANITE 5. 3mm ALUMINIUM CLADDING - TIMBER LOOK SILVER WAITWE	6. JAMES HARDIE - STRIA 255mm
A DEVELOPMENT APPLICATION B SURVEY ISSUE DESCRIPTION BY CHK DATE REV DESCRIPTION	DL KC/PI 08.11.21 PROJECT DL GF/PI 11.11.21 SKYCORP AUSTRALIA PROJECT SKYCORP AUSTRALIA VARRIEWOOD DRAWING BY CHK DATE PROJECT	NORTH DRAWN DL, KC PROJECT NO P563 CHECKED PI / KC SCALE 1:100, 1:500@A1 B DA 700 B disc stage. dwg no. revision





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А	PRELIMINARY DESIGN	21/09/2021			
REVISION	AMENDMENT	ISSUE DATE	ISSUE	ISSUED TO	ISSUE
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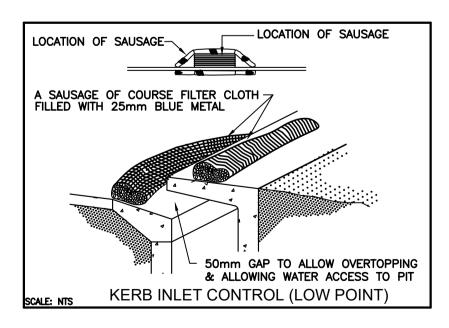
BELLA VISTA N.S.W. 2153 ALL CORRESPONDENCE TO: P.O. BOX 6080 BAULKHAM HILLS BC **BAULKHAM HILLS NSW 2153** CONSULTING PH. 8814 6191 FAX 8814 5301 MOB. 0425 270 333 EMAIL and rew@camconsulting.com.au ISSUE DATE STRUCTURAL & CIVIL ENGINEERS

PROJECT PROPOSED DEVELOPMENT LOT 2, 10 FERN CREEK ROAD,	DRAINAGE LAYOU	F PLAN	
WORRIEWOOD, NSW CLIENT SKYCORP	SCALES A1 - 1:100	DESIGNED A.C.	DRAFTED M.W.
ARCHITECT / PROJECT MANAGER KAE CHAN	DRAWING NO. C21187 -SW01	APPROVED A.C.	REVISION

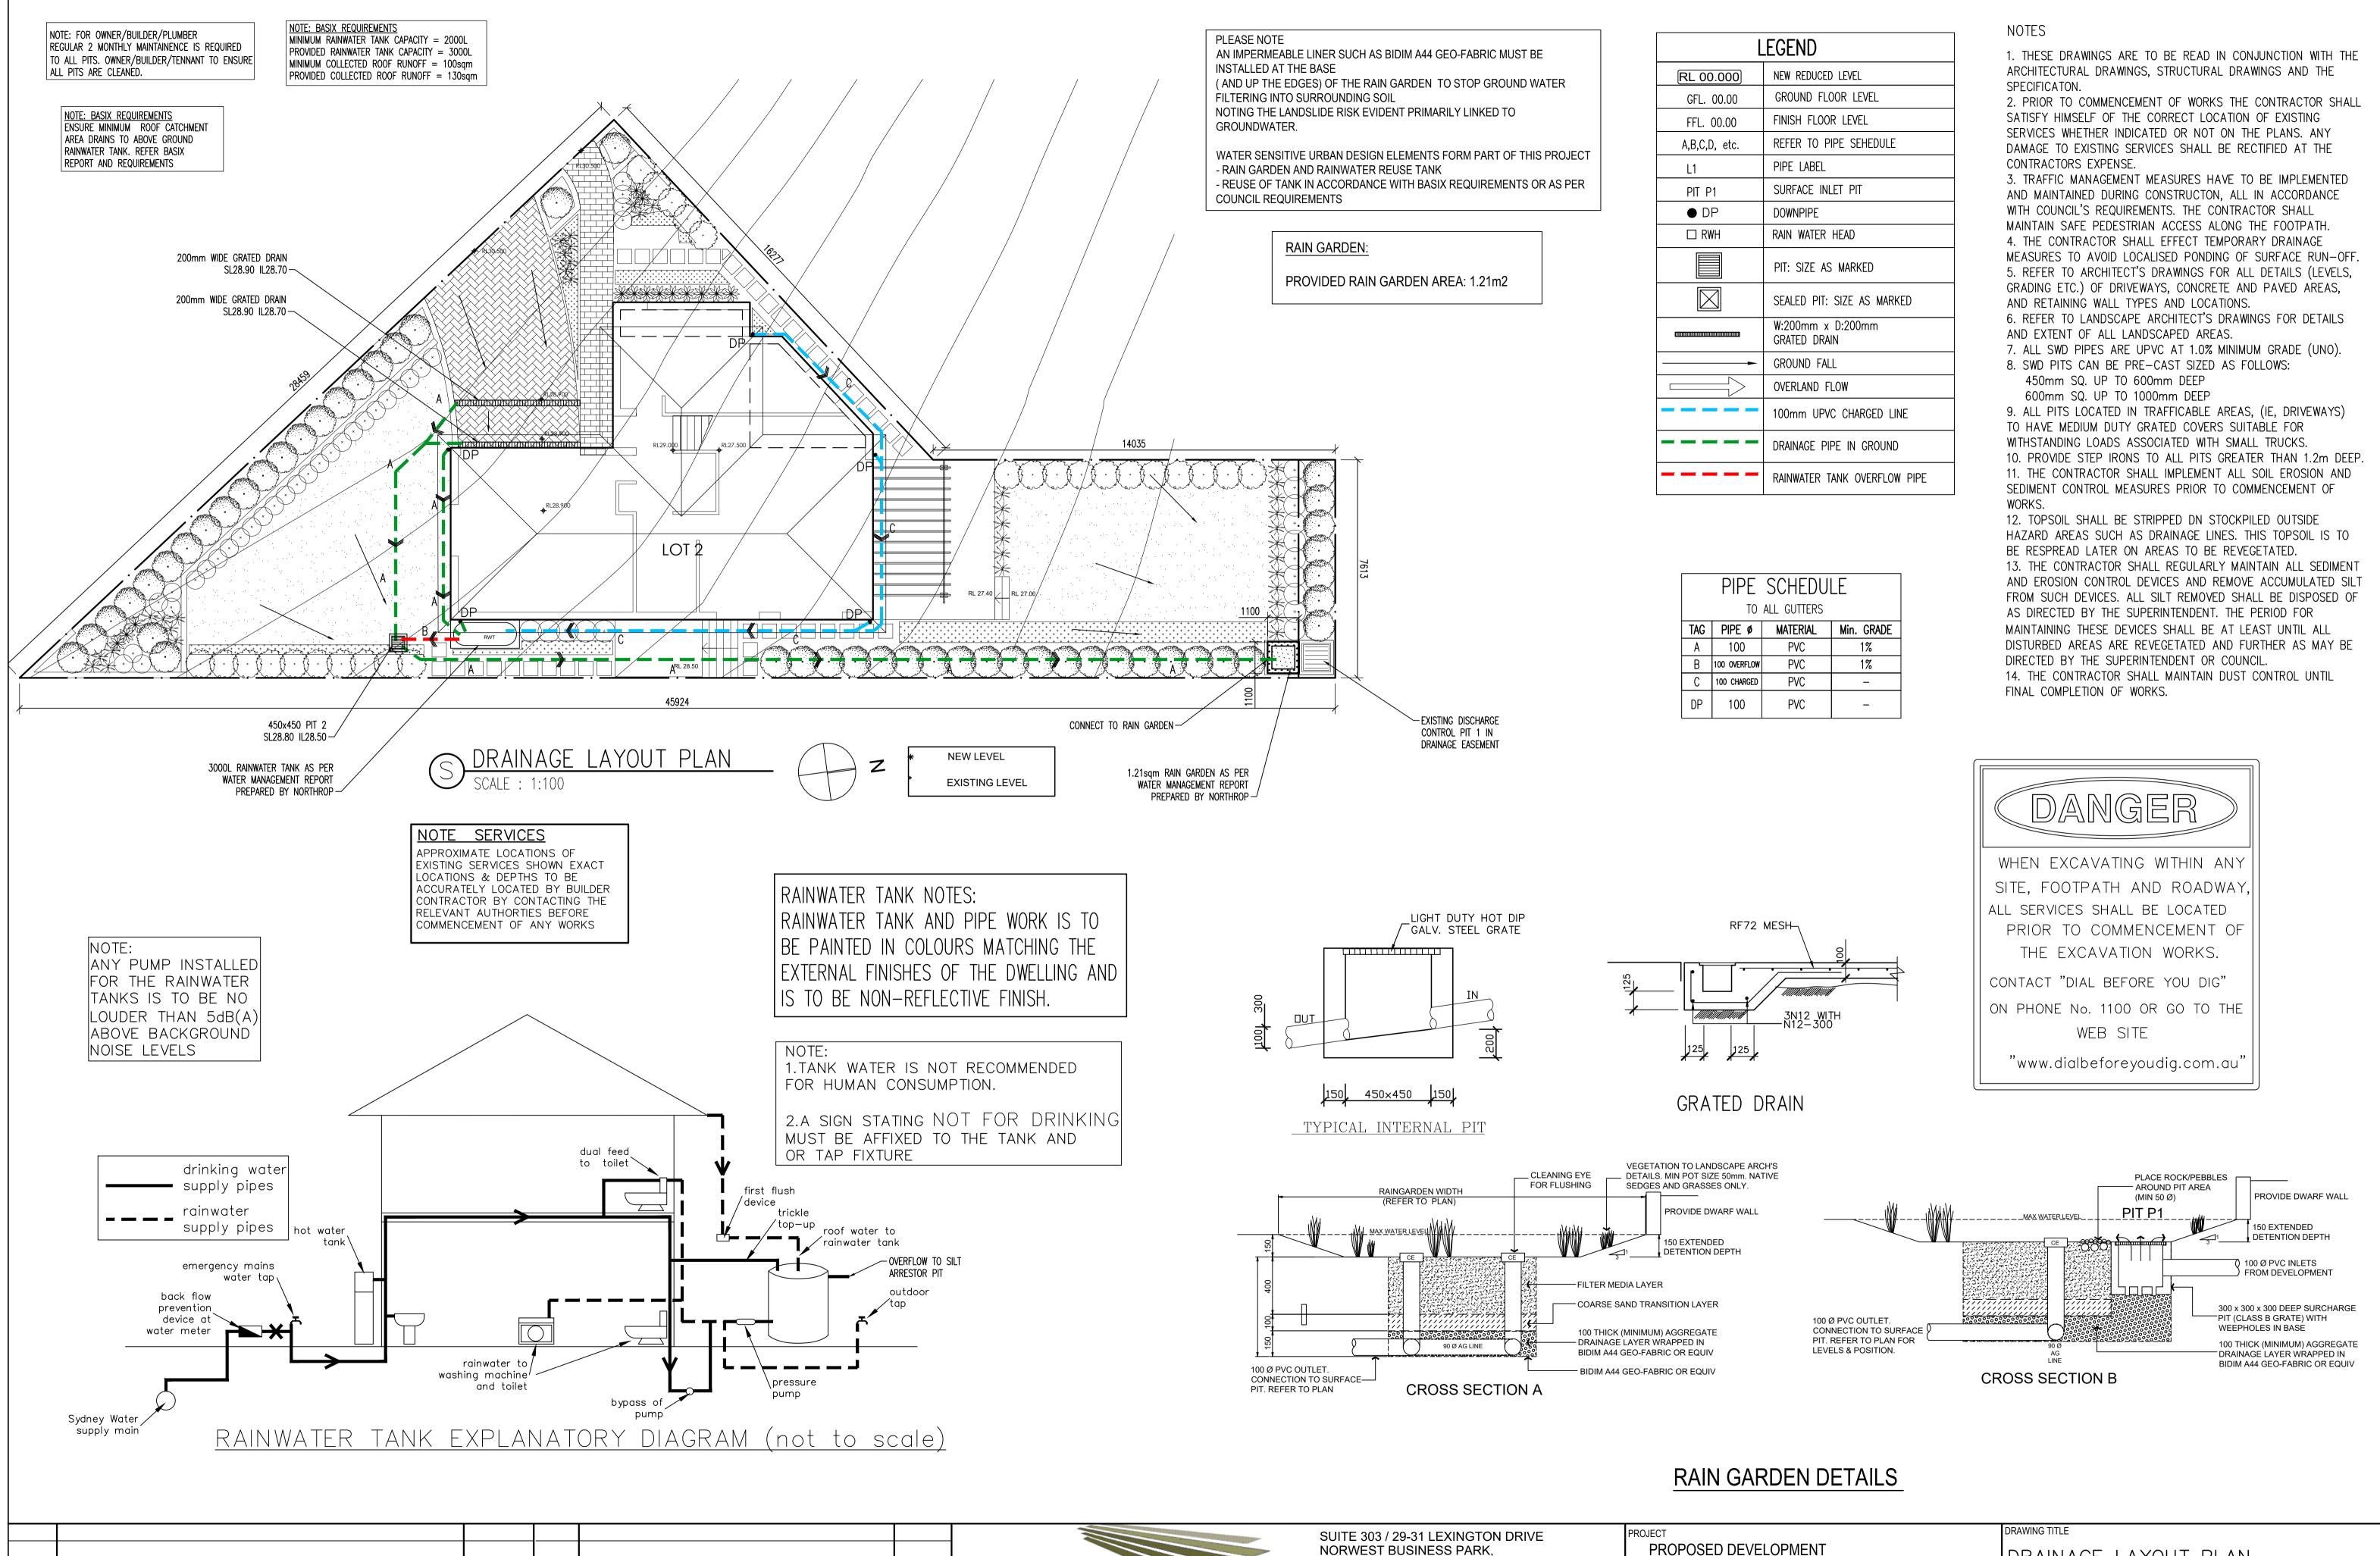
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DUCED LEVEL
D FLOOR LEVEL
FLOOR LEVEL
to pipe sehedule
BEL
e inlet pit
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ITER HEAD
ZE AS MARKED
PIT: SIZE AS MARKED
m x D:200mm DRAIN
) FALL
ND FLOW
UPVC CHARGED LINE
E PIPE IN GROUND
ER TANK OVERFLOW PIPE




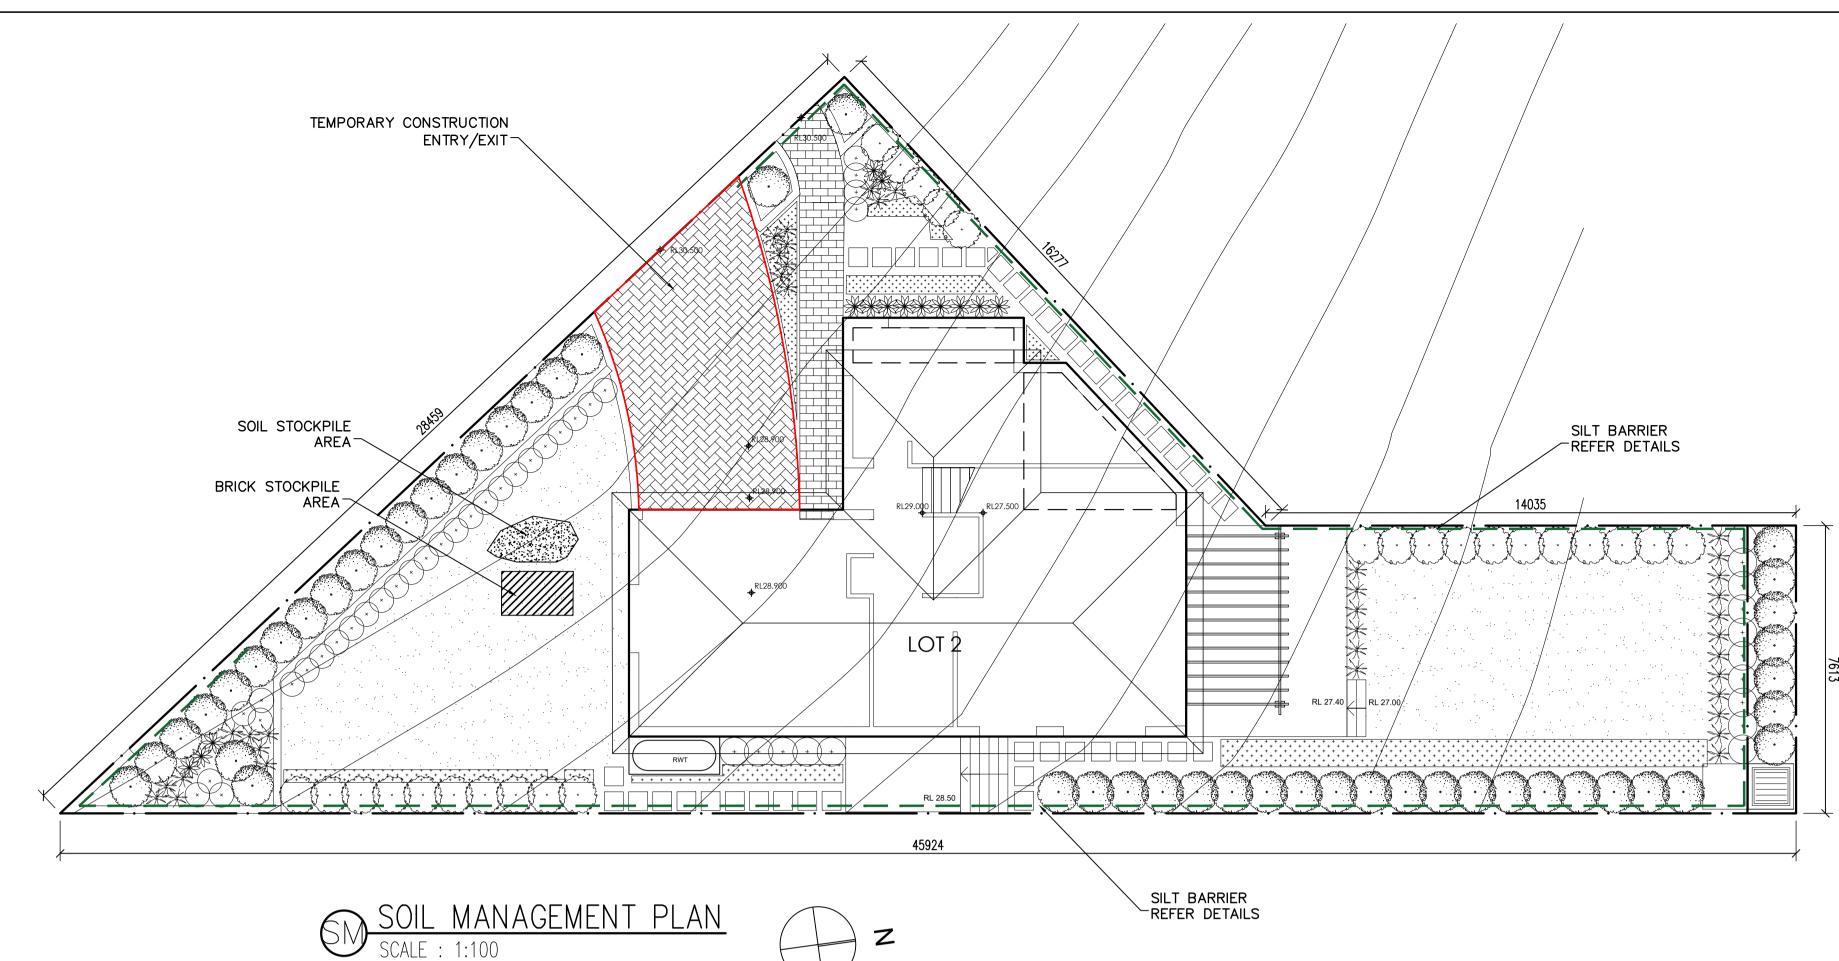


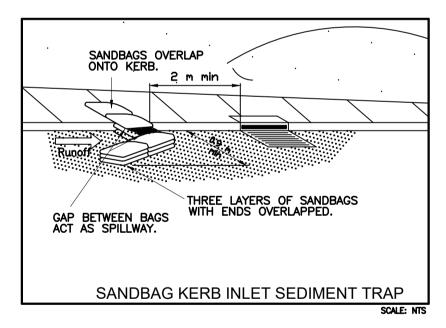

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A	PRELIMINARY DESIGN	21/09/2021			
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SUITE 303 / 29-31 LEXINGTON DRIVE NORWEST BUSINESS PARK, BELLA VISTA N.S.W. 2153 ALL CORRESPONDENCE TO: P.O. BOX 6080 BAULKHAM HILLS BC

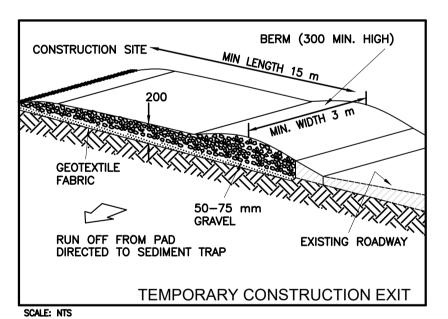BAULKHAM HILLS NSW 2153 PH. 8814 6191 FAX 8814 5301 MOB. 0425 270 333

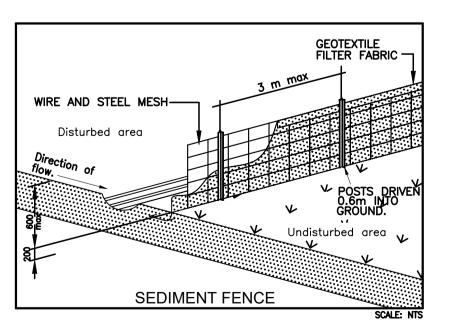EMAIL andrew@camconsulting.com.au

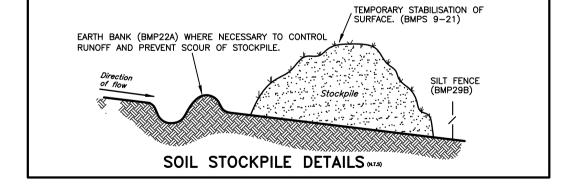PROJECT
PROPOSED DEVELOPME
LOT 2, 10 FERN CREEK R
WORRIEWOOD, NSW
CLIENT
SKYCORP
ARCHITECT / PROJECT MANAGER

ARCHITECT / PROJECT MANAGER KAE CHAN

SOIL EROSION CONTROL INSTRUCTIONS

- EARTH BATTERS WILL BE CONSTRUCTED WITH AS LOW AS A GRADIENT AS PRACTICABLE BUT NO STEEPER, UNLESS OTHERWISE NTOED, THAN:
- -2(H):1(V) WHERE SLOPE LENGTH LESS THAN 12 METRES -2.5(H):1(V) WHERE SLOPE LENGTH BETWEEN 12 & 16 METRES -3(H):1(V) WHERE SLOPE LENGTH BETWEEN 16 & 20 METRES -4(H):1(V) WHERE SLOPE LENGTH GREATER THAN 20 METRES ALL WATERWAYS, DRAINS, SPILLWAYS AND THEIR OUTLETS WILL
- BE CONSTRUCTED TO BE STABLE IN AT LEAST THE 1:20 YEAR ARI, TIME OF CONCENTRATION STORM EVENT. • WATERWAYS AND OTHER AREAS SUBJECT TO CONCENTRATED FLOWS AFTER CONSTRUCTION ARE TO HAVE A MAXIMUM GROUNDCOVER C-FACTOR OF 0.05 (70% GROUND COVER) WITHIN 10 WORKING DAYS FROM COMPLETION OFFORMATION. FLOW
- VELOCITIES ARE TO BE LIMITED TO THOSE SHOWN INTABLE 5-1 OF "MANAGING URBAN STORMWATER - SOILS AND CONSTRUCTION DEPT OF HOUSING 1998 (BLUE BOOK). FOOT AND VEHICULAR TRAFFIC WILL BE PROHIBITED IN THESE AREAS.
- STOCKPILES AFTER CONSTRUCTION ARE TO HAVE A MAXIMUM GROUND COVER C-FATOR OF 0.1 (60% GROUND COVER) WITHIN 10 WORKING DAYS FROM COMPLETION OF FORMATION.
- ALL LANDS, INCLUDING WATERWAYS AND STOCKPILES, DURING CONSTRUCTION ARE TO HAVE A MAXIMUM GROUND COVER C-FACTOR OF 0.15 (50% GROUND COVER) WITHIN 20 WORKING DAYS FROM INACTIVITY EVEN THOUGH WORKS MAY CONTINUE LATER.
- FOR AREAS OF SHEET FLOW USE THE FOLLOWING GROUND COVER PLANT SPECIES FOR TEMPORARY COVER: JAPANESE MILLET 20KG/HA AND OATS.
- PERMANENT REHABILITATION OF LANDS AFTER CONSTRUCTION WILL ACHIEVE A GROUND COVER C-FACTOR OF LESS THAN 0.1 AND LESS THAN 0.05 WITHIN 60 DAYS. NEWLY PLANTED LANDS WILL BE WATERED REGULARLY UNTIL AN EFFECTIVE COVER IS ESTABLISHED AND PLANTS ARE GROWING VIGOROUSLY FOLLOW-UP SEED AND FERTILISER WILL BE APPLIED AS 20KG/HA
- REVEGATATION SHOULD BE AIMED AT RE-ESTABLISHING NATURAL SPECIES. NATURAL SURFACE SOILS SHOULD BE REPLACED AND NON-PERSISTANT ANNUAL COVER SROPS SHOULS BE USED.

DUST CONTROL INSTRUCTIONS

- ALL STOCKPILED MATERIAL OR SEDIMENT COLLECTION TO BE
- SPRAYED BY LIGHTLY WIDE ANGLED WATER • THIS TEMPORARY MECHANICAL METHOD CONFINES AND SETTLES THE DUST FROM THE AIR BY DUST AND WATER PARTICLE ADHESION. WATER IS SPRAYED THROUGH NOZZELS OVER THE PROBLEM AREA.

NT DAD,	DRAWING TITLE SOIL MANAGEMENT	PLAN	
	scales	DESIGNED	drafted
	A1 - 1:100	A.C.	M.W.
	DRAWING NO.	APPROVED	REVISION
	C21187 -SWO2	A.C.	B