

# **ACTION PLANS**

## 32A OXFORD FALLS ROAD BEACON HILL 2100

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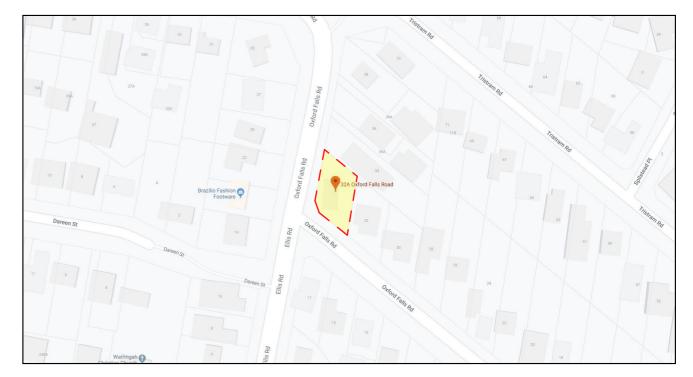
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## **MOD PLANS**

These plans are for Development Approval only.

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SHEET NUMBER	SHEET NAME	DATE PUBLISHED
MOD0	COVER	6/11/2020
MOD1	SITE / ROOF / SEDIMENT EROSION / WASTE MANAGEMENT / STORMWATER CONCEPT PLAN	6/11/2020
MOD2	PROPOSED GROUND FLOOR PLAN	6/11/2020
MOD3	PROPOSED FIRST FLOOR PLAN	6/11/2020
MOD4	NORTH / EAST ELEVATION	6/11/2020
MOD5	SOUTH / WEST ELEVATION	6/11/2020
MOD6	LONG / CROSS SECTION	6/11/2020
MOD7	AREA CALCULATIONS	6/11/2020
MOD8	WINTER SOLSTICE 9AM	6/11/2020
MOD9	WINTER SOLSTICE 9AM	6/11/2020
MOD10	WINTER SOLSTICE 9AM	6/11/2020

ITEM DETAILS	DEVELOPMENT APPLICATION						
ADDRESS	32A OXFORD FALLS RD. BEACON HILL						
LOT & DP/SP	LOT 1 DP 234584						
COUNCIL	NORTHERN BEACHS COUNCIL (WARRING	AH)					
SITE AREA	594.38m²	,					
FRONTAGE	26.822m (24.886m SECONDARY STREET FRONTAGE)						
CONTROLO	PERMISSIBLE / REQUIRED EXISTING PROPOSED COMPLIANCE						
CONTROLS	m / m² / %	m / m² / %	m / m² / %				
LEP							
LAND ZONING	R2 – LOW DENSITY RESIDENTIAL	R2	R2	YES			
MINIMUM LOT SIZE	600m²	594.38m²	UNCHANGED	YES			
FLOOR SPACE RATIO	NOT IDENTIFEID	N/A	N/A	N/A			
MAXIMUM BUILDING HEIGHT	8.5m	7.2m	7.5m	YES			
HAZARDS							
ACID SULFATE SOILS	NOT IDENTIFIED	N/A	N/A	N/A			
FLOOD PLANNING	NOT IDENTIFIED	N/A	N/A	N/A			
DEVELOPMENT ON SLOPING LAND	NOT IDENTIFIED	N/A	N/A	N/A			
COASTAL HAZARDS	NOT IDENTIFIED	N/A	N/A	N/A			
HIGH/MED/LOW FLOOD RISK PRECINCT	NOT IDENTIFIED	N/A	N/A	N/A			
NATIVE VEGETATION	NOT IDENTIFIED	N/A	N/A	N/A			
WILDLIFRE CORRIDORS	NOT IDENTIFIED	N/A	N/A	N/A			
WATERWAYS AND RIPARIAN LAND	NOT IDENTIFIED	N/A	N/A	N/A			
THREATEND HIGH CONSERVATION HABITAT	NOT IDENTIFIED	N/A	N/A	N/A			
LAND ADJOINING PUBLIC OPEN SPACE	NOT IDENTIFIED	N/A	N/A	N/A			
DCP							
WALL HEIGHT	7.2m	5.24m	UNCHANGED	YES			
NUMBER OF STOREYS	2	2	UNCHANGED	YES			
SIDE BOUNDARY SETBACKS	0.9m	N: 4.997m E: 2.255m	N: 2.575m E: 1.116m	YES			
FRONT BOUNDARY SETBACK	6.5m	5.260m	5.240m	NO			
SECONDARY FRONT BOUNDARY SETBACK	3.5m	3.337m	2.073m	NO			
LANDSCAPE OPEN SPACE	40% (237.75m²)	242.44m <sup>2</sup>	202.83m <sup>2</sup>	NO			
PRIVATE OPEN SPACE	60m²	0m²	45.21m <sup>2</sup>	YES			



### NCC & AS COMPLIANCES SPECIFICATIONS

- EARTHWORKS - PART 3.1.1 OF NCC - EARTH RETAINING STRUCTURES - PART 3.1.2 OF NCC

- DRAINAGE - PART 3.1.3 OF NCC

- TERMITE-RISK MANAGEMENT - PART 3.1.4 OF NCC

- FOOTINGS & SLAB - PART 3.2 OF NCC INCLUDING AS2870

- MASONRY - PART 3.3 OF NCC INCLUDING AS3700 - FRAMING - PART 3.4 OF NCC

- SUB FLOOR VENTILATION - PART 3.4.1 OF NCC

- ROOF CLADDING AND WALL-CLADDING - PART 3.5 OF NCC

- GLAZING - PART 3.6 OF NCC INCLUDING AS1288

- FIRE SAFETY - PART 3.7 OF NCC

- FIRE SEPERATION - PART 3.7.2 OF NCC

- FIRE PROTECTION OF SEPERATING WALLS AND FLOORS- PART 3.7.3 OF NCC

- SMOKE ALARMS - PART 3.7.5 OF NCC

- WET AREAS AND EXTERNAL WATERPROOFING - PART 3.8.1 OF NCC

- ROOM HEIGHTS - PART 3.8.2 OF NCC

- FACILITIES - PART 3.8.3 OF NCC

- LIGHT - PART 3.8.4 OF NCC

- VENTILATION - PART 3.8.5 OF NCC

- SOUND INSULATION - PART 3.8.6 OF NCC

- STAIRWAYAND RAMP CONSTRUCTION - PART 3.9.1 OF NCC

- BARRIERS AND HANDRAILS - PART 3.9.2 OF NCC

- SWIMMING POOLS - PART 3.10.1 OF NCC

- CONSTRUCTION IN BUSHFIRE PRONE AREAS - PART 3.10.5 OF NCC

- FENCING & OTHER PROVISIONS - REGS & AS1926 - DEMOLITION WORKS - AS2601-1991 THE DEMOLITION OF STRUCTURES.

- ALL WATERPROOF MEMBRANES TO COMPLY WITH WITH AS 3740-2010

- ALL PLUMBING & DRAINAGE WORK TO COMPLY WITH AS 3500 - SITE CLASSIFICATION AS TO AS 2870

- ALL PLASTERBOARD WORK TO COMPLY WITH AS 2588-1998 - ALL STRUCTURAL STEEL WORK TO COMPLY WITH AS 4100 & AS 1554

- ALL CONCRETE WORK TO COMPLY WITH AS 3600

- ALL ROOF SHEETING WORK TO COMPLY WITH AS 1562-1992

- ALL SKYLIGHTS TO COMPLY WITH WITH AS 4285-2007

- ALL CERAMIC TILING TO COMPLY WITH AS 3958.1-2007 & 3958.2-1992 - ALL GLAZING ASSEMBLIES TO COMPLY WITH AS2047 & 1288

- ALL TIMBER RETAINING WALLS ARE TO COMPLY WITH AS 1720.1-2010,

AS 1720.2-2006, AS 1720.4-2006, AS 1170.1-1989 & AS 1170.4-2007 - ALL RETAINING WALLS ARE TO COMPLY WITH 3700 - 2011 & AS 3600 -2009

- ALL CONSTRUCTION TO COMPLY TO AS3959- 2009

## OXFORD FALLS ROAD



### 3m MAX DISTURBED AREA POSTS DRIVEN 0.6m INTO GROUND DETAIL OF OVERLAP WIRE OR STEEL MESH (WHERE REQUIRED) ↓ UNDISTURBED AREA **SEDIMENT FENCE**

#### DUST CONTROL:

TO REDUCE DUST GENERATED BY WIND ACTION, THE REMOVAL OF THE TOP SOIL IS TO BE MINIMISED. TO PREVENT DUST GENERATION, WATERING DOWN OF THE SITE, ESPECIALLY DURING THE MOVEMENT OF MACHINERY IS REQUIRED. WHERE EXCAVATING INTO ROCK, KEEP THE SURFACE MOIST TO MINIMISE DUST. CONSTRUCT A GRAVEL ENTRY/EXIT POINT USING BLUE METAL AND RESTRICT ALL VEHICLE MOVEMENTS WITHIN THE SITE TO A MINIMUM. ENSURE WIND BREAKS, SUCH AS EXISTING FENCES ARE MAINTAINED DURING THE CONSTRUCTION PHASE UNTIL NEW LANDSCAPING IS PROVIDED OR REINSTATED. PREVENT DUST BY COVERING STOCKPILES

#### SEDIMENT NOTE:

1. ALL EROSION AND SEDIMENT CONTROL MEASURES TO BE INSPECTED AND MAINTAINED DAILY BY THE SITE MANAGER.

2. MINIMISE DISTURBED AREAS, REMOVE EXCESS SOIL FROM EXCAVATEDAREA AS SOON AS POSSIBLE. 3. ALL MATERIAL STOCKPILE TO BE CLEAR FROM DRAINS, GUTTERS AND FOOTPATHS, OR WITHIN SEDIMENT FENCE AREA.

4. DRAINAGE TO BE CONNECTED TO STORMWATER AS SOON AS POSSIBLE. IF STORED ON SITE, IT MUST BE FILTERED BEFORE RELEASING INTO STORMWATER SYSTEM OR WATERWAYS.

5. ROADS AND FOOTPATHS TO BE SWEPT DAILY.

#### STOCKPILES:

ALL STOCKPILES ARE TO BE KEPT ON-SITE WHERE POSSIBLE. ANY MATERIALS PLACED ON THE FOOTPATHS OR NATURE STRIPS REQUIRE COUNCIL'S PERMISSION.

ALL STOCKPILES ARE TO BE PLACED AWAY FROM THE DRAINAGE LINES AND STREET GUTTERS. IT IS BEST TO LOCATE THESE ON THE HIGHEST PART OF THE SITE IF POSSIBLE. PLACE WATERPROOF COVERING OVER STOCKPILES.

IF REQUIRED PROVIDE DIVERSION DRAIN & BANK AROUND STOCKPILES.

#### **GUTTER PROTECTION:**

PROVIDE PROTECTION TO DOWNHILL GRATE IN GUTTER BY MEANS OF SAND BAGS OR BLUE METAL WRAPPED IN GEOTEXTILE FABRIC. WHEN SOIL OR SAND BUILDS UP AROUND THIS SEDIMENT BARRIER, THE MATERIAL SHOULD BE RELOCATED BACK TO THE SITE FOR DISPOSAL.

NOTE: ALL PROPOSED STORMWATER TO CONNECT WITH EXISTING

#### SITE / ROOF / SEDIMENT EROSION / WASTE MANAGEMENT PLAN 1:200


COMMENTS

DEV DATE



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					commencement of works.	

DOWN NOTES

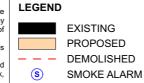

LENA & CRAIG LOWE

CLIENT

2100

PROJECT ADDRESS 32A OXFORD FALLS ROAD BEACON HILL DRAWING NO.

MOD1


DATE 2020


Friday, 6 November **SCALE** 

#### DRAWING NAME


SITE / ROOF / SEDIMENT EROSION / WASTE MANAGEMENT / STORMWATER CONCEPT PLAN


1:200 @A3

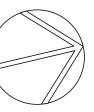


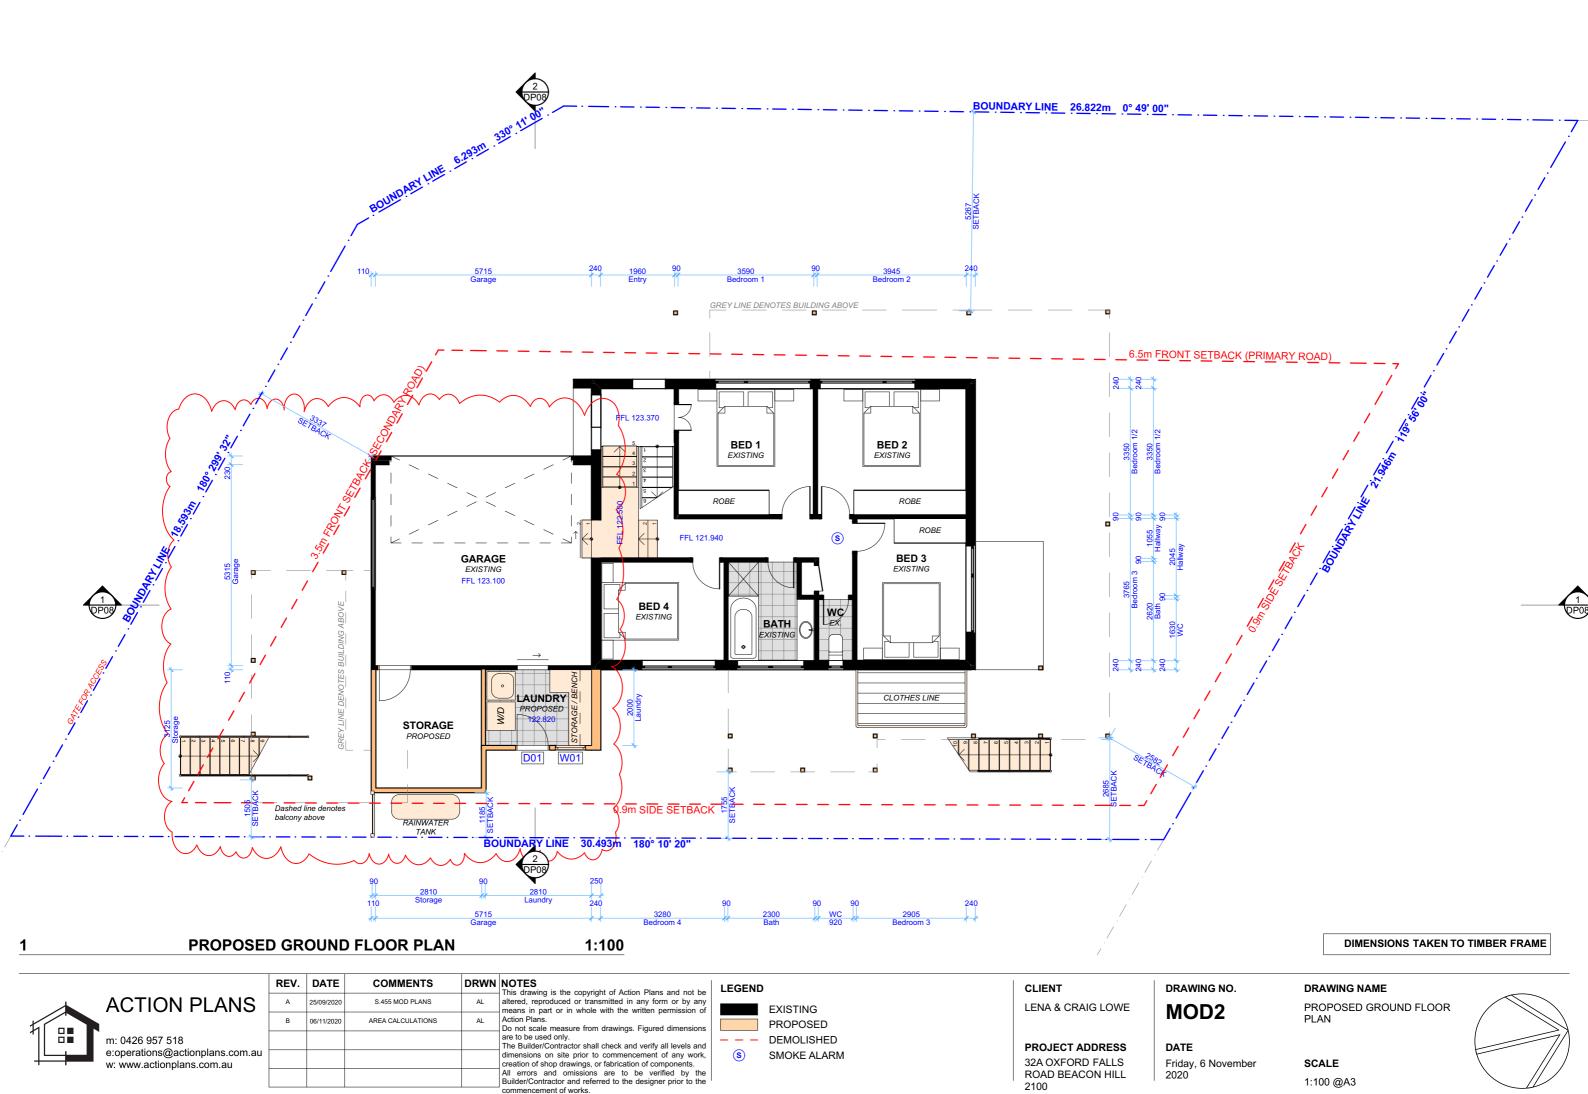



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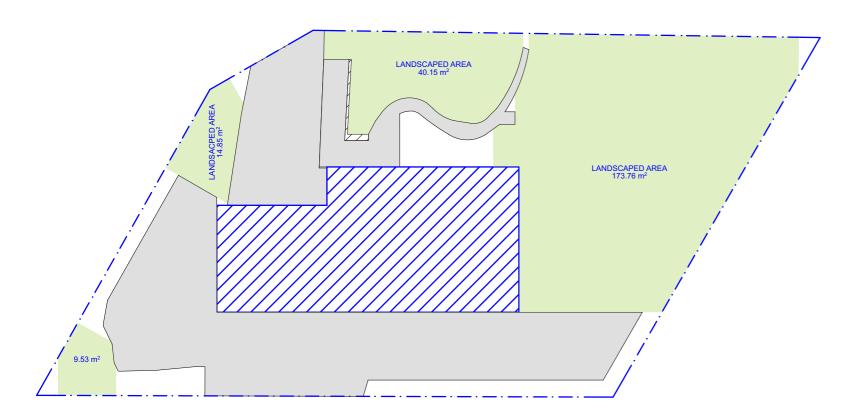


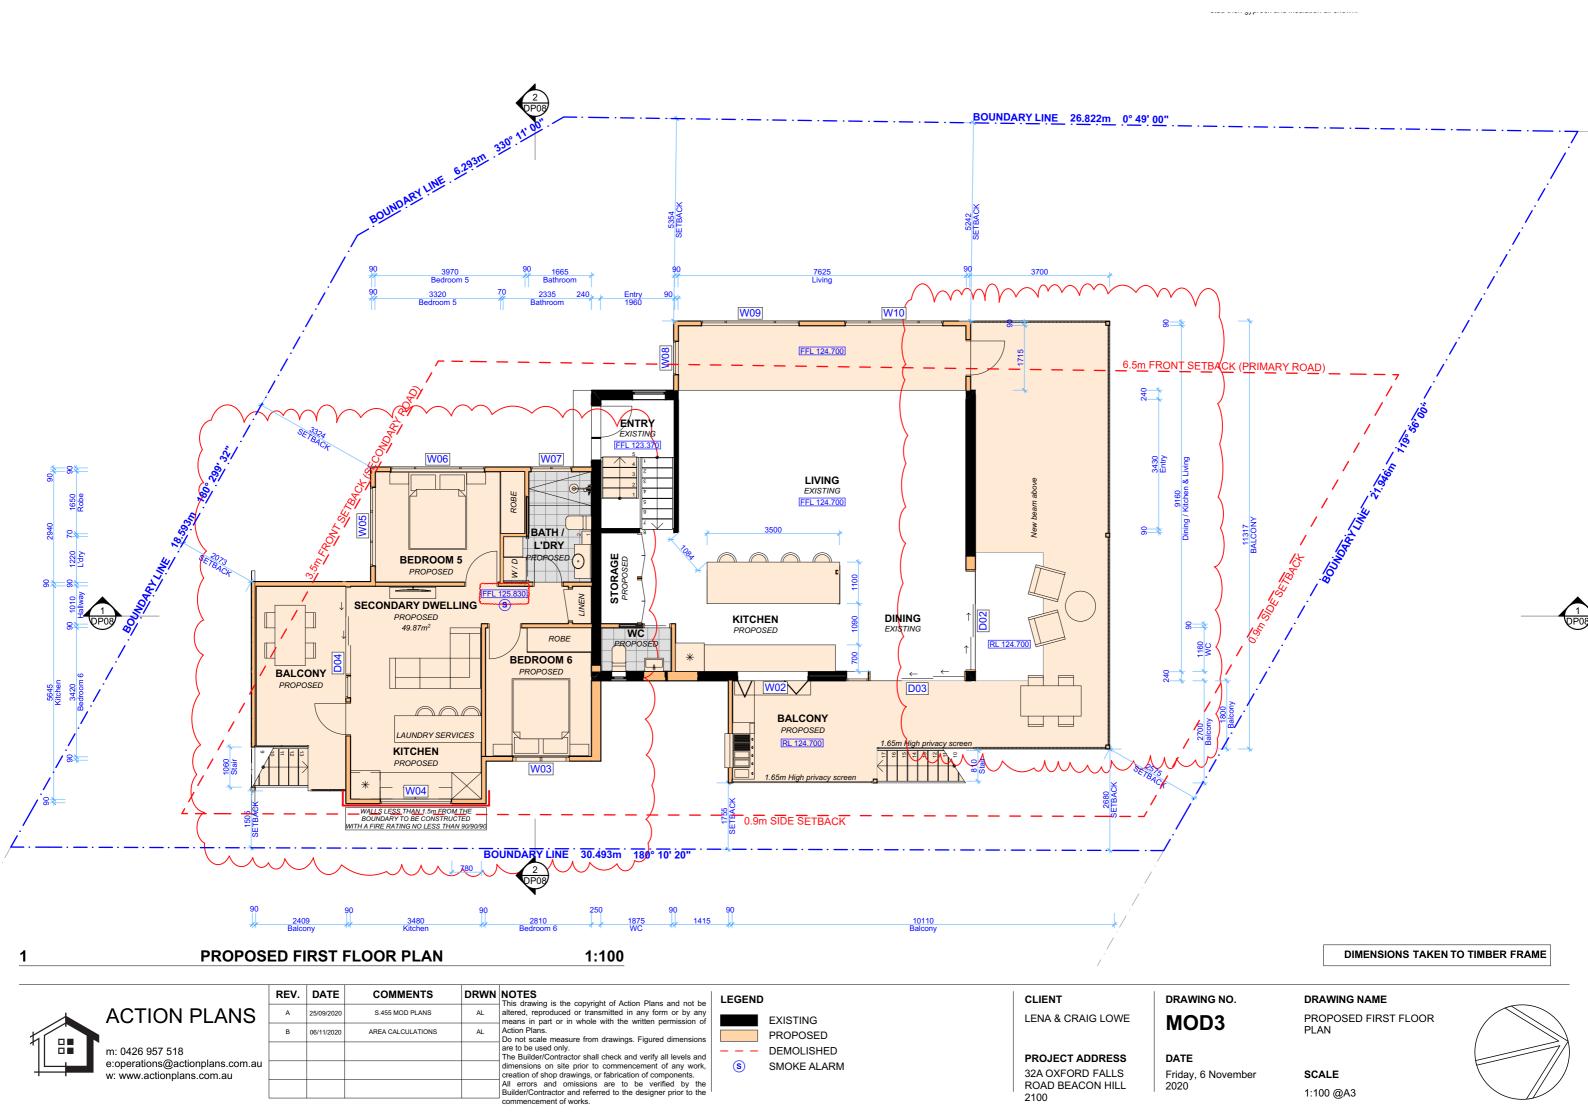

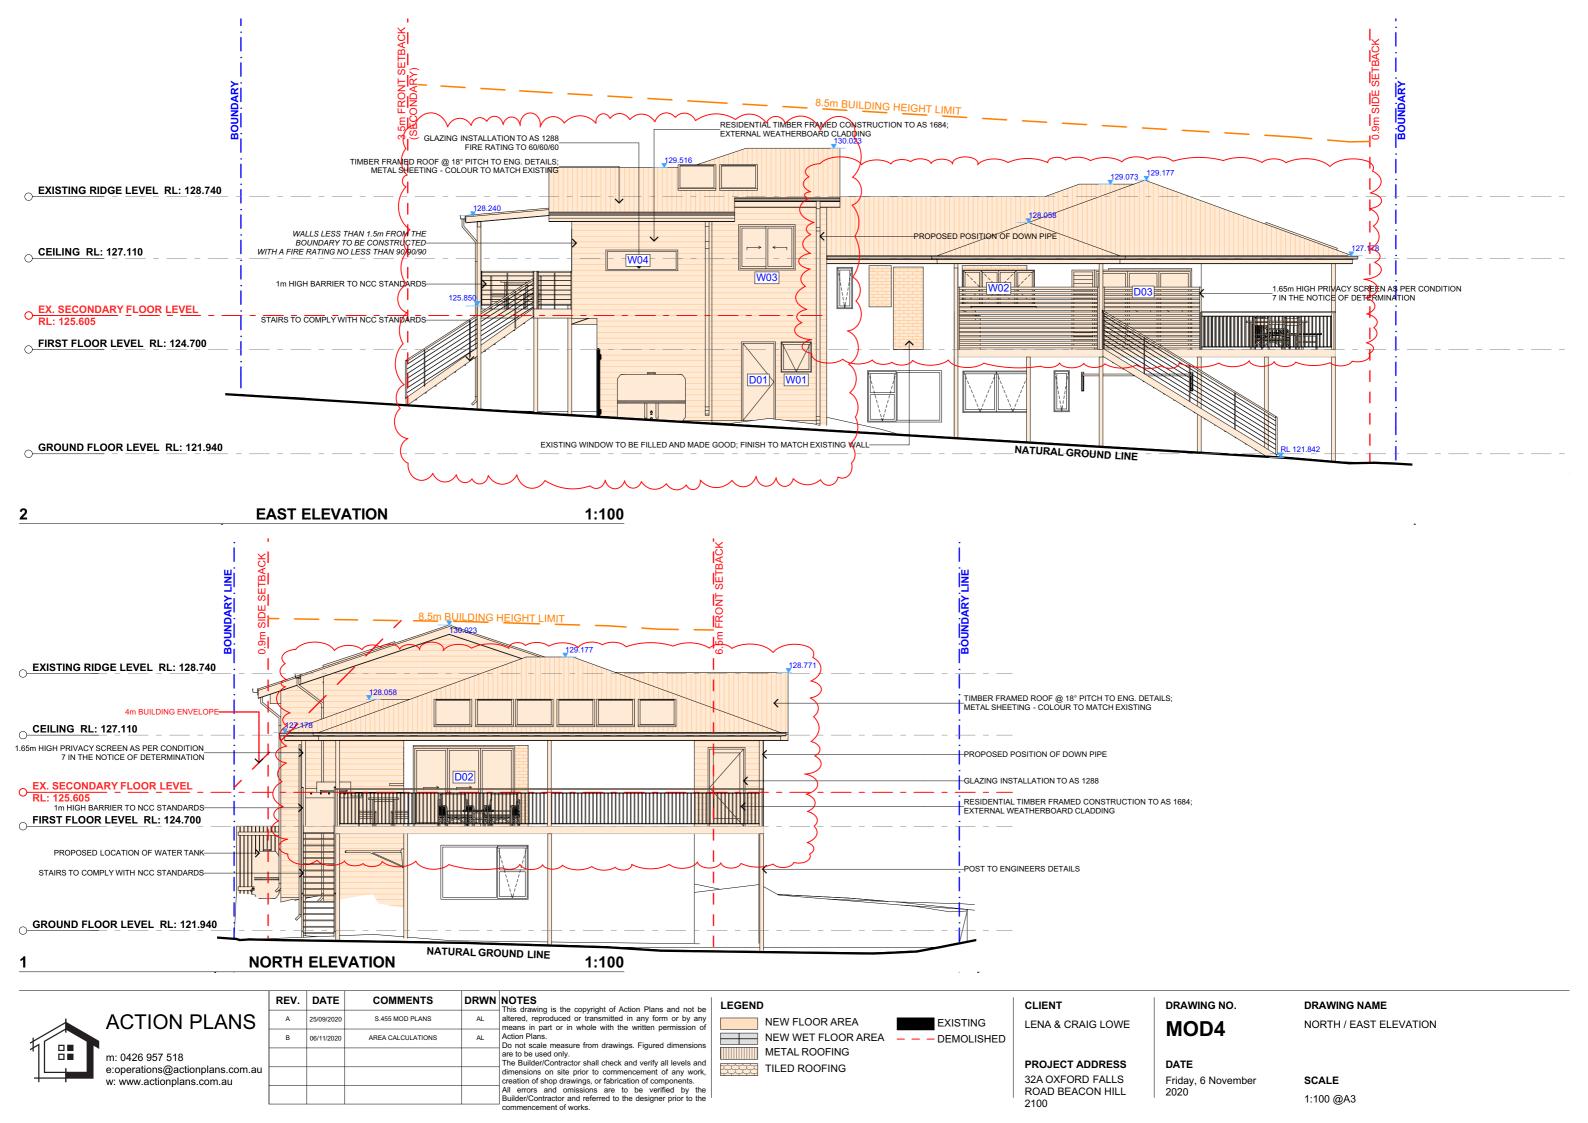

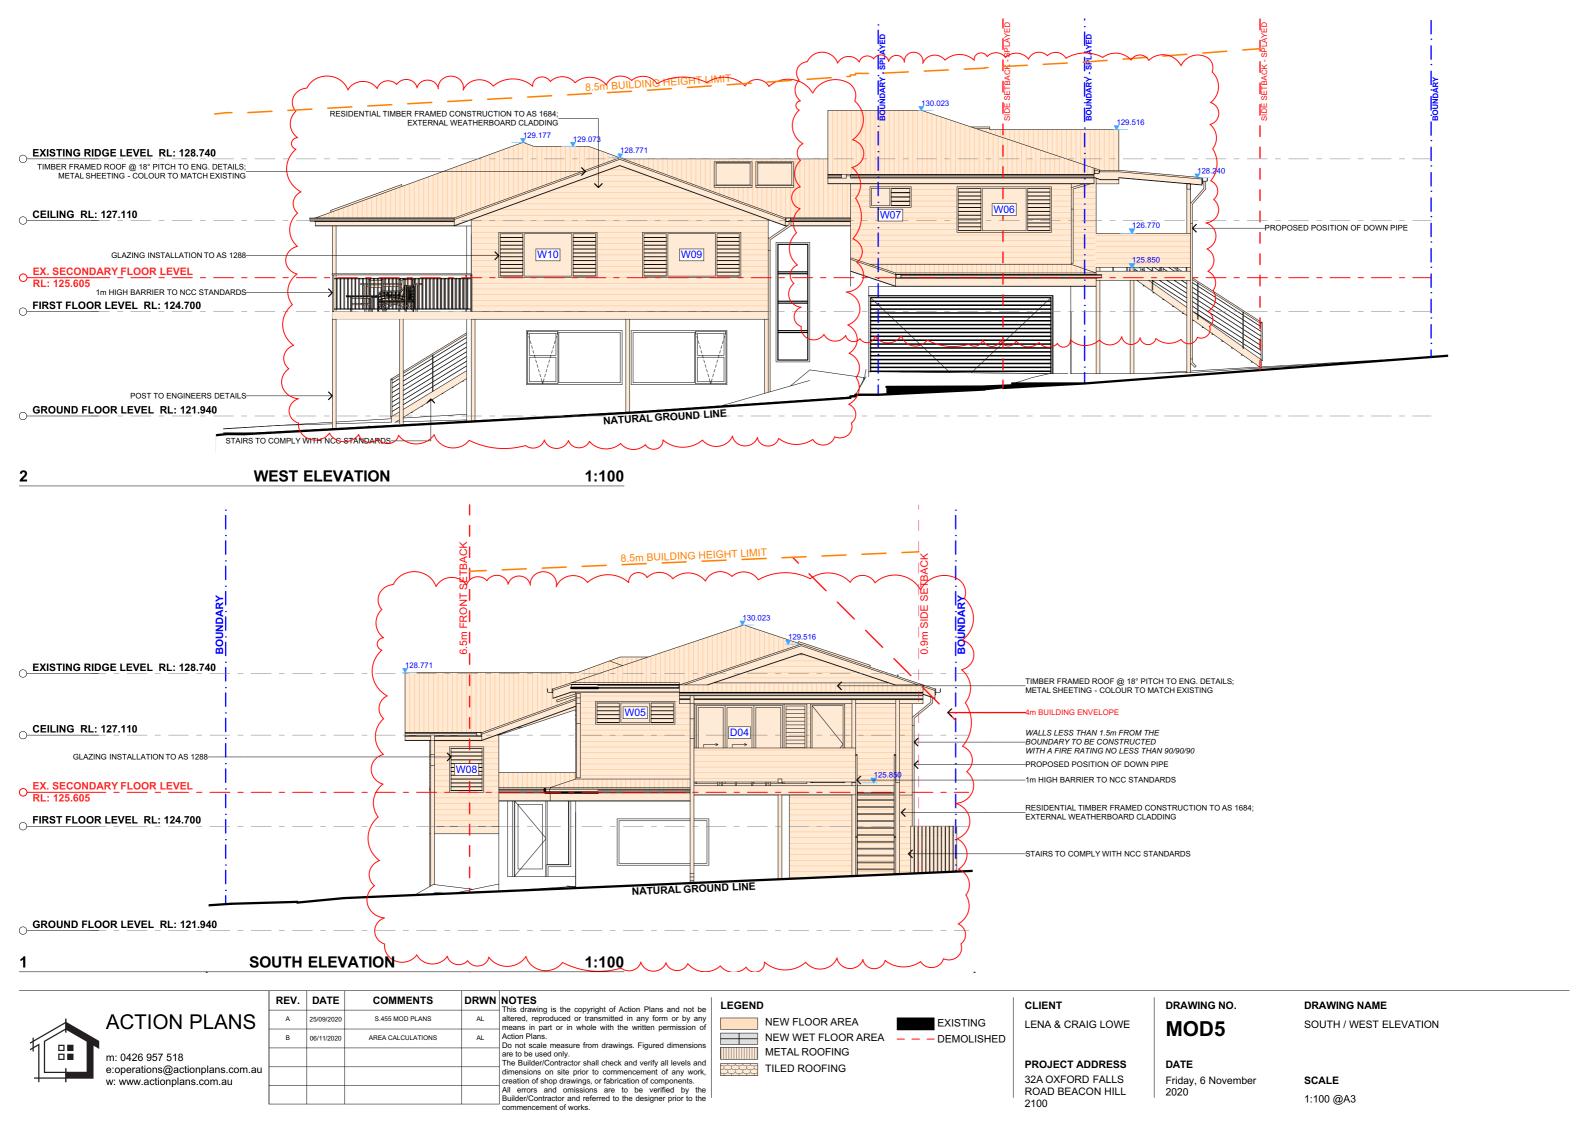

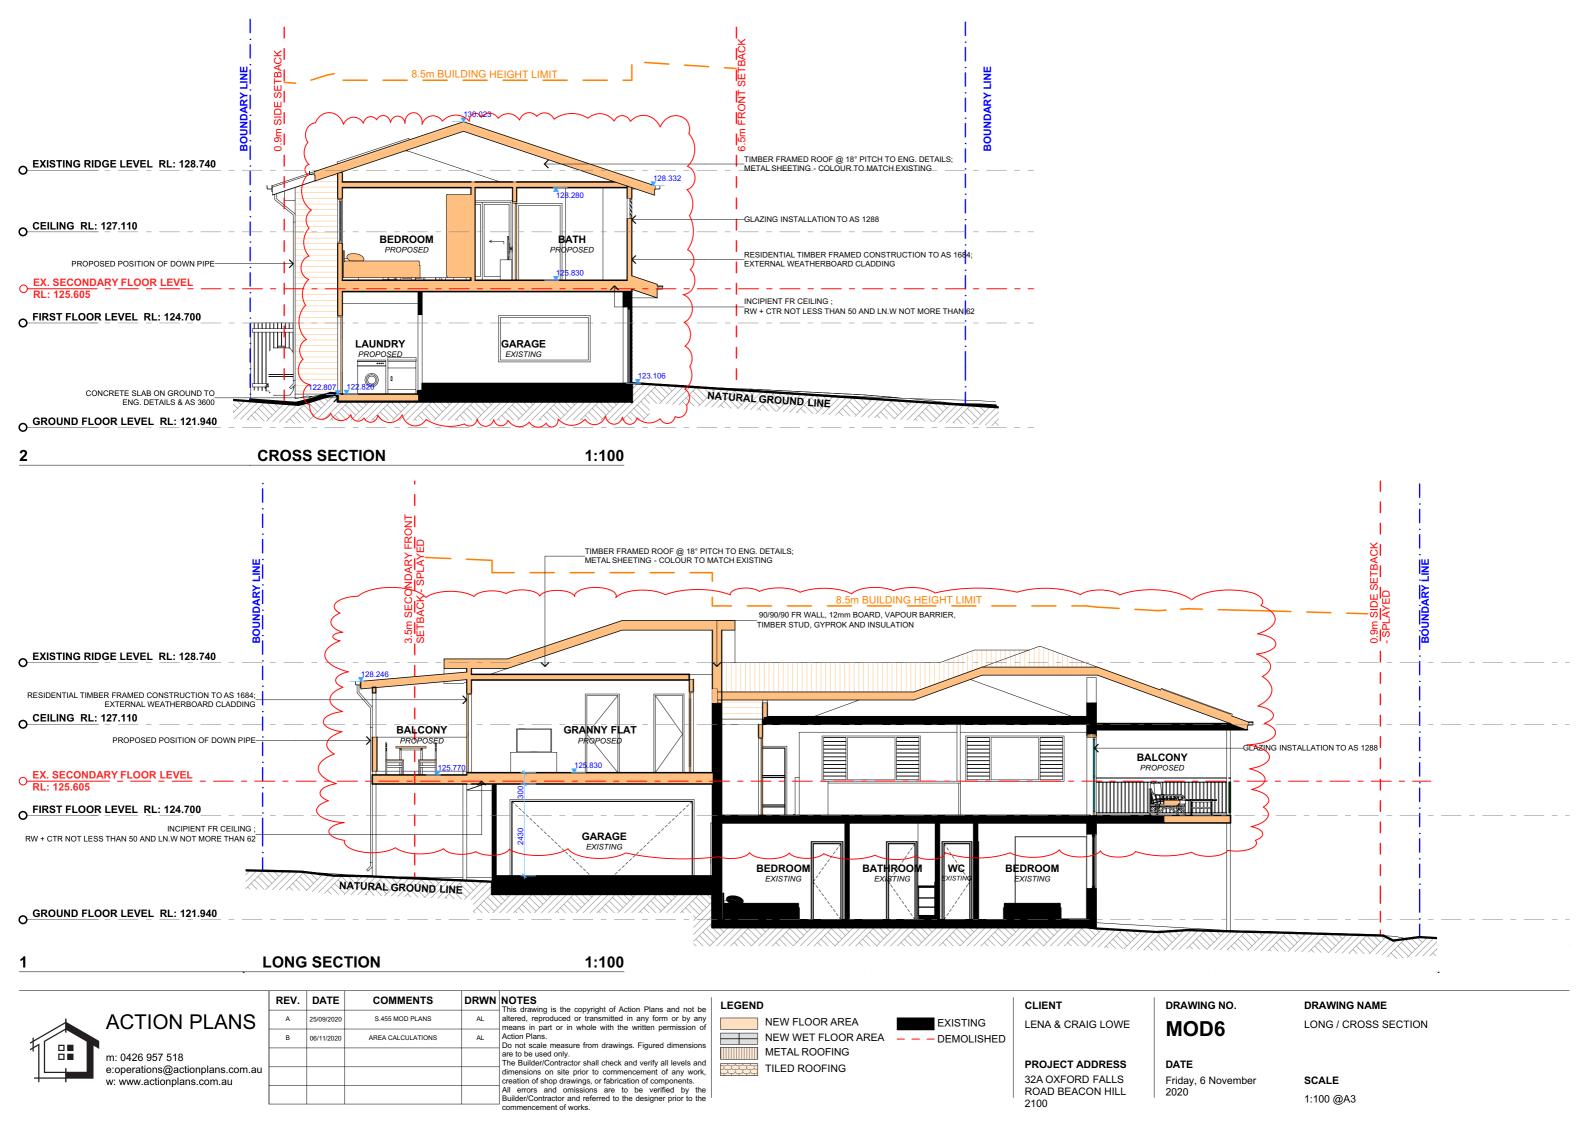PROPOSED AREA CALCULATIONS 1:200

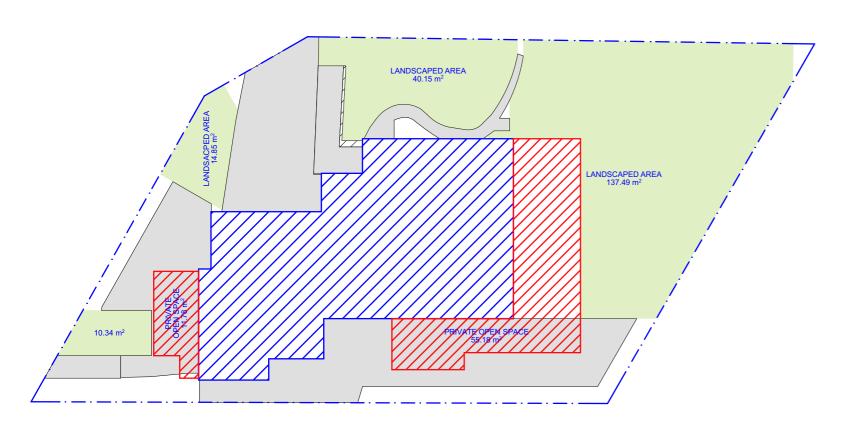

COMMENTS

### 1 EXISTING AREA CALCULATIONS 1:200

REV. DATE



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DRWN NOTES



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PROJECT ADDRESS
32A OXFORD FALLS
ROAD BEACON HILL
2100

MOD7

G NO. DRAWING NAME

AREA CALCULATIONS

DATE

Friday, 6 November 2020

SCALE 1:200 @A3

**CONTROL TABLE** 

40% (237.75m<sup>2</sup>)

**PROPOSED** 

7.5m

45.21m<sup>2</sup>

34% (202.83m<sup>2</sup>)

**REQUIRED** 


8.5m


SITE AREA 594.38m<sup>2</sup>

**LANDSCAPING** 

PRIVATE OPEN SPACE 60m<sup>2</sup>

**HEIGHT** 

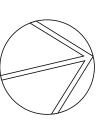


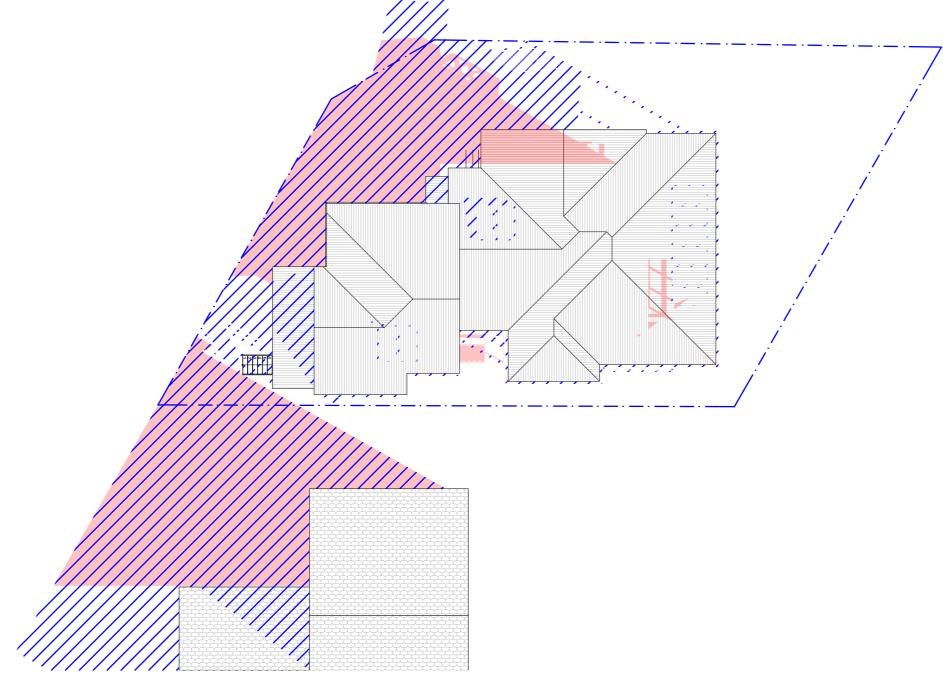

WINTER SOLSTICE 9AM 1:200

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All errors and omissions are to be vi		All errors and omissions are to be verified by the Builder/Contractor and referred to the designer prior to the	

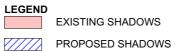

EXISTING SHADOWS

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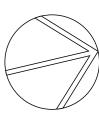
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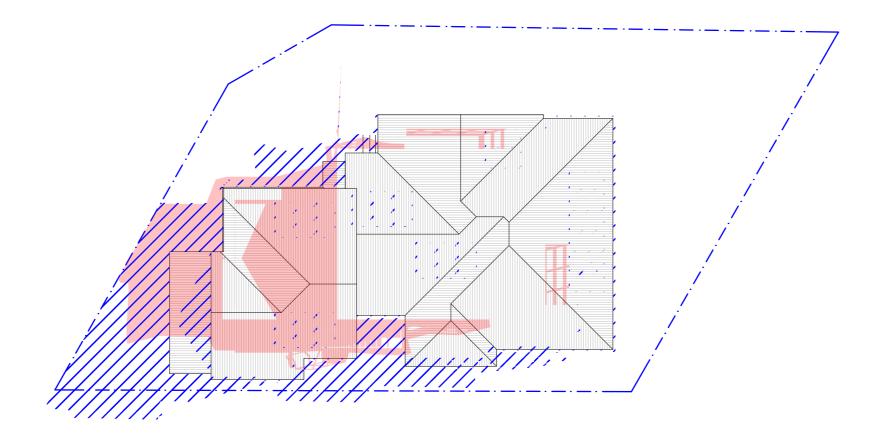
DRAWING NO. MOD8


DATE

DRAWING NAME WINTER SOLSTICE 9AM

Friday, 6 November 2020 SCALE 1:200 @A3






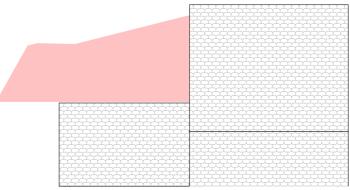

**WINTER SOLSTICE 12PM** 1:200



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				commencement of works.

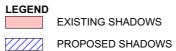

EXISTING SHADOWS

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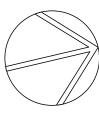
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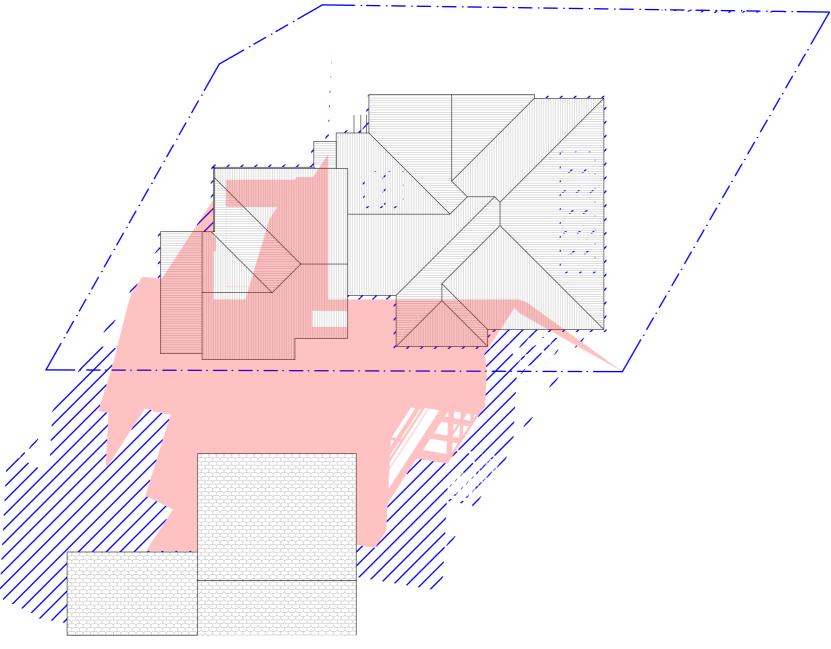
MOD9

DATE

DRAWING NAME WINTER SOLSTICE 9AM

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1 WINTER SOLSTICE 3PM 1:200



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EXISTING SHADOWS

PROPOSED SHADOWS

PROJECT ADDRESS 32A OXFORD FALLS ROAD BEACON HILL 2100

LENA & CRAIG LOWE

CLIENT

DRAWING NO.

MOD10

DATE

**Priday, 6 November** 2020

DRAWING NAME
WINTER SOLSTICE 9AM

**SCALE** 1:200 @A3

