STORMWATER MANAGEMENT PLAN

EROSION CONTROL

BEFORE EARTHWORKS CAN COMMENCE THE EROSION & SEDIMENT CONTROL MEASURES MUST BE IN PLACE.

DURING THE CONSTRUCTION PERIOD, THESE CONTROL MEASURES WILL NEED TO BE INSPECTED & MAINTAINED REGULARLY, ESPECIALLY AFTER STORM EVENTS, BY THE CONTRACTOR.

ALL WORK IS TO BE CARRIED OUT TO PREVENT EROSION, CONTAMINATION & SEDIMENTATION OF THE STORAGE SITE, SURROUNDING AREAS & DRAINAGE SYSTEMS.

MINIMIZE DISTURBED AREA COVERED WITH NATURAL VEGETATION. ONLY THOSE AREAS DIRECTLY REQUIRED FOR CONSTRUCTION ARE

INSTALL EROSION/SEDIMENT CONTROL MEASURES PRIOR TO COMMENCEMENT OF CONSTRUCTION OR EXCAVATION OPERATIONS.

PROVIDE SILT FENCE/STRAW BAIL BARRIERS TO THE LOW SIDE OF ALL EXPOSED EARTH EXCAVATIONS. TIE SEDIMENT FENCING MATERIAL TO CYCLONE WIRE SECURITY FENCE. SEDIMENT CONTROL FABRIC SHALL BE AN APPROVED MATERIAL (EG. HUMES PROPEX STOP) STANDING 300mm ABOVE GROUND & EXTENDING 150mm BELOW GROUND.

ISOLATE EXISTING STORMWATER PITS WITH STRAW BALES OR SILT TRAPS TO FILTER ALL INCOMING FLOWS.

DO NOT STOCKPILE EXCAVATED MATERIAL ON THE ROAD WAY.

DIVERT CLEAN WATER FROM UNDISTURBED AREAS AROUND THE WORKING AREAS.

CONSTRUCTION ENTRY/EXIT SHALL BE VIA THE LOCATION NOTED ON THE DRAWING. CONTRACTOR SHALL ENSURE ALL DROPPABLE SOIL & SEDIMENT IS REMOVED PRIOR TO CONSTRUCTION TRAFFIC EXITING SITE. CONTRACTOR SHALL ENSURE ALL CONSTRUCTION TRAFFIC ENTERING AND LEAVING THE SITE DO SO IN A FORWARD

TREAT THE STORMWATER RUNOFF WITH SUSPENDED SOLIDS SO THE DISCHARGE WATER QUALITY TO COUNCIL STORMWATER DRAINAGE SYSTEM HAS A MAXIMUM CONCENTRATION OF SUSPENDED SOLIDS THAT DOES NOT EXCEED 50 MILLIGRAMS PER LITRE IN ACCORDANCE WITH THE PROTECTION OF THE ENVIRONMENT OPERATION ACT (POEO 1997) AND SHALL BE APPROVED BY LOCAL COUNCIL

ADOPT TEMPORARY MEASURES AS MAY BE NECESSARY FOR EROSION & SEDIMENT CONTROL, INCLUDING BUT NOT LIMITED TO

DRAINS: TEMPORARY DRAINS AND CATCH DRAINS.
 SPREADER BANKS OR OTHER STRUCTURES: TO DISPERSE.

CONCENTRATED RUNOFF.

SILT TRAPS: CONSTRUCTION AND MAINTENANCE OF SILT TRAPS TO PREVENT DISCHARGE OF SCOURED MATERIAL TO DOWNSTREAM

AFTER RAIN, INSPECT, CLEAN, AND REPAIR IF REQUIRED, TEMPORARY EROSION & SEDIMENT CONTROL MEASURES.

REMOVE TEMPORARY EROSION & SEDIMENT CONTROL MEASURES

COMPLY WITH THE REQUIREMENTS OF LANDCOM'S MANAGING URBAN STORMWATER - SOIL AND CONSTRUCTION 'THE BLUE BOOK' LATEST EDITION

THE EROSION & SEDIMENT CONTROL PLAN PROVIDED IS ONLY INDICATIVE. THE CONTRACTOR SHOULD PREPARE A DETAILED ESCP SUITABLE FOR THE SPECIFIC SITE CONDITIONS



DIAL BEFORE YOU DIG SHOULD BE CONTACTED PRIOR TO ANY EXCAVATION ON SITE

TM: TRADE MARK OF THE ASSOCIATION OF DIAL BEFORE YOU DIG SERVICES LTD. USED

GENERAL NOTES

ALL WORK SHALL BE CARRIED OUT IN ACCORDANCE WITH COUNCIL'S REQUIREMENTS, BUILDING CODE OF AUSTRALIA, NSW CODE OF PRACTICE AND THE TO THE RELEVANT SERVICE CODES.

THESE DRAWINGS SHALL BE READ IN CONJUNCTION WITH ALL ARCHITECTURAL AND OTHER CONSULTANTS' DRAWINGS AND SPECIFICATIONS AND WITH SUCH OTHER WRITTEN INSTRUCTIONS AS MAY BE ISSUED DURING THE COURSE OF THE CONTRACT. ALL DISCREPANCIES SHALL BE REFERRED TO THE SUPERINTENDENT FOR DECISION BEFORE PROCEEDING WITH THE WORK.

ALL DIMENSIONS SHOWN ON THE DRAWINGS ARE IN MILLIMETERS (U.N.O.). DIMENSIONS SHALL NOT BE OBTAINED BY SCALING OF THESE DRAWINGS. USE FIGURED DIMENSIONS ONLY.

BENCHMARKS HAVE BEEN ESTABLISHED WHERE INDICATED ON THE DRAWINGS. ALL LEVELS ARE TO AUSTRALIAN HEIGHT DATUM (A.H.D.) THE CONTRACTOR SHALL UNDERTAKE ALL NECESSARY SURVEY WORK TO ENSURE THAT THE WORKS ARE CONSTRUCTED TO DESIGN LINE AND

SETTING OUT DIMENSIONS AND LEVELS SHOWN ON THE DRAWINGS SHALL BE VERIFIED BY THE CONTRACTOR.

ALL MATERIALS SHALL BE IN ACCORDANCE WITH THE REQUIREMENTS THE RELEVANT SAA CODES AND THE BY-LAWS AND ORDINANCES THE RELEVANT BUILDING AUTHORITIES.

IT IS THE CONTRACTOR'S RESPONSIBILITY TO PROVIDE ALL SAFETY FENCES, WARNING SIGNS, TRAFFIC DIVERSIONS AND THE LIKE DURING CONSTRUCTION. ALL WORKS TO COMPLY WITH WORK HEALTH AND REQUIREMENTS AND OTHER RELEVANT AUTHORITY SAFETY

NO TREES SHALL BE REMOVED, CUTBACK OR RELOCATED WITHOUT THE WRITTEN INSTRUCTION FROM THE SUPERINTENDENT.

WHERE NEW WORKS ABUT EXISTING THE CONTRACTOR SHALL ENSURE THAT A SMOOTH EVEN PROFILE, FREE FROM ABRUPT CHANGES IS

WORKS SHALL BE CARRIED OUT IN ACCORDANCE WITH THE DETAILS SHOWN ON THE DRAWINGS AND THESE SPECIFICATIONS.

DESIGN LEVELS GIVEN ARE TO FINISHED SURFACE LEVEL AND INCLUSIVE OF TOPSOIL. (TOPSOIL DEPTH VARIES)

THE CONTRACTOR SHALL ARRANGE ALL SURVEY SETOUT TO BE CARRIED OUT BY A N.A.T.A. REGISTERED SURVEYOR.

CARE IS TO BE TAKEN WHEN EXCAVATING NEAR EXISTING SERVICES. NO MECHANICAL EXCAVATIONS ARE TO BE UNDERTAKEN OVER TELECOMMUNICATIONS OR ELECTRICAL SERVICES. HAND EXCAVATE IN

THE LOCATIONS OF UNDERGROUND SERVICES SHOWN ON THE DRAWING HAVE BEEN PLOTTED FROM DIAGRAMS PROVIDED BY SERVICE THIS INFORMATION HAS BEEN PREPARED SOLELY FOR THE AUTHORITIES OWN USE AND MAY NOT NECESSARILY BE UPDATED

THE POSITION OF SERVICES AS RECORDED BY THE AUTHORITY AT THE TIME OF INSTALLATION MAY NOT REFLECT CHANGES IN THE PHYSICAL ENVIRONMENT SUBSEQUENT TO INSTALLATION.

MODULAR ENGINEERS DOES NOT GUARANTEE THAT THE SERVICES INFORMATION SHOWN ON THE DRAWING SHOWS MORE THAN THE PRESENCE OR ABSENCE OF SERVICES, AND WILL ACCEPT NO LIABILITY FOR INACCURACIES IN THE SERVICES INFORMATION SHOWN FROM ANY CAUSE WHATSOEVER.

IT IS THE CONTRACTOR'S RESPONSIBILITY TO OBTAIN FROM THE UTILITY SERVICES AUTHORITIES A CURRENT COPY OF UNDERGROUND SERVICES SEARCH FOR THE LOCATION OF ALL EXISTING SERVICES PRIOR TO COMMENCEMENT OF ANY WORK AND NOTIFY ANY CONFLICT WITH THE DRAWINGS IMMEDIATELY. CLEARANCE SHALL BE OBTAINED FROM THE RELEVANT REGULATORY AUTHORITY. CONTRACTOR TO KEEP COPY OF UNDERGROUND SERVICES SEARCH ON SITE AT ALL TIMES ANY DAMAGES TO SERVICES OR SERVICES ADJUSTMENTS SHALL BE CARRIED OUT BY THE CONTRACTOR OR RELEVANT AUTHORITY AT THE CONTRACTOR'S EXPENSE.

VISIT THE SITE BEFORE SUBMITTING THE FINAL TENDER PRICE TO ASSESS 'ON SITE' CONDITIONS. FAILURE TO DO SO WILL FORFEIT ANY CLAIM FOR NOT BEING AWARE OF CONDITIONS AFFECTING THE TENDER

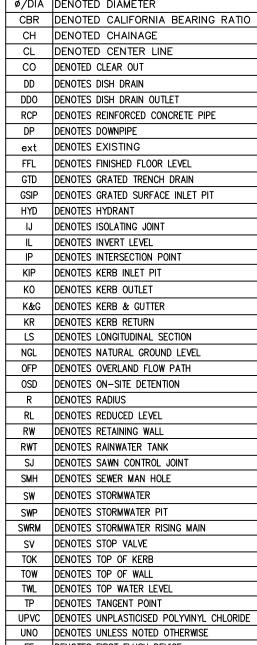
THE CONTRACTOR SHALL PREPARE ACCURATE WORK-AS-EXECUTED DRAWINGS FOLLOWING THE COMPLETION OF ALL WORKS.

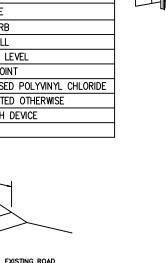
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IS THE CONTRACTOR'S RESPONSIBILITY TO HAVE IN PLACE & MAINTAIN TRAFFIC FACILITIES AT ALL TIMES DURING CONSTRUCTION. 100 110

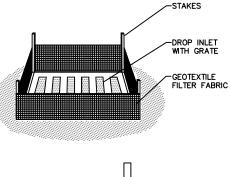
- A-	LEGEND
<u> </u>	DENOTED DOWN PIPE SPREADER
DP	DENOTES DOWN-PIPE
eDP	DENOTES EXISTING DOWN-PIPE
RWH_	DENOTES RAINWATER HEAD WITH DOWN-PIPE
	DENOTES RAINWATER CHARGED LINE
	DENOTES STORMWATER 1% MIN. FALL GRAVITY LINE
	DENOTES STORMWATER SEALED CHARGE LINE
/	DENOTES RAINWATER SEALED CHARGE LINE
	DENOTES ANTICIPATED ALIGNMENT OF EXISTING UNDERGROUND STORMWATER SYSTEM
	DENOTES SUBSOIL LINE
sw	DENOTES EXISTING STORMWATER LINE
s	DENOTES AUTHORITY SEWER LINE
	DENOTES SEDIMENT FENCE
Œ	DENOTES CLEAR OUT EYE POINT
Œ	DENOTES SEALED CLEAR OUT EYE POINT
	DENOTES GRATED SURFACE INLET PIT
	DENOTES GRATED TRENCH DRAIN
× 00.00	DENOTES PROPOSED SPOT LEVEL
	DENOTES EXISTING GRATED SURFACE INLET PIT
\boxtimes	DENOTES EXISTING JUNCTION PIT
	DENOTES EXISTING KERB INLET PIT
eTEL	DENOTES EXISTING TELSTRA PIT
⊞ eHYD	DENOTES EXISTING HYDRANT
eSV	DENOTES EXISTING STOP VALVE
⊠ eGAS	DENOTES EXISTING GAS VALVE
O ePP	DENOTES EXISTING POWER POLE
Oesmh	DENOTES EXISTING SEWER MANHOLE
OFP	DENOTES OVERLAND FLOW PATH

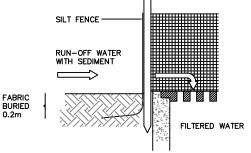
		ABBREVIATIONS
	ø/DIA	DENOTED DIAMETER
	CBR	DENOTED CALIFORNIA BEARING RATIO
	СН	DENOTED CHAINAGE
	CL	DENOTED CENTER LINE
	СО	DENOTED CLEAR OUT
LINE	DD	DENOTES DISH DRAIN
LINE	DDO	DENOTES DISH DRAIN OUTLET
	RCP	DENOTES REINFORCED CONCRETE PIPE
`	DP	DENOTES DOWNPIPE
,	ext	DENOTES EXISTING
	FFL	DENOTES FINISHED FLOOR LEVEL
	GTD	DENOTES GRATED TRENCH DRAIN
	GSIP	DENOTES GRATED SURFACE INLET PIT
	HYD	DENOTES HYDRANT
	IJ	DENOTES ISOLATING JOINT
	IL	DENOTES INVERT LEVEL
	IP	DENOTES INTERSECTION POINT
	KIP	DENOTES KERB INLET PIT
	ко	DENOTES KERB OUTLET
	K&G	DENOTES KERB & GUTTER
Γ	KR	DENOTES KERB RETURN
	LS	DENOTES LONGITUDINAL SECTION
	NGL	DENOTES NATURAL GROUND LEVEL
	OFP	DENOTES OVERLAND FLOW PATH
	OSD	DENOTES ON-SITE DETENTION
	R	DENOTES RADIUS
	RL	DENOTES REDUCED LEVEL
	RW	DENOTES RETAINING WALL
	RWT	DENOTES RAINWATER TANK
	SJ	DENOTES SAWN CONTROL JOINT
	SMH	DENOTES SEWER MAN HOLE
	SW	DENOTES STORMWATER
	SWP	DENOTES STORMWATER PIT
	SWRM	DENOTES STORMWATER RISING MAIN
	SV	DENOTES STOP VALVE
	TOK	DENOTES TOP OF KERB
	TOW	DENOTES TOP OF WALL
	TWL	DENOTES TOP WATER LEVEL
	TP	DENOTES TANGENT POINT
	UPVC	DENOTES UNPLASTICISED POLYVINYL CHLORIDE
	UNO	DENOTES UNLESS NOTED OTHERWISE
	FF	DENOTES FIRST FLUSH DEVICE
15m MINIMUM	TYP	DENOTES TYPICAL
MOM	LENGTH	
_		












SUMP SEDIMENT TRAP NOT TO SCALE

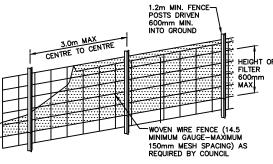

DIAGRAMMATIC VIEW

1.2 MIN FENCE -POST FENCE WITH FILTER CLOTH 200 ₹ EMBEDED FILTER CLOTH MINIMUM 200mm INTO GROUND TYPICAL SECTION

SEDIMENT FENCE DETAIL

TEMPORARY	CONSTRUCTION	EXIT	(RUBBLE	ALTERNATIVE
	NOT TO	SCALE	•	

SIZE:	A3 ℃	10	20	30	40	50	60	70	80	90	100	110		
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В	10-FEB-	-2025	ISSUED	FOR CD		S.R.	S.R.	RPEQ(28316),						
								PDP000	oia)No.00)0072,	07689,				
								DEP000						



CONSTRUCTION SITE

GEOTEXTILE FABRIC-

ODULAR ENGINEERS ptv Itd 6/7 PARKES STREET, PARRAMATTA NSW 2150 02 873 08473


RUN-OFF FROM

PAD DIRECTED TO SEDIMENT TRAP

04 208 98999 info@modularengineers.com.au BN 66 646 960 929

USE OF THESE DRAWINGS THE DESIGN AND DETAILS SHOWN ON THESE DRAWINGS ARE APPLICABLE TO THIS PROJECT ONLY AND MAY NOT BE REPRODUCED IN WHOLE OR IN PART OR BE USED FOR ANY OTHER PROJECT OR PURPOSE WITHOUT THE WRITTEN PERMISSION OF MODULAR ENGINEERS WITH WHOM COPYRIGHT RESIDES

PROJECT TITLE :	PROPOSED CONSTRUCTION OF ADDITIONS
PROJECT ADDRESS :	77 MYOLA ROAD, NEWPORT, NSW 2106
PROJECT NO. :	STW232-2024
DRAWING TITLE :	TITLE PAGE, GENERAL NOTES, AND DETAILS—1
DRAWING NO. :	STW001
ISSUE DATE :	23-0CT-2024

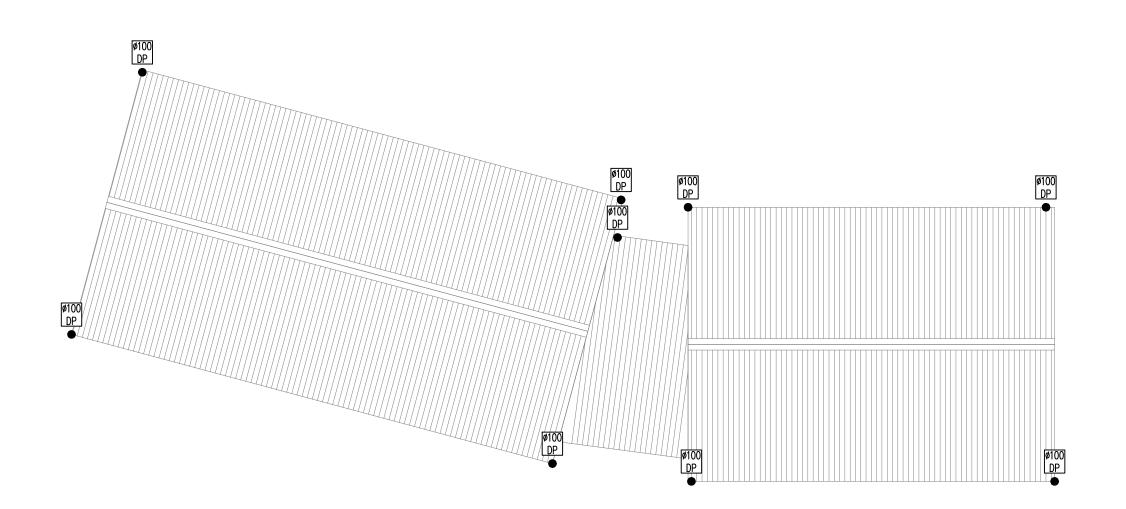

PIPE SCHEDULE SIZE MATERIAL GRADE TYPE Α GRAVITY DAI.100 P.V.C. MIN. 1% В DAI.150 P.V.C. MIN. 1% GRAVITY Χ DAI.100 P.V.C. CHARGE TO RWT/PIT 200X100 GALV. STEEL D MIN. 1% TO KERB E EXISTING **EXISTING EXISTING EXISTING**

STORMWATER ROOF PLAN

SCALE: 1:100

SIZE: /	43 0 10	20	30	40 50	60	70	80	90	100	110	120	
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REV.	DATE	DESC	RIPTION	D.P.ENG.	DFT.			ALI AL-C	BAIDI		П.	

		REVISIONS			APPROVED BY	
REV.	DATE	DESCRIPTION	D.P.ENG.	DFT.	ALI AL-OBAIDI	N /
Α	23-OCT-2024	ISSUED FOR CDC	S.R.	S.R.	MSc, BSc, MIEAust,CPEng,NER,NPER (No: 5358554).	IV
В	10-FEB-2025	ISSUED FOR CDC	S.R.	S.R.	RPEQ(28316),	
					PE(Victoia)No.0007689, PDP0000072,	ΕN
					PRE0000191,	



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PROJECT ADDRESS :	77 MYOLA ROAD, NEWPORT, NSW 2106
PROJECT NO. :	STW232-2024
DRAWING TITLE :	STORMWATER DESIGN PLANS
DRAWING NO. :	STW002
ISSUE DATE :	23-0CT-2024

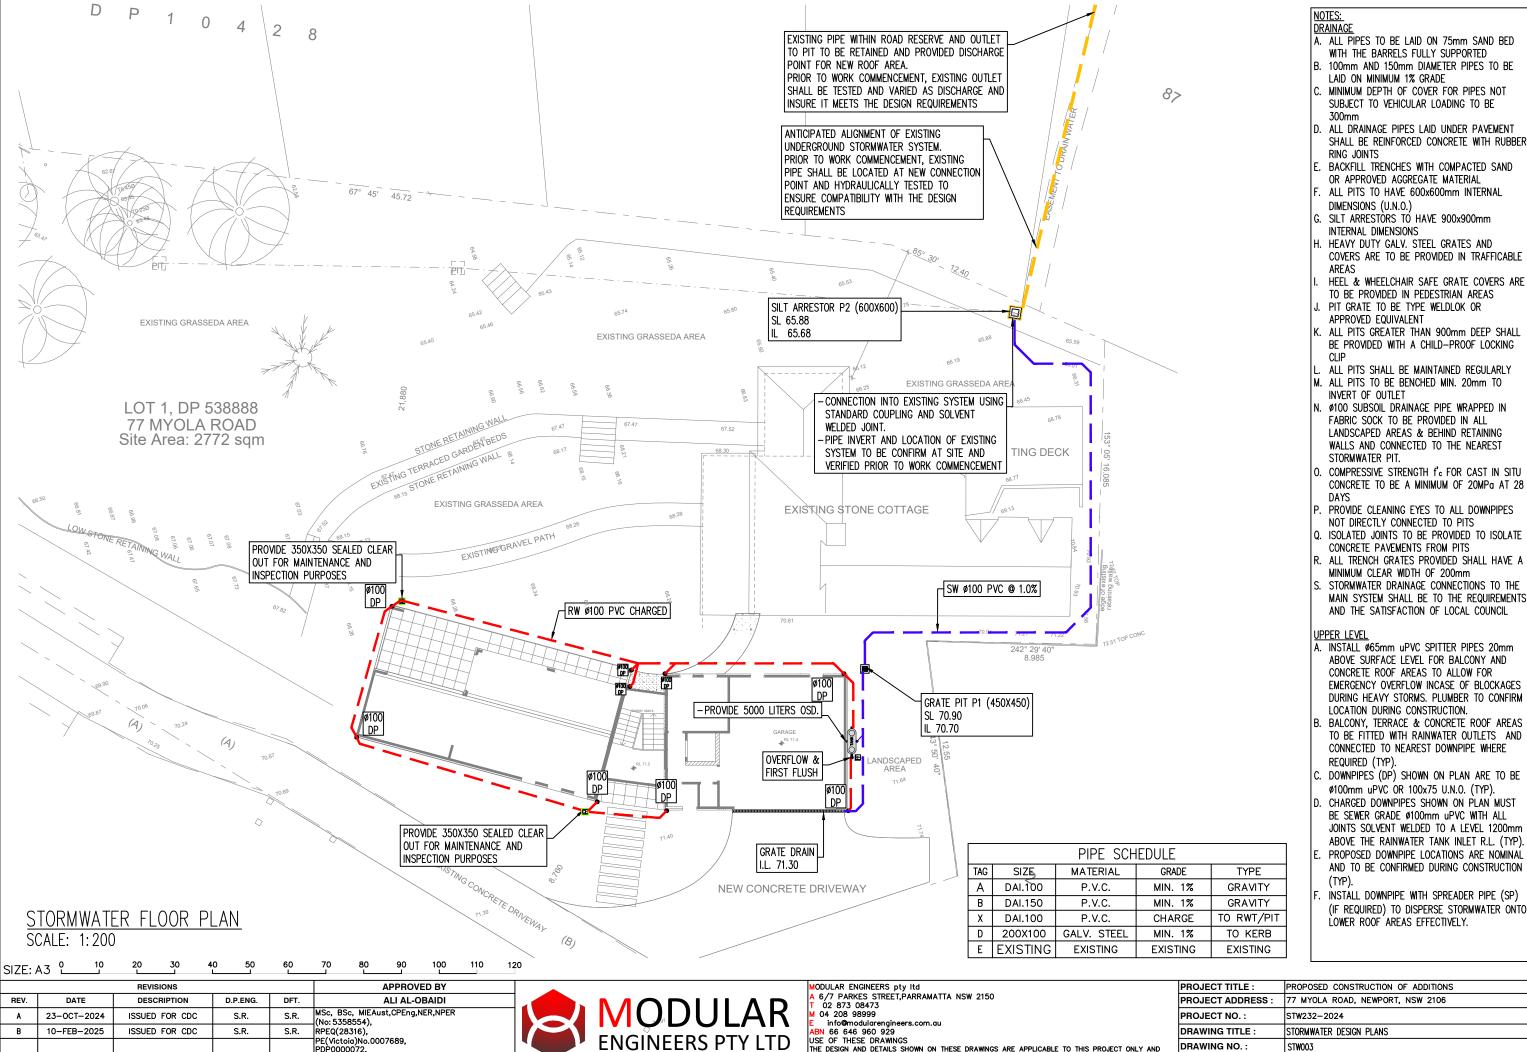
NOTES:

<u>DRAINAGE</u> A. ALL PIPES TO BE LAID ON

- A. ALL PIPES TO BE LAID ON 75mm SAND BED WITH THE BARRELS FULLY SUPPORTED
- B. 100mm and 150mm diameter pipes to be Laid on Minimum 1% grade
- MINIMUM DEPTH OF COVER FOR PIPES NOT SUBJECT TO VEHICULAR LOADING TO BE 300mm
- D. ALL DRAINAGE PIPES LAID UNDER PAVEMENT SHALL BE REINFORCED CONCRETE WITH RUBBER RING JOINTS
- E. BACKFILL TRENCHES WITH COMPACTED SAND OR APPROVED AGGREGATE MATERIAL
- . ALL PITS TO HAVE 600x600mm INTERNAL DIMENSIONS (U.N.O.)
- G. SILT ARRESTORS TO HAVE 900x900mm INTERNAL DIMENSIONS
- H. HEAVY DUTY GALV. STEEL GRATES AND
 COVERS ARE TO BE PROVIDED IN TRAFFICABLE
 AREAS
- I. HEEL & WHEELCHAIR SAFE GRATE COVERS ARE TO BE PROVIDED IN PEDESTRIAN AREAS J. PIT GRATE TO BE TYPE WELDLOK OR
- APPROVED EQUIVALENT
 K. ALL PITS GREATER THAN 900mm DEEP SHALL
 BE PROVIDED WITH A CHILD-PROOF LOCKING
- L. ALL PITS SHALL BE MAINTAINED REGULARLY
- M. ALL PITS TO BE BENCHED MIN. 20mm TO INVERT OF OUTLET
- N. Ø100 SUBSOIL DRAINAGE PIPE WRAPPED IN FABRIC SOCK TO BE PROVIDED IN ALL LANDSCAPED AREAS & BEHIND RETAINING WALLS AND CONNECTED TO THE NEAREST STORMWATER PIT.
- O. COMPRESSIVE STRENGTH f'e FOR CAST IN SITU CONCRETE TO BE A MINIMUM OF 20MPa AT 28 DAYS
- P. PROVIDE CLEANING EYES TO ALL DOWNPIPES NOT DIRECTLY CONNECTED TO PITS Q. ISOLATED JOINTS TO BE PROVIDED TO ISOLATE
- CONCRETE PAVEMENTS FROM PITS
 R. ALL TRENCH GRATES PROVIDED SHALL HAVE A
- MINIMUM CLEAR WIDTH OF 200mm
- S. STORMWATER DRAINAGE CONNECTIONS TO THE MAIN SYSTEM SHALL BE TO THE REQUIREMENTS AND THE SATISFACTION OF LOCAL COUNCIL

UPPER LEVEL

- A. INSTALL Ø65mm upvc spitter pipes 20mm above surface level for balcony and concrete roof areas to allow for emergency overflow incase of blockages during heavy storms. Plumber to confirm location during construction.
- BALCONY, TERRACE & CONCRETE ROOF AREAS TO BE FITTED WITH RAINWATER OUTLETS AND CONNECTED TO NEAREST DOWNPIPE WHERE REQUIRED (TYP).
- C. DOWNPIPES (DP) SHOWN ON PLAN ARE TO BE Ø100mm uPVC OR 100x75 U.N.O. (TYP).
- D. CHARGED DOWNPIPES SHOWN ON PLAN MUST BE SEWER GRADE Ø100mm uPVC WITH ALL JOINTS SOLVENT WELDED TO A LEVEL 1200mm ABOVE THE RAINWATER TANK INLET R.L. (TYP).
- PROPOSED DOWNPIPE LOCATIONS ARE NOMINAL AND TO BE CONFIRMED DURING CONSTRUCTION (TYP).
- F. INSTALL DOWNPIPE WITH SPREADER PIPE (SP)
 (IF REQUIRED) TO DISPERSE STORMWATER ONTO LOWER ROOF AREAS EFFECTIVELY.




PE(Victoia)No.0007689, PDP0000072,

PRF0000191

PROPOSED CONSTRUCTION OF ADDITIONS 77 MYOLA ROAD, NEWPORT, NSW 2106 DRAWING TITLE : STORMWATER DESIGN PLANS DRAWING NO.: STW003 ISSUE DATE : 23-OCT-2024

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TYPE **GRAVITY** В DAI.150 P.V.C. MIN. 1% GRAVITY Χ DAI.100 P.V.C. CHARGE TO RWT/PIT 200X100 GALV. STEEL MIN. 1% TO KERB D E EXISTING **EXISTING EXISTING EXISTING**

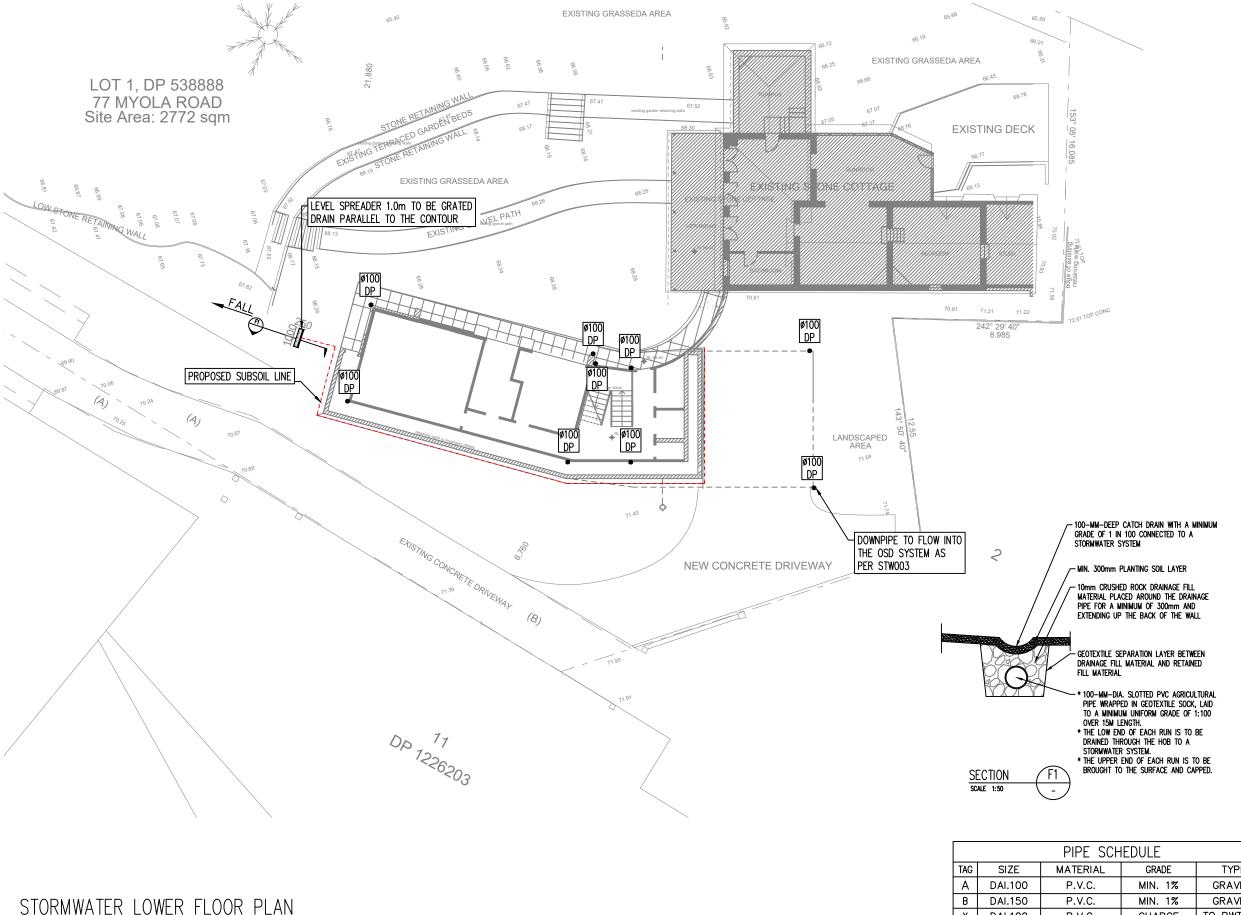DRAINAGE

- A. ALL PIPES TO BE LAID ON 75mm SAND BED WITH THE BARRELS FULLY SUPPORTED
- B. 100mm AND 150mm DIAMETER PIPES TO BE LAID ON MINIMUM 1% GRADE
 - MINIMUM DEPTH OF COVER FOR PIPES NOT SUBJECT TO VEHICULAR LOADING TO BE
- D. ALL DRAINAGE PIPES LAID UNDER PAVEMENT SHALL BE REINFORCED CONCRETE WITH RUBBER RING JOINTS
- BACKFILL TRENCHES WITH COMPACTED SAND OR APPROVED AGGREGATE MATERIAL
- ALL PITS TO HAVE 600x600mm INTERNAL DIMENSIONS (U.N.O.)
- G. SILT ARRESTÒRS TÓ HAVE 900x900mm INTERNAL DIMENSIONS
- HEAVY DUTY GALV. STEEL GRATES AND COVERS ARE TO BE PROVIDED IN TRAFFICABLE
- HEEL & WHEELCHAIR SAFE GRATE COVERS ARE TO BE PROVIDED IN PEDESTRIAN AREAS PIT GRATE TO BE TYPE WELDLOK OR APPROVED EQUIVALENT
- K. ALL PITS GREATER THAN 900mm DEEP SHALL BE PROVIDED WITH A CHILD-PROOF LOCKING
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- CONCRETE PAVEMENTS FROM PITS ALL TRENCH GRATES PROVIDED SHALL HAVE A
- MINIMUM CLEAR WIDTH OF 200mm
- STORMWATER DRAINAGE CONNECTIONS TO THE MAIN SYSTEM SHALL BE TO THE REQUIREMENTS AND THE SATISFACTION OF LOCAL COUNCIL

UPPER LEVEL

- A. INSTALL Ø65mm uPVC SPITTER PIPES 20mm ABOVE SURFACE LEVEL FOR BALCONY AND CONCRETE ROOF AREAS TO ALLOW FOR EMERGENCY OVERFLOW INCASE OF BLOCKAGES DURING HEAVY STORMS. PLUMBER TO CONFIRM LOCATION DURING CONSTRUCTION.
- BALCONY, TERRACE & CONCRETE ROOF AREAS TO BE FITTED WITH RAINWATER OUTLETS AND CONNECTED TO NEAREST DOWNPIPE WHERE REQUIRED (TYP).
- DOWNPIPES (DP) SHOWN ON PLAN ARE TO BE ø100mm uPVC OR 100x75 U.N.O. (TYP).
- CHARGED DOWNPIPES SHOWN ON PLAN MUST BE SEWER GRADE Ø100mm uPVC WITH ALL JOINTS SOLVENT WELDED TO A LEVEL 1200mm ABOVE THE RAINWATER TANK INLET R.L. (TYP)
- PROPOSED DOWNPIPE LOCATIONS ARE NOMINAL AND TO BE CONFIRMED DURING CONSTRUCTION
- INSTALL DOWNPIPE WITH SPREADER PIPE (SP) (IF REQUIRED) TO DISPERSE STORMWATER ONTO LOWER ROOF AREAS EFFECTIVELY.

SIZE: /	43 0 10	20 30 4	-0 50 └── ─	60		80		100	110	120
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В	10-FEB-2025	ISSUED FOR CDC	S.R.		RPEQ(28					

PE(Victoia)No.0007689, PDP0000072,

PRF0000191

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PROJECT TITLE :	PROPOSED CONSTRUCTION OF ADDITIONS
PROJECT ADDRESS :	77 MYOLA ROAD, NEWPORT, NSW 2106
PROJECT NO. :	STW232-2024
DRAWING TITLE :	STORMWATER DESIGN PLANS
DRAWING NO. :	STW004
ISSUE DATE :	23-OCT-2024



DRAIN MODELING RESULTS							
STORM EVENT (ARI)	SITE DISCHA	OSD STORAGE (m3)					
STORM EVENT (ART)	EXISTING	DEVELOPED	OSD STORAGE (IIIS)				
1%AEP	174	165	4.5				
2%AEP	147	139	3.5				
5%AEP	131	2.7					
20% AEP	1.9						
USED OSD STORAGE	5						
ORIFICE DIAMETER	40						

INTER ALLOTMENT PIPE CAPACITY

Flow Volume: 21.998L/s Flow Velocity: 1.245m/s Pipe Size: 150mm

Flow Depth: 100%

Maximum Flow Volume: 23.663L/s Maximum Flow Velocity: 1.419m/s

Pipe Shape Circular

Diameter (mm)

Pipe Material Thermoplastics

Roughness (n)

0.009

Pipe Slope (%)

Design Flow Rate (L/s) 19 (AS SHOWN ABOVE)

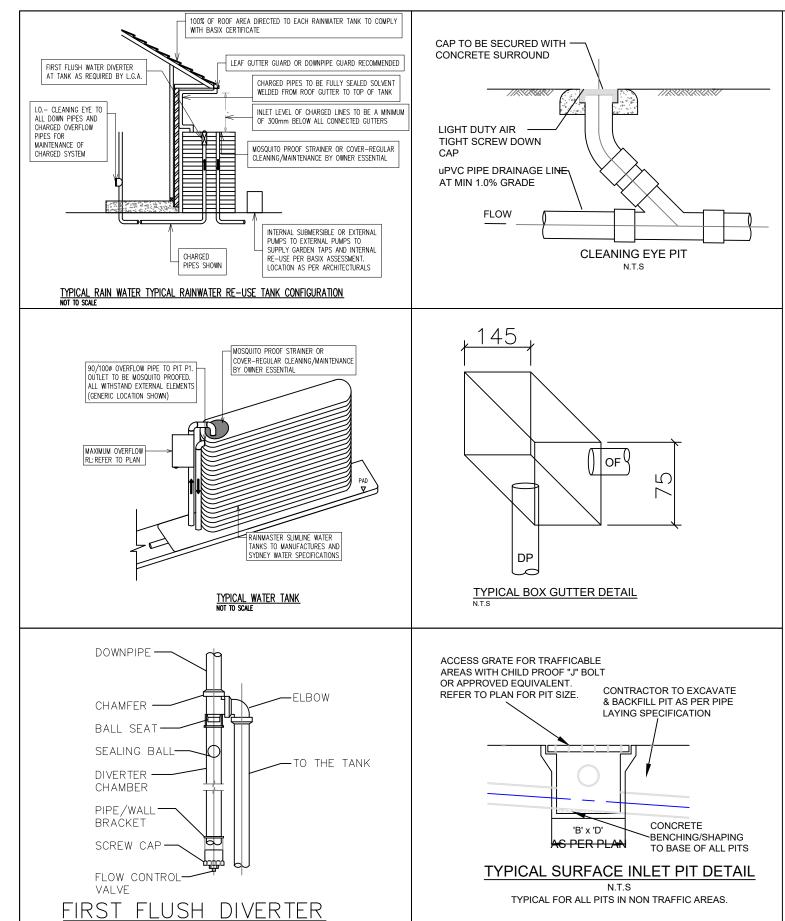
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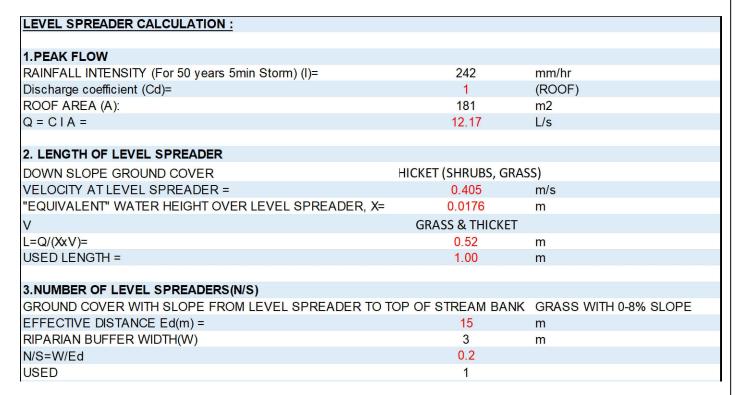
		REVISIONS	APPROVED BY		
REV.	DATE	DESCRIPTION	D.P.ENG.	DFT.	ALI AL-OBAIDI
A	23-0CT-2024	ISSUED FOR CDC	S.R.		MSc, BSc, MIEAust,CPEng,NER,NPER (No: 5358554).
В	10-FEB-2025	ISSUED FOR CDC	S.R.	S.R.	RPEQ(28316),
					PE(Victoia)No.0007689, PDP0000072,
					PRE0000191, IDEP0000203

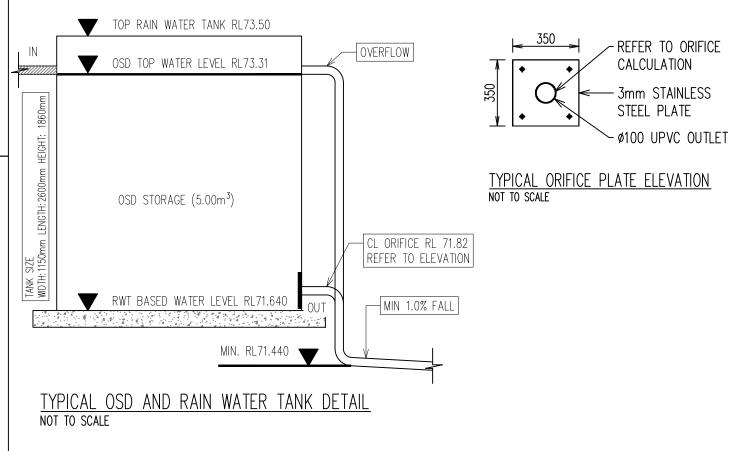


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DRAWING TITLE :	STORMWATER DETAILS AND NOTES
DRAWING NO. :	STW006
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