

NORTHERN SYDNEY
Seascape
Suite 7 22-27 Fisher Rd
Dee Why NSW 2099

BLUE MOUNTAINS Shop 1 274 Macquarie Rd Springwood NSW 2777 CONSULTING ENGINEERS
Civil
Structural
Stormwater & Flood

3 October 2024

Chief Executive Officer Northern Beaches Council 725 Pittwater Road Dee Why NSW 2099

Address of the Project: 1112-1116 Barrenjoey Road, Palm Beach

Description of Project: Drainage Letter - New Dwelling

With reference to the Development Application for the above property, please find copies of the site Stormwater Management Plan, **STORM-1/B**, Basement Stormwater Management Plan, **STORM-2/B** and Stormwater Management Details, **STORM-3/B**, for your perusal.

The plan shows collected flows from the proposed roof areas, along with surrounding hardstand and landscaped areas, discharging into the existing council drainage system located at the front of the site.

Note that as the site is classified as flood affected, there has been no on-site detention system provided, in accordance with Council policy. 2 x 6000 litre rainwater storage tanks for non-potable domestic reuse have been provided in accordance with BASIX requirements.

Note that the basement drainage system includes the pump and sump which collects basement flows before pumping them up to the surface level drainage system at the site frontage.

The plan also shows that water quality devices should be included within the stormwater drainage system in order to comply with the Council Water Management Policy for Development. The MUSIC modelling file is attached for your perusal.

Should you require any further information, please contact the undersigned.


Yours faithfully TAYLORCONSULTING.NET.AU

**D.M.Schaefer - Director** B.E Civil (Hons) M.I.E. Aust. N.E.R.



TAYLOR Page 1 of 1



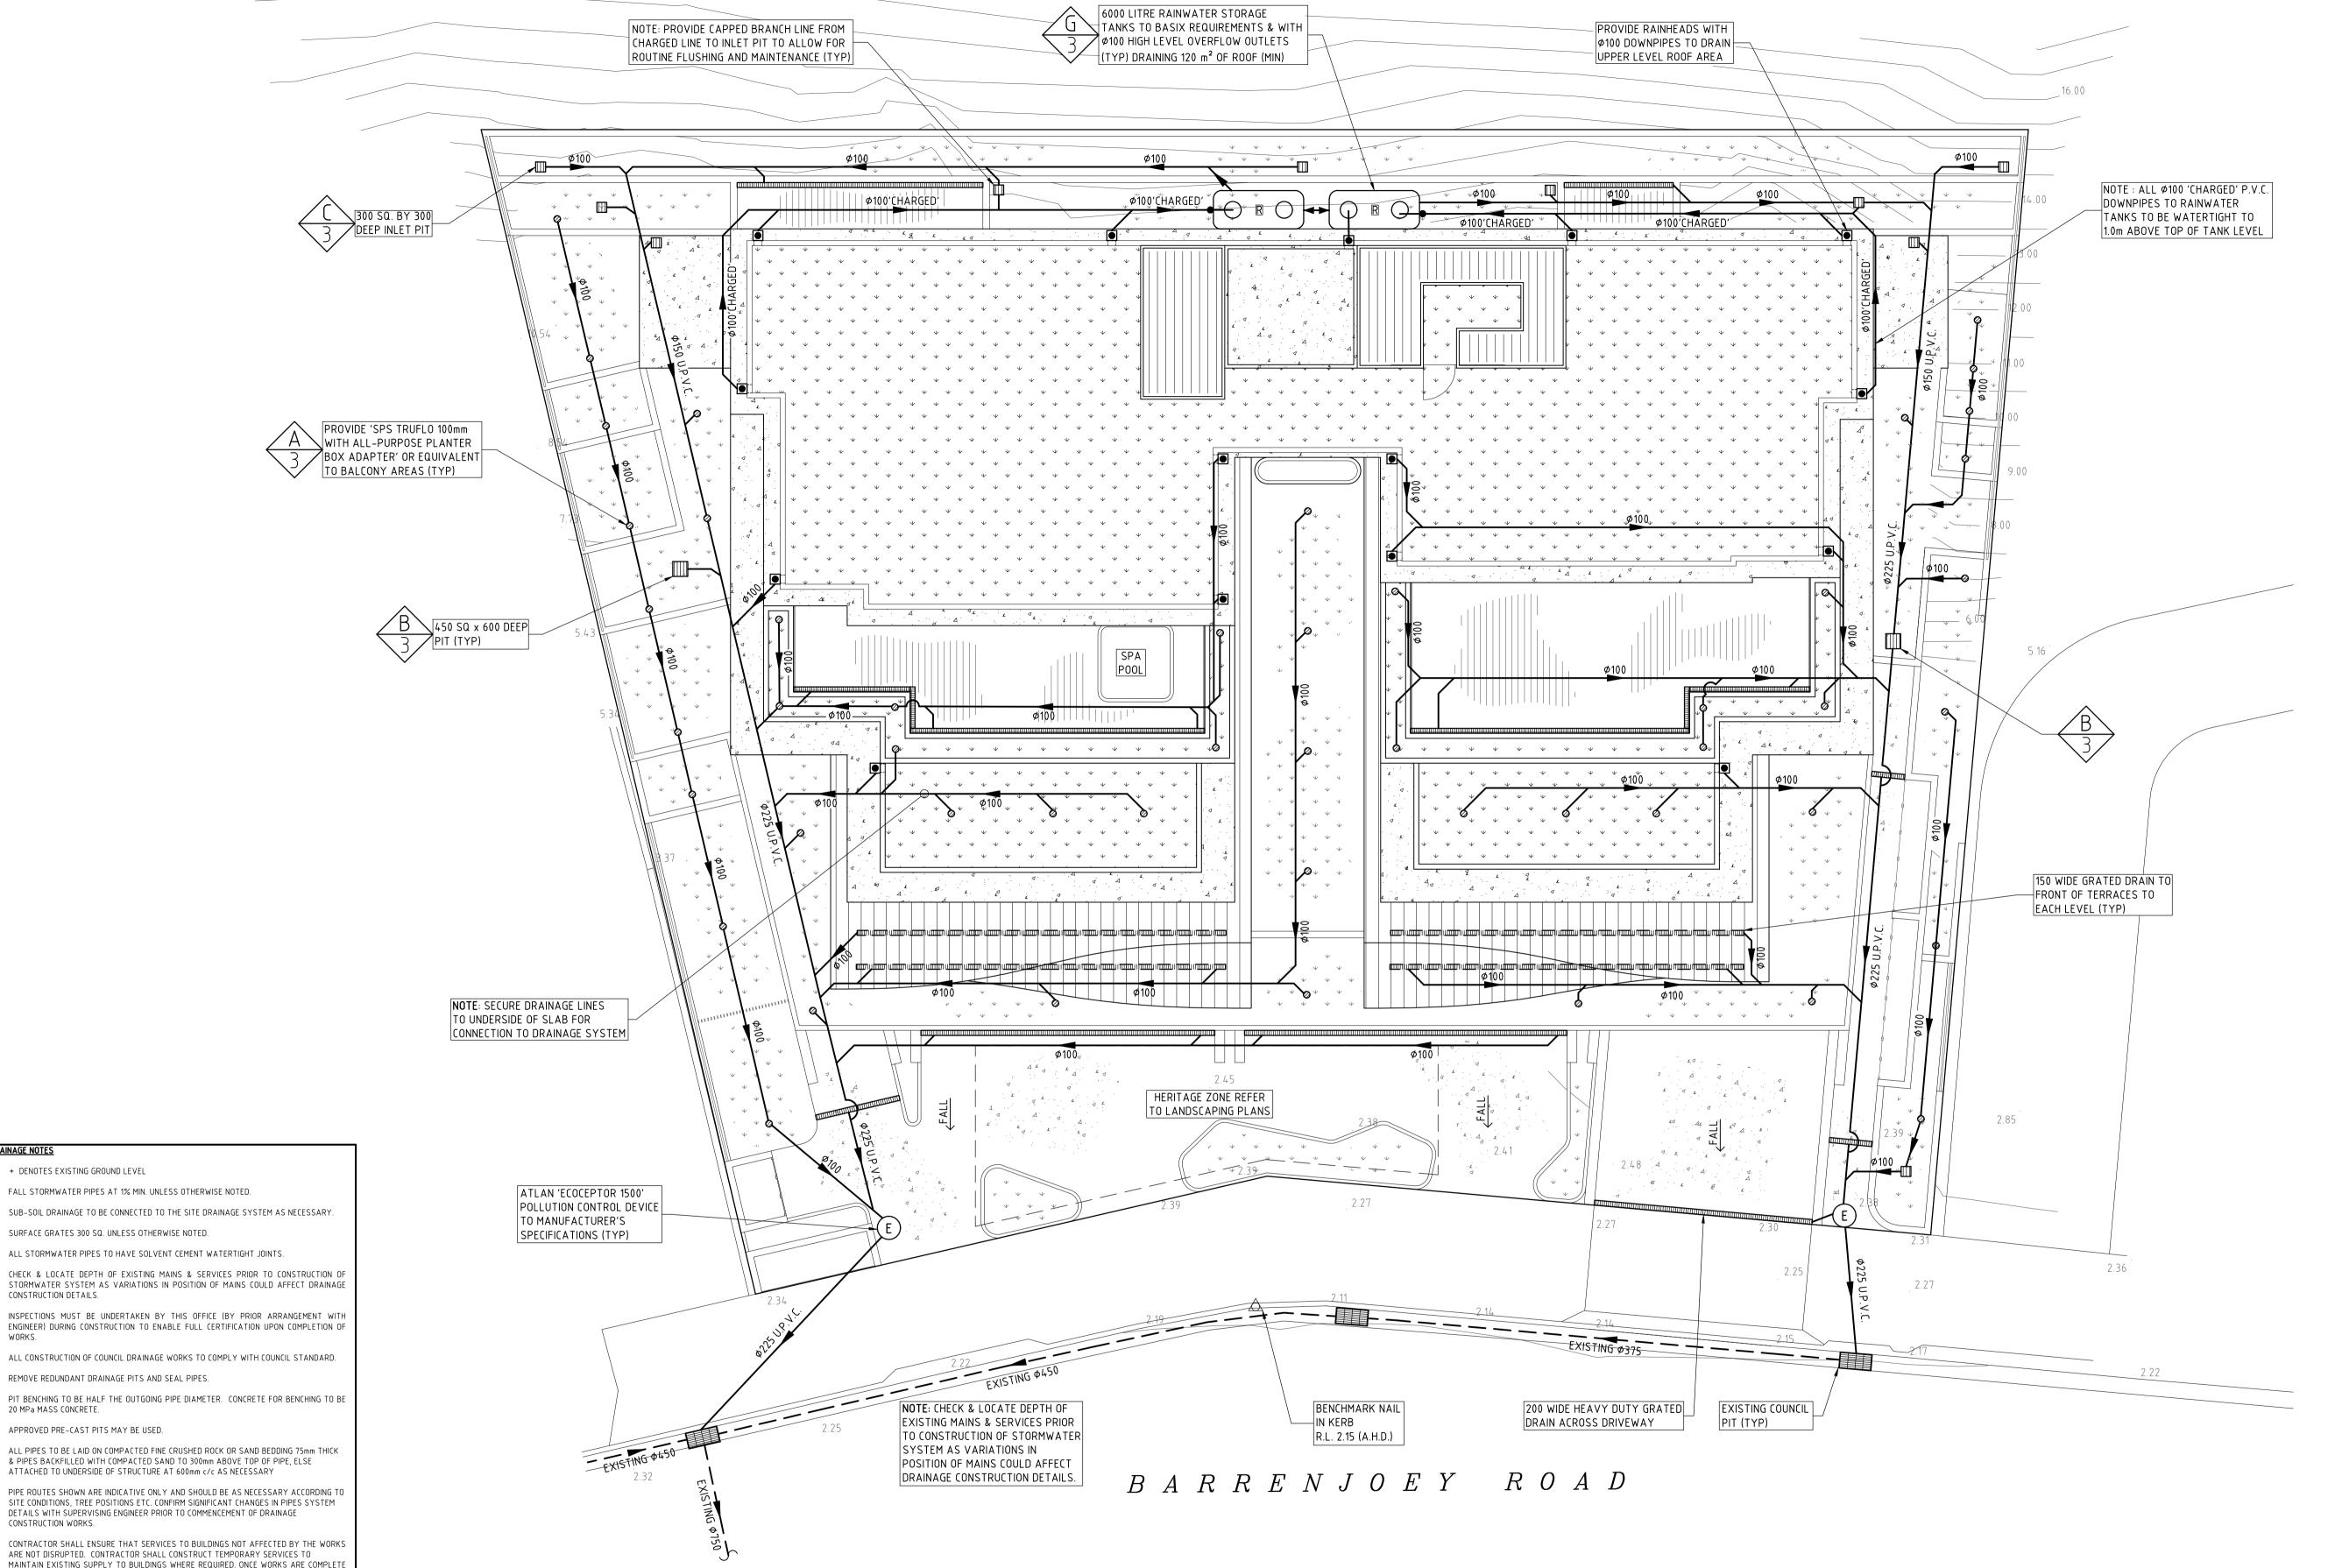

APPROVED PRE-CAST PITS MAY BE USED.

+ DENOTES EXISTING GROUND LEVEL

CONSTRUCTION DETAILS.

20 MPa MASS CONCRETE.

SURFACE GRATES 300 SQ. UNLESS OTHERWISE NOTED.

REMOVE REDUNDANT DRAINAGE PITS AND SEAL PIPES.

DRAINAGE NOTES

ALL PIPES TO BE LAID ON COMPACTED FINE CRUSHED ROCK OR SAND BEDDING 75mm THICK & PIPES BACKFILLED WITH COMPACTED SAND TO 300mm ABOVE TOP OF PIPE, ELSE ATTACHED TO UNDERSIDE OF STRUCTURE AT 600mm c/c AS NECESSARY

PIPE ROUTES SHOWN ARE INDICATIVE ONLY AND SHOULD BE AS NECESSARY ACCORDING TO SITE CONDITIONS, TREE POSITIONS ETC. CONFIRM SIGNIFICANT CHANGES IN PIPES SYSTEM DETAILS WITH SUPERVISING ENGINEER PRIOR TO COMMENCEMENT OF DRAINAGE CONSTRUCTION WORKS.

CONTRACTOR SHALL ENSURE THAT SERVICES TO BUILDINGS NOT AFFECTED BY THE WORKS ARE NOT DISRUPTED. CONTRACTOR SHALL CONSTRUCT TEMPORARY SERVICES TO MAINTAIN EXISTING SUPPLY TO BUILDINGS WHERE REQUIRED. ONCE WORKS ARE COMPLETE AND COMMISSIONED THE CONTRACTOR SHALL REMOVE ALL TEMPORARY SERVICES AND MAKE GOOD ALL DISTURBED AREAS.

STORMWATER SYSTEM REQUIRES SIGNIFICANT MAINTENANCE DUE TO POTENTIAL HIGH POLLUTANT LOAD. FILTERS AND POLLUTANT TRAPS SHOULD BE CHECKED AFTER LARGE STORM EVENTS AND CLEANED EVERY 6 MONTHS.

PLUMBING AND DRAINAGE WORKS TO COMPLY WITH AS-3500, THE NATIONAL DRAINAGE &

WHERE POSSIBLE DRAINAGE LINES SHALL BE LAID IN AREAS PREVIOUSLY DISTURBED BY OTHER SITE WORKS AND FOLLOW TOPOGRAPHICAL FEATURES TO REDUCE IMPACT AND

THIS STORMWATER MANAGEMENT PLAN HAS BEEN PREPARED FOR SUBMISSION TO COUNCIL/CERTIFEIR AND DOES NOT NECESSARILY CONTAIN ALL APPROPRIATE INFORMATION TO ENABLE FOR ISSUE TO PLUMBER/BUILDER FOR CONSTRUCTION. CONTACT TAYLOR CONSULTING FOR MORE INFORMATION.

SITE DRAINAGE PLAN SCALE 1:100

## STORMWATER MANAGEMENT PLAN 8 SEP 23 : BASIX TANKS ADDED 1112-1116 BARRENJOEY ROAD, PALM BEACH 12 SEP 24 : UPDATED PLAN TO SUIT LATEST ARCHITECTURAL PLAN DRAWN CHECKED : SCALE @ A1 LI 1:100 1 OCTOBER 2024 ENGINEER

ISSUE DATE : REVISION

"Seascape" Suite 7 22-26 Fisher Rd Dee Why NSW 2099 T 02 9982 7092 F 02 9982 5898 enquire@taylorconsulting.net.au www.taylorconsulting.net.au

STORMWATER SYSTEM DESIGN DATA

PROPOSED IMPERVIOUS AREA =  $629.9 \text{ m}^2$  (46%)

PROPOSED LANDSCAPED AREA =  $731.6 \text{ m}^2$  (54%)

EXISTING IMPERVIOUS AREA =  $623.1 \,\mathrm{m}^2$  (45%)


CONSULTING


CIVIL & STRUCTURAL ENGINEERS


EXISTING LANDSCAPED AREA =  $738.4 \text{ m}^2$  (55%)

SITE AREA =  $1361.5 \text{ m}^2 (100\%)$ 

SITE DATA

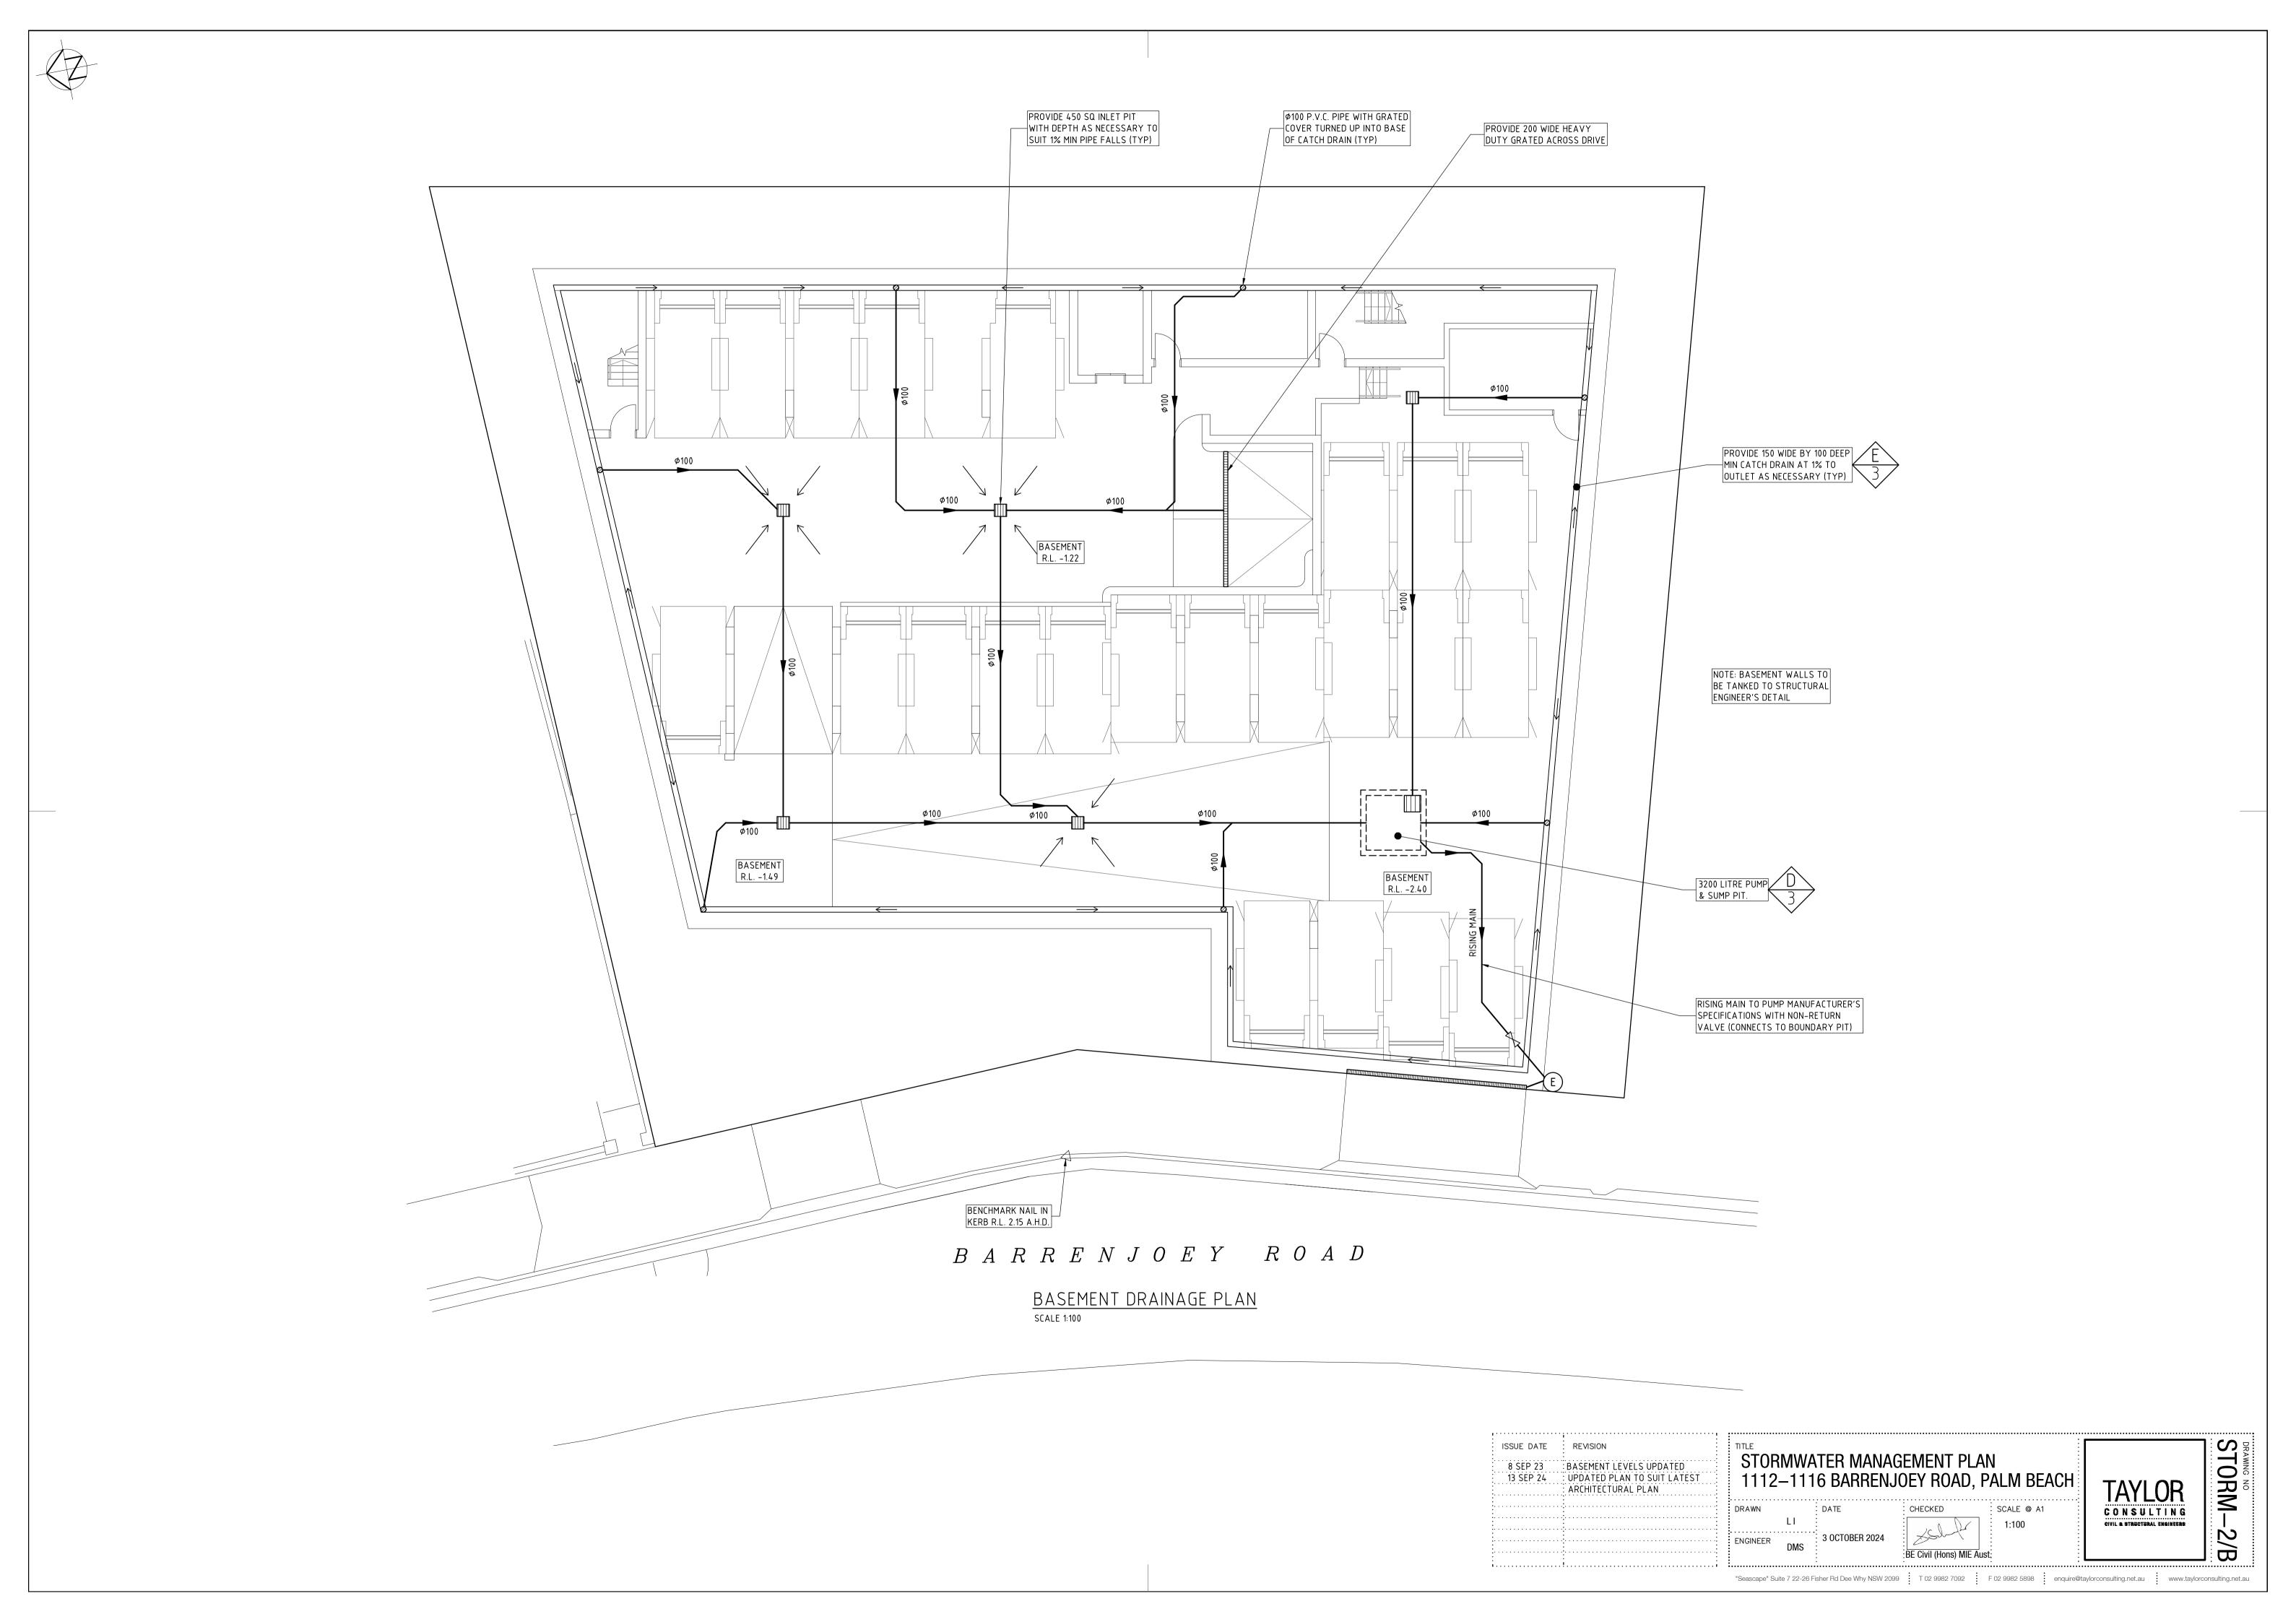

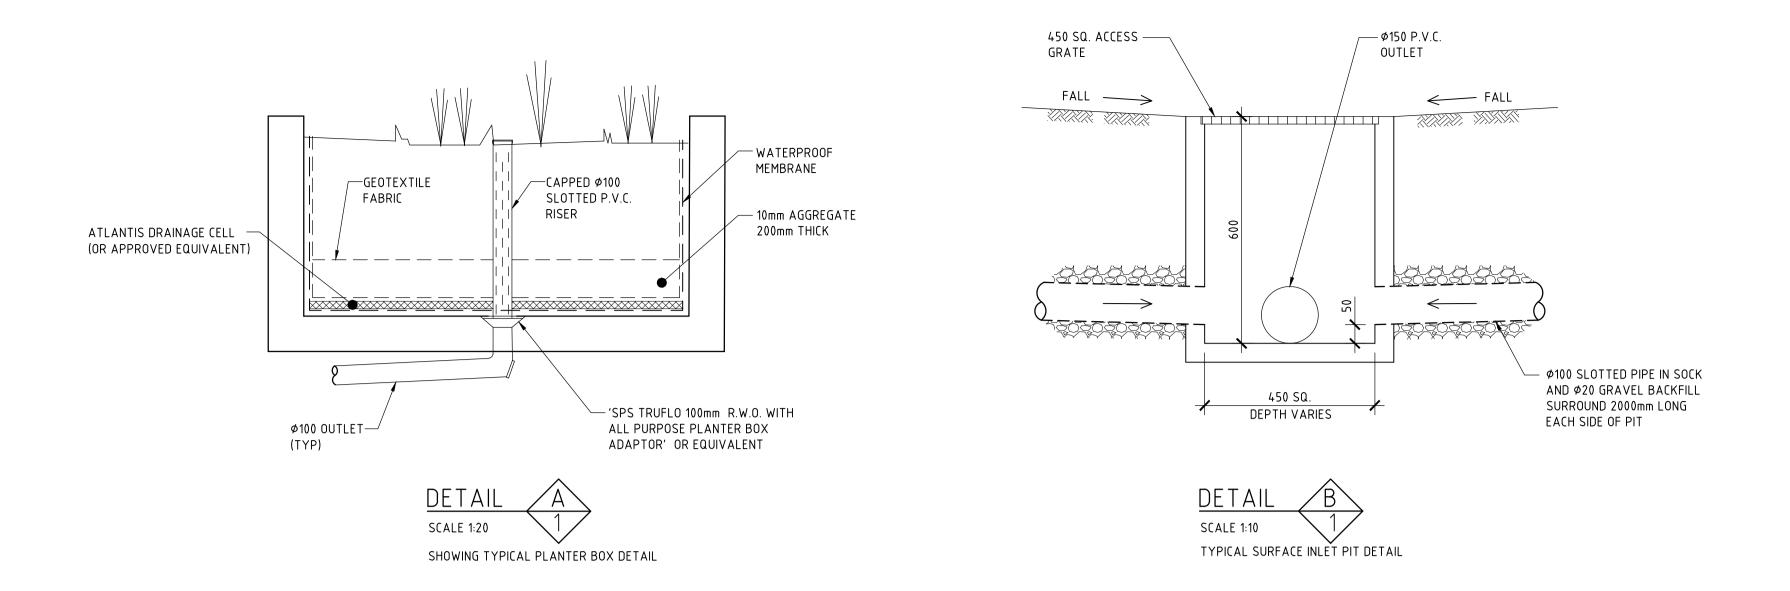

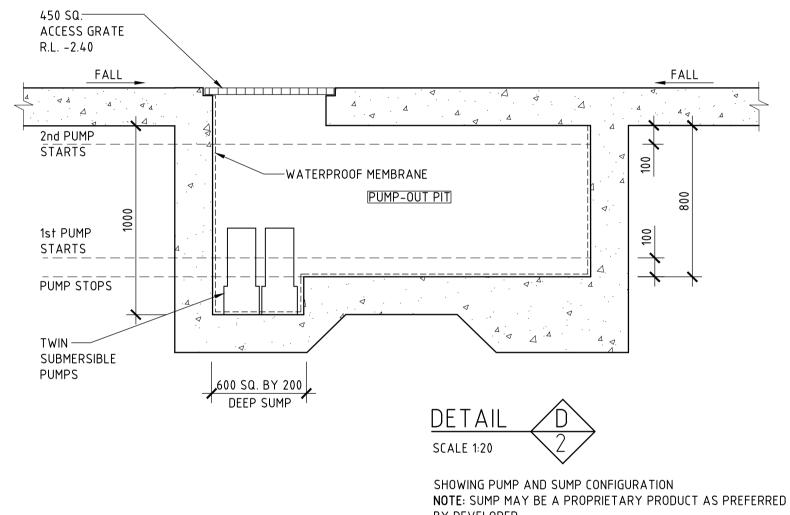

BY DEVELOPER

PUMP NOTES

IN PUMP PIT.

1. TWIN SUBMERSIBLE PUMPS TO BE PROVIDED

2. PUMPS TO OPERATE ALTERNATELY AT LOW INLET FLOWRATE & CONCURRENTLY AT HIGH INLET FLOWRATE.

3. PUMP CAPACITY TO BE 2.0 L/s EACH FOR STATIC


4. PROVIDE EXTERNAL CONTROL PANEL WITH AUDIO,


5. INLET PIPE TO BE LOCATED CLEAR OF THE HIGH LEVEL

VISUAL ALARMS & BATTERY POWER BACK-UP.


FLOAT SWITCH TO PREVENT FALSE ALARMS.

HEAD = 6.0m (EXCLUDES OUTLET PIPE LOSSES).

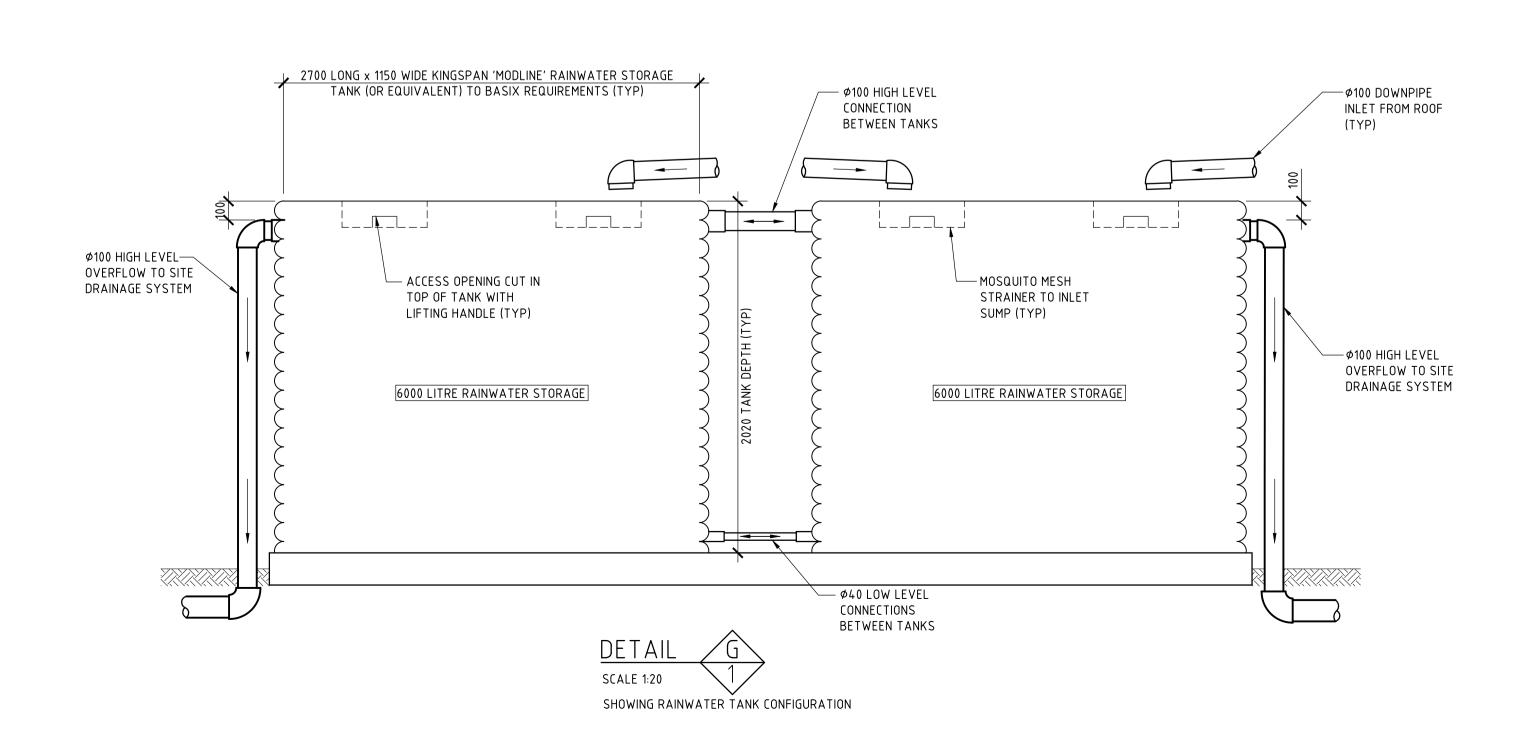

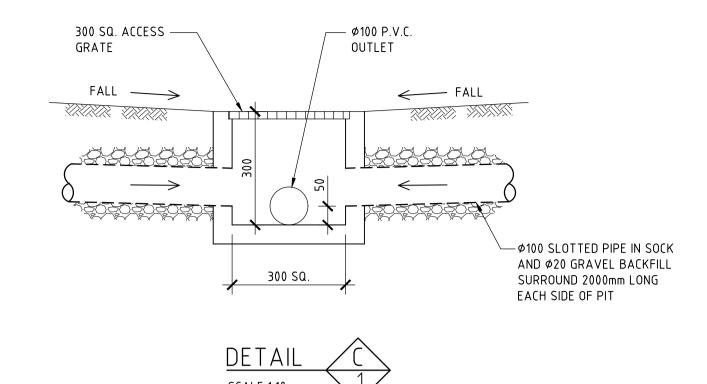

TYPICAL SURFACE INLET PIT DETAIL

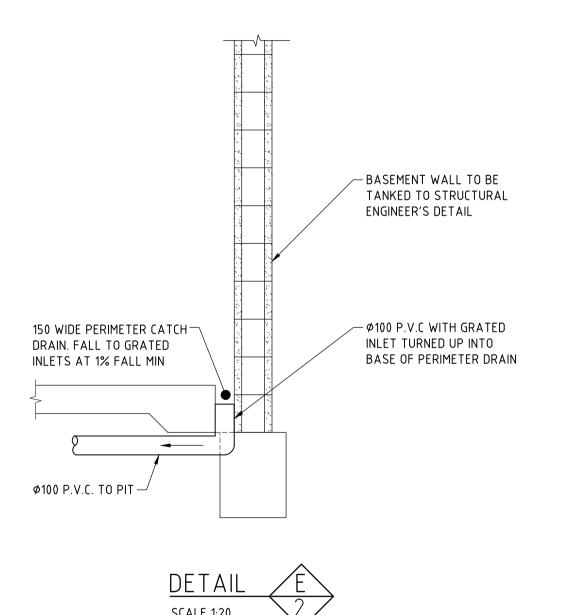

## DRAINAGE NOTES

- + DENOTES EXISTING GROUND LEVEL
- FALL STORMWATER PIPES AT 1% MIN. UNLESS OTHERWISE NOTED.

SURFACE GRATES 300 SQ. UNLESS OTHERWISE NOTED.

- SUB-SOIL DRAINAGE TO BE CONNECTED TO THE SITE DRAINAGE SYSTEM AS NECESSARY.
- ALL STORMWATER PIPES TO HAVE SOLVENT CEMENT WATERTIGHT JOINTS.
- CHECK & LOCATE DEPTH OF EXISTING MAINS & SERVICES PRIOR TO CONSTRUCTION OF STORMWATER SYSTEM AS VARIATIONS IN POSITION OF MAINS COULD AFFECT DRAINAGE
- CONSTRUCTION DETAILS. INSPECTIONS MUST BE UNDERTAKEN BY THIS OFFICE (BY PRIOR ARRANGEMENT WITH ENGINEER) DURING CONSTRUCTION TO ENABLE FULL CERTIFICATION UPON COMPLETION OF
- ALL CONSTRUCTION OF COUNCIL DRAINAGE WORKS TO COMPLY WITH COUNCIL STANDARD.
- REMOVE REDUNDANT DRAINAGE PITS AND SEAL PIPES.
- PIT BENCHING TO BE HALF THE OUTGOING PIPE DIAMETER. CONCRETE FOR BENCHING TO BE 20 MPa MASS CONCRETE.
- APPROVED PRE-CAST PITS MAY BE USED. ALL PIPES TO BE LAID ON COMPACTED FINE CRUSHED ROCK OR SAND BEDDING 75mm THICK

& PIPES BACKFILLED WITH COMPACTED SAND TO 300mm ABOVE TOP OF PIPE, ELSE ATTACHED TO UNDERSIDE OF STRUCTURE AT 600mm c/c AS NECESSARY

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## RAINWATER RE-USE NOTES AND SPECIFICATIONS

- ROOF WATER ONLY TO BE DRAINED TO THE RAINWATER STORAGE TANK.
- THE RAINWATER STORAGE TANK NEEDS TO BE CONNECTED FOR RE-USE AS REQUIRED BY THE OWNER.
- RAINWATER STORAGE TANK TO BE CONFIGURED IN ACCORDANCE WITH SYDNEY WATER SPECIFICATIONS 'GUIDELINES FOR RAINWATER TANK ON RESIDENTIAL
- TO BE BASED ON THE DAILY NON-POTABLE USAGE THAT MAY BE EXPECTED FROM THE

PROVIDE MAINS 'TOP-UP' SUPPLY TO RAINWATER TANK. MAINS TOP-UP ZONE

- PROVIDE A MECHANICAL PUMPING ARRANGEMENT (IN SOUND-PROOF HOUSING) TO PUMP SUPPLIERS SPECIFICATION TO SUIT INTENDED USAGE OF RAINWATER STORAGE. PUMPING ARRANGEMENTS MUST COMPLY WITH EPA GUIDELINES.
- INLETS TO RAINWATER TANK MUST BE SCREENED TO PREVENT THE ENTRY OF FOREIGN MATTER, ANIMALS OR INSECTS.
- A SIGN MUST BE AFFIXED TO THE RAINWATER TANK CLEARLY STATING THAT THE
- WATER IN THE TANK IS RAINWATER AND IS NOT TO BE USED FOR HUMAN CONSUMPTION. RAINWATER TANK TO BE PLACED ON A STRUCTURALLY ADEQUATE BASE IN
- ACCORDANCE WITH THE MANUFACTURER'S OR STRUCTURAL ENGINEER'S DETAILS. THE TANK MUST NOT BE INSTALLED OVER ANY MAINTENANCE STRUCTURE OR FITTINGS
- USED BY A PUBLIC AUTHORITY.
- RAINWATER TANK AND ASSOCIATED PLUMBING WORKS TO BE INSTALLED AND CONFIGURED BY A LICENSED PLUMBER. PUMP TO BE INSTALLED BY A LICENSED

