

### COVER PAGE & DRAWING LIS

Sheet Name

COVERT NOL & DIVINING
SECTIONS
EXISTING PLAN
ELEVATIONS
DEMOLITION PLAN
SITE PLAN
PROPOSED PLAN

# 23 HOWARD AVENUE DEE WHY

CONVERSION OF A COMMERCIAL TENNANCY INTO A RESIDENTIAL UNIT

DA FOR CHANGE OF USE Project: 23 HOWARD AVENUE DEE WHY


Walsh<sup>2</sup> Architects

Scale @ A3 Sheet Name **COVER PAGE & DRAWING LIST** This drawing is copyright and remains the property of Walsh<sup>2</sup> Architects. This drawing is for development application purposes only and not for construction.

No. Number DA000

KEN SNELL Client:

Sheet Number	Current Revision	Current Revision Date
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DA000	A	24.08.2020
DA200	A	24.08.2020
DA020	A	24.08.2020
DA300	A	24.08.2020
DA030	A	24.08.2020
DA010	A	24.08.2020
DA100	A	24.08.2020
	DA200 DA020 DA300 DA030 DA010	DA000 A   DA200 A   DA020 A   DA300 A   DA030 A   DA030 A   DA010 A

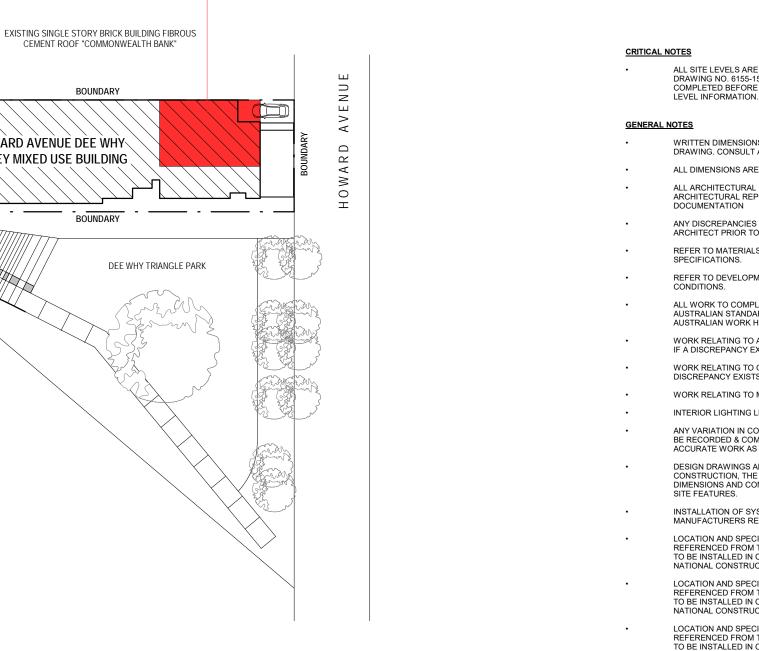

### SITE: LEVEL 1 - COMMERCIAL OFFICE 02

DA FOR CHANGE OF USE Project: 23 HOWARD AVENUE DEE WHY Client: KEN SNELL

Walsh<sup>2</sup>

Registered Architec ACT 2624 NSW 10366 Architects scott@walsharchitects.com.au 0466 049 880

BOUNDARY

BOUNDARY

23 HOWARD AVENUE DEE WHY

6 STOREY MIXED USE BUILDING

AHAHA

Scale 1 : 500 @ A3 Sheet Name SITE PLAN

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No. Number DA010

ALL SITE LEVELS ARE BASED OFF DATA FROM ACT GOVERNMENT SUBURBAN LAND AGENCY DRAWING NO. 6155-15-037, REVISION G, DATE 04.10.2019. DETAILED LEVEL SURVEY TO BE COMPLETED BEFORE COMMENCEMENT OF SITE WORKS. ARCHITECT TO BE NOTIFIED OF ANY NEW

WRITTEN DIMENSIONS TO TAKE PRECEDENCE OVER SCALED DIMENSIONS. DO NOT SCALE DRAWING. CONSULT ARCHITECT IF ANY CLARIFICATION IS REQUIRED.

ALL DIMENSIONS ARE IN MILLIMETRES UNLESS OTHERWISE STATED

ALL ARCHITECTURAL DRAWINGS MUST BE READ IN CONJUNCTION WITH RELEVANT CONTRACTS, ARCHITECTURAL REPORTS, SCHEDULES AND SPECIFICATIONS AND ALL OTHER CONSULTANT

ANY DISCREPANCIES IN DOCUMENTATION ARE TO BE NOTIFIED TO THE PROJECT MANAGER AND ARCHITECT PRIOR TO THE COMMENCEMENT OF WORK.

REFER TO MATERIALS AND FINISHES SCHEDULE FOR DETAILS ON MATERIAL SELECTION AND SPECIFICATIONS.

REFER TO DEVELOPMENT APPLICATION NOTICE OF DECISION FOR ANY AND ALL APPROVAL

ALL WORK TO COMPLY WITH THE NATIONAL CONSTRUCTION CODE INCLUDING RELEVANT AUSTRALIAN STANDARDS AND REQUIREMENTS OF THE BUILDING CODE OF AUSTRALIA AND AUSTRALIAN WORK HEALTH AND SAFETY LEGISLATION

WORK RELATING TO ACCESSIBLE REQUIREMENTS TO MEET AS1428.1, UNLESS NOTED OTHERWISE. IF A DISCREPANCY EXISTS REFER TO PROJECT MANAGER FOR CLARIFICATION.

WORK RELATING TO OFF-STREET PARKING TO AS2890.1, UNLESS NOTED OTHERWISE. IF A DISCREPANCY EXISTS REFER TO PROJECT MANAGER FOR CLARIFICATION.

WORK RELATING TO MASONRY TO AS37000.

INTERIOR LIGHTING LEVELS TO BE COMPLIANT WITH NCC : SECTION J.

ANY VARIATION IN CONSTRUCTION METHODOLOGY OR IN MATERIAL TYPE OR SPECIFICATION TO BE RECORDED & COMMUNICATED TO THE ARCHITECT & RELATIVE CONSULTANTS TO ENSURE ACCURATE WORK AS EXECUTED DRAWINGS.

DESIGN DRAWINGS ARE BASED ON SURVEY INFORMATION. PRIOR TO DETAILED DESIGN AND CONSTRUCTION, THE CONTRACTOR IS TO UNDERTAKE A FULL SURVEY TO VERIFY ALL DIMENSIONS AND CONFIRM LOCATION OF EXISTING STRUCTURE, SERVICES, BUILDING FABRIC AND

INSTALLATION OF SYSTEMS AND PROPRIETARY PRODUCTS TO BE STRICTLY IN ACCORDANCE WITH MANUFACTURERS RECOMMENDATIONS

LOCATION AND SPECIFICATION OF ALL ELECTRICAL SERVICES, FIXTURES AND FITTINGS TO BE REFERENCED FROM THE ELECTRICAL ENGINEERS DRAWINGS AND SPECIFICATION. ALL FIXTURES TO BE INSTALLED IN COMPLIANCE WITH THE RELEVANT AUSTRALIAN STANDARDS AND THE NATIONAL CONSTRUCTION CODE OF AUSTRALIA.

LOCATION AND SPECIFICATION OF ALL MECHANICAL SERVICES, FIXTURES AND FITTINGS TO BE REFERENCED FROM THE MECHANICAL ENGINEERS DRAWINGS AND SPECIFICATION. ALL FIXTURES TO BE INSTALLED IN COMPLIANCE WITH THE RELEVANT AUSTRALIAN STANDARDS AND THE NATIONAL CONSTRUCTION CODE OF AUSTRALIA

LOCATION AND SPECIFICATION OF ALL HYDRAULIC SERVICES, FIXTURES AND FITTINGS TO BE REFERENCED FROM THE HYDRAULIC ENGINEERS DRAWINGS AND SPECIFICATION. ALL FIXTURES TO BE INSTALLED IN COMPLIANCE WITH THE RELEVANT AUSTRALIAN STANDARDS AND THE NATIONAL CONSTRUCTION CODE OF AUSTRALIA


ANY CONSULTANT DRAWING INFORMATION SHOWN ON THE ARCHITECTURAL DRAWINGS ARE TO BE USED AS A GUIDE ONLY. BUILDER TO ENSURE THEY OVERLAY LATEST CONSULTANT DRAWING.

ALL STRUCTURAL COLUMN DIMENSIONS SHOWN ON THE ARCHITECTURAL CONCRETE SETOUT DRAWINGS ARE FOR SETOUT PURPOSES ONLY AND SHOULD BE CONFIRMED BY REVIEWING CURRENT STRUCTURAL DRAWINGS

BUILDER TO UNDERTAKE THEIR OWN DIAL BEFORE YOU DIG





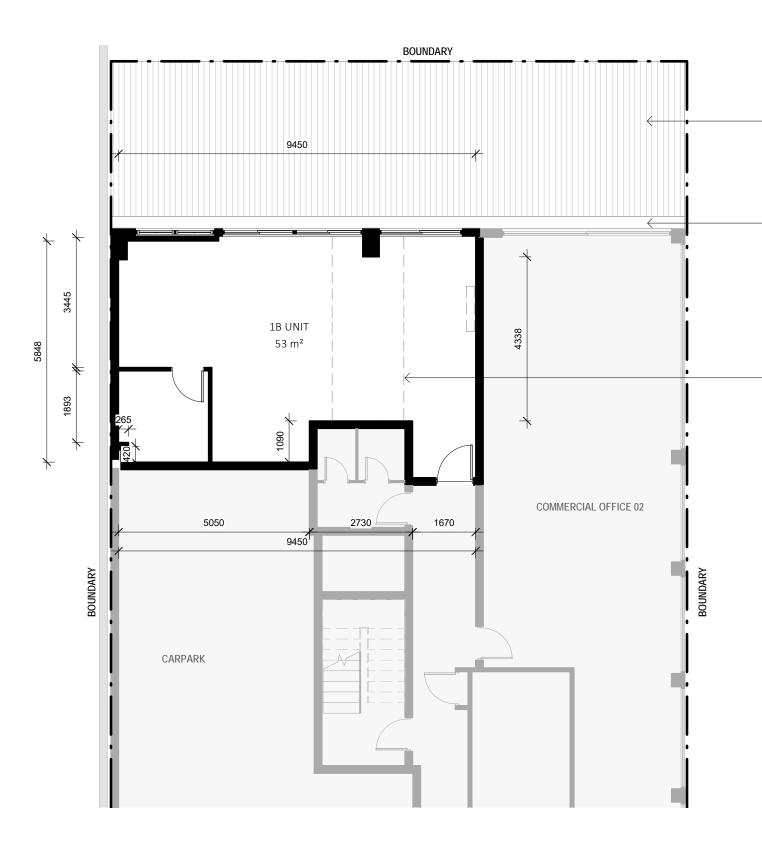

DA FOR CHANGE OF USE Project: 23 HOWARD AVENUE DEE WHY Client: KEN SNELL

Scale 1 : 100 @ A3

EXISTING PLAN

Sheet Name

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No. Number DA020


EXISTING AWNING ROOF BELOW

EXISTING BOX GUTTER

EDGE OF CONCRETE BEAM ABOVE





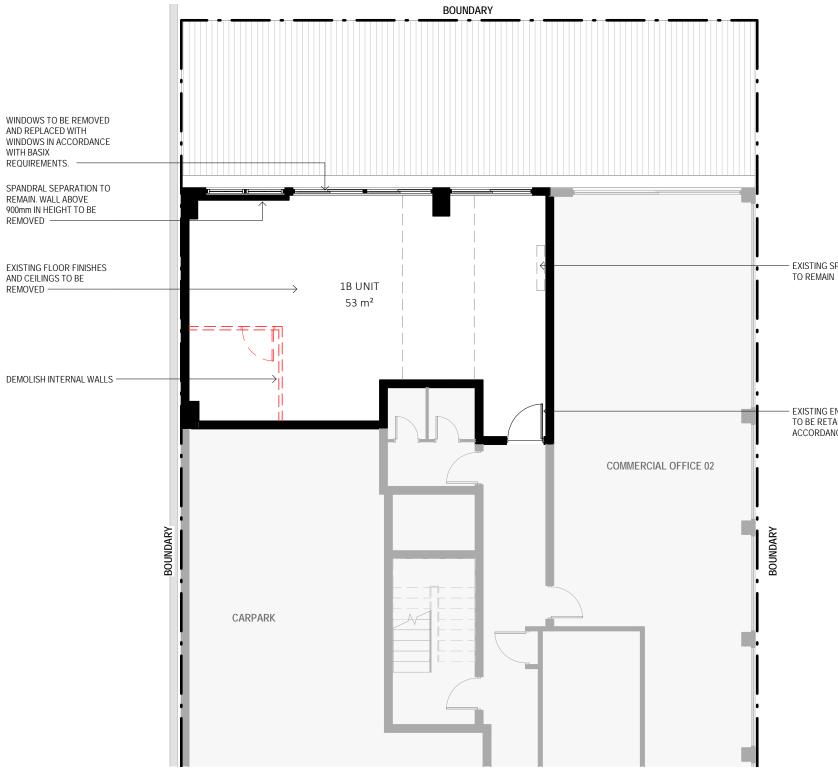


Sheet Name

Scale

1 : 100 @ A3



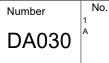

EXISTING SPLIT SYSTEM A/C UNIT

EXISTING ENTRY DOOR AND FRAME TO BE RETAINED. FRL -/60/30 NOTED IN ACCORDANCE WITH CLAUSE C3.11






	:	23 Howa	rd Avenue Dee	e Why					
SUMM	ARY OF E	BASIX	COMMIT	MEN	TS F	OR	unit 1	IB	
	mmary of the B/ efer to the CURI For de	RENT BA		for Con	nplete			nte.	
WATER CO	MMITMENTS	5							
Fixtures									
3 Star Showe	inouus		Yes ( > 4.5 but <= 6 L/min)						
4 Star Kitche	n / Basin Tap	s Y	Yes 3 Star Toilet			Yes	Yes		
THERMAL CO	OMFORT COM	MITM	ENTS - Refer	to TP	A Spe	cific	ation or	n plans	
ENERGY CO	MMITMENTS								
Hot Water	Electric Heat	Pump	26 to 30 STCs						
Cooling	Living	1 Ph	1 Phase A/C 2 S					tar	
System	Bedrooms	Non	None						
Heating	Living	1 Ph	1 Phase A/C 2 Star						
Heating System	Bedrooms	Non	None						
	1 x Bathroor	n Fan	Fan ducted to exterior Manual on/off						
Ventilation	Kitchen	Fan	Fan ducted to exterior Manual of					on/off	
	Laundry	Fan	Fan ducted to exterior Manual					on/off	
Natural	Window/Sk	ylight ir	light in Kitchen No						
Lighting	Window/Sk	ylight ir	light in Bathrooms/Toilets				No		
Artificial	Number of b	edroor	ns	1	AII	Ded	icated	Yes	
Lighting	Number of L	iving/D	ining rooms	1	AII 🛛	Ded	icated	Yes	
(rooms to be	Kitchen			Y	es	Ded	Yes		
primarily lit by fluorescent or	All Bathrms	/Toilets	Foilets Yes Ded			icated	Yes		
LED lights)	Laundry		Yes Dedicated			icated	Yes		
LLD lights)	All Hallway	s	Yes Dedicated				icated	Yes	
OTHER COM	MITMENTS								
Indoor clothes line			/es Ventilated refrigerator space				Yes		
Stove/Oven			Electric cooktop & electric oven						
Alternative Er	nerov n/a								

August 2020	ainability Assessments			rence: 16042 2) 4962 3439
enquiries@bi	uildingsustainability.net.au	www.b	uildingsustaina	
the Assessor C If different cons	Important No becification was used to achieve th ertificate and takes precedence ou truction elements are applied then	e thermal pe er any other the Assesso	specification. or Certificate is no	longer valid.
Thermal External Wall	Performance Specifications for	unit 1B (de		
Double Brick	Construction		Ad	<i>Ided Insulation</i> R1.0
DOUDIC DITCK				K1.u
Internal Wall (	Construction		Ad	ded Insulatio
Plasterboard of	n studs			None
Concrete Bloc	k + stud + Pasterboard (party walls	s)		None
Ceiling Constr	uction		Ad	ded Insulation
Plasterboard				None
Roof Construc	tion Colour		Adı	ded Insulation
Concrete	Any			None
Floor Construe	tion Covering		Ad	ded Insulation
Concrete	As drawn			None
Windows	Glass and frame type	U Value	SHGC Range	Area sq m
ALM-001-01 A	Aluminium A SG Clear	6.70	0.51 - 0.63	As drawn
ALM-002-01 A	Aluminium B SG Clear	6.70	0.63 - 0.77	As drawn
	are awning windows, bifolds, casement:			
	are double hung windows, sliding windo	ws & doors, fi	ked windows, stacker	doors, louvres
Skylights	Glass and frame type	U Va	lue SHGC	Area sq n
	alues are according to AFRC. Alte e SHGC is within the range specil		ts may be used if t	he U value
External Wind		randahs, pei	rgolas, awnings etd	;)
All shade element	ents modelled as drawn			
Ceiling Penetra	ations (downlight	s, exhaust fa	ns, flues etc)	
No adjustment	has been made for losses to insula	ation arising f	rom ceiling penetr	ations.

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Walsh<sup>2</sup> Architects Registered Architect ACT 2624 NSW 10366 scott@walsharchitects.com.au 0466 049 880

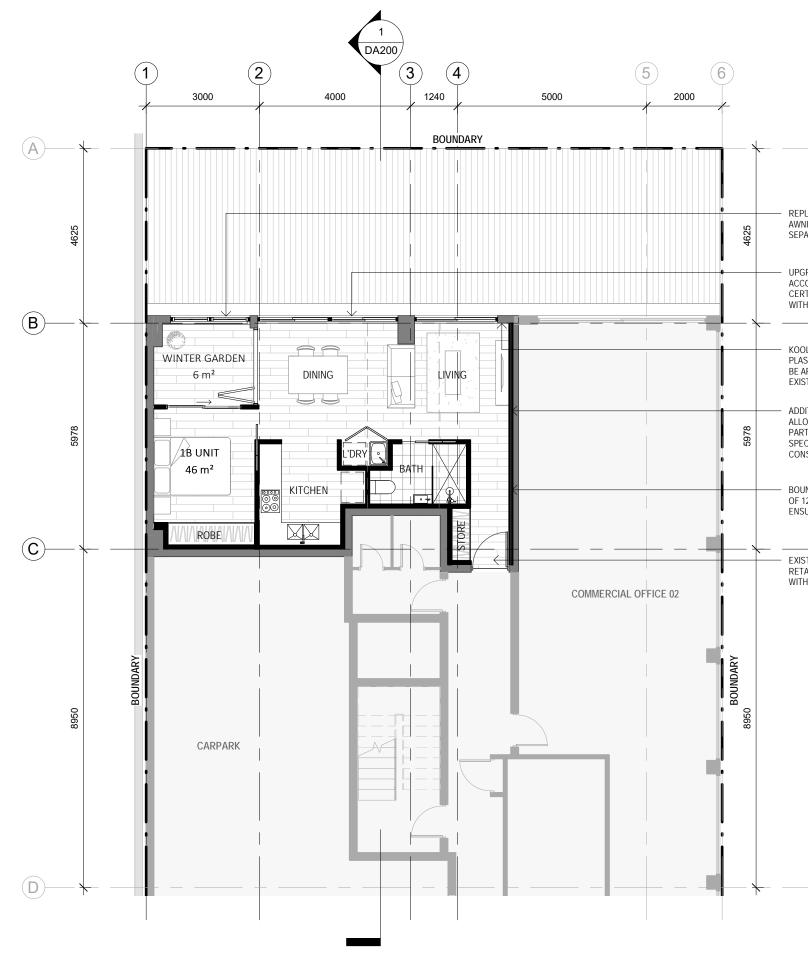Scale As indicated @ A3 Sheet Name **PROPOSED PLAN** 

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### No. Number DA100

Client: KEN SNELL

REPLACE COLOURBACK PANELS WITH AWNING WINDOWS. EXISTING SPANDRAL SEPARATION TO BE MAINTAINED

UPGRADE SLIDING WINDOWS IN ACCORDANCE WITH BASIX REQUIREMENTS. CERTIFIER TO CONFIRM IF COMPLIANCE WITH NCC2019 PART D2, 2.24 IS REQUIRED

KOOLTHERM K17 INSULATED DRY-LINING PLASTERBOARD FOR ADHESIVE BONDING TO BE APPLIED TO THE INTERIOR OF THE EXISTING NORTH FACING EXTERNAL WALL

ADDITIONAL 100mm WALL HAS BEEN SHOWN TO ALLOW FOR COMPLIANCE WITH NCC2019 VOL.1 -PART F, 5.3. ACOUSTIC ENGINEER TO PROVIDE SPECIFIC DETAIL ASSESMENT DURING CONSTRUCTION CERTIFICATE STAGE.

BOUNDING WALLS ARE ASSUMED TO HAVE FRL OF 120/120/120. FUTURE CONSTRUCTION IS TO ENSURE A FRL OF 120/120/120.


EXISTING ENTRY DOOR AND FRAME TO BE RETAINED. FRL -/60/30 NOTED IN ACCORDANCE WITH CLAUSE C3.11

#### NOTES

BCA CONSULTANT TO CONFIRM EXISTING WALLS MEET BCA POMPLIANCE FOR FIRE RESISTANCE LEVELS AND ACOUSTIC  $R_{\rm W}$  VALUES





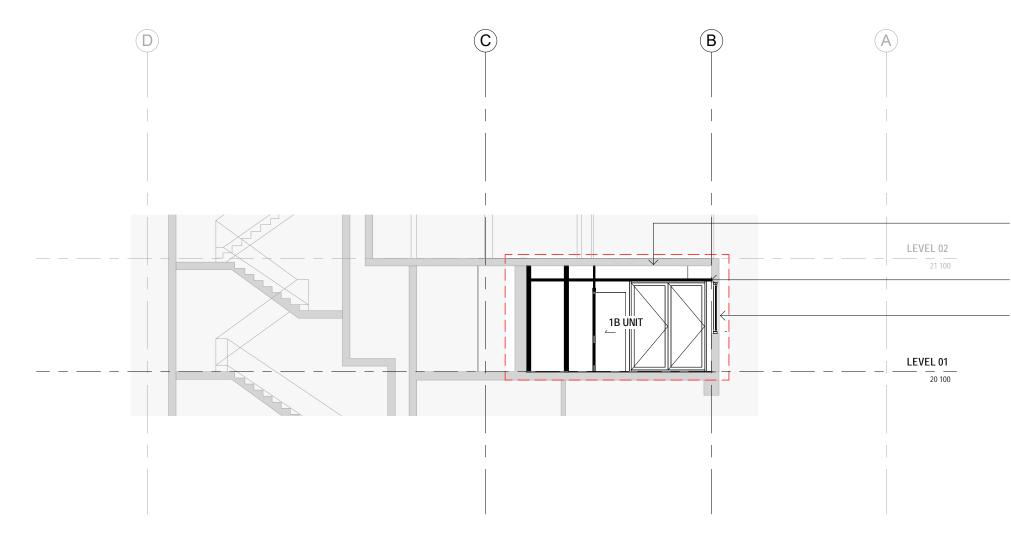


Scale 1 : 100 @ A3 Sheet Name SECTIONS



No.

UPGRADE EXISTING SERVICE PENETRATIONS WHICH ARE NOT SUITABLY SEALED FOR FIRE IN ACCORDANCE WITH NCC PART C3.

- MINIMUM 2400mm CEILING IN ACCORANCE WITH NCC PART F 3.1
- UPGRADE SLIDING WINDOWS IN ACCORDANCE WITH BASIX REQUIREMENTS. CERTIFIER TO CONFIRM IF COMPLIANCE WITH NCC2019 PART D2, 2.24 IS REQUIRED

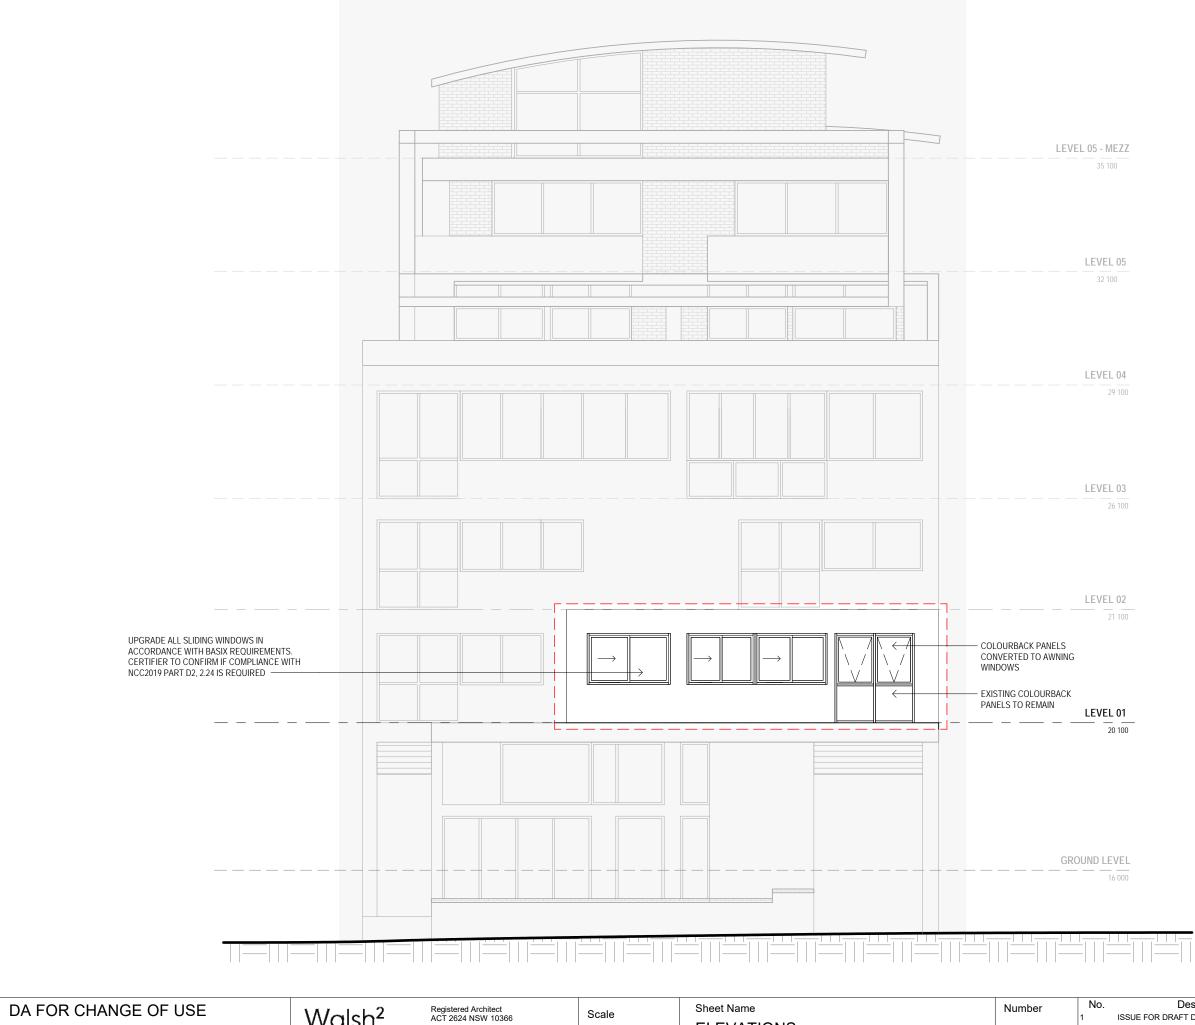



Description ISSUE FOR DRAFT DA ISSUE FOR DA APPROVAL

Date 18.08.2020 24.08.2020

Rev. А