

EXCAVATION FOOTPRINT

THIS PLAN TO BE READ IN CONJUNCTION WITH

MOD2014/0117

WARRINGAH COUNCIL

# MARMORA

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 REV
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 A
 JAN 14
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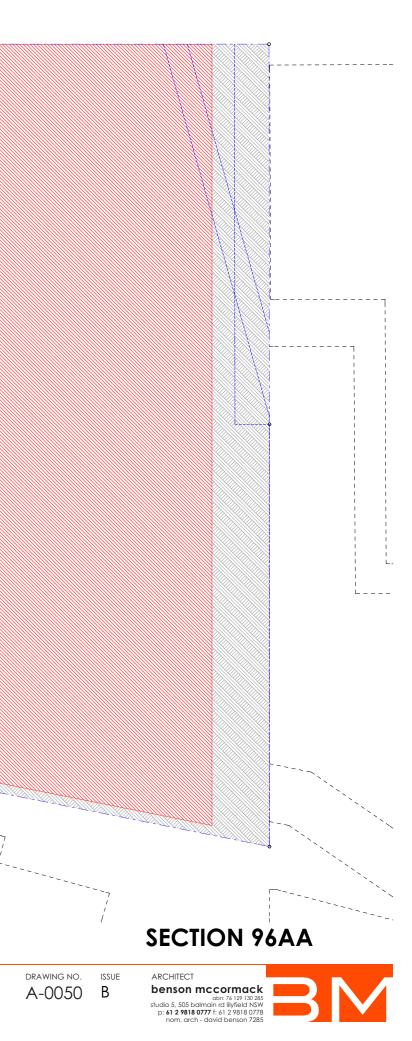
 B
 JUN 14
 S96 AA


CLIENT Moorgate Property Suite 1, 38 East Esplanade Manly NSW 2095 PROJECT DETAILS Marmora 18 Marmora Street Freshwater NSW 2096 PROJECT NORTH

TH SCALE PROJECT NO. 1:200 @ A3 1353A

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PROJECT NO. DRAWING 1353A EXCAVATION PLANS



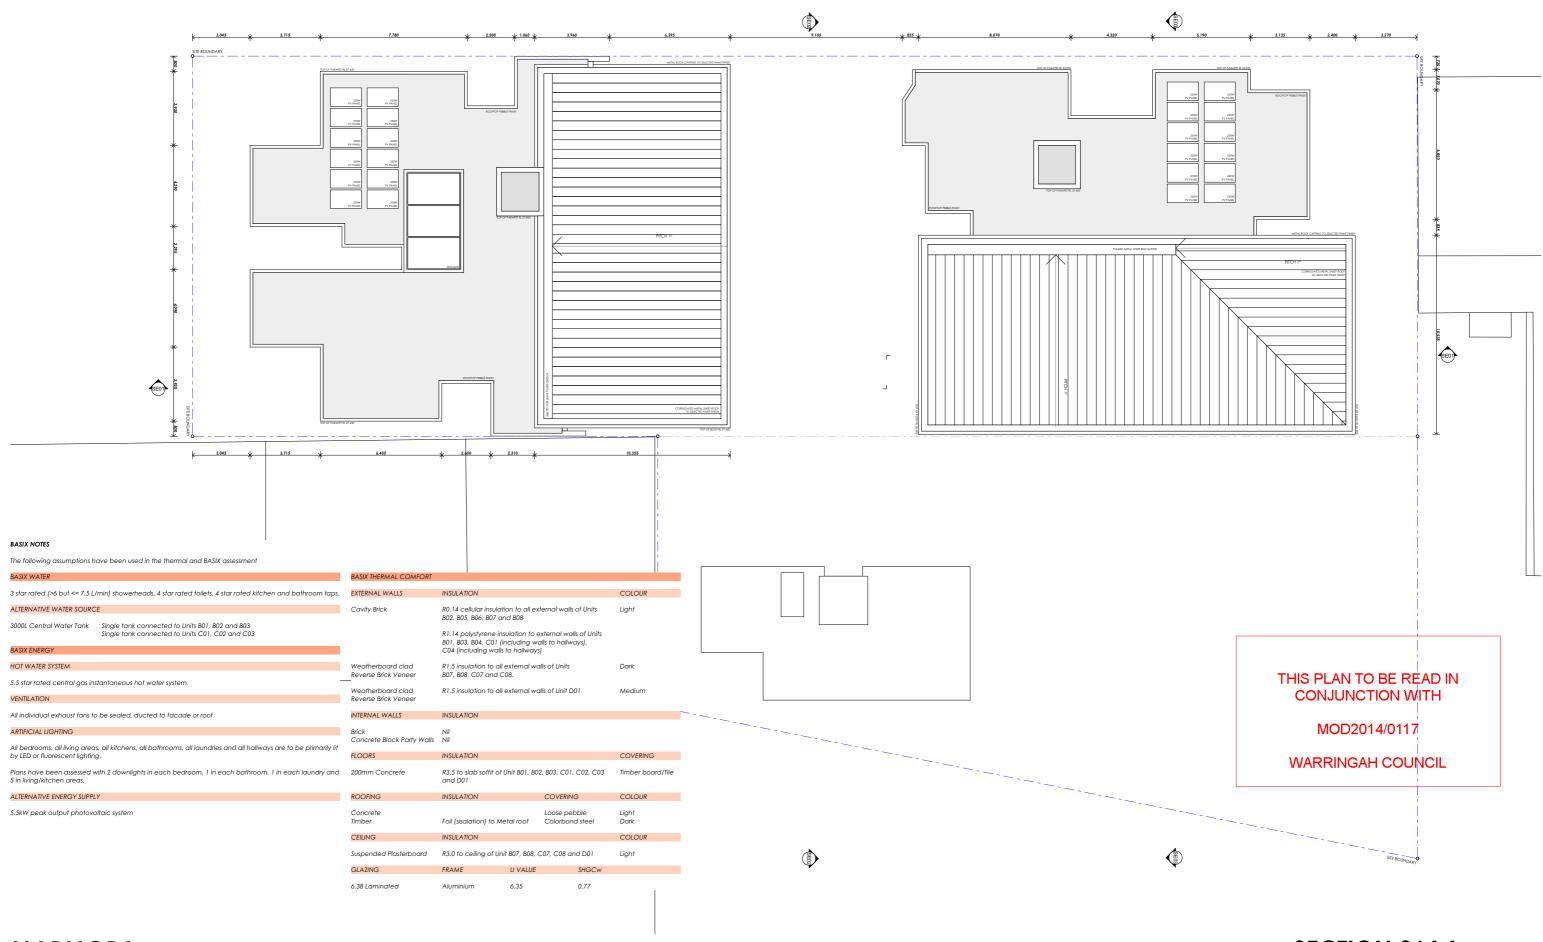

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REV DATE ISSUE

A JAN 14 ISSUED TO COUNCIL FOR PRE DA B JUN 14 S96 AA CLIENT Moorgate Property Suite 1, 38 East Esplanade Manly NSW 2095 PROJECT DETAILS Marmora 18 Marmora Street Freshwater NSW 2096 SCALE PROJECT N 1:200 @ A3 1.3.5.3


PROJECT NO. DRAWING 1353A ROOF PLAN


# **SECTION 96AA**

DRAWING NO. ISSUE

ARCHITECT **benson mccormack** \_abr: 76 129 130 285 studio 5, 505 balmain rd lilyfield NSW p: 61 2 9818 0777 f: 61 2 9818 0778 nom. arch - david benson 7285



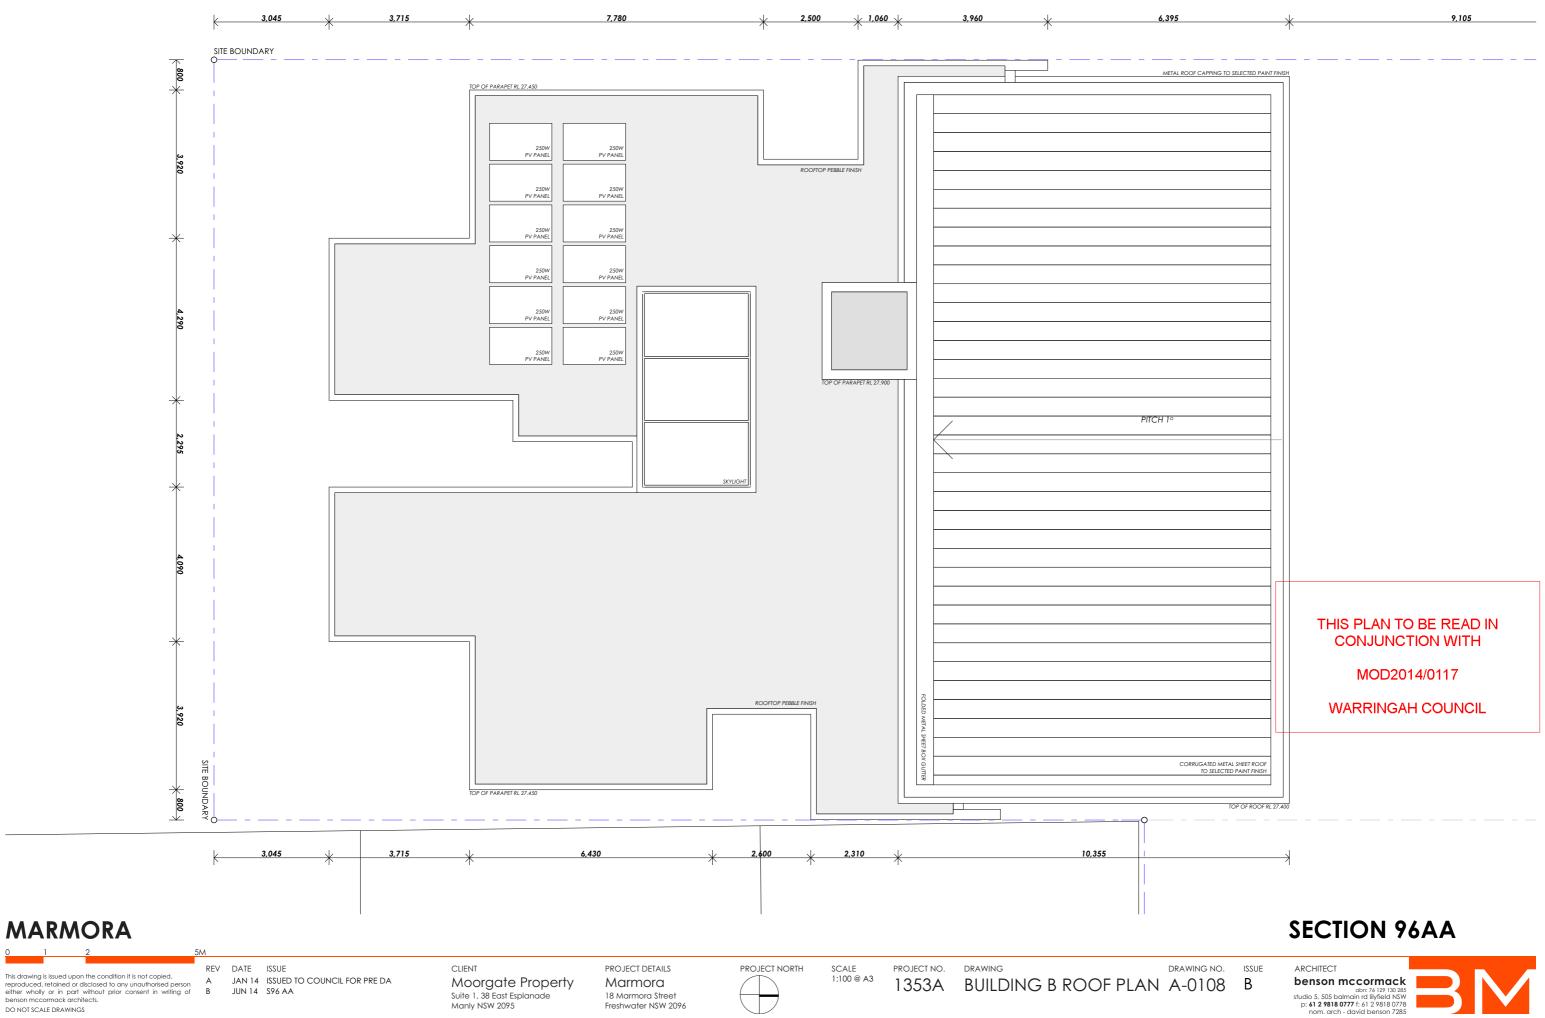

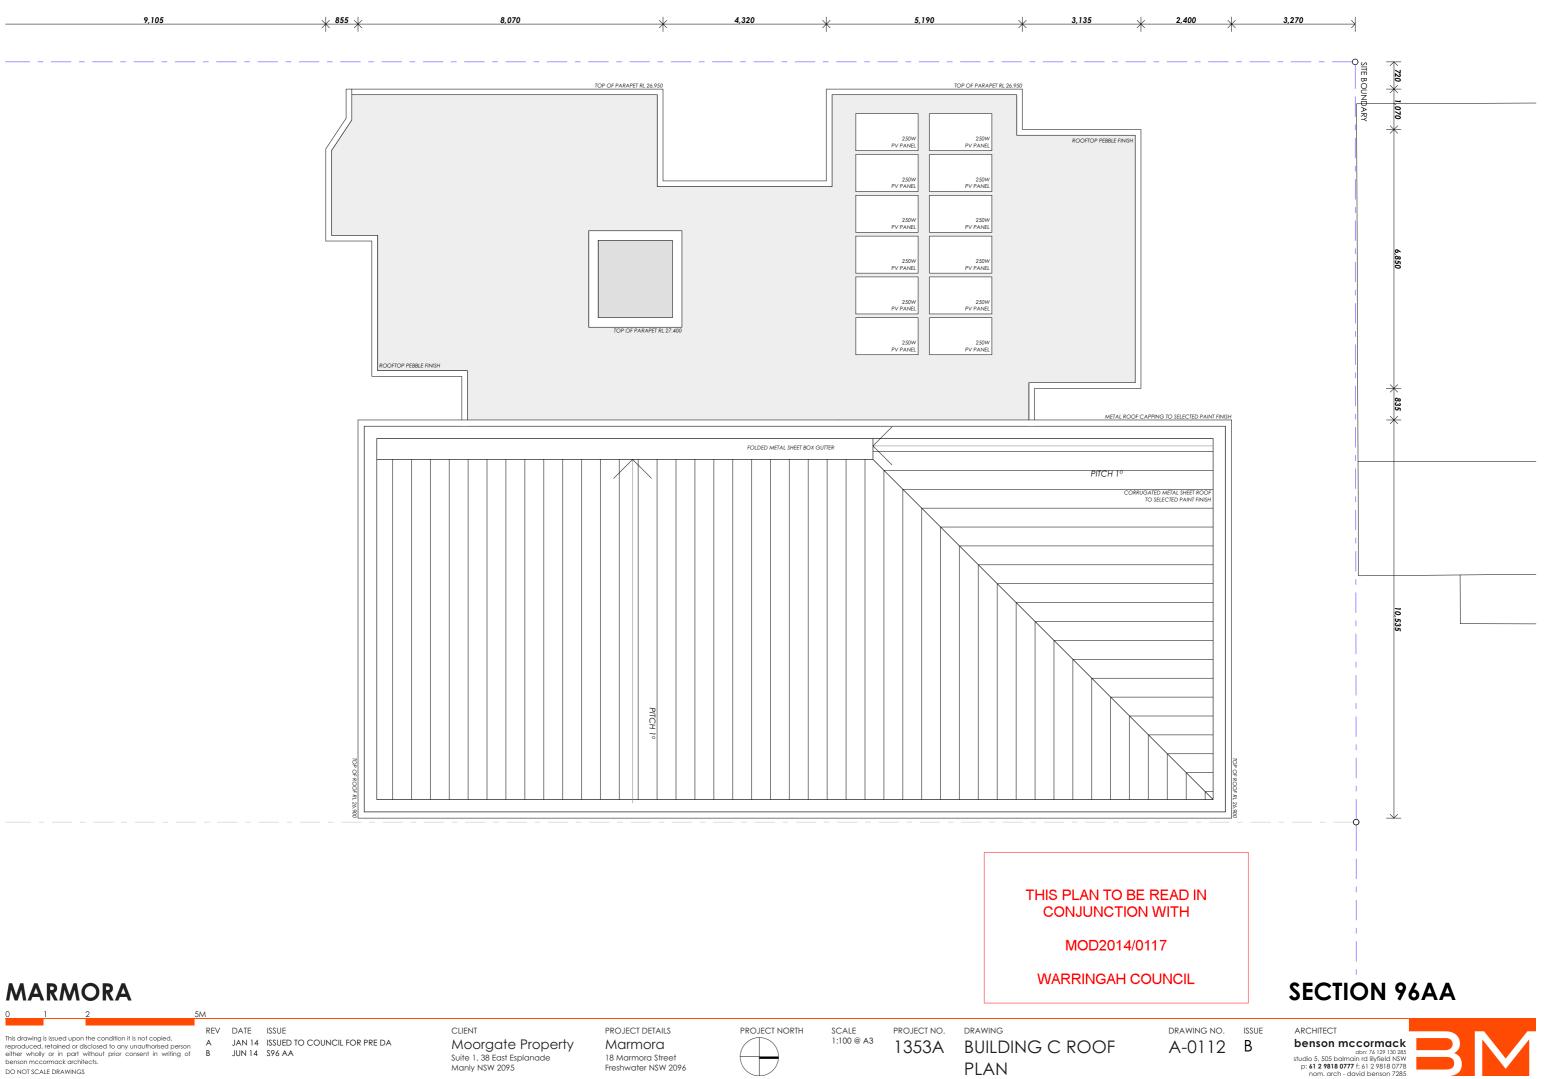

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PLAN

The following assumptions he	ave been used i	in the thermal an	a BASIX assessment			
BASIX WATER						
3 star rated (>6 but <= 7.5 L/min) showerheads, 4 star rated toilets, 4 star rated kitchen and bathroom taps						
ALTERNATIVE WATER SOURC	ALTERNATIVE WATER SOURCE					
3000L Central Water Tank			B01, B02 and B03 C01, C02 and C03			
BASIX ENERGY						
HOT WATER SYSTEM						
5.5 star rated central gas ins	tantaneous hot	water system.				
VENTILATION						
All individual exhaust fans ta	be sealed, duc	cted to facade o	r roof			
ARTIFICIAL LIGHTING						
All bedrooms, all living areas by LED or fluorescent lighting		l bathrooms, all lo	aundries and all hallway	rs are to be primarily lit		
Plans have been assessed w 5 in living/kitchen areas.	rith 2 downlights	in each bedroor	m, 1 in each bathroom,	1 in each laundry and		
ALTERNATIVE ENERGY SUPPL	Y					
5.5kW peak output photovo	ltaic system					
BASIX THERMAL COMFORT						
EXTERNAL WALLS	INSULATION			COLOUR		
Cavity Brick	R0.14 cellular i B02, B05, B06,		ternal walls of Units	Light		
	B01, B03, B04,	ene insulation to e C01 (including w g walls to hallway:				
Weatherboard clad Reverse Brick Veneer	R1.5 insulation B07, B08, C07	to all external wo and C08.	alls of Units	Dark		
Weatherboard clad Reverse Brick Veneer	R1.5 insulation	to all external wo	alls of Unit D01	Medium		
INTERNAL WALLS	INSULATION					
Brick Concrete Block Party Walls	Nil Nil					
FLOORS	INSULATION			COVERING		
200mm Concrete	R3.5 to slab so and D01	ffit of Unit B01, B0	2, B03, C01, C02, C03	Timber board/Tile		
ROOFING	INSULATION		COVERING	COLOUR		
Concrete Timber	Foil (sisalation)	to Metal roof	Loose pebble Colorbond steel	Light Dark		
CEILING	INSULATION			COLOUR		
Suspended Plasterboard	R3.0 to ceiling	of Unit B07, B08,	C07, C08 and D01	Light		
GLAZING	FRAME	U VALUE	SHGCw			
6.38 Laminated	Aluminium	6.35	0.77			

The following assumptions have been used in the thermal and BASIX assessment

C Two means	k <sup>800</sup> ¥ 7.060	<del>*****************</del> *	k	7.770	* 1.200 *
		11 METRE HEIGHT LIMIT			
	NEEDES DORM OF AMPLICED A SOM OF	8.5 METRE HEIGHT LIMIT			
0					
0					
L	X X				

# MARMORA

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BASIX NOTES


REV DATE ISSUE JAN 14 ISSUED TO COUNCIL FOR PRE DA JUN 14 S96 AA

CLIENT Moorgate Property Suite 1, 38 East Esplanade Manly NSW 2095

PROJECT DETAILS Marmora 18 Marmora Street Freshwater NSW 2096 PROJECT NORTH

SCALE 1:200 @ A3 PROJECT NO.

DRAWING 1353A NORTH ELEVATION

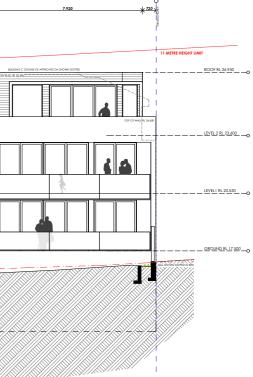

### THIS PLAN TO BE READ IN CONJUNCTION WITH

## MOD2014/0117


### WARRINGAH COUNCIL

# **SECTION 96AA**



ARCHITECT benson mccormack benson mccommon studio 5, 505 balmain rd liyfield NSW p: 61 2 9818 0777 f: 61 2 9818 0778 nom. arch - david benson 7285



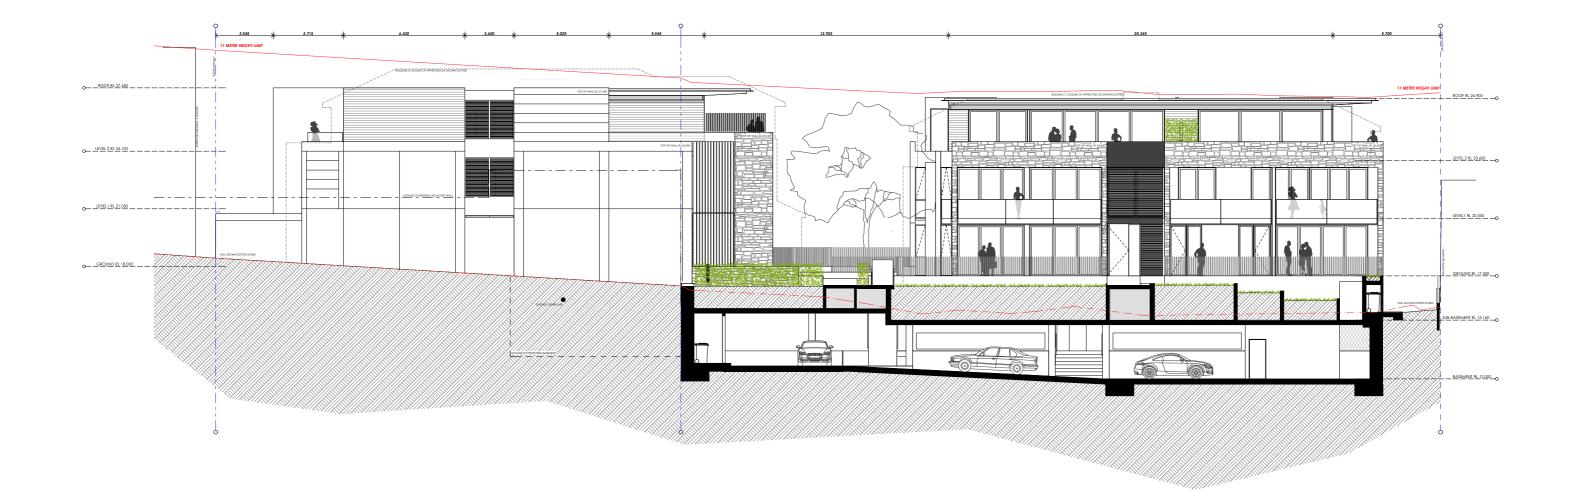

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REV DATE ISSUE

CLIENT Moorgate Property Suite 1, 38 East Esplanade Manly NSW 2095

PROJECT DETAILS Marmora 18 Marmora Street Freshwater NSW 2096 PROJECT NORTH

SCALE 1:200 @ A3

PROJECT NO. DRAWING 1353A EAST ELEVATION

#### THIS PLAN TO BE READ IN CONJUNCTION WITH

### MOD2014/0117


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# **SECTION 96AA**

DRAWING NO. ISSUE A-0201 B

ARCHITECT benson mccormack abn: 76 129 130 285 studio 5, 505 balmain rd lilyfield NSW p: **61 2 9818 0777** f: 61 2 9818 0778 nom. arch - david be son 7285



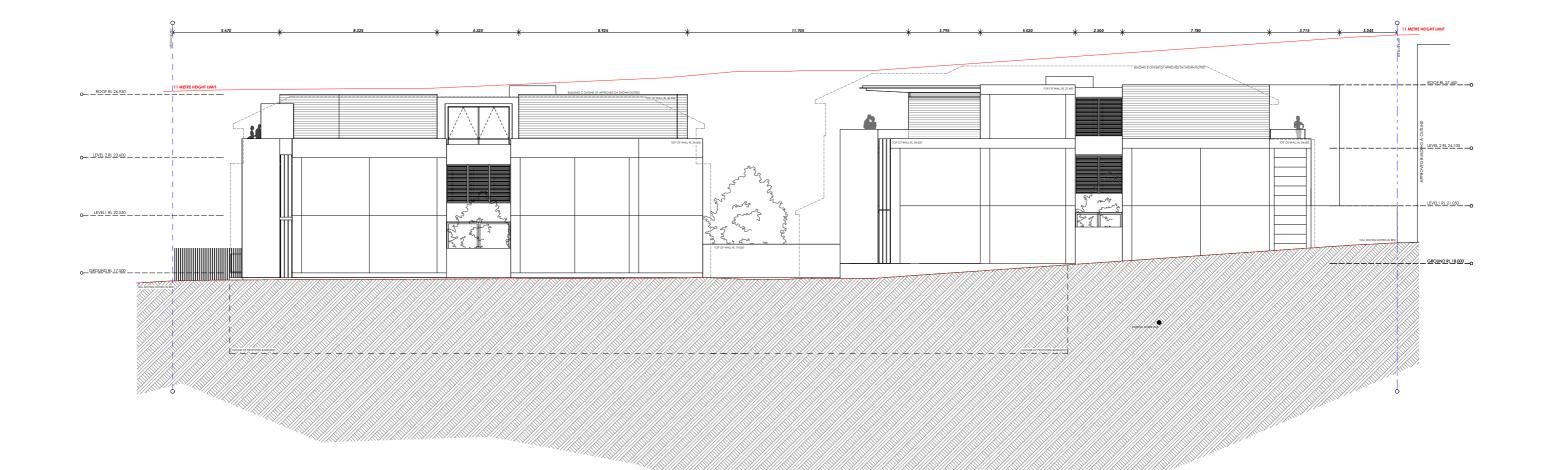

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CLIENT Moorgate Property Suite 1, 38 East Esplanade Manly NSW 2095

PROJECT DETAILS Marmora 18 Marmora Street Freshwater NSW 2096 PROJECT NORTH

SCALE 1:200 @ A3

PROJECT NO. DRAWING 1353A WEST ELEVATION

### THIS PLAN TO BE READ IN CONJUNCTION WITH

#### MOD2014/0117


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# **SECTION 96AA**

DRAWING NO. ISSUE A-0202 B

ARCHITECT benson mccormack abn: 76 129 130 285 studio 5, 505 balmain rd lilyfield NSW p: **61 2 9818 0777** f: 61 2 9818 0778 nom. arch - david b on 7285



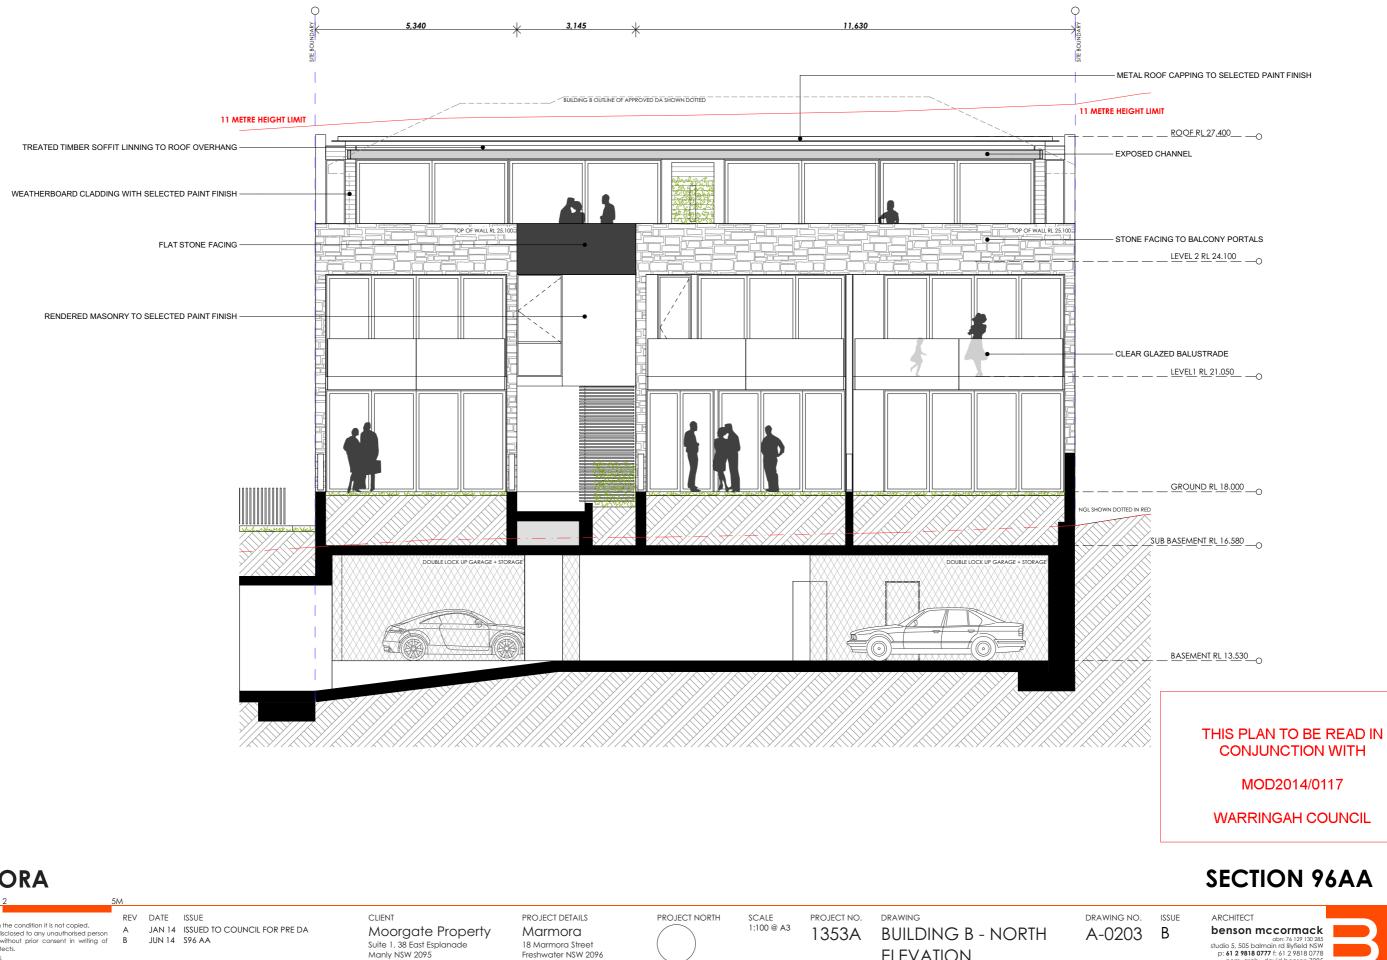

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JUN 14 S96 AA

Suite 1, 38 East Esplanade Manly NSW 2095

18 Marmora Street Freshwater NSW 2096

ELEVATION

nom. arch - david



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CLIENT Moorgate Property Suite 1, 38 East Esplanade Manly NSW 2095

PROJECT DETAILS Marmora 18 Marmora Street Freshwater NSW 2096 PROJECT NORTH

SCALE 1:100 @ A3

PROJECT NO. DRAWING 1353A BUILDING B - SOUTH ELEVATION

#### 11 METRE HEIGHT LIMIT

- FLAT STONE FACING

ROOF RL 27.450

WEATHERBOARD CLADDING WITH SELECTED PAINT FINISH

<u>LEVEL 2 RL 24.100</u>

AWNING TO SELECTED PAINT FINISH (1100MM DEEP)

<u>LEVEL1 RL 21.050</u>

SHOWN DOTTED IN RED

<u>GROUND RL 18.000</u>

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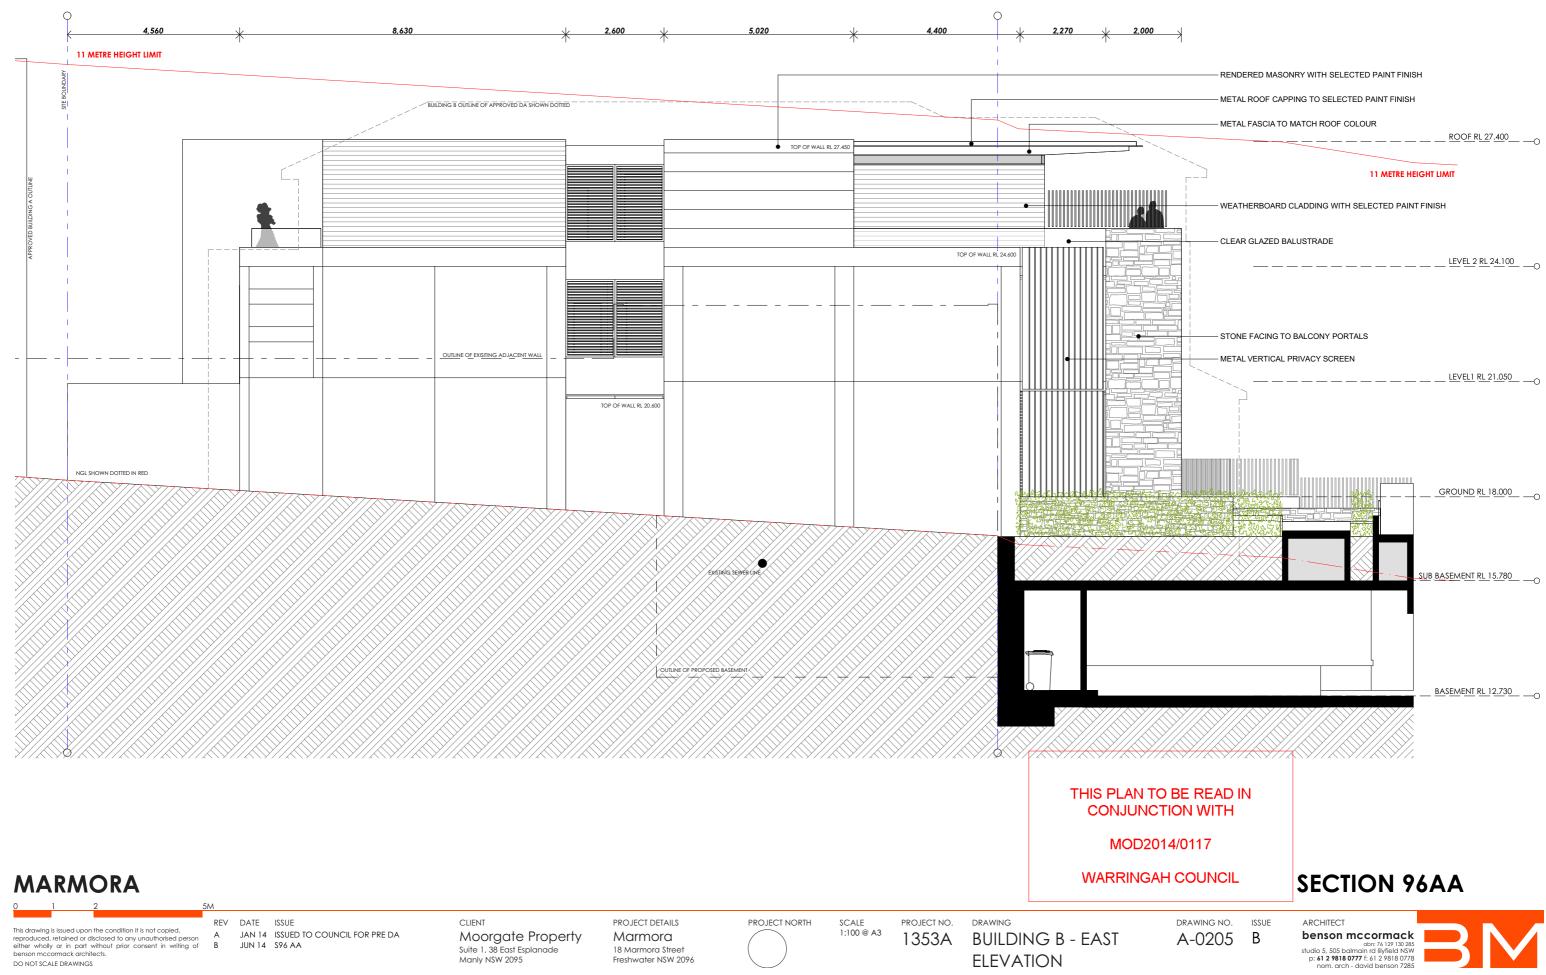
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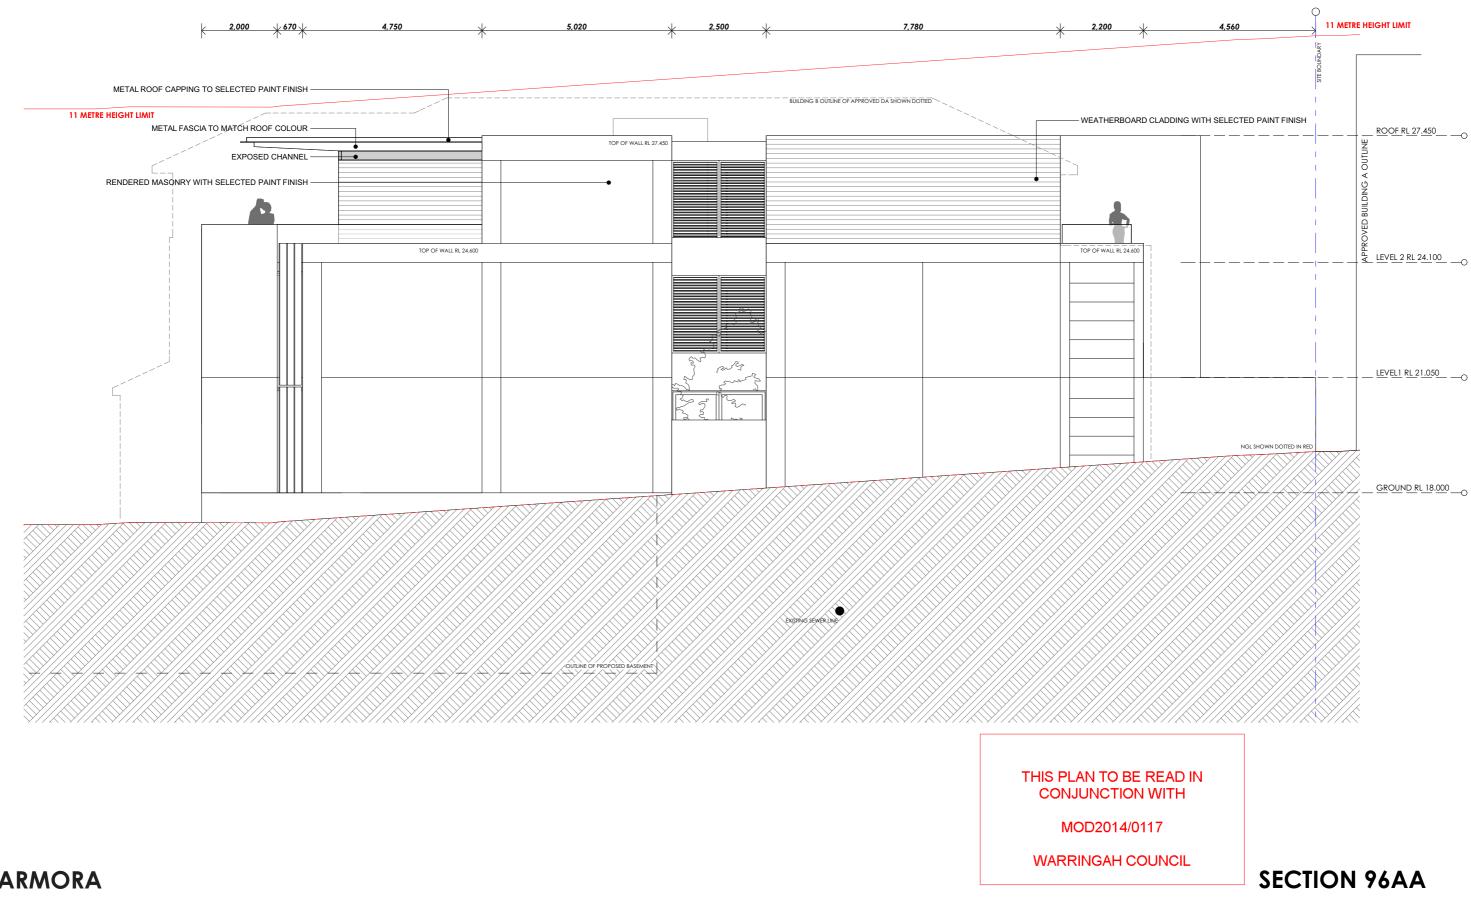
# **SECTION 96AA**

DRAWING NO. ISSUE A-0204 B

ARCHITECT benson mccormack abn: 76 129 130 285 studio 5, 505 balmain rd lilyfield NSW p: 61 2 9818 0777 f: 61 2 9818 0778 nom, arch - david b on 7285







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CLIENT Moorgate Property Suite 1, 38 East Esplanade Manly NSW 2095

PROJECT DETAILS Marmora 18 Marmora Street Freshwater NSW 2096 PROJECT NORTH


SCALE 1:100 @ A3 PROJECT NO.

DRAWING 1353A BUILDING B - WEST ELEVATION



ARCHITECT benson mccormack abn: 76 129 130 285 studio 5, 505 balmain rd lilyfield NSW p: 61 2 9818 0777 f: 61 2 9818 0778 nom. arch - david b



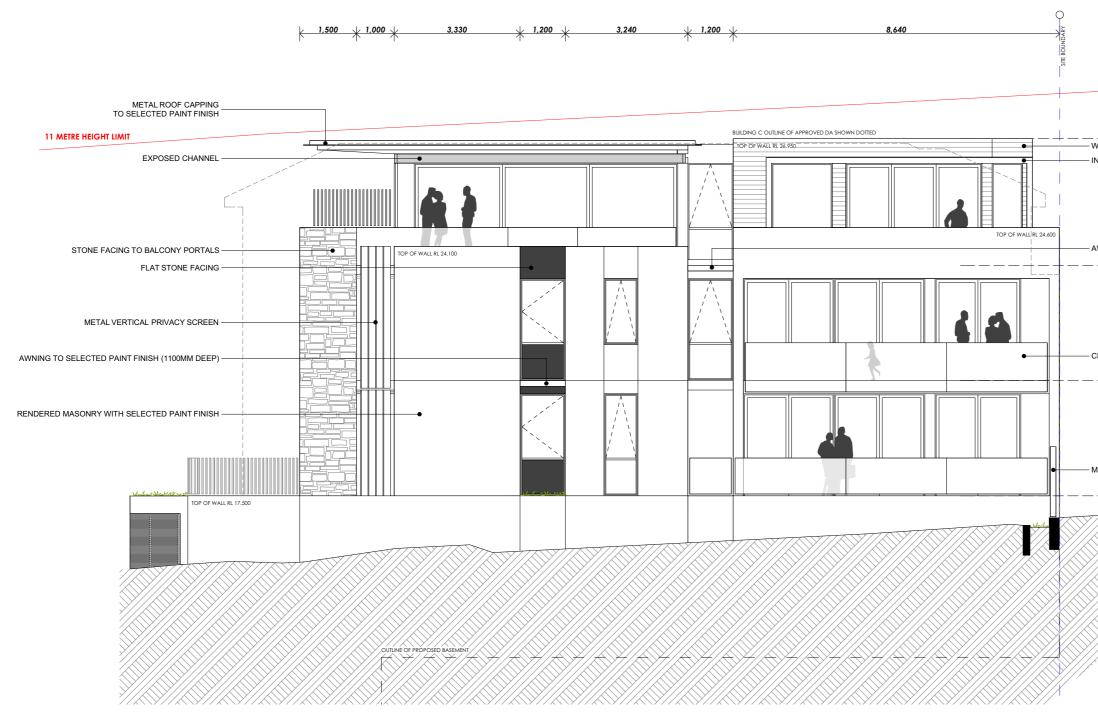

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REV DATE ISSUE

CLIENT Moorgate Property Suite 1, 38 East Esplanade Manly NSW 2095

PROJECT DETAILS Marmora 18 Marmora Street Freshwater NSW 2096 PROJECT NORTH

SCALE 1:100 @ A3 PROJECT NO.

DRAWING 1353A BUILDING C - NORTH ELEVATION

11 METRE HEIGHT LIMIT

ROOF RL 26.950 - WEATHERBOARD CLADDING WITH SELECTED PAINT FINISH - INTEGRATED STEEL FRAMED FC CLAD AWNING SURROUND

AWNING TO SELECTED PAINT FINISH (1100MM DEEP) \_\_\_\_<u>LEVEL 2 RL 23.600</u>\_\_\_O

- CLEAR GLAZED BALUSTRADE

\_\_\_\_<u>LEVEL1 RL 20.550</u>\_\_\_\_O

- METAL PALISADE FENCING

DRAWING NO. ISSUE

A-0207 B

\_\_\_\_\_ GROUND RL 17.500 \_\_\_\_



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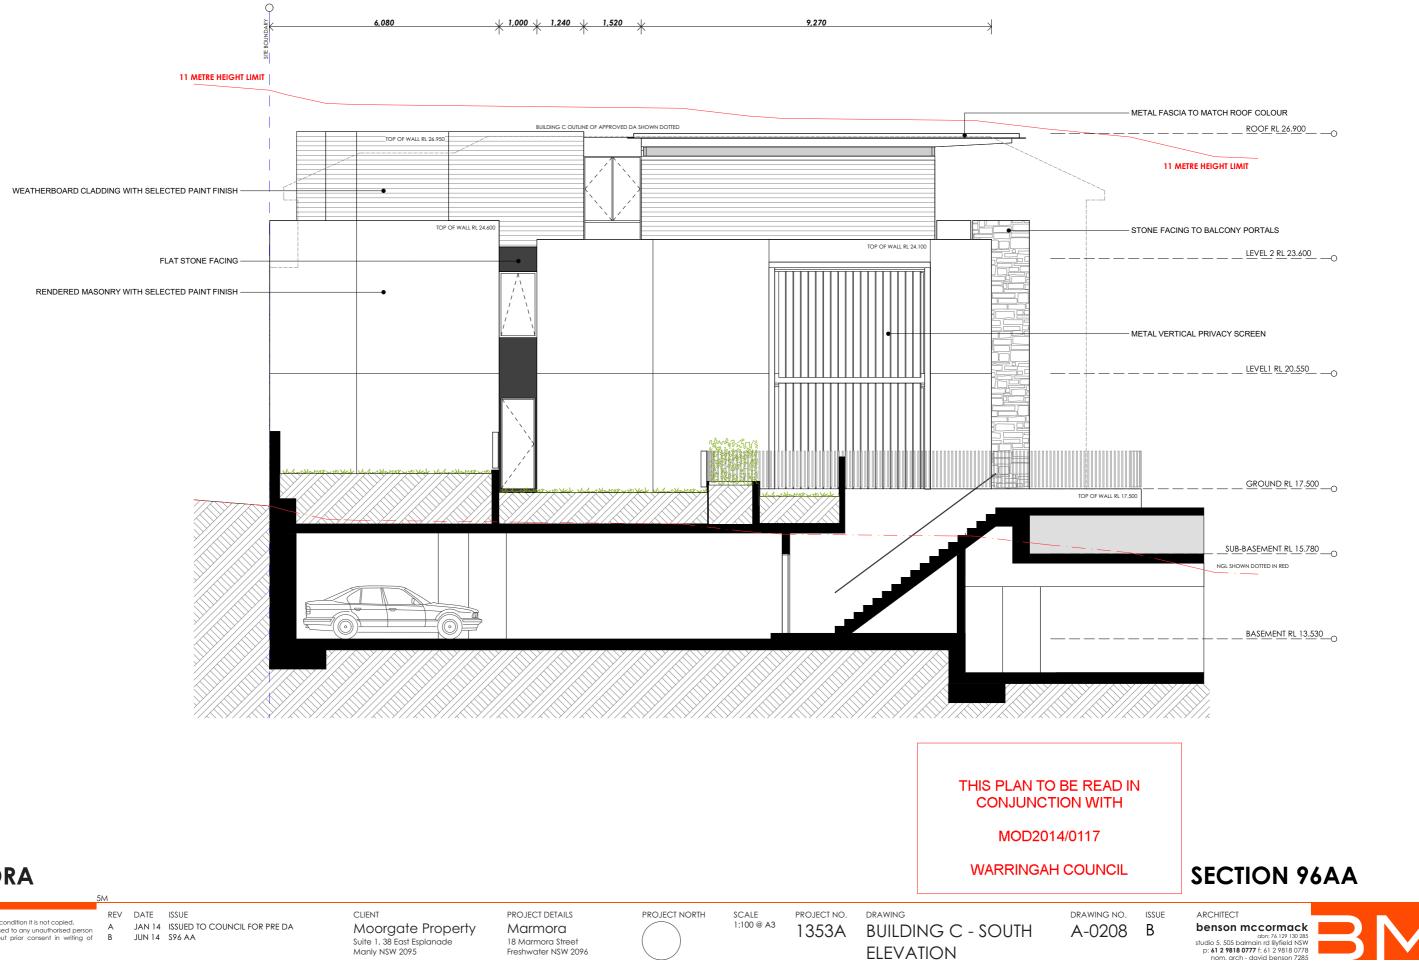
### MOD2014/0117

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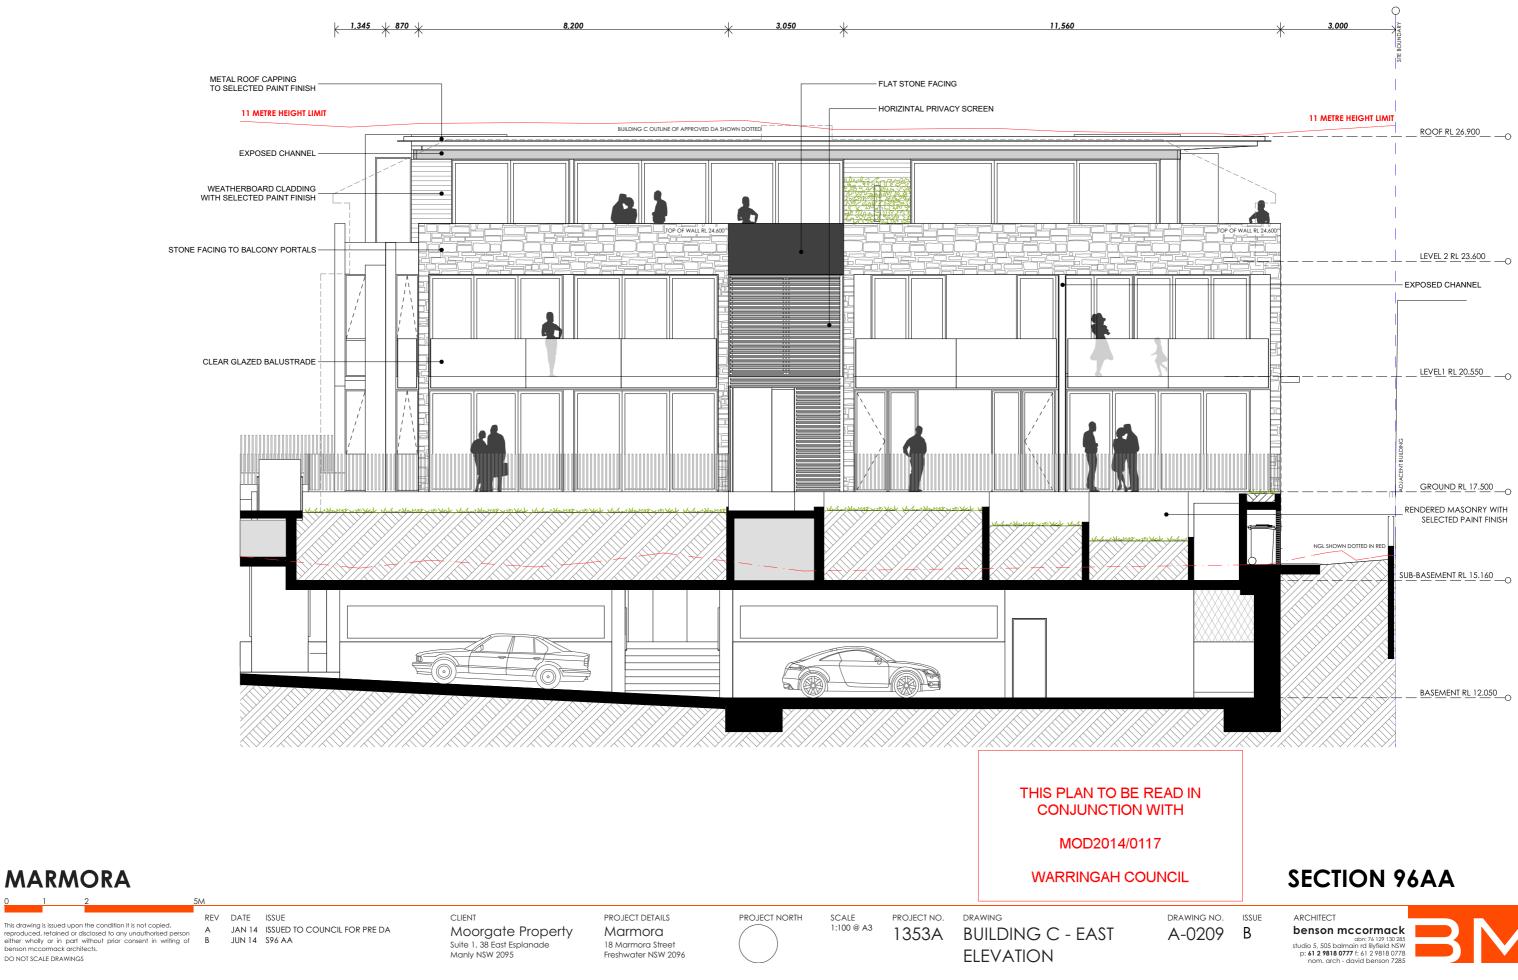
# **SECTION 96AA**



ARCHITECT benson mccormack abn: 76 129 130 285 studio 5, 505 balmain rd lilyfield NSW p: **61 2 9818 0777** f: 61 2 9818 0778 nom, arch - david be nson 7285




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MARMORA



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SCALE PROJECT NO. 1:100 @ A3 1353A


PROJECT NO. DRAWING 1353A BUILDING C - WEST ELEVATION
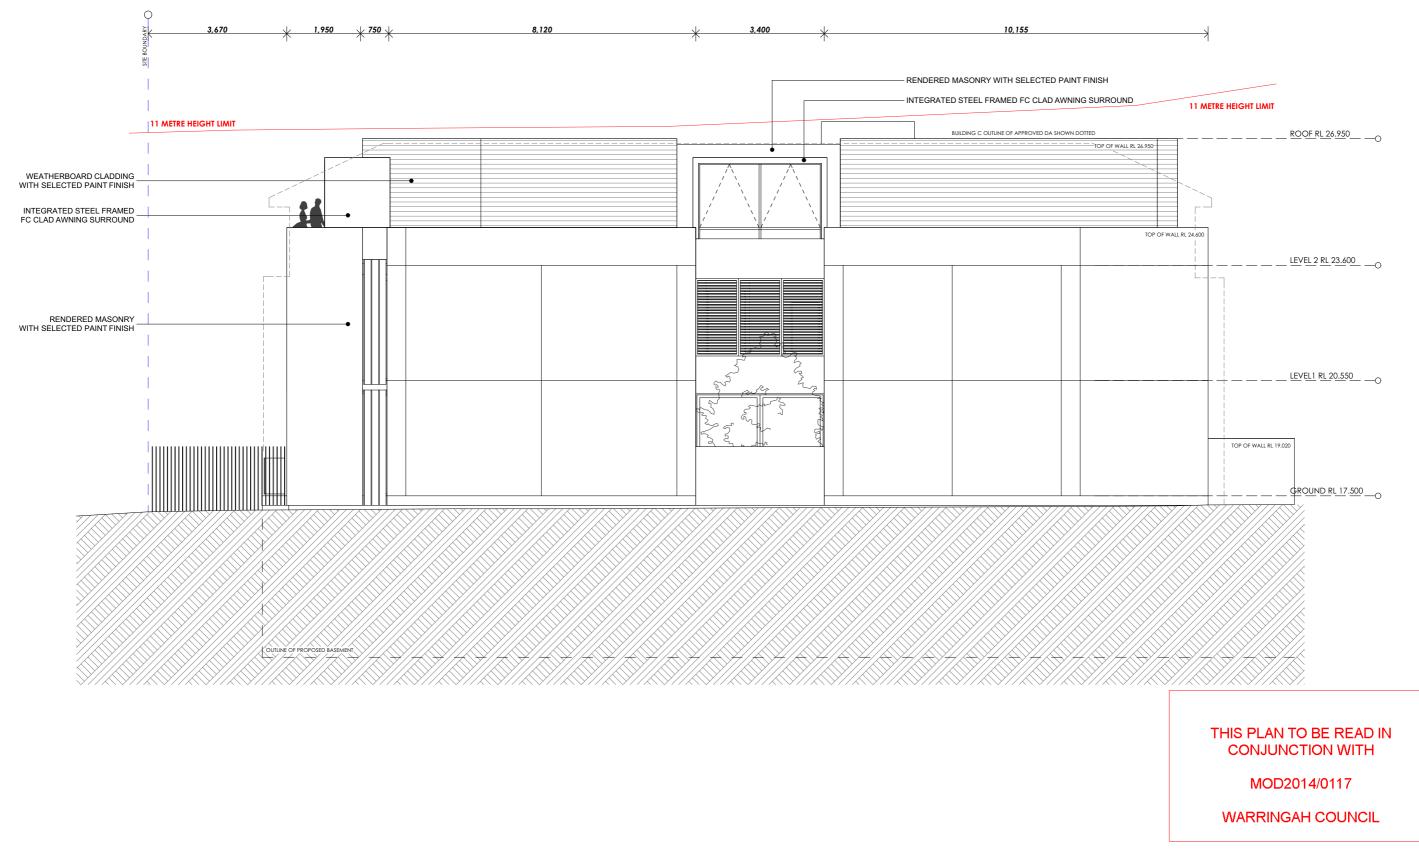
# **SECTION 96AA**

DRAWING NO. ISSUE

ARCHITECT **benson mccormack** abs: 76 129 130 285 studio 5, 505 balmain rd lilyfield NSW p: 61 2 9818 0777 f: 61 2 9818 0778 nom. arch - david benson 7285



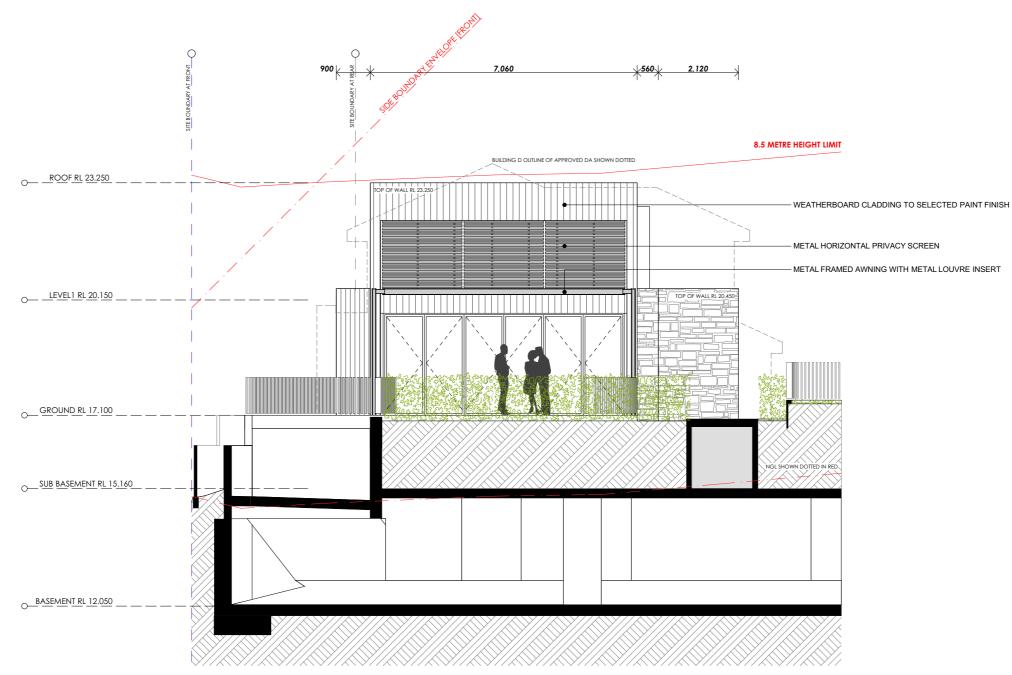

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PROJECT DETAILS Marmora 18 Marmora Street Freshwater NSW 2096 PROJECT NORTH

SCALE 1:100 @ A3 PROJECT NO. 1353A

DRAWING BUILDING D - NORTH ELEVATION

DRAWING NO. ISSUE A-0211 B

ARCHITECT benson mccormack abn: 76 129 130 285 studio 5, 505 balmain rd lilyfield NSW p: 61 2 9818 0777 f: 61 2 9818 0778 nom. arch - david




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**SECTION 96AA** 

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CLIENT Moorgate Property Suite 1, 38 East Esplanade Manly NSW 2095

PROJECT DETAILS Marmora 18 Marmora Street Freshwater NSW 2096 PROJECT NORTH

SCALE 1:100 @ A3 PROJECT NO.

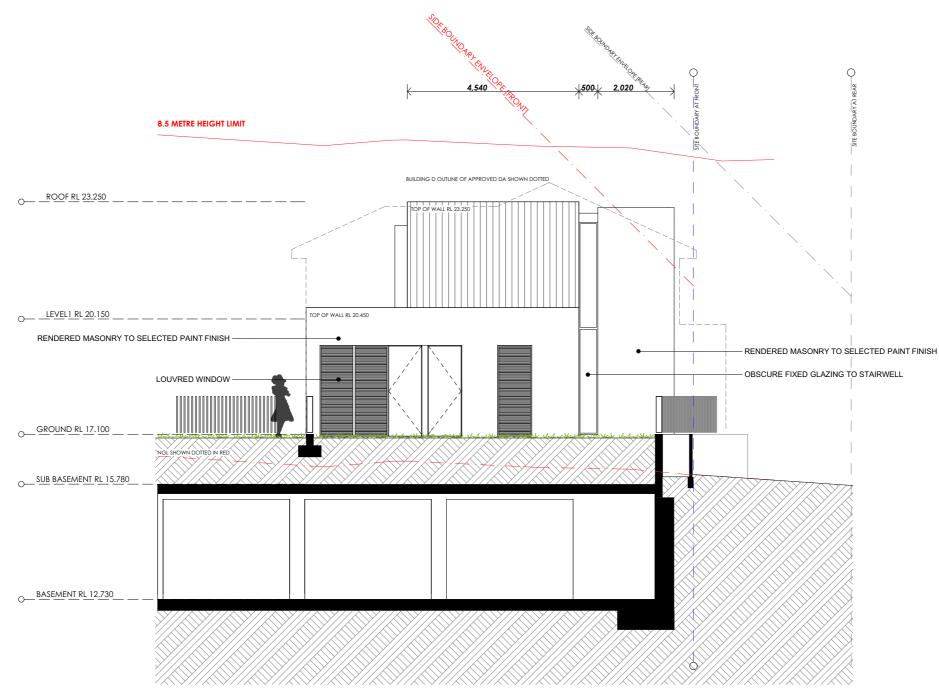DRAWING 1353A BUILDING D - SOUTH ELEVATION

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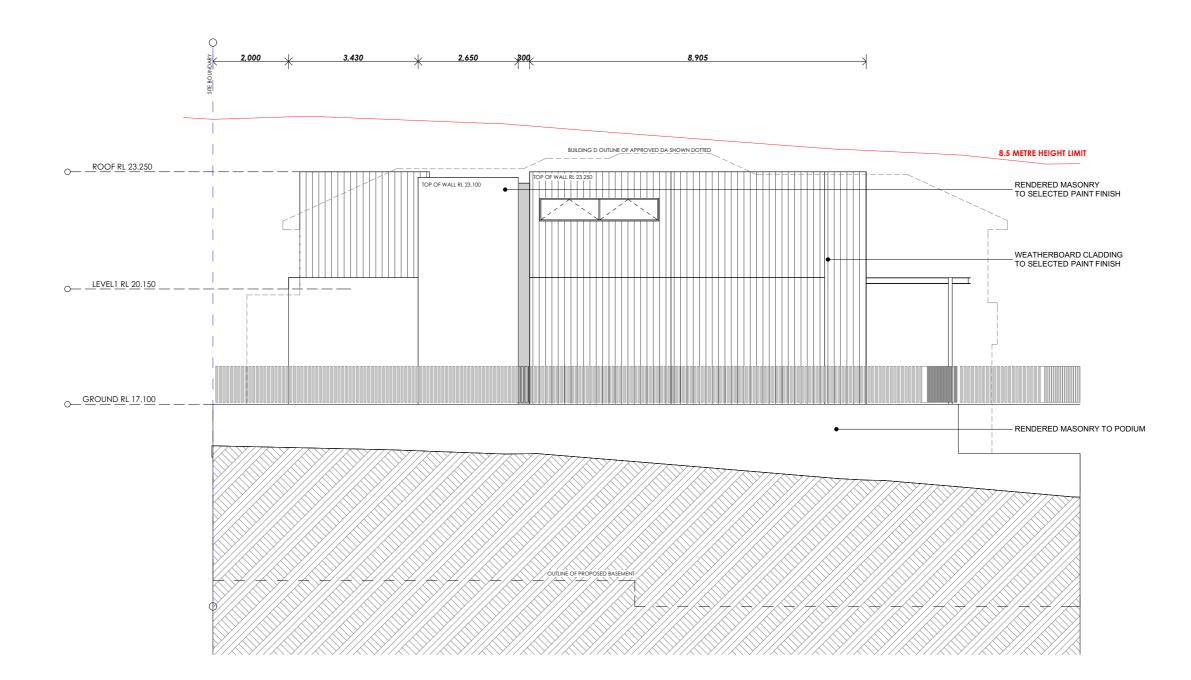
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# **SECTION 96AA**

DRAWING NO. ISSUE A-0212 B

ARCHITECT benson mccormack abr: 76 129 130 285 studio 5, 505 balmain rd lilyfield NSW p: **61 2 9818 0777** f: 61 2 9818 0778 nom, arch - david k





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CLIENT Moorgate Property Suite 1, 38 East Esplanade Manly NSW 2095

PROJECT DETAILS Marmora 18 Marmora Street Freshwater NSW 2096 PROJECT NORTH

SCALE 1:100 @ A3 PROJECT NO.

DRAWING 1353A BUILDING D - EAST ELEVATION

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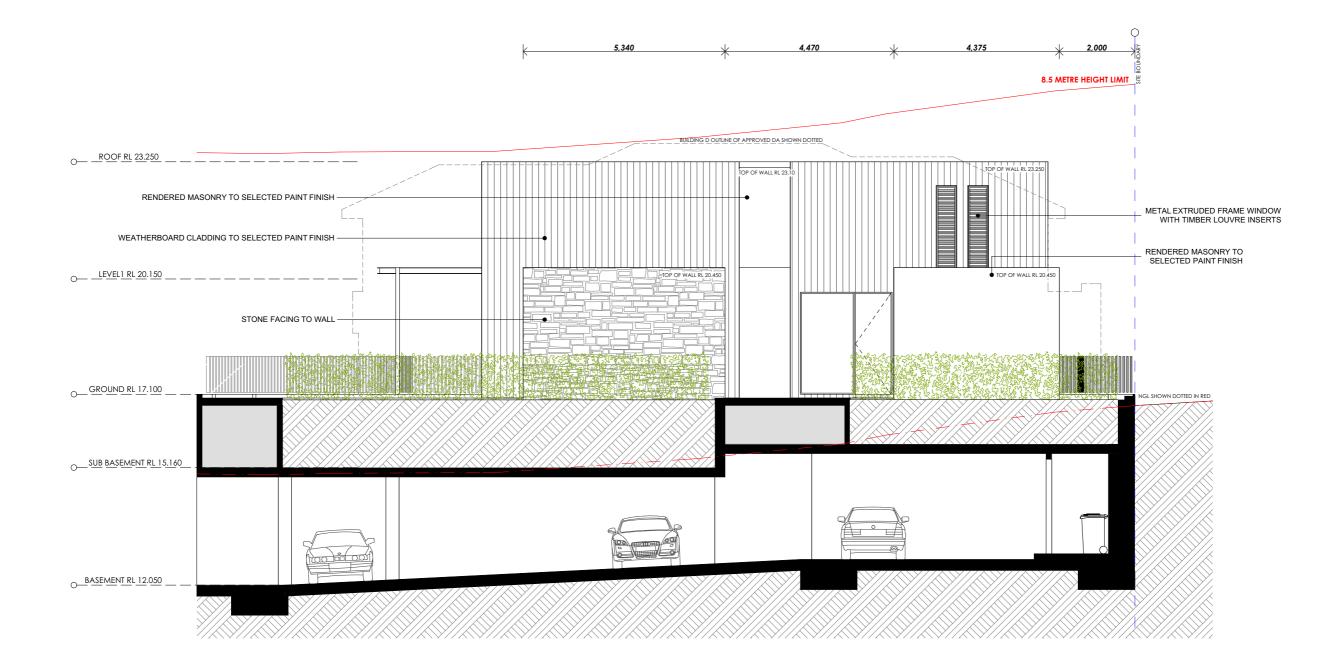
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# **SECTION 96AA**

DRAWING NO. ISSUE A-0213 B

ARCHITECT benson mccormack abn: 76 129 130 285 studio 5, 505 balmain rd lilyfield NSW p: **61 2 9818 0777** f: 61 2 9818 0778 nom. arch - david be nson 7285





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CLIENT Moorgate Property Suite 1, 38 East Esplanade Manly NSW 2095 PROJECT DETAILS Marmora 18 Marmora Street Freshwater NSW 2096 PROJECT NORTH

SCALE PROJECT NO. 1:100 @ A3 1353A

PROJECT NO. DRAWING 1353A BUILDING D - WEST ELEVATION

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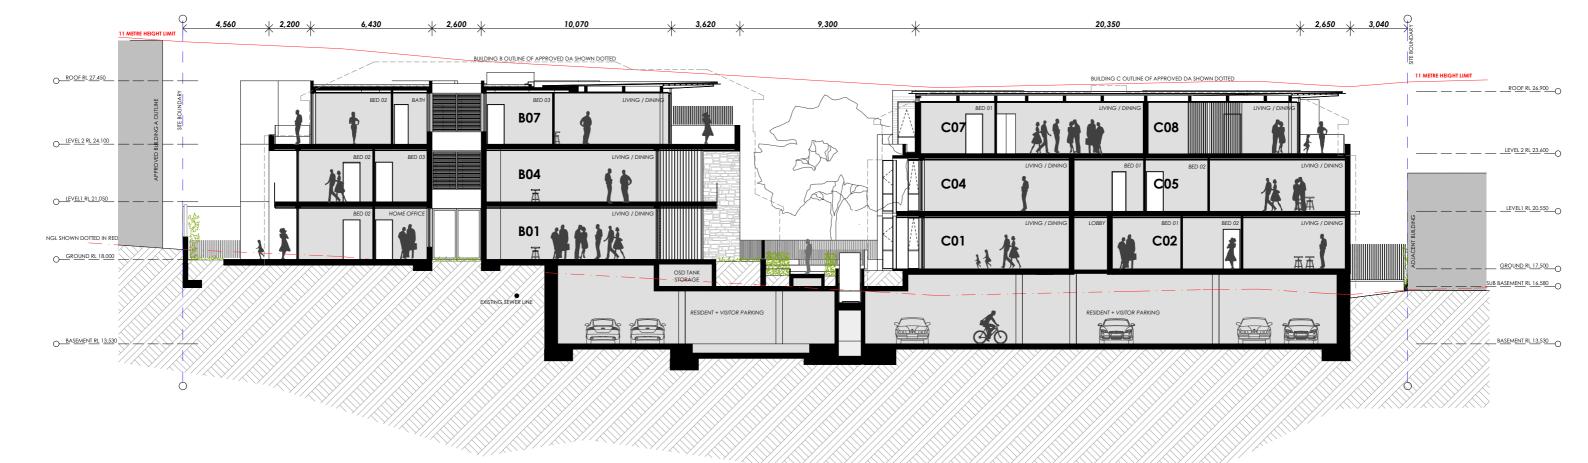
# SECTION 96AA

DRAWING NO. ISSUE

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ARCHITECT **benson mccormack** abr: 76 129 130 285 studio 5, 505 balmain rd illyfield XSW p: 61 2 9818 0777 f: 61 2 9818 0778 nom. arch - david benson 7285





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CLIENT Moorgate Property Suite 1, 38 East Esplanade Manly NSW 2095 PROJECT DETAILS Marmora 18 Marmora Street Freshwater NSW 2096 PROJECT NORTH

SCALE PROJECT NO. DRA 1:200 @ A3 1353A SE

D. DRAWING SECTION A

# THIS PLAN TO BE READ IN CONJUNCTION WITH

## MOD2014/0117


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# **SECTION 96AA**


DRAWING NO. ISSUE

ARCHITECT **benson mccormack** abn: 76 129 130 285 studio 5, 505 balmain rd lilyfield NSW p: 61 2 9818 0777 f: 61 2 9818 0778 nom. arch - david benson 7285



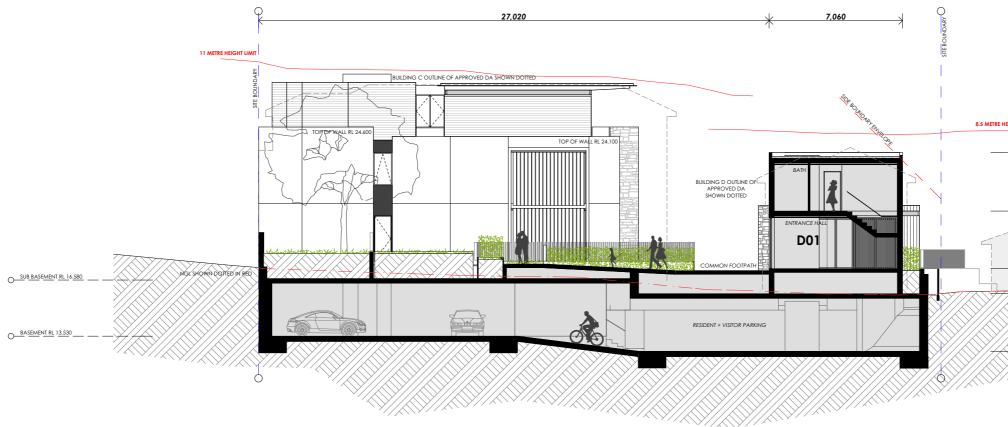

SECTION B

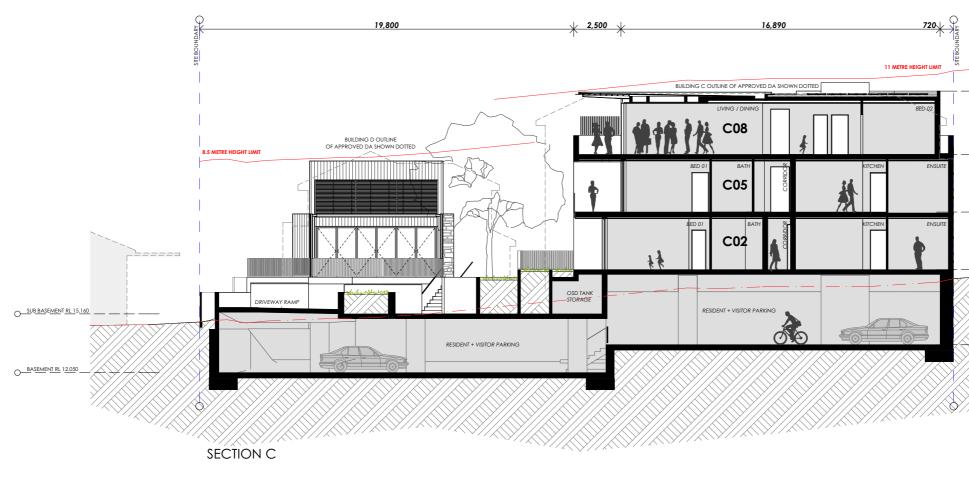

# MARMORA

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REV DATE ISSUE

CLIENT Moorgate Property Suite 1, 38 East Esplanade Manly NSW 2095

PROJECT DETAILS Marmora 18 Marmora Street Freshwater NSW 2096 PROJECT NORTH

SCALE 1:200 @ A3 PROJECT NO. DRAWING 1353A SECTION B + C

#### 8.5 METRE HEIGHT LIMIT

\_\_\_\_\_LEVEL1 RL 20.150\_\_\_\_O SUB BASEMENT RL 15.780 BASEMENT RL 12.050 THIS PLAN TO BE READ IN CONJUNCTION WITH MOD2014/0117 WARRINGAH COUNCIL \_\_\_\_<u>LEVEL 2 RL 23.600</u>O \_\_\_\_\_LEVEL1 RL 20.550\_\_\_\_O


GROUND RL 17.500 IGL SHOWN DOTTED IN RED BASEMENT RL 13.530





ARCHITECT benson mccormack abn: 76 129 130 285 studio 5, 505 balmain rd lilyfield NSW p: 61 2 9818 0777 f: 61 2 9818 0778 nom, arch - david b



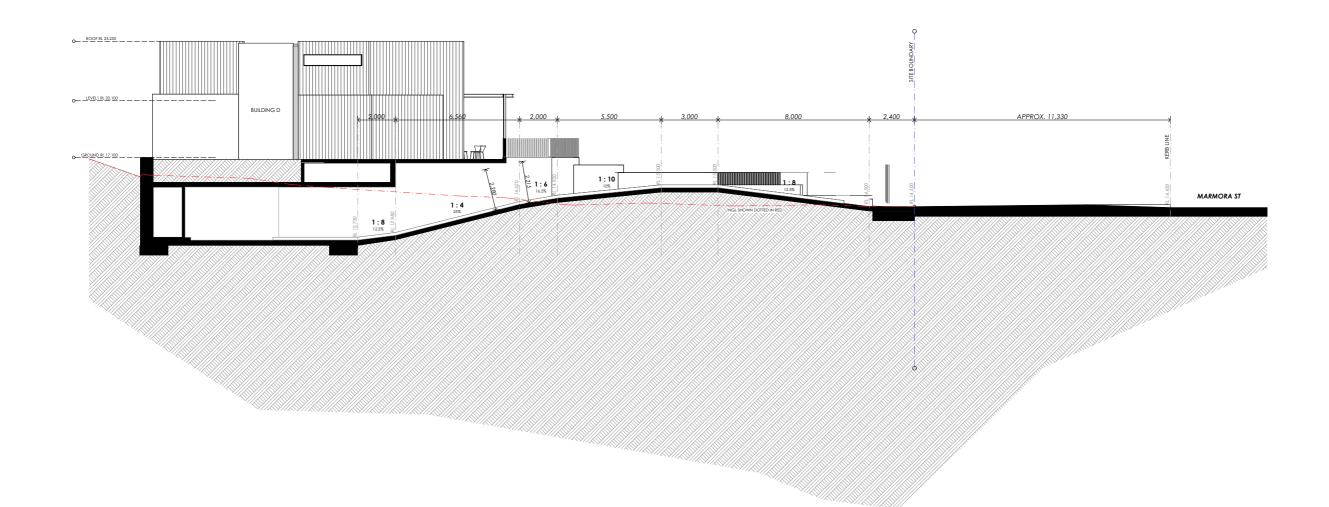

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CLIENT Moorgate Property Suite 1, 38 East Esplanade Manly NSW 2095

PROJECT DETAILS Marmora 18 Marmora Street Freshwater NSW 2096 PROJECT NORTH

SCALE 1:200 @ A3

PROJECT NO. DRAWING 1353A DRIVEWAY SECTION

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## MOD2014/0117

WARRINGAH COUNCIL

# **SECTION 96AA**

DRAWING NO. ISSUE A-1600 B

ARCHITECT beins on mccormack abr: 76 129 130 285 studio 5, 505 balmain rd lilyfield NSW p: 61 2 9818 0777 f: 61 2 9818 07778 nom. arch - david benson 7285



#### WALLS



#### STONE FACING TO PORTALS

SANDSTONE WALL CLADDING



WEATHERBOARD CLADDING 02

PAINT FINISH SIM/EQ TO DULUX 'SHOJI WHITE' MATT



#### **RENDERED MASONRY 01**

PAINT FINISH SIM/EQ TO DULUX 'SHOJI WHITE' MATT



**RENDERED MASONRY 02** 

PAINT FINISH SIM/EQ TO DULUX 'OOLONG' MATT



#### FLAT STONE FACING

SLATE WALL TILE CLADDING

ROOF



#### SHEET METAL ROOFING

POWDERCOAT FINISH SIM/EQ TO DULUX 'NIGHT SKY'





SOFFIT
INNOWOOD DECKING SYSTEM IN 'SPOTTED GUM'
WALL OPENINGS

ALUMINIUM WINDOW FRAME	

POWDERCOATED FINISH SIM/EQ TO DULUX 'ANOTEC DARK GREY'

# MARMORA

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CLIENT Moorgate Property Suite 1, 38 East Esplanade Manly NSW 2095

PROJECT DETAILS Marmora 18 Marmora Street Freshwater NSW 2096 PROJECT NORTH

PROJECT NO. SCALE NTS

DRAWING 1353A MATERIALS & FINISHES A-1612 B

### THIS PLAN TO BE READ IN CONJUNCTION WITH

### MOD2014/0117

### WARRINGAH COUNCIL

## SCREEN

#### LANDSCAPE FENCING

TIMBER, COLOUR SIM/EQ TO MERBAU



#### LOUVRE / PERGOLA

POWDERCOATED FINISH SIM/EQ TO DULUX 'BRONZE PEARL'

## ARTICULATION



#### EXPOSED STEEL CHANNEL

POWDERCOATED FINISH SIM/EQ TO DULUX 'GHETTO BLACK'

DRAWING NO. ISSUE

ARCHITECT benson mccormack abn: 76 129 130 285 studio 5, 505 balmain rd lilyfield NSW p: **61 2 9818 0777** f: 61 2 9818 0778



# **PROPOSED HOUSING DEVELOPMENT** 18 MARMORA STREET, HARBORD, NSW **CIVIL DRAWINGS**

PROJECT No. 111927

DRAWING INDEX 109865-00-MIE000 109865-00-MIE100 STORMWATER MANAGEMENT PLAN 109865-00-MIE150 OSD TANK 2 AND DETAILS 109865-00-MIE151 OSD TANK 3 AND DETAILS

#### STORMWATER DRAINAGE

ALL WORKMANSHIP AND MATERIALS SHALL COMPLY WITH THE CURRENT EDITIONS OF THE FOLLOWING AUSTRALIAN STANDARDS. AS 1260 UNPLASTICISED PVC (UPVC) PIPES AND FITTINGS FOR SEWERAGE APPLICATIONS AS 1260 UNPLASTICISED PVC (UPVC) PIPES AND FITTINGS FOR SEWERAGE APPLICATIONS AS 1597 PRECAST REINFORCED CONCRETE BOX CULVERTS PART 1 - SMALL CULVERTS (NOT EXCEEDING 1200MM WIDTH AND 900MM DEPTH) AS 1531 CAST IRON 100-NFESSURE PIPES AND PIPE FITTINGS AS 1550 GALVANISED COATINGS AS 1555 SAA CODE FOR FIXED PLATFORMS, WALKWAYS, STAIRWAYS AND LADDERS AS 2032 CODE OF PRACTICE FOR INSTALLATION OF UPVC PIPE SYSTEMS AS 2032 CODE OF PRACTICE FOR INSTALLATION OF UPVC PIPE SYSTEMS AS 2033 OCDE OF PRACTICE FOR INSTALLATION OF UPVC PIPE SYSTEMS AS 2032 CODE OF PRACTICE FOR INSTALLATION OF UPVC PIPE SYSTEMS AS 2030 9100 PLANTIGE PIPE AND ASSOCIATED FITTINGS PART 1 - PERFORATED PLASTICES DRAINAGE AND EFFLUENT PIPE FITTINGS AS 3030 31 NATIONAL PLUMBING AND DRAINAGE CODE, PART 3, STORMWATER DRAINAGE AS 3020 1000 SQN BILIERIE OUNCPETF PIPES

AS 3725 LOADS ON BURIED CONCRETE PIPES AS 3925 EDADS ON BURIED CONCRETE PIPES AS 3996 METAL ACCESS COVERS, ROAD GRATES AND FRAMES AS 4058 PRECAST CONCRETE PIPES (PRESSURE AND NON-PRESSURE) AS 4139 FIBRE REINFORCED CONCRETE PIPES AND FITTINGS

THE CONTRACTOR SHALL COMPLY WITH THE 'MINES (TRENCHES) REGULATIONS 1982' FOR ALL SHORING, SUPPORT OF TRENCHES, QUALIFICATIONS OF PERSONNEL AND NOTIFICATION TO THE RESPONSIBLE AUTHORITY

TRENCHES MUST BE KEPT CLEAR OF WATER AT ALL TIMES AND TIMBERED WHERE NECESSARY TO PREVENT COLLAPSE.

SUITABLE SAFETY BARRIERS SHALL BE PROVIDED AROUND THE EXCAVATION AT ALL TIMES. THE BARRIERS SHALL BE SUITABLY DEFINED BY APPROVED LIGHTING DURING THE APPROPRIATE LIGHT UP TIME FOR THE AREA

PIPES SHALL BEAR EVENLY ON THE BED PREPARED AS SPECIFIED ABOVE AND LAID WITH THE SOCKETS POINTED IN DEGRADE ALL PIPES SHALL BE LAID IN STRAIGHT LINES, TO TRUE INVENTIEVELS AND GRADES AS SHOWN ON PLANS EACH PIPE SHALL BE LAID IN STRAIGHT LINES, TO TRUE INVERT LEVELS AND GRADES AS SHOWN ON PLANS EACH PIPE SHALL BE SEPARATELY BONED BETWEEN ACCURATELY ESTABLISHED GRADE POINTS. THE CONTRACTOR SHALL ADERED TO THE DRAWINGS AND SHALL NOT BE PERMITTED TO VARY THE LINE, LEVELS OR LOCATION OF THE DRAIN WITHOUT THE SUPERINTENDENTS WRITTEN APPROVAL

ALL PIPE JOINTING SHALL BE CARRIED OUT IN ACCORDANCE WITH THE MANUFACTURER'S WRITTEN SPECIFICATIONS FOR THE TYPE OF PIPE BEING USED

WHERE ANY PIPE IS CUT INTO A LARGER PIPE, SUCH CONNECTION SHALL BE NEATLY MADE AND NO PART OF THE PIPE OR DOWNIPIPE SHALL BE ALLOWED TO PROJECT ANY CUT-IN JUNCTION SHALL BE MADE IN THE TOP HALF OF THE LARGER PIPE SUCH JUNCTION TO CONCRETE PIPES SHALL BE SURROUNDED WITH A NEAT COLLAR OF CEMENT MORTRA AS DIRECTED OR AS DETAILED ON THE DRAWINGS JUNCTIONS BETWEEN PAYO PIPES SHALL USE PROPRIETY FITTINGS INTENDED FOR THE PURPOSE

THE ENDS OF PIPES WHICH CONNECT WITH SIDE ENTRY, JUNCTION OR OTHER PITS SHALL BE NEATLY CUT TO FIT THE INNER FACE OF THE CONCRETE. WHERE UPVC PIPES ENTER/LEAVE PITS A RUBBER RING JOINT MANHOLE COUPLING SHALL BE CAST INTO THE PIT WALL BEDDING, HAUNCH AND OVERLAY MATERIALS SHALL CONFORM TO THE DETAILS SHOWN ON THE DRAWINGS

ALL PITS AND ENDWALLS SHALL BE CONSTRUCTED IN THE POSITIONS AND TO THE LEVELS SHOWN ON THE

DRAWINGS OR AS DIRECTED BY THE SUPERINTENDENT

TH FLOW PATH

ALL DOWNPIPES SHALL BE CONNECTED TO AT THE END OF A PIPE OR ELBOW AND WHICH THEY SHALL ENTER

CENTRALLY WHERE PVC DOWNPIPES AND UNDERGROUND DRAINAGE ARE USED, THE DOWNPIPES SHALL BE CONNECTED TO THE UNDERGROUND DRAINS WITH SUITABLE STANDARD FITTINGS. BENDS ETC AND WITH SOLVENT JOINTS THE CONTRACTOR SHALL LAY AND GRADE DRAINS FROM DOWNPIPES TO COMPLY WITH THE REQUIREMENTS FOR PIPE MATERIAL AND COVER REQUIRED BY ASSIGN 3. WHEER HE REQUIREMENTS OF ASSIGN 3 CANNOT BE MET THE CONTRACTOR SHALL REFER THE MATTER TO THE SUPERINTENDENT

SUPPLY APPARATUS AND MATERIALS NECESSARY FOR AND CARRY OUT THE TESTS REQUIRED BY THE DENT AND THE RELEVANT

THE CONTRACTOR SHALL PRESSURE TEST WITH WATER, ALL STORMWATER PIPEWORK IN OR UNDER THE STRUCTURE, IN ACCORDANCE WITH AS 3500 3

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#### EARTHWORKS

THE CONTRACTOR SHALL COMPLY WITH THE CURRENT EDITIONS OF THE FOLLOWING VICROADS AND AUSTRALIAN STANDARDS AUSTRALIAN STANDARDS

AS 1289 TESTING SOILS FOR ENGINEERING PURPOSES

AS 3798 GUIDELINES ON EARTHWORKS FOR COMMERCIAL AND RESIDENTIAL DEVELOPMENTS VICROADS SPECIFICATION - SECTION 201 SITE CLEARING

THE CONTRACTOR SHALL BE RESPONSIBLE FOR CARRYING OUT ALL CONTROL AND COMPLIANCE EXAMINATION AND

TESTING OF MATERIALS AND WORK

TESTING OF MATERIALS AND WORK UNLESS OTHERWISE SPECIFIED, ALL TESTS SHALL BE UNDERTAKEN IN ACCORDANCE WITH THE APPROPRIATE AUSTRALIAN STANDARD TEST METHOD. WHERE THERE IS NO RELEVANT AUSTRALIAN STANDARD TEST METHOD THEN THE CURRENT APPROPRIATE VICROADS TEST METHOD OR OTHER SPECIFIED TEST METHOD SHALL BE USED ALL TESTS SHALL BE CONDUCTED BY EXPERIENCED TESTING OFFICERS IN A LABORATORY ACCREDITED BY THE NATIONAL ASSOCIATION OF TESTING AUTHORITIES (NATA)

ES DETERMINATION OF THE NATURE AND QUANTITY(IES) OF THE EXISTING SITE MATERIALS SHALL BE THE RESPONSIBILITY OF THE CONTRACTOR WHERE INCLUDED IN THE DOCUMENTS, GEOTECHNICAL REPORTS ARE INCLUDED FOR INFORMATION ONLY. INTERPRETATION OF THE REPORT/S SHALL BE THE RESPONSIBILITY OF THE CONTRACTOR THE CONTRACTOR SHALL BE DEEMED TO HAVE ALLOWED IN THE CONTRACT SUM FOR EXCAVATION IN ALL MATERIAL NO ADDITIONAL PAVEMENT SHALL BE MADE FOR EXCAVATION IN ROCK NOR ANY HARD OR SOFT MATERIAL USE OF ON-SITE MATERIAL WITHIN THE WORKS SHALL ONLY BE PERMITTED WHERE THE MATERIAL EITHER

USE OF ON-SITE MATERIAL WITHIN THE WORKS SHALL ONLY BE PERMITTED WHERE THE MATERIAL EITHER I IS SPECIALLY STATED WITHIN THE DOCUMENTS AS BEING USED IN THE WORKS, OR II IS PERIALLY STATED WITHIN THE DOCUMENTS AS BEING USED IN THE WORKS, OR III SPERIALLY STATED WITHIN THE DOCUMENTALS COMPRISING GRANULAR IGNEOUS WEATHERED ROCK OR QUARRY MASTE (SUCH AS RMS DGS40 OR EQUIVALENT), SANDY CLAY OR WEATHERED SEDIMENTARY ROCK THE FILL MATERIAL 'VM PARTICLE SIZE AFTER COMPACTION SHALL NOT EXCEED 40MM, NOT LESS THAN 50% OF THE MATERIAL SHALL BE 'SER THAN 75 MICRON AND IT SHALL HAVE A LIQUID LIMIT NOT EXCEED 400M, NOT LESS THAN SO% OF THE MATERIAL SHALL BE WEDEN

UNSUITABLE MATERIAL SHALL MEAN ANY MATERIAL WHICH CONTAINS VEGETABLE MATTER, ROOTS, STUMPS AND OR ANY OTHER PERISHABLE, FOREIGN OR DELETERIOUS MATTER, OR CONTAINS CLAY HAVING A LIQUID LIMIT EXCEEDING 80% AND OR A PLASTICITY INDEX EXCEEDING 50% OR CONTAINS ROCK, GRAVEL OR OTHER PIECES WHOSE LEAST DIMENSION EXCEEDS 100MM, OR IS SILTY MATERIAL OR IS OTHERWISE CONSIDERED AS BEING UNSUITABLE

WHEN A SURFACE IS UNABLE TO SUPPORT CONSTRUCTION EQUIPMENT OR IT IS NOT POSSIBLE TO COMPACT THE OVERLYING MATERIALS BECAUSE OF HIGH MOISTURE CONTENT, THEN ONE OR MORE OF THE FOLLOWING ALTERIN RNATIVE

OVERLYING MATERIALS BECAUSE OF HIGH MOISTURE CONTENT, THEN ONE OR MORE OF THE FOLLOWING ALTERNATIVE ACTIONS MAY BE TAKEN. (I)ALLOW THE MATERIAL TO DRY TO A MOISTURE CONTENT WHICH ALLOW IT TO BE COMPACTED AND ALLOW THE PLACEMENT AND COMPACTION OF OVERLYING MATERIAL. (I)SCARIFY THE MATERIAL TO DEPTH OF ZOOMM AND WORK AS NECESSARY TO ACCELERATE DRYING RECOMPACT AS SPECIFIED WHEN MOISTURE CONTENT APPROXIMATES OPTIMUM SPECIFIED WHEN MOISTURE CONTENT APPROXIMATES OPTIMUM (III)EXCAVATE AND REPLACE THE SOFT MATERIAL THE ACTION TO BE ADOPTED SHALL BE AT THE CONTRACTOR'S DISCRETION AND EXPENSE, BUT SHALL BE ADVISED TO THE

SUPERINTENDENT BEFORE ACTION COMMENCES IF THE CONTRACTOR ELECTS PURSUANT TO (I) ABOVE TO ALLOW THE MATERIAL TO DRY, RESULTING DELAYS, IF ANY,

SHALL NOT CONSTITUTE GROUNDS FOR AN EXTENSION OF CONTRACT PERIOD OR DATE OF PRACTICAL COMPLETION THE FINISHED SUBGRADE SHALL NOT BE DISTURBED BY TRAFFIC OR OTHER OPERATIONS AND SHALL BE PROTECTED AND

HE FINISHED SUBGRADE STALL NOT DE DISTORDED OF THE TO STATE AS EN END AND THE SUBGRADE MAINTAINED BY THE CONTRACTOR UNTIL THE FIRST LAYER OF FILL OR SUB-BASE IS PLACED THEREON. THE SUBGRADE MAINTAINED BY THE CONTRACTOR OWNER THE FIRST LATER OF FILL OR SUB-BASE IS FURGED THEREOUNT THE SUBGRADE SHALL BE KEPT DRAINED AND COMPLETELY FREE OF STANDING WATER AT ALL TIMES THE CONTRACTOR SHALL PLAN AND CARRY OUT THE WHOLE OF THE WORKS TO MINIMUSE THE EFFECTS OF RUIN-OFF AND REOSION ON THE SITE AND DOWNSTREAM AREAS HE SHALL AVOID UNINECESSARY GROUND DISTURBANCE AND PROVIDE AS NECESSARY FOR THE PROPER CONTROL OF STORMWATER RUN-OFF AT EVERY STAGE OF THE WORKS.

PRIOR TO THE COMMENCEMENT OF EARTHWORKS TOPSOIL IS TO BE STRIPPED WITHIN THE LIMITS OF THE EARTHWORKS AND FROM ANY AREAS TO BE COVERED BY PAVING, STRUCTURES OR FILL AND ALL AREAS WHICH ARE TO SUPPORT PAVEMENTS, EMBANIKMENTS, STRUCTURES AND THE LIKE OR FILLING UNDER SUCH WORKS, SHALL BE STRIPPED CLEAR OF ALL TREES, LOGS, STUMPS, SCRUB, GRASS, ROOT GROWTH, CULTWATED SOIL, WET OR SPONGY NATURAL SOIL, DECAYED

VEGETABLE MATTER AND ANY OTHER DELETERIOUS SUBSTANCE. THE CONTRACTOR SHALL BREAK UP AND REMOVE ALL ASPHALT AND CONCRETE MATERIAL UPON WHICH FILL OR PAVEMENT SHALL BE PLACED. ALL MATERIAL WITHIN THE LIMIT OF THE EARTHWORKS SHALL BE WHOLLY REMOVED FILLALL HOLES WITH APPROVED MATERIAL IN MAXIMUM 150MM COMPACTED THICKNESS LAYERS COMPACTED TO THE

TY TO THE ADJOINING UNDISTURBED SOIL AND TO THE APPROVAL OF THE SUPERINTENDENT

HAVE INCLUDED IN THE CONTRACT SUM FOR ALL ACTIVITIES REQUIRED FOR UNSTABLE AREA RECTIFICATION INCLUDING THE DELIVERY, PLACING AND COMPACTING OF APPROVED MATERIAL AS WELL AS THE EXCAVATION AND DISPOSAL OF REPLACED MATERIAL

EXCAVATION TO THE LINES LEVELS AND GRADES AS REQUIRED FOR UNDERGROUND SERVICES SPECIFIED IN THE EXCAVATION TO THE LINES, LEVELS AND GRADES AS REQUIRED FOR UNDERGROUND SERVICES SPECIFIED IN THE RELEVANT SERVICES SECTIONS, INCLUDING DRAINAGE, HYDRAULIC, ELECTRICAL AND THE LIKE UNLESS OTHERWISE SPECIFIED MAKE THE TRENCHES STRAIGHT BETWEEN MANHOLES, INSPECTION POINTS, JUNCTIONS AND THE LIKE, WITH VERTICAL SUBS AND UNFORM GRADES DEPTH SHALL BE AS REQUIRED BY THE RELEVANT SERVICES AND ITS BEDDING CUT BACK ROOTS ENCOUNTERED IN THENCHES TO LESS THAN 800MM CLEAR OF THE RELEVANT SERVICE REMOVE SUCH OTHER OBSTRUCTIONS INCLUDING ROOT, SZIVMPS, BOULDERS AND THE LIKE WHICH MAY, IN THE OPINION OF THE SUPERINTENDENT, INTERFERE WITH THE PROPER FUNCTIONING OF THE SERVICE SECTION SECTION LAY AND RED SERVICES IN A COORDANCE WITH THE REI FUNCTIONING OF THE SERVICE SECTION SECTION

LAY AND BED SERVICES IN ACCORDANCE WITH THE RELEVANT SERVICES SPECIFICATION SECTION

BACKFILL AND COMPACT SERVICE TRENCHES AS SOON AS POSSIBLE AFTER APPROVAL OF LAID AND BEDDED SERVICE COMPACT BACKFILL IN PIPE TRENCHES SO THAT THE PIPE IS BUTTRESSED BY THE WALLS OF THE TRENCH

UN WHERE FILLING IS DESIGNATED BY THE CONTRACT OR IS SHOWN ON THE DRAWINGS AS STRUCTURAL OR CONTROLLED FILL THE CONTRACTOR SHALL ENGAGE AN INDEPENDENT GEOTECHNICAL TESTING AUTHORITY TO SUPERVISE SUBGRADE PREPARATION, FILL PLACEMENT, COMPACTION AND TO UNDERTAKE SAMPLING AND TESTING AND REPORTING TO SATISFY THE REQUIREMENTS OF THIS SPECIFICATION AND THOSE OF AS 2870 AND AS 3798, FOR CONTROLLED FILL

NO FILL SHALL BE PLACED OVER LAYERS NOT TESTED AND HAVING SATISFACTORY RESULTS WHERE EXCAVATED MATERIAL IS NOT SUITABLE FOR FILLING, FILL MATERIAL, AS SPECIFIED IN THIS SPECIFICATION SECTION, "IMPORTED FILL" SHALL BE USED

SUITABLE MATERIAL EXCAVATED FROM THE SITE MAY BE USED AS FILL ONLY WHERE APPROVED IN WRITING BY THE SUPERINTENDENT. OR WHERE SHOWN ON THE DRAWINGS COMPACT IMPORTED BULK FILL IN LAYERS OF 150MM MAXIMUM COMPACTED DEPTH AND AT OPTIMUM MOISTURE

CONTENT THE CONTRACTOR SHALL CARRY OUT TESTING AT A FREQUENCY WHICH IS SUFFICIENT TO ENSURE THAT THE MATERIALS AND WORK SUPPLIED UNDER THE CONTRACT COMPLIES WITH THE SPECIFIED REQUIREMENTS AND CONFORMING TO THE "MINIMUM FREQUENCY OF TESTING FOR MATERIAL DESCRIPTIONS" TABLE AND "GUIDELINES FOR MINIMUM FREQUENCY OF FIELD DENSITY TEST," TABLE OF AS 3788

UNLESS OTHERWISE PERMITTED, NO FILLING SHALL BE PLACED AGAINST ANY STRUCTURES, WING WALLS OR RETAINING WALLS WITHIN FOURTEEN DAYS OF CASTING. STRUT WALLS AS NECESSARY TO PREVENT MOVEMENT DURING PLACING AND PLACE AND COMPACT FILLING OVER AND AROUND PIPES, CULVERTS, BRIDGES AND OTHER STRUCTURES SO AS TO AVOID

UNBALANCED LOADING OR MOVEMENT UNBALANCED LOADING OR MOVEMENT UNLESS OTHERWISE DETAILED BACKFILL AT STRUCTURES SHALL BE FILLED AS FOLLOWS WHERE THE GAP BETWEEN THE STRUCTURE AND UNDISTURBED GROUND EXCEEDS 2M, BACKFILL THE ZONE WITHIN 2M OF THE STRUCTURE WITH CLASS 3 FINE CRUSHED ROCK AND BACKFILL IN THE ZONE BEYOND 2M OF THE STRUCTURE WITH SELECT FILL TO THE APPROVAL OF THE SUPERINTENDENT OR CLASS 3 FINE CRUSHED ROCK.

UNLESS OTHERWISE DETAILED, MATERIAL WITHIN 300MM OF WEEPHOLES SHALL BE AN APPROVED GRANULAR FILTER MEDIUM OF COARSE SAND OR CRUSHED STONE WRAPPED AND SURROUNDED WITH AN APPROVED GEOTEXTILE SEPARATION LAYER

HORIZONTAL NO POINT SHALL BE GREATER THAN + OR - 100MM FROM THE DESIGN LOCATION.

NO POINT SHALL BE GREATER T VERTICAL: SUBGRADE LEVEL: +0, -25MM PAVEMENT DESIGN SUBGRADE LEVEL: +0, -25MM OTHER: +50, -50MM OTHER: +50, -50MM

F13

STRAIGHTNESS (EXCLUDES ROCK): MAXIMUM 20MM DEPARTURE FROM 3M STRAIGHT EDGE LAID.

PARALLEL TO ROAD CENTRE LINE NORMAL TO INTENDED CONTOURS

AREAS UPON WHICH FILLS ARE TO BE CONSTRUCTED, ALL LAYERS OF FILLING, AND MATERIALS LESS THAN 150MM BELOW PERMANENT SUBGRADE LEVEL IN CUTTINGS, SHALL BE COMPACTED SO AS TO BE CAPABLE OF WITHSTANDING TEST ROLLII WITHOUT VISIBLE DEFORMATION OR SPRINGING, WITH A PNEUMATIC TYRED ROLLER OR HIGHWAY TRUCK BALLASTED TO

COMPLY WITH THE FOLLOWING. PHEUMATIC TYMED- NOT LESS THAN 3 T PER TYRE WITH TYRES INFLATED TO 550 KPA. HIGHWAY TRUCK - WITH REAR AXLE OR AXLES LOADED TO NOT LESS THAN 8 T EACH WITH TYRES INFLATED TO 550 KPA TEST ROLLING SHALL BE CARRIED OUT IMMEDIATELY BEFORE OVERLYING LAYRES ARE PLACED WHERE TEST ROLLING IS REQUIRED AT SOME LATER DATE, THE SURFACE SHALL BE MOISTURE CONDITIONED AS REQUIRED AND GIVEN NOT LESS THAN FOUR COVERAGES OF THE TEST ROLLER BEFORE TEST ROLLING COMMENCES

THE WORK SHALL NOT BE ACCEPTED AS COMPLETE UNLESS ALL TEST RESULTS ARE PROVIDED TO THE SUPERINTENDENT THE CONTRACTOR SHALL PROVIDE ALL MATERIAL PROPERTY AND QUALITY TEST RESULTS TO THE SUPERINTENDENT

#### CIVII

THE CONTRACTOR SHALL LIAISE DIRECTLY WITH ALL SERVICE AUTHORITIES INVOLVED AND SHALL COMPLY WITH ALL THEIR REGULATIONS AND REQUIREMENTS

ALL LEVELS SHOWN ARE TO AUSTRALIAN HEIGHT DATUM, UNLESS STATED OTHERWISE. ALL COORDINATES SHOWN ARE TO AUSTRALIAN MAP GRID. UNLESS STATED OTHERWISE

SERVICE INFORMATION SHOWN IS BASED ON PLANS SUPPLIED AND IS APPROXIMATE ONLY ACTUAL LOCATION CAN ONLY RE DETERMINED BY EXCAVATION. THE CONTRACTOR SHALL LIAISE WITH SERVICE AUTHORITIES FOR SERVICE LOCATIONS. THE CONTRACTOR SHALL PROTECT ALL SERVICES AND SHALL RECTIFY ANY DAMAGE AT HIS EXPENSE

CH ALL WORKS IN PUBLIC LANDS SHALL BE TO THE APPROVAL AND SATISFACTION OF THE RELEVANT AUTHORITY. THE CONTRACTOR SHALL BE RESPONSIBLE FOR OBTAINING ALL PERMITS AND OBTAINING RELEVANT AUTHORITY WRITTEN APPROVAL OF THE WORKS

EXISTING SURFACE CONTOURS SHOWN ARE INTERPOLATED FROM SPOT HEIGHTS AND ARE APPROXIMATE ONLY

UNLESS OTHERWISE NOTED ALL VEGETATION SHALL BE STRIPPED TO A MINIMUM DEPTH OF ???MM UNDER ALL PAVEMENT AND BUILDING AREAS

PRIOR TO PLACEMENT OF ANY FILLS, PAVEMENT OR BUILDINGS. THE EXPOSED SUB-GRADE SHALL BE COMPACTED TO THE SPECIFIED STANDARD MAINUM DRY DENSITY FOR THE DEPTH SPECIFIED, MY SOFT SPOTS SHALL BE REMOVED AND REPLACED WITH APPROVED FILL AND COMPACTED AS SPECIFIED SUBGRADE SHALL BE PROOF ROLLED, AS SPECIFIED

LI FILL REQUIRED SHALL BE APPROVED FILL MATERIAL AND SHALL BE COMPACTED IN 150MM MAXIMUM COMPACTED HICKNESS LAYERS TO THE DENSITIES SPECIFIED, UNLESS SHOWN OTHERWISE ON THE DRAWINGS

HE CONTRACTOR SHALL KEEP THE SITE WELL DRAINED AND COMPLETELY FREE OF STANDING WATER AT ALL TIMES

GRADE EVENLY BETWEEN FINISHED SURFACE SPOT LEVELS. (FINISHED SURFACE CONTOURS ARE SHOWN FOR CLARITY ONLY.) WHERE FINISHED SURFACE SPOT LEVELS ARE NOT SHOWN THE SURFACE SHALL BE GRADED SMOOTHLY SO THAT IT WILL DRAIN FREELY, AND TO MATCH THE LEVELS OF ADJACENT SURFACES OR STRUCTURES

DOWNPIPES SHALL BE CONNECTED TO PITS OR STORMWATER PIPES WITH EARTHENWARE OR SEWER CLASS PVC PIPES DOMMETER SINDICATED BY DOWNPIPE SIZE ON ARCHITECTURAL OR ENGINEERING DRAWINGS) AT A MINIMUM GRADE O 11/100, MINIMUM 300MM COVER, UNLESS OTHERWISE SHOWN.

L CONCRETE STORMWATER PIPES SHALL BE CLASS 2 WITH RUBBER RING JOINTS IN ACCORDANCE WITH A.S 4058, OR A.S.4139

ALL PVC STORMWATER PIPES SHALL BE SEWER GRADE IN ACCORDANCE WITH A S.1260.

ALL DIMENSIONS AND SET OUTS SHOWN ARE FITHER TO FACE OF BUILDING, GRID LINES OR FACE OF KERB INVERT (LINE OF KERB), UNLESS SHOWN OTHERWISE C15

CONTRACTOR SHALL BE ISSUED AN ELECTRONIC COPY OF THE CIVIL DETAIL PLANS IN AUTOCAD DWG FORMAT FOR SET OUT PURPOSES. ALL DIMENSIONS SHOWN ON PLAN SHALL OVER RIDE SET OUT POINTS SELECTED FROM ELECTRONIC FILE PROVIDED

ALL CUT BATTERS TO BE 1VIN IH UNLESS OTHERWISE NOTED. ALL FILL BATTERS TO BE 1VIN IH UNLESS OTHERWISE NOTED

ALL SURFACE DAMAGED DUE TO CONSTRUCTION WORK SHALL BE REINSTATED TO THE SATISFACTION OF THE SUPERINTENDENT

C18 SAWCUT EXISTING KERB/KERB & CHANNEL AND PAVING WHERE NEW WORKS ARE TO MATCH EXISTING WORKS

BUILDING AND SITE MAINTENANCE PROGRAM IS TO INCORPORATE REGULAR FLUSHING OF ALL STORMWATER PITS, PIPES, DOWNPIPES, SUB-SOIL DRAINS AND ASSOCIATED FITTINGS TO AVOID BLOCKAGES WITHIN THE SYSTEM,

A DETAIL LEVEL AND FEATURE SURVEY HAS BEEN UNDERTAKEN FOR THIS SITE BY: NIPROVICH & ASSOCIATES PTY LTD REF NO.07\_113A DATE: 07/05/2002

diers Ave Wilson St

Surfers Parade

Motherpedia

Lawrence St TR 11

OF

PIT COVERS SHALL BE PLACED IN ACCORDANCE WITH THE DETAIL SITE PLANS AND PIT SCHEDULE (IF PROVIDED) IN REGARD TO TYPE SIZE LOCATION AND LEVEL THE BASE OF EACH PIT SHALL BE INFILLED AND SHAPED WITH CONCRETE OR CEMENT MORTAR TO PROVIDE A


SUPEL REPARTATION AND MATERIALS INCLESSARY FOR, AND CARRY OUT THE TESTS REQUIRED BY THE SPECIFICATION OR REGULATORY AUTHORITIES, IN THE PRESENCE OF THE SUPERINTENDENT AND THE AUTHORITY LEAVE PIPE JOINTS EXPOSED TO ENABLE OBSERVATION DURING THE TESTS. ENSURE PVC SOLVENT CEMENT JOINTS HAVE BEEN CURED FOR AT LEAST 24 HOURS BEFORE TESTING

### **DIAL** 1100 BEFORE YOU DIG


#### WARNING


CATIONS OF UNDERGROUND S ARE APPROXIMATE ONLY AM

COVER SHEET, GENERAL NOTES & INDEX

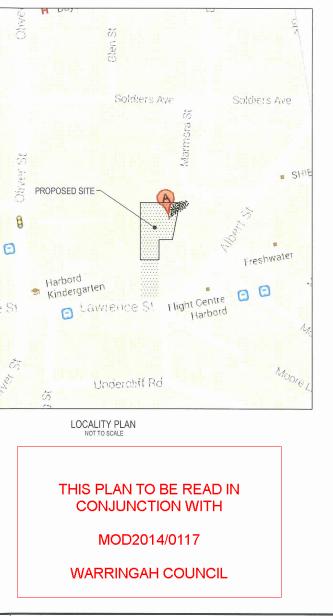


OJECT	HARBORD	NORTH
	18 MARMORA STREET HARBORD, NSW	
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PROJECT	HARBORD 18 MARMORA STREET HARBORD, NSW		NORTH
TITLE	OSD TANK 2 AND DETAILS	PROJECT No DRAWING No 111927-00-MIE150	<sup>REV</sup>

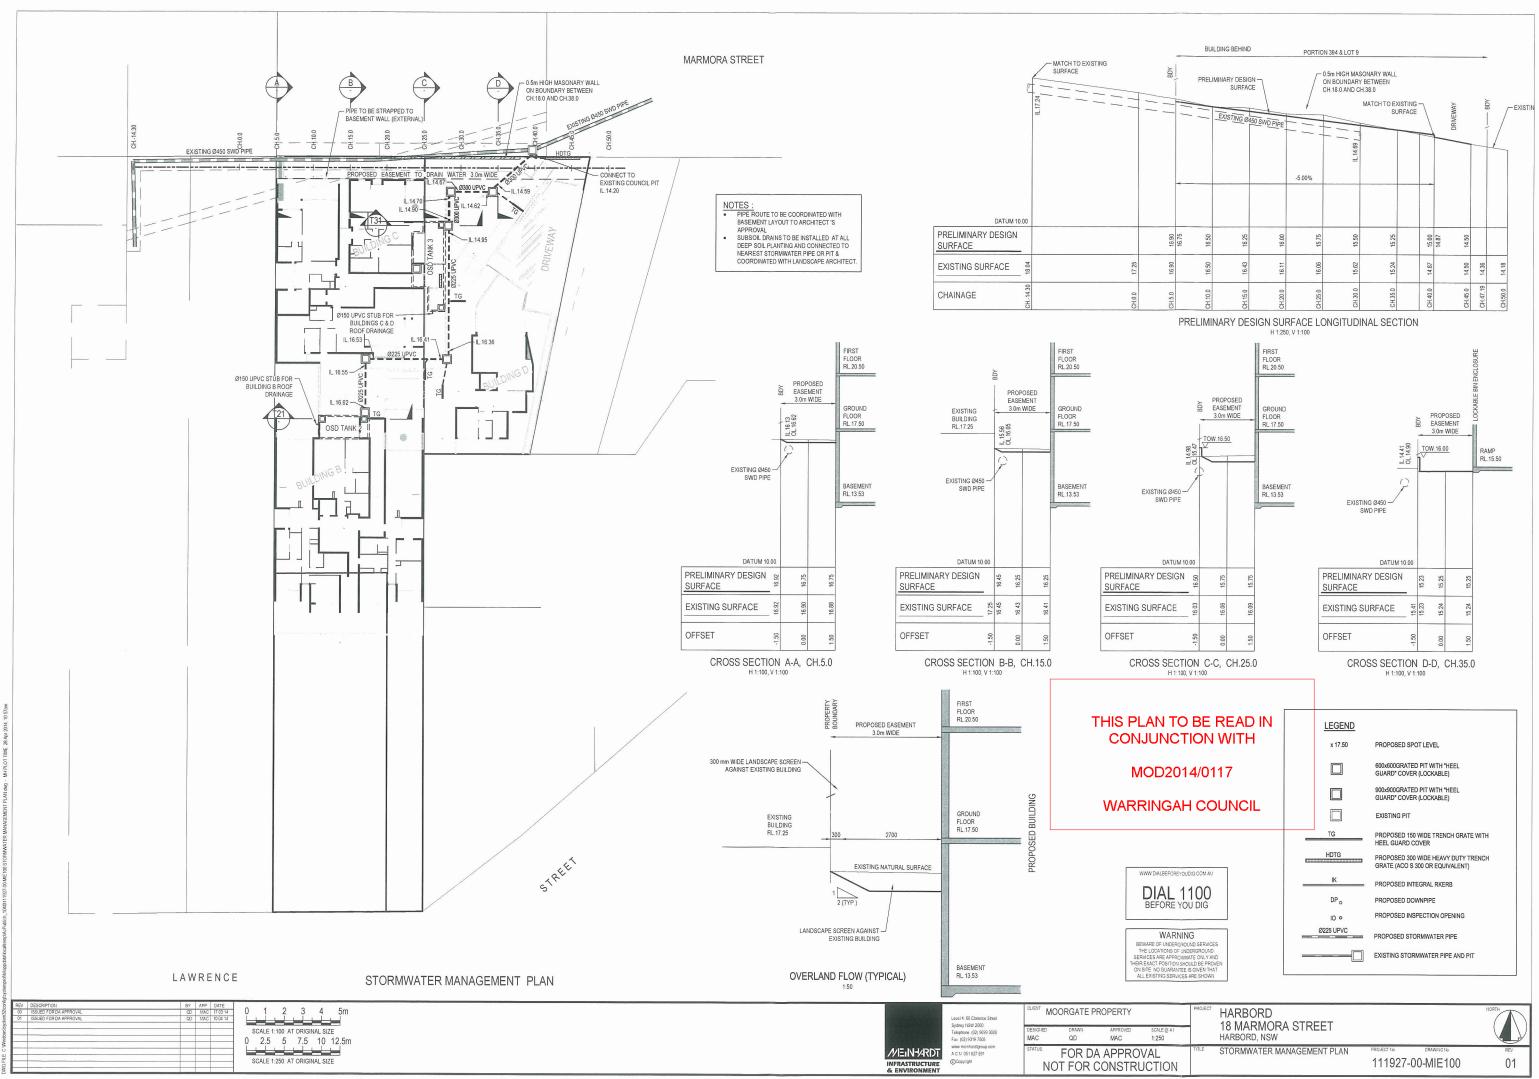

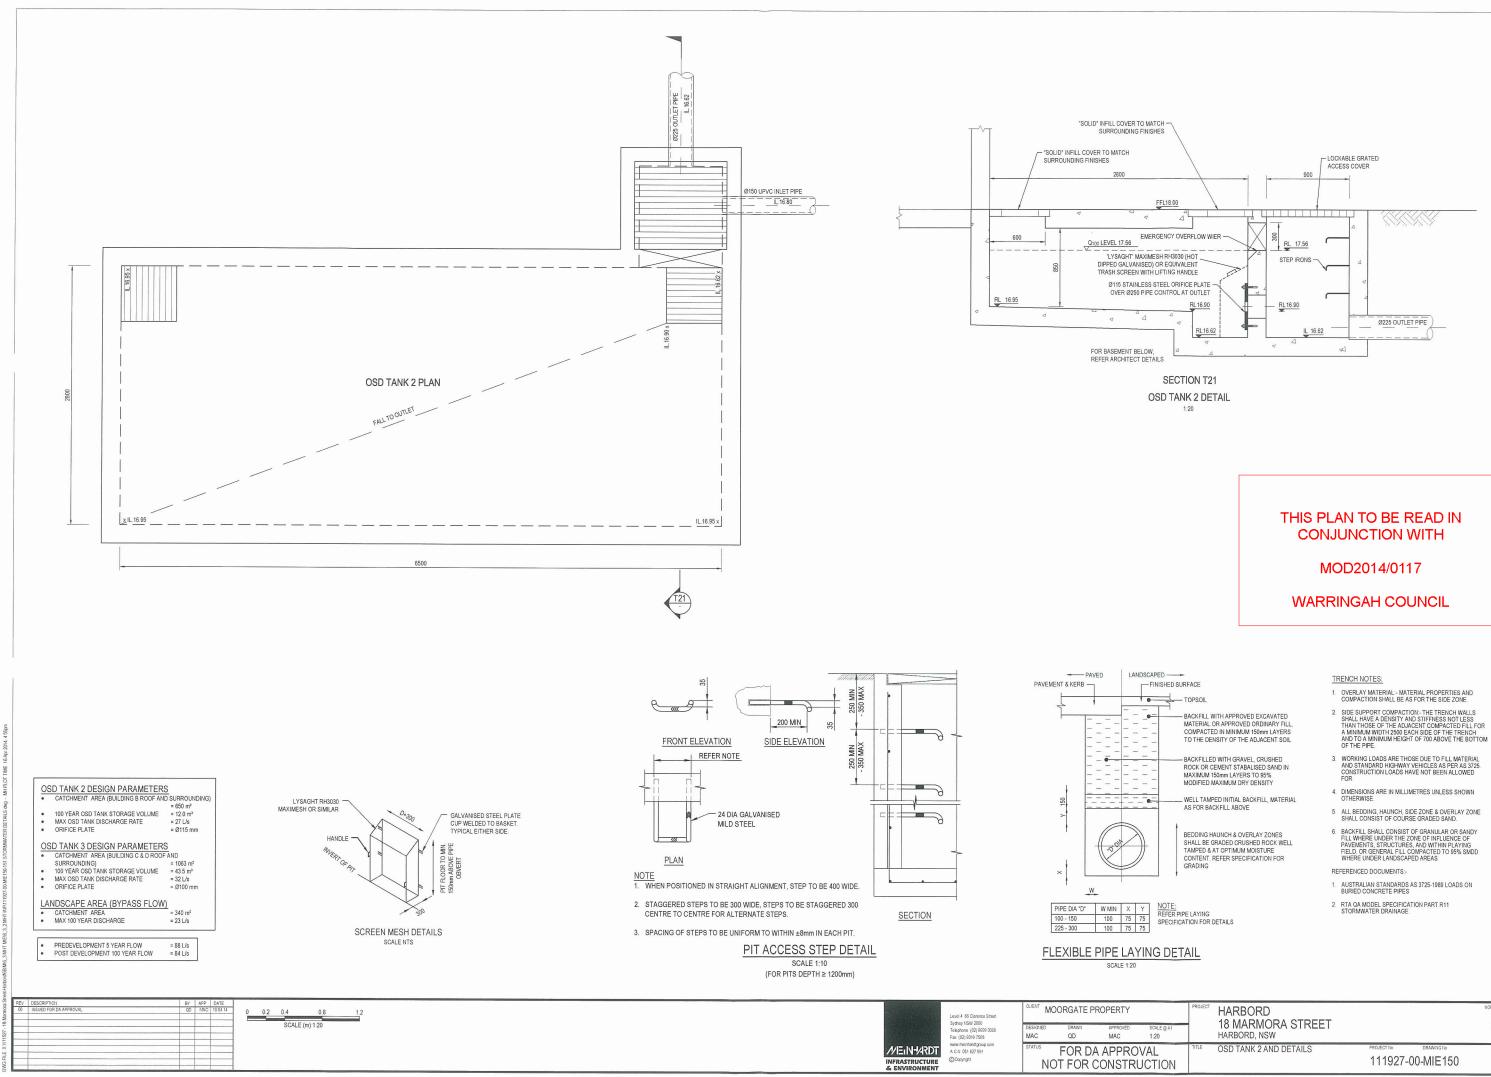
#### THIS PLAN TO BE READ IN CONJUNCTION WITH

#### MOD2014/0117
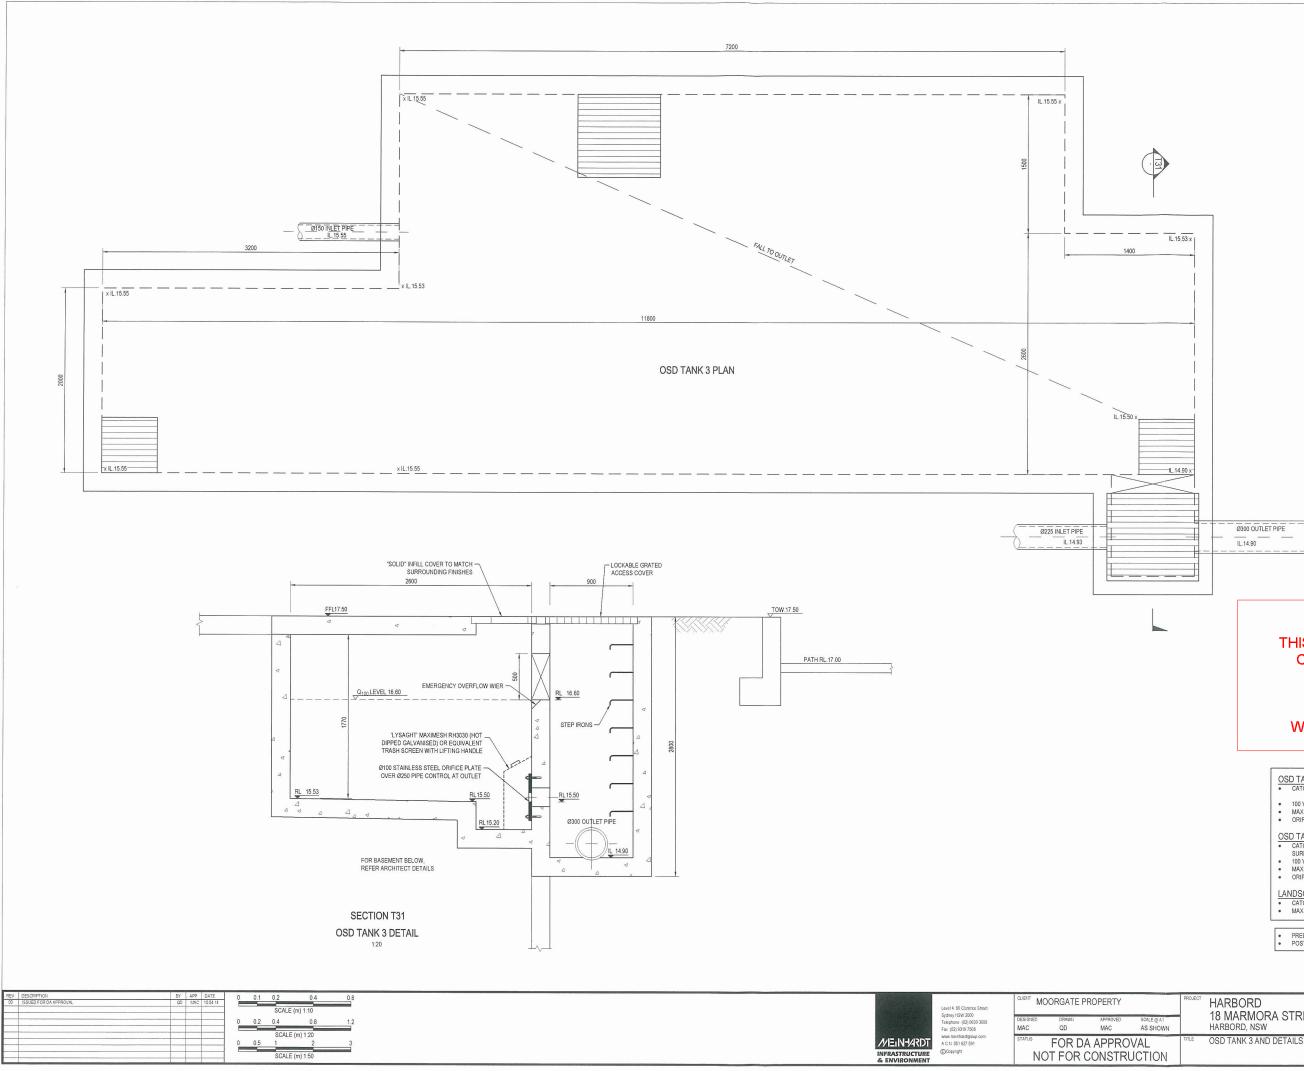
#### WARRINGAH COUNCIL

	CATCHMENT AREA (BUILDING B ROOF AND	= 650 m <sup>2</sup>
•	100 YEAR OSD TANK STORAGE VOLUME	= 12.0 m <sup>3</sup>
•	MAX OSD TANK DISCHARGE RATE	= 27 L/s
•	ORIFICE PLATE	= Ø115 mm
08	SD TANK 3 DESIGN PARAMETERS	5
•	CATCHMENT AREA (BUILDING C & D ROOF	AND
	SURROUNDING)	= 1063 m <sup>2</sup>
٠	100 YEAR OSD TANK STORAGE VOLUME	= 43.5 m <sup>3</sup>
•	MAX OSD TANK DISCHARGE RATE	= 32 L/s
•	ORIFICE PLATE	= Ø100 mm
LA	NDSCAPE AREA (BYPASS FLOW)	
	CATCHMENT AREA	= 340 m <sup>2</sup>
•	MAX 100 YEAR DISCHARGE	= 23 L/s
_		- 99 1 /a
<u>.</u>		
	PREDEVELOPMENT 5 YEAR FLOW POST DEVELOPMENT 100 YEAR FLOW	

PROJECT	HARBORD 18 MARMORA STREET HARBORD, NSW		NORTH
TITLE	OSD TANK 3 AND DETAILS	PROJECT No DRAWING No 111927-00-MIE151	REV 00

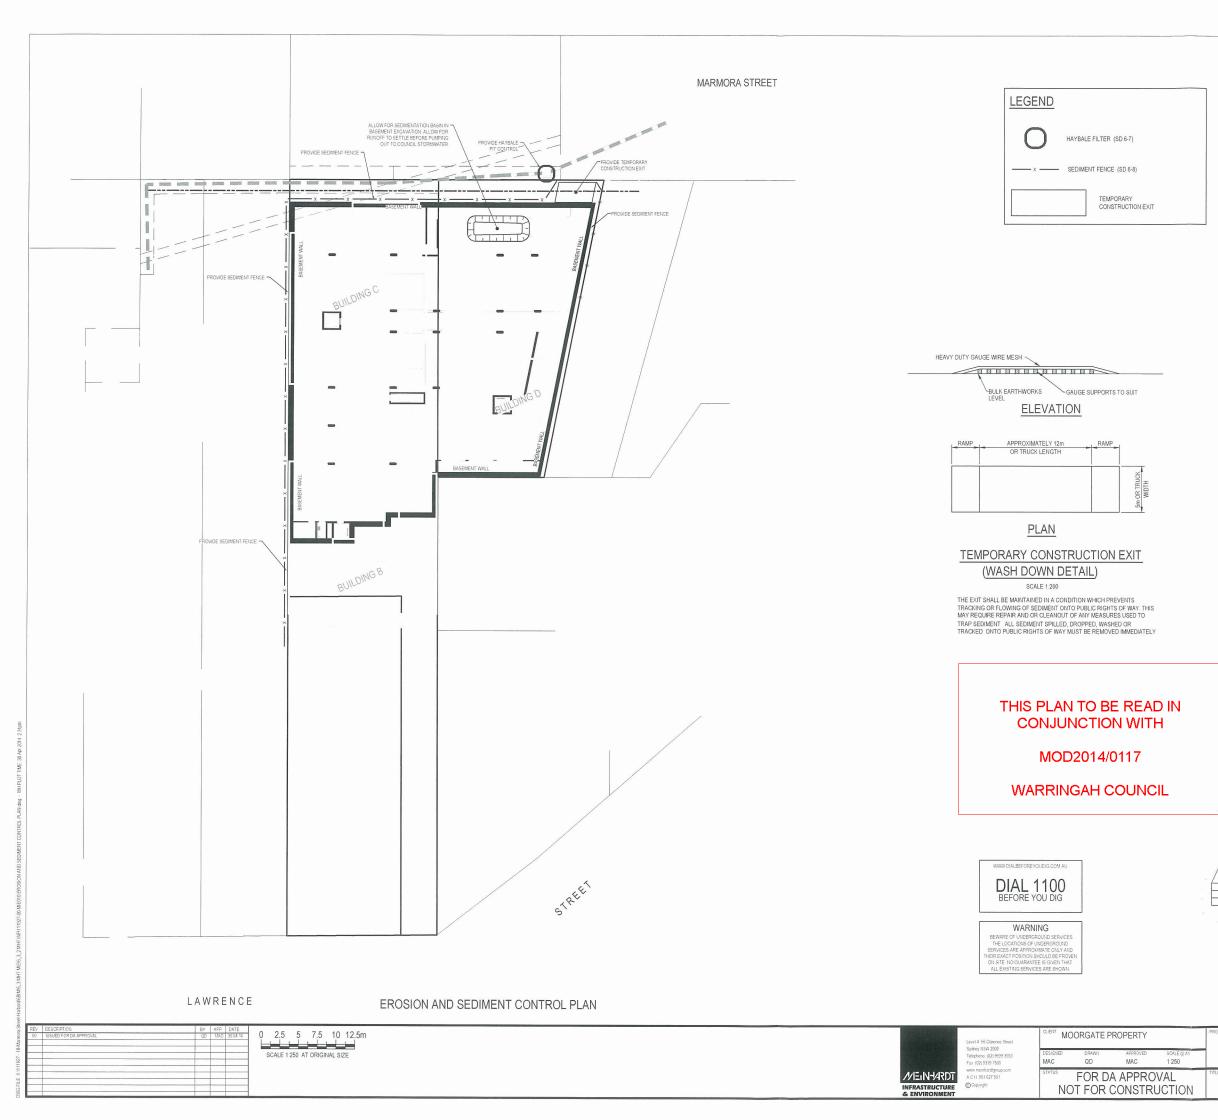

#### EROSION AND SEDIMENT CONTROLS

- ES1 ALL WORK SHALL BE GENERALLY CARRIED OUT IN ACCORDANCE WITH (A) LOCAL AUTHORITY REQUIREMENTS
- (B) APPLICABLE POLLUTION CONTROL MANUAL FOR URBAN STORMWATER
- (C) DEPARTMENT OF CONSERVATION AND LAND MANAGEMENT MANUAL- "URBAN EROSION & SEDIMENT CONTROL"
- (D) NSW PROTECTION OF THE ENVIRONMENT ACT 1997
- ES2 THE CONTRACTOR SHALL PREPARE EROSION AND SEDIMENT CONTROL DRAWINGS AND NOTES FOR THE WHOLE OF THE WORKS SHOULD THE CONTRACTOR STAGE THESE WORKS THEN THE DESIGN MAY REQUIRE TO BE MODIFIED VARIATION TO THESE DETAILS MAY REQUIRE TO BE APPROVED BY THE RELEVANT AUTHORITIES THE EROSION AND SEDIMENT CONTROL PLAN SHALL BE IMPLEMENTED AND ADOPTED TO MEET THE VARYING SITUATIONS AS WORK ON SITE PROGRESSES
- ES3 MAINTAIN ALL EROSION AND SEDIMENT CONTROL DEVICES TO THE SATISFACTION OF THE SUPERINTENDENT AND THE LOCAL AUTHORITY AS APPROPRIATE (IE PRIVATE / PUBLIC LAND)
- ES4 AS STORMWATER PITS ARE CONSTRUCTED PREVENT SITE RUNOFF ENTERING. ERECT SILT FENCES AROUND PITS
- ES5 MINIMISE THE AREA OF SITE DISTURBED AT ANY ONE TIME.
- ES6 PROTECT ALL STOCKPILES OF MATERIALS FROM SCOUR AND EROSION. DO NOT STOCKPILE LOOSE MATERIAL IN ROADWAYS, NEAR DRAINAGE PITS OR IN WATERCOURSES.
- ES7 ALL SOIL AND WATER CONTROL MEASURES ARE TO BE PUT BACK IN PLACE AT THE END OF EACH WORKING DAY, AND MODIFIED TO BEST SUIT SITE CONDITIONS
- ES8 CONTROL WATER FROM UPSTREAM OF THE SITE SO THAT IT DOES NOT ENTER THE DISTURBED SITE.
- ES9 ALL CONSTRUCTION VEHICLES SHALL ENTER AND EXIT THE SITE VIA THE AGREED TEMPORARY CONSTRUCTION ENTRY/EXIT
- ES10 ALL VEHICLES ASSOCIATED WITH CIVIL WORKS SHALL BE CLEANED AND INSPECTED BY THE CONTRACTOR BEFORE LEAVING THE SITE
- ES11 MAINTAIN ALL STORMWATER PIPES AND PITS CLEAR OF DEBRIS AND SEDIMENT. THE CONTRACTOR SHALL INSPECT STORMWATER SYSTEM AND CLEAN OUT AFTER EACH STORM EVENT AND / OR WHEN DIRECTED
- ES12 THE CONTRACTOR SHALL CLEAN OUT ALL EROSION AND SEDIMENT CONTROL DEVICES AFTER EACH STORM EVENT
- ES13 SETTLEMENT OF DISPERSED FINES IN WET BASIN AFTER EVERY STORM EVENT THE COLLECTED RUNOFF IS TO BE TREATED WITH AN APPROVED FLOCCULANT TO REDUCE THE SUSPENDED SOLIDS TO LESS THAN Somg/L AND PUMPED TO AN APPROVED OUTLET AS DIRECTED BY THE SUPERINTENDENT.

