

SITE / ROOF / SEDIMENT EROSION / WASTE MANAGEMENT / STORMWATER CONCEPT PLAN



	REV.	DATE	COMMENTS	DRWN	NOTES	LEGEND	CLIENT	DRAWIN
ON PLANS	А	08.07.2022	DA SUBMISSION	SC	This drawing is the copyright of Action Plans and not be altered, reproduced or transmitted in any form or by any means in part or in whole with the written permission of Action Plans.	EXISTING	TRUDI & MATTHEW	DA0
					Do not scale measure from drawings. Figured dimensions are to be used only. The Builder/contractor/owner is to ensure that the approved boundary setbacks and	PROPOSED	PIKE	DAU
7 518 s@actionplans.com.au					approved levels are confirmed and set out by a registered Surveyor prior to construction, the boundary setbacks take precedence over all other dimensions. The Builder/Contractor shall check and verify ALL dimensions on site prior to	– – – DEMOLISHED	PROJECT ADDRESS	DATE
ionplans.com.au					commencement of any work, creation of shop drawings, or fabrication of components. All errors and omissions are to be verified by the Builder/Contractor/client and referred to the designer prior to the commencement of works.	PROP. RL	9 ALEXANDER STREET COLLAROY NSW 2097	Thursday 2022

*	NOTES REGARDING BOUNDARY THE INFORMATION SHOWN ON THIS PLAN IS FOR DESIGN PURPOSES ONLY. THE POSITION OF BOUNDARY LINES HAVE BEEN ESTABLISHED BY A SURVEY TO MEET THE IDENTIFICATION REQUIREMENTS FOR COUNCIL AND NOT FOR REGISTRATION WITH THE LAND REGISTRATION SERVICES NSW NOR MAY THIS PLAN BE USED FOR ANY OTHER PURPOSE. SUBSEQUENT REGISTERED OR OTHER SURVEYS MAY AFFECT THE DEFINED BOUNDARY POSITIONS IN THIS AREA. ANY DIFFERENCES OF THIS NATURE ARE BEYOND THE PURPOSES OF THIS PLAN. THIS PLAN IS FOR THE ABOVE STATED PURPOSES ONLY. RESTRICTIONS ON THE TITLE HAVE NOT BEEN INVESTIGATED. IF FURTHER DEVELOPMENT IS CONTEMPLATED OR CONSTRUCTION INTENDED THEN IT IS IMPORTANT THAT A SURVEY SET OUT IS CARRIED OUT.
	DUST CONTROL : TO REDUCE DUST GENERATED BY WIND ACTION, THE REMOVAL OF THE TOP SOIL IS TO BE MINIMISED. TO PREVENT DUST GENERATION, WATERING DOWN OF THE SITE, ESPECIALLY DURING THE MOVEMENT OF MACHINERY IS REQUIRED. WHERE EXCAVATING INTO ROCK, KEEP THE SURFACE MOIST TO MINIMISE DUST. CONSTRUCT A GRAVEL ENTRY/EXIT POINT USING BLUE METAL AND RESTRICT ALL VEHICLE MOVEMENTS WITHIN THE SITE TO A MINIMUM. ENSURE WIND BREAKS, SUCH AS EXISTING FENCES ARE MAINTAINED DURING THE CONSTRUCTION PHASE UNTIL NEW LANDSCAPING IS PROVIDED OR REINSTATED. PREVENT DUST BY COVERING STOCKPILES
	SEDIMENT NOTE : 1. ALL EROSION AND SEDIMENT CONTROL MEASURES TO BE INSPECTED AND MAINTAINED DAILY BY THE SITE MANAGER. 2. MINIMISE DISTURBED AREAS, REMOVE EXCESS SOIL FROM EXCAVATEDAREA AS SOON AS POSSIBLE. 3. ALL MATERIAL STOCKPILE TO BE CLEAR FROM DRAINS, GUTTERS AND FOOTPATHS, OR WITHIN SEDIMENT FENCE AREA. 4. DRAINAGE TO BE CONNECTED TO STORMWATER AS SOON AS POSSIBLE. IF STORED ON SITE, IT MUST BE FILTERED BEFORE RELEASING INTO STORMWATER SYSTEM OR WATERWAYS. 5. ROADS AND FOOTPATHS TO BE SWEPT DAILY.
IN PMENT	STOCKPILES : ALL STOCKPILES ARE TO BE KEPT ON-SITE WHERE POSSIBLE. ANY MATERIALS PLACED ON THE FOOTPATHS OR NATURE STRIPS REQUIRE COUNCIL'S PERMISSION. ALL STOCKPILES ARE TO BE PLACED AWAY FROM THE DRAINAGE LINES AND STREET GUTTERS. IT IS BEST TO LOCATE THESE ON THE HIGHEST PART OF THE SITE IF POSSIBLE. PLACE WATERPROOF COVERING OVER STOCKPILES. IF REQUIRED PROVIDE DIVERSION DRAIN & BANK AROUND STOCKPILES.
ITE WORKS.	GUTTER PROTECTION : PROVIDE PROTECTION TO DOWNHILL GRATE IN GUTTER BY MEANS OF SAND BAGS OR BLUE METAL WRAPPED IN GEOTEXTILE FABRIC. WHEN SOIL OR SAND BUILDS UP AROUND THIS SEDIMENT BARRIER, THE MATERIAL SHOULD BE RELOCATED BACK TO THE SITE FOR DISPOSAL.
	NOTE: ALL PROPOSED STORMWATER TO CONNECT WITH EXISTING

WING NO.


DRAWING NAME

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SITE / ROOF / SEDIMENT EROSION / WASTE MANAGEMENT / STORMWATER CONCEPT PLAN SCALE

sday, 13 October

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PROPOSED LOWER GROUND FLOOR

		REV.	. DATE	COMMENTS	DRWN	NOTES	LEGEND	CLIENT	DRAWING NO
	ACTION PLANS	A	08.07.2022	DA SUBMISSION	SC	This drawing is the copyright of Action Plans and not be altered, reproduced or transmitted in any form or by any means in part or in whole with the written permission of Action Plans.	EXISTING	TRUDI & MATTHEW	
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	m: 0426 957 518					approved levels are confirmed and set out by a registered Surveyor prior to construction, the boundary setbacks take precedence over all other dimensions.	DEMOLISHED	PROJECT ADDRESS	DATE
	e:operations@actionplans.com.au w: www.actionplans.com.au			The Builder/Contractor shall check and verify ALL dimensions on site prior commencement of any work, creation of shop drawings, or fabrication of component	The Builder/Contractor shall check and verify ALL dimensions on site prior to commencement of any work, creation of shop drawings, or fabrication of components.	9 ALEXANDER STREET	Thursday, 13 (
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ING NO.

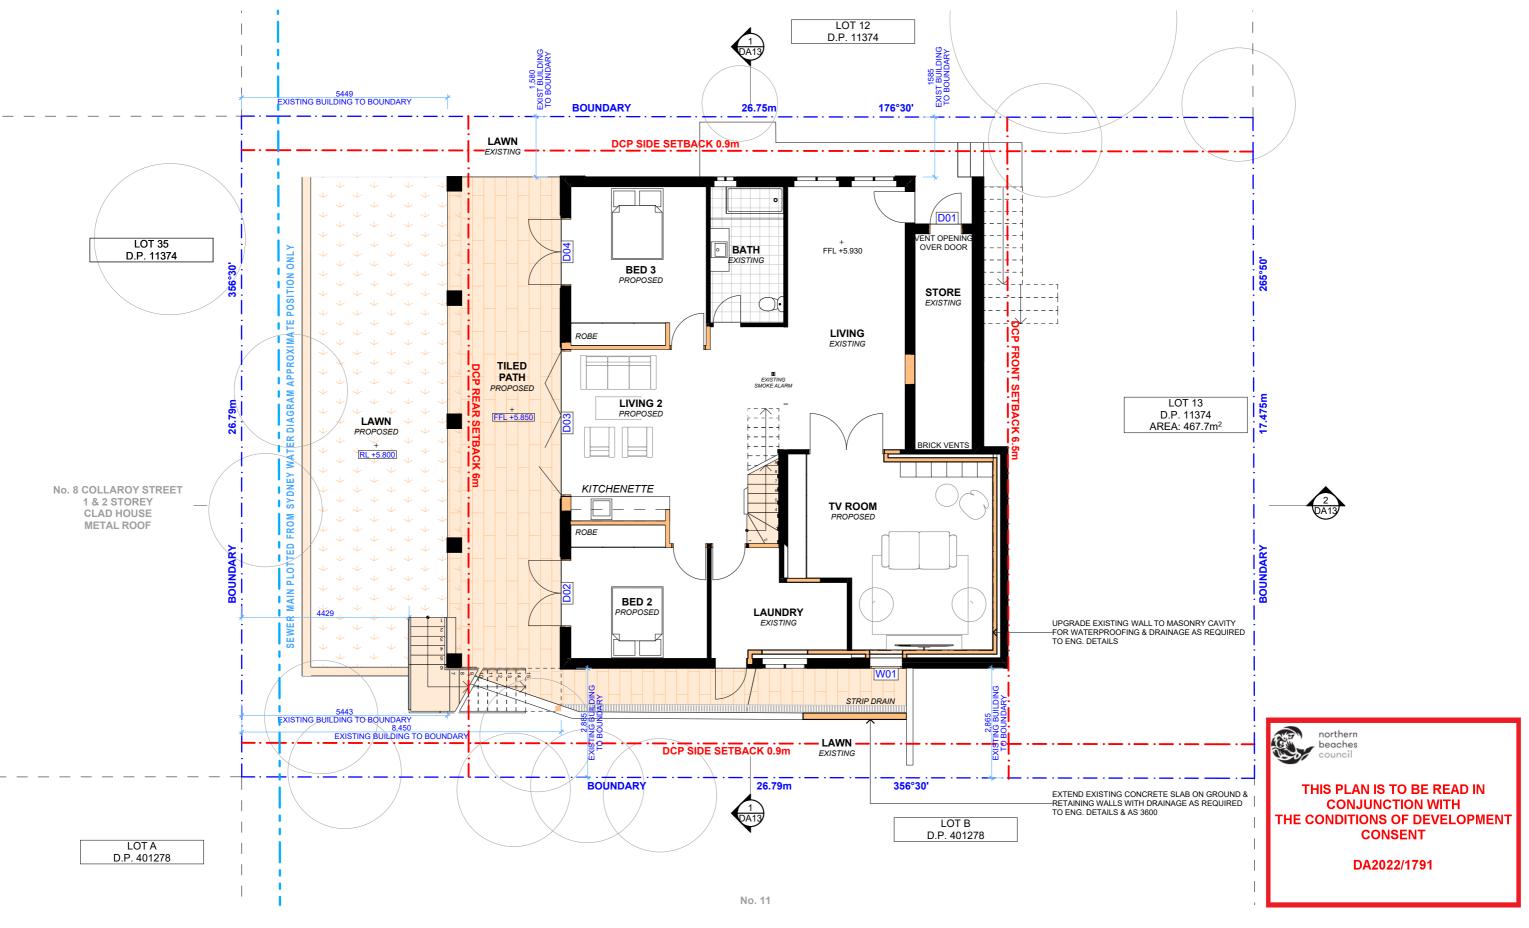DRAWING NAME


PROPOSED LOWER GROUND FLOOR PLAN




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SCALE



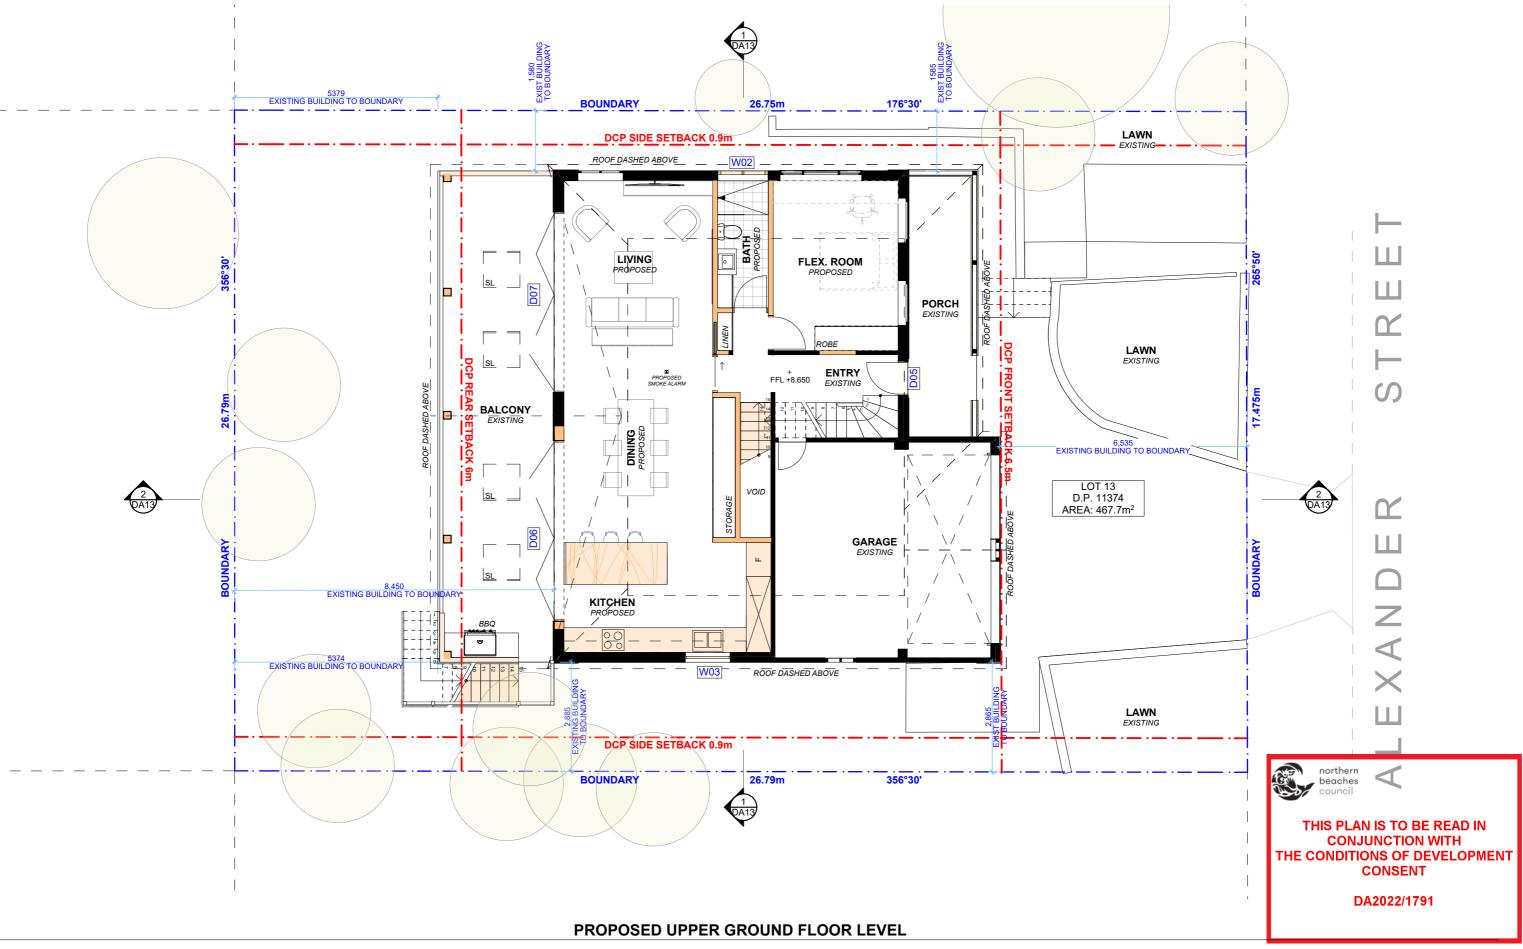


DRAWING NAME

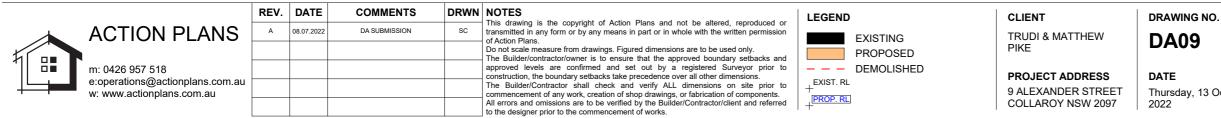PROPOSED GROUND FLOOR PLAN



Thursday, 13 October


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PROP. RL
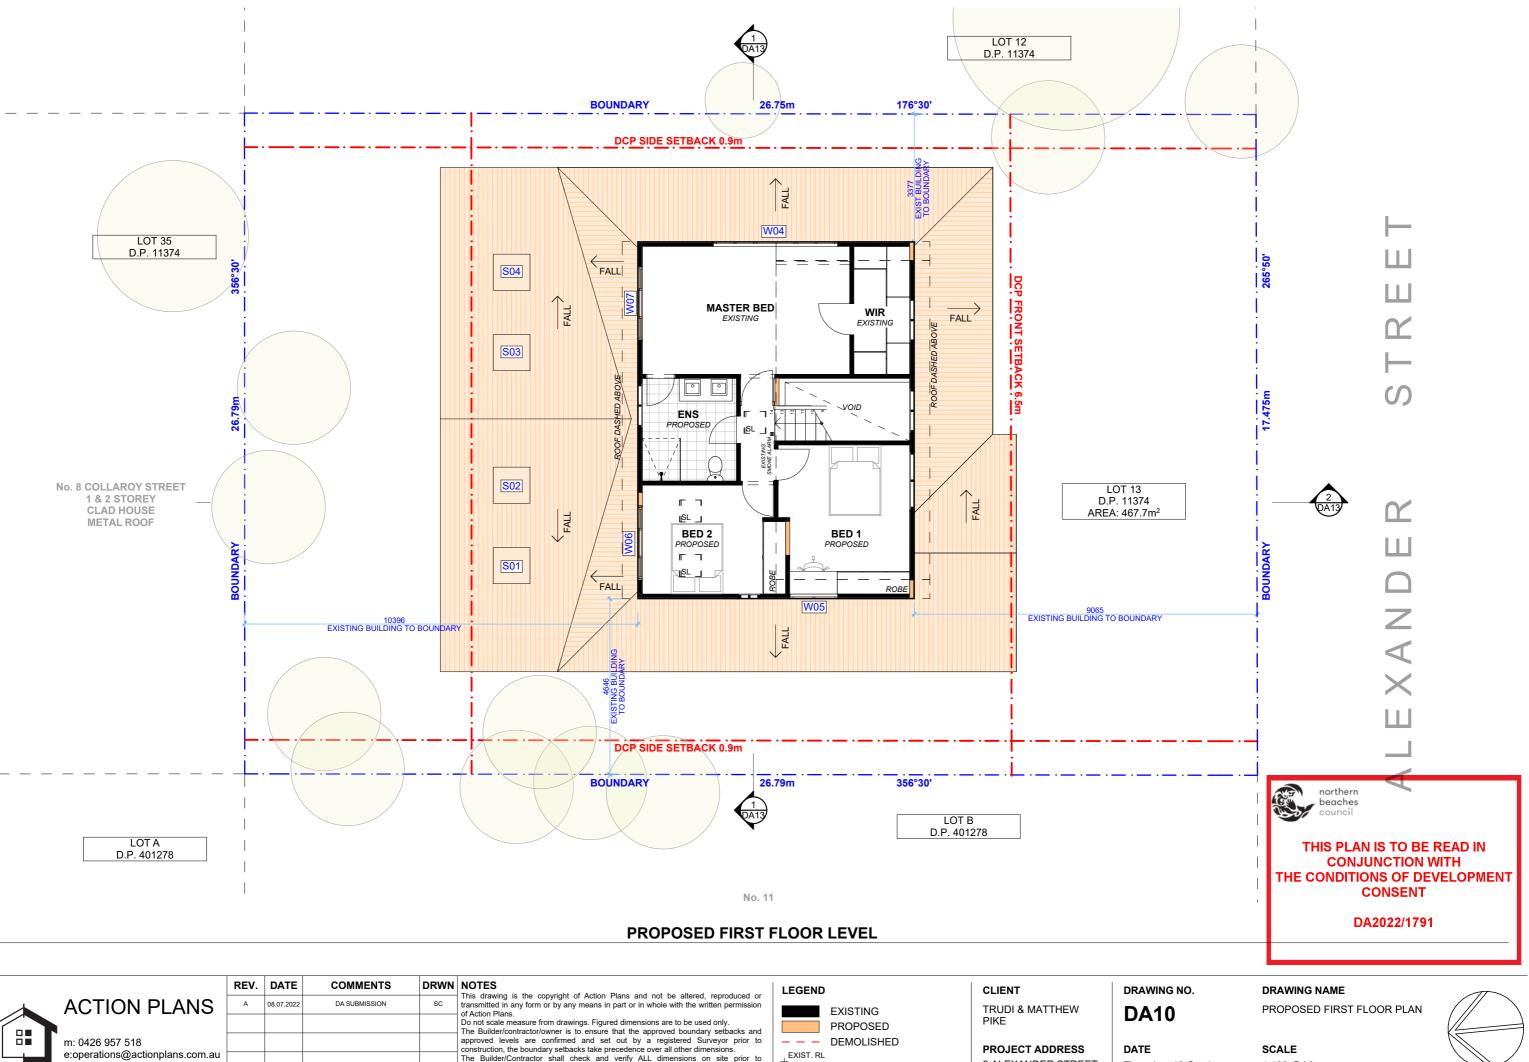
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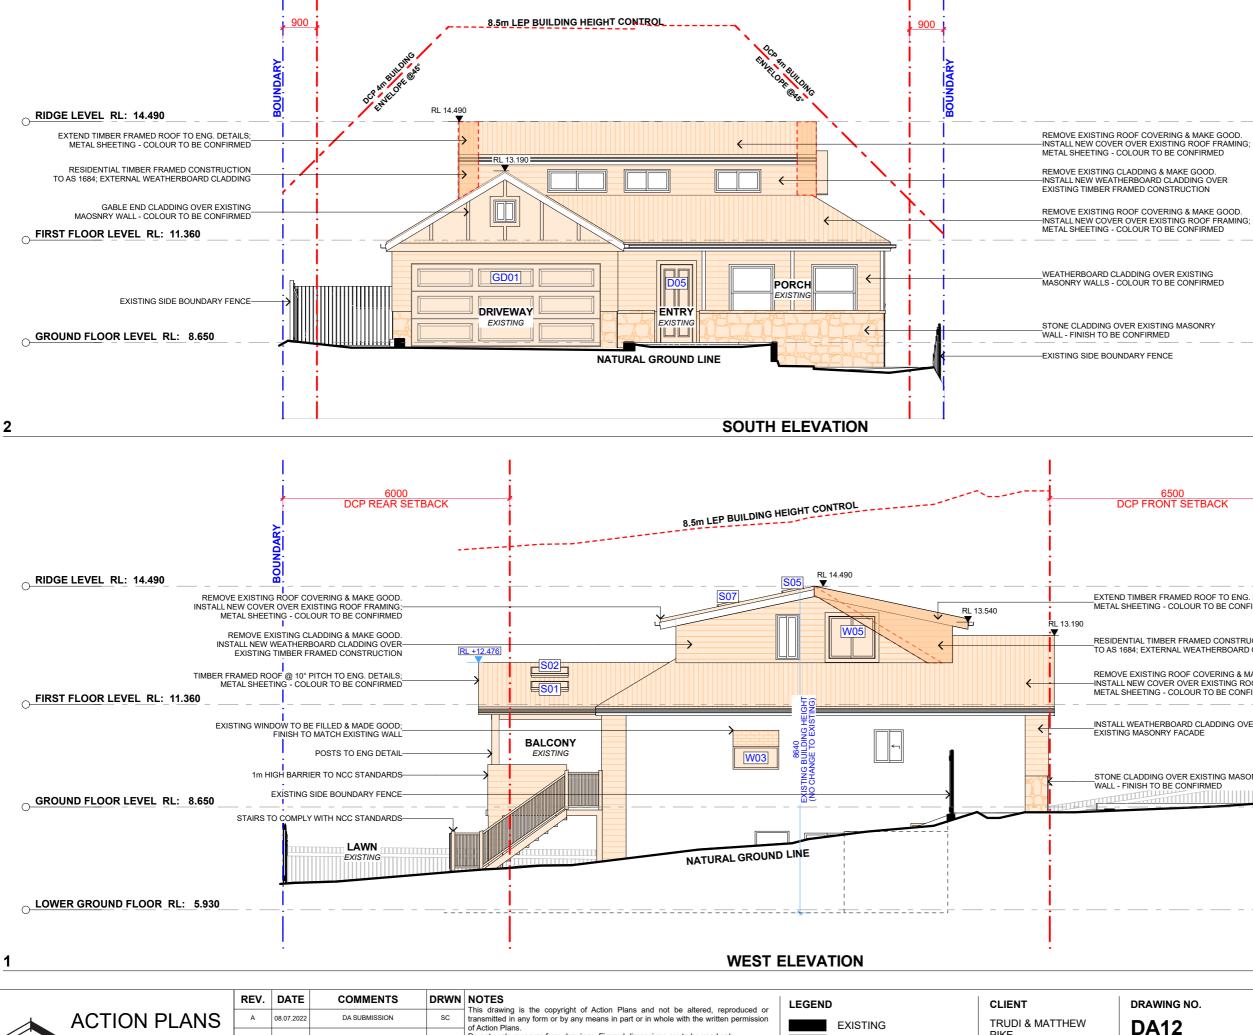
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2022

Thursday, 13 October

1:100 @A3

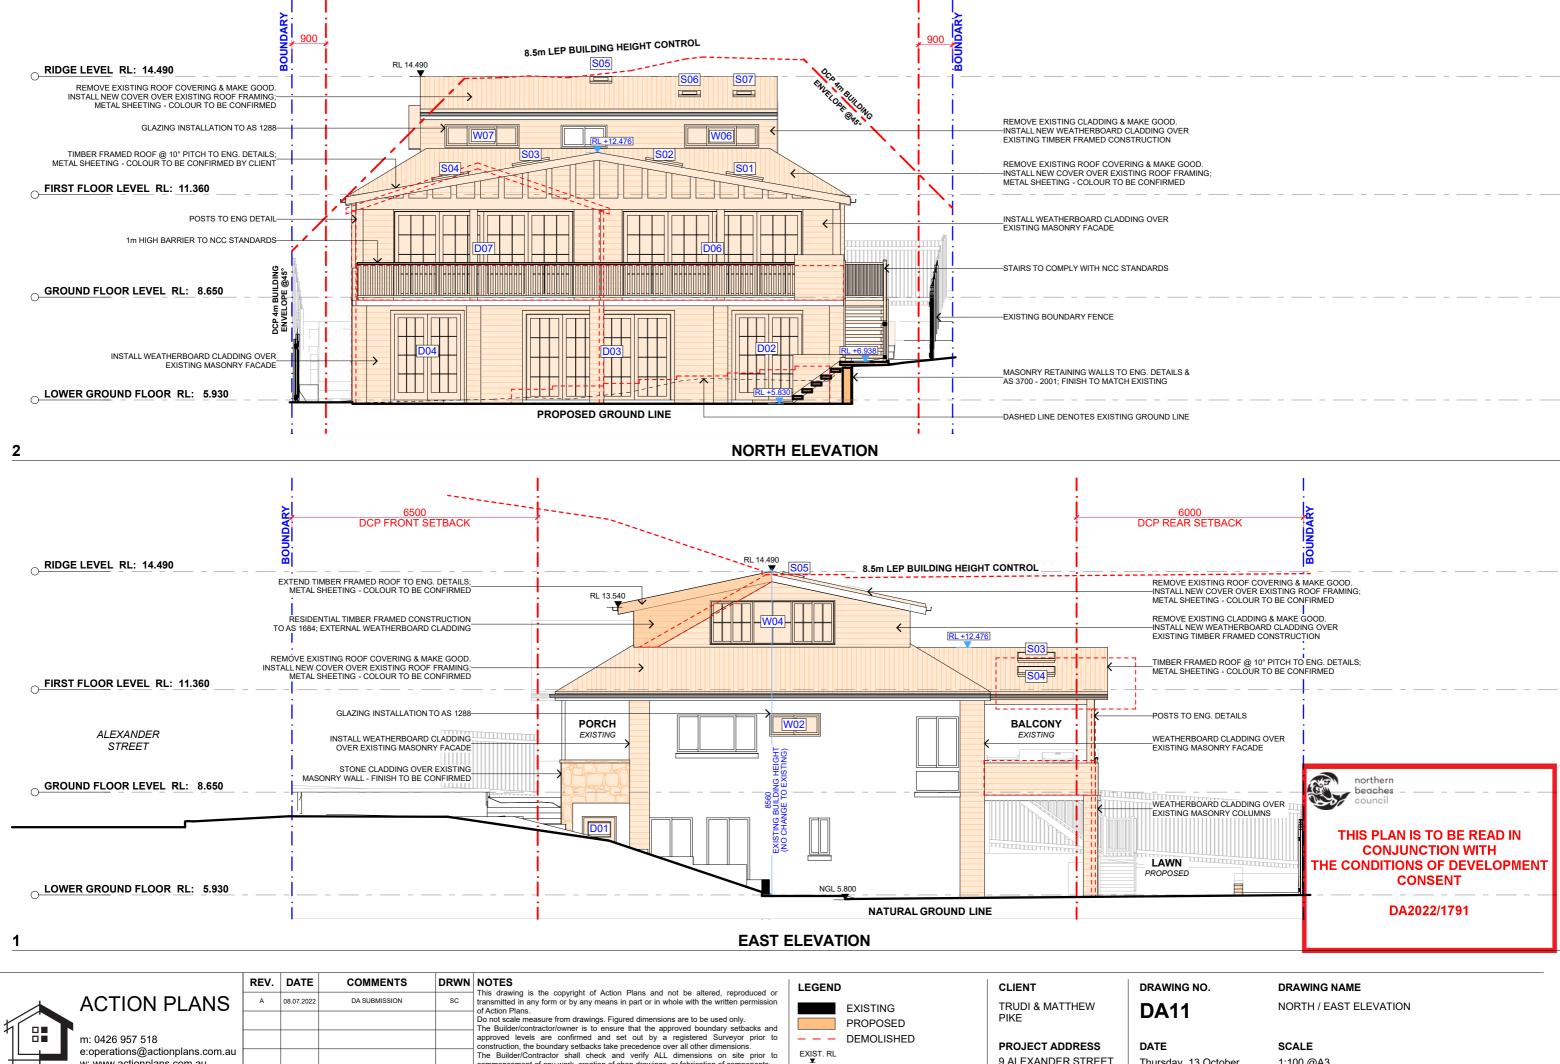

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H	m: 0426 957 518					Do not scale measure from drawings. Figured dimensions are to be used only. The Builder/contractor/owner is to ensure that the approved boundary setbacks and approved levels are confirmed and set out by a registered Surveyor prior to construction, the boundary setbacks take precedence over all other dimensions. The Builder/Contractor shall check and verify ALL dimensions on site prior to commencement of any work, creation of show drawings, or fabrication of components.		PROPOSED
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PIKE

COLLAROY NSW 2097

DATE 2022


6500 DCP FRONT SETBACK _EXTEND TIMBER FRAMED ROOF TO ENG. DETAILS; METAL SHEETING - COLOUR TO BE CONFIRMED _RESIDENTIAL TIMBER FRAMED CONSTRUCTION TO AS 1684; EXTERNAL WEATHERBOARD CLADDING REMOVE EXISTING ROOF COVERING & MAKE GOOD. -INSTALL NEW COVER OVER EXISTING ROOF FRAMINE METAL SHEETING - COLOUR TO BE CONFIRMED INSTALL WEATHERBOARD CLADDING OVER EXISTING MASONRY FACADE ALEXANDER STREET STONE CLADDING OVER EXISTING MASONRY WALL - FINISH TO BE CONFIRMED norther THIS PLAN IS TO BE READ IN **CONJUNCTION WITH** THE CONDITIONS OF DEVELOPMENT CONSENT DA2022/1791


DRAWING NAME

SOUTH / WEST ELEVATION

Thursday, 13 October

SCALE 1:100 @A3

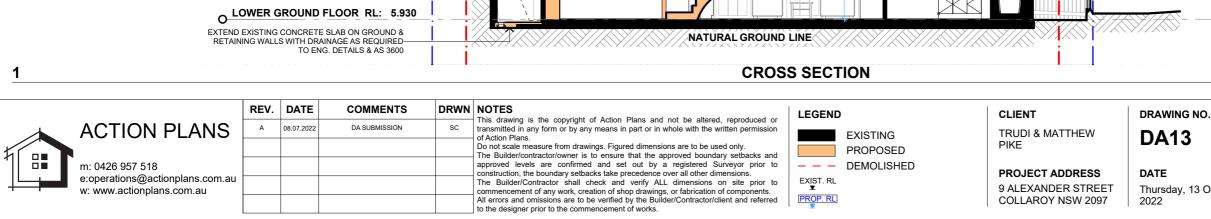

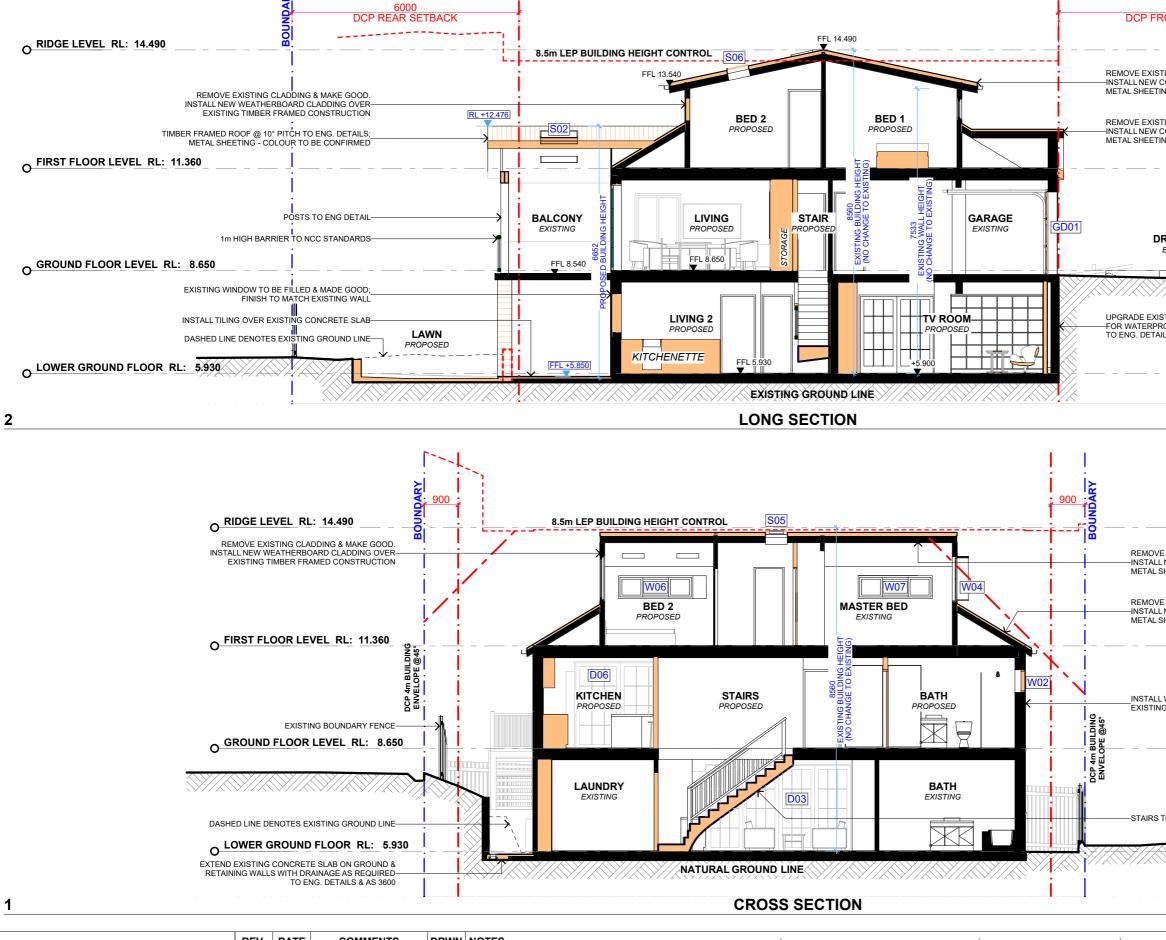

6500 ONT SETBACK	BOUNDARY
ING ROOF COVERING & MAKE GOOD OVER OVER EXISTING ROOF FRAMIN NG - COLOUR TO BE CONFIRMED ING ROOF COVERING & MAKE GOOD	IG;
NG - COLOUR TO BE CONFIRMED	
RIVEWAY EXISTING	
TING WALL TO MASONRY CAVITY OOFING & DRAINAGE AS REQUIRED LS	

REMOVE EXISTING ROOF COVERING & MAKE GOOD. HINSTALL NEW COVER OVER EXISTING ROOF FRAMING; METAL SHEETING - COLOUR TO BE CONFIRMED

REMOVE EXISTING ROOF COVERING & MAKE GOOD. -INSTALL NEW COVER OVER EXISTING ROOF FRAMING; METAL SHEETING - COLOUR TO BE CONFIRMED

INSTALL WEATHERBOARD CLADDING OVER EXISTING MASONRY FACADE

	northern
O COMPLY WITH NCC STANDARDS	THIS PLAN IS TO BE READ IN CONJUNCTION WITH THE CONDITIONS OF DEVELOPMENT CONSENT
>	DA2022/1791

DRAWING NAME

LONG / CROSS SECTION

Thursday, 13 October

SCALE 1:100 @A3