

## Memo

#### **Development Assessment**

To: Northern Beaches Local Planning Panel - Chairperson

Cc: Northern Beaches Local Planning Panel – Expert and

Community Members

From: Steve Findlay, Manager - Development Assessment

Date: 30 November 2020

Subject: Item 3.2 for Meeting of 2 December 2020 - DA2020/0442 for a

Mixed Development (Shop-top Housing) at 231 Whale Beach

Road, Whale Beach

**Record Number:** 2020/748500

#### Dear Panel,

One of the items scheduled for the NBLPP Meeting on Wednesday 2 December 2020 is Item 3.2 which relates to a Development Application (DA2020/0442) for demolition works and construction of a Mixed Use Development comprising Shop-top Housing and retail premises, with associated car parking, landscaping and strata subdivision.

The purpose of this memo is to advise the panel that the applicant has submitted amended plans and additional information in an attempt to address the concerns raised by Council and the community. The amended plans are attached to this memo and are submitted to the panel for its consideration of the matter.

In summary, the amended plans include the following changes:

- The extent of the eastern projection of the balconies to Levels 2 and 3 has been reduced by 3.0 metres
- The balconies to Levels 2 and 3 have been redesigned to project less to the east and have a softer, more rounded and consistent character incorporating brickwork.
- Timber soffits to balconies and awning roofs has been provided. As the primary views from Surf Road are from below, this has a significant impact on the materiality of the building from this aspect.
- The first floor podium base has been clad in sandstone rather than off-form concrete.
   Sandstone has also been provided to visible ground floor walls adjacent to the street frontage.
- The depth of the first floor podium has been reduced from 1.9 metres to 1.4 metres. This will reduce the bulk at the base of the building.
- The garden area to the pedestal base (first floor) has been increased and hard landscaped area reduced.
- The central void has been opened up by deleting projecting bays and angling the south eastern wall.

- The width of the sunshade bays has been reduced to northern elevation on all levels.
- Steel or aluminium gates and screens have been replaced with timber.
- The upper level perforated brickwork and associated rooftop plant has been deleted and accommodated within a single rooftop element combining the lift overrun and plant. These changes reduce the total width of rooftop elements when viewed from Whale Beach Road from 14.325 metres to 4.700 metres.
- The flyover copper roof over the fire stair has been deleted.
- The hard surface area to south of bedrooms of Apartment 1 has been replaced with garden bed.
- The hard surface area to the north of Level 1 Apartment 2 has been replaced with garden bed.
- The extent of the awning to Whale Beach Road has been reduced and softened with a curve in plan.
- Two street trees have been provided to the Surf Road frontage.
- The side setbacks to the majority of the northern and southern walls of Apartment 5
  have been increased to 4.2m from the boundary and a fixed timber sunshade and
  privacy screen provided adjacent to the windows. This will decrease the bulk and scale
  of the building, provide greater privacy to neighbouring buildings and give a lighter
  appearance to the upper floor.
- The selection of face brickwork has been amended to a softer, more natural appearance brick that is more distinguishable from the off form concrete finish. This will soften the appearance of the building and help to break down the bulk and scale.
- Reducing bulk and side setbacks further will result in deletion of the central breezeway, which not only reduces amenity for the building, but for the residents and beachgoers, who will be able to utilise the breezeway.

## Proposed amendments to reduce impact on views include the following:

- The upper level perforated brickwork and associated rooftop plant has been deleted and accommodated within a single rooftop element combining the lift overrun and plant. These changes reduce the total width of rooftop elements when viewed from Whale Beach Road from 14.325 metres to 4.700 metres.
- The flyover copper roof over the fire stair has been deleted.
- The extent of the eastern projection of the balconies to Levels 2 and 3 has been reduced by 3.0 metres
- Existing street trees have been retained including the Fig Tree (T1) on Whale Beach Road.
- The width of the sunshade bays has been reduced to northern elevation on all levels.
- The side setbacks to the majority of the northern and southern walls of Apartment 5
  have been increased to 4.2m from the boundary and a fixed timber sunshade and
  privacy screen provided adjacent to the windows. This will decrease the bulk and
  scale of the building, provide greater privacy to neighbouring buildings and give a
  lighter appearance to the upper floor.

## Proposed amendments to increase privacy include the following:

- The garden area to the pedestal base (first floor) has been increased and hard landscaped area reduced.
- A garden bed and privacy screen has been provided to the southern edge of Apartment 3 terrace. This will provide greater privacy to 229 Whale Beach Road.

2020/748500 Page 2 of 3

- A garden bed has been provided to the southern edge of Apartment 4 terrace. This will provide greater privacy to 229 Whale Beach Road.
- An angled louvre privacy screen has been provided to the northern edge of Retail 2 terrace. This will provide greater privacy to 233 Whale Beach Road.
- A garden bed has been provided to the northern edge of Apartment 5 terrace. This will provide greater privacy to 233 Whale Beach Road. Note that 1m high garden beds prevent occupants of elevated terraces from standing at the edge and looking down into neighbouring dwellings. As long as level differences are sufficient, occupants are restricted to looking out over the adjacent building.
- The side setbacks to the majority of the northern and southern walls of Apartment 5 have been increased to 4.2m from the boundary and a fixed timber sunshade and privacy screen provided adjacent to the windows. This will decrease the bulk and scale of the building, provide greater privacy to neighbouring buildings and give a lighter appearance to the upper floor.

To support the amended plans, the applicant also provided updated experts reports, including:

- Updated Traffic Report
- Updated Landscape Drawings and Report Updated BASIX Certificate
- BCA Compliance Report

A review of the amended plans indicates that whilst the amendments represent significant improvements to the design of the proposed and ameliorate many of the adverse impacts, the extent of the amendments does not fully address Council's concerns to warrant a favourable recommendation, particularly in relation to the issue of bulk and scale and how the development responds to the topography of the land and immediately adjoining properties.

Furthermore, the amended plans have not been publicly exhibited or fully reviewed by the relevant referral sections of Council.

As detailed in the assessment report, the development needs to be broken down to a greater extent to better relate to the site, by stepping down the site to a greater degree on its upper levels, in a manner which is consistent with the prevailing topography of the land. Such an outcome would produce a form of development on the site which contextually fits within the established and unique character of site and the locality.

Should the Panel accept the amended plans, they will need to be renotified and referred to the various experts within Council.

Steve Findlay Manager, Development Assessment

2020/748500 Page 3 of 3

	Number	Issue	Sheet Name
DA01		Р	Site Plan
İ	DA02	Р	Locality Plan
	DA03	Р	Basement Plan
ĺ	DA04	Р	Ground Floor Plan
ĺ	DA05	Р	Level 1 Plan
İ	DA06	Р	Level 2 Plan
Ì	DA07	Р	Level 3 Plan
İ	DA08	Р	Level 4 Plan
	DA09	Р	Roof Plan
	DA10	Р	Elevations
	DA11	Р	Elevations
	DA12	Р	Boundary Elevations
L	DA13	Р	Section
	DA14	Р	Section
	DA15	Р	Shadow Diagram - 900am June 21
	DA16	Р	Shadow Diagram - 1200noon June 21
	DA17	Р	Shadow Diagram - 300pm June 21
	DA18	Р	Neighbouring Shadow Studies
	DA19	Р	Solar Access Study
	DA20	Р	Driveway Profile
	DA21	Р	Photomontage - Whale Beach Road
	DA22	Р	Photomontage - Surf Road
	DA23	Р	Site Analysis - Existing
	DA24	Р	Site Analysis - Proposed
	DA30	Р	Sectional Perspective (Site)
	DA31	Р	Compliance Check
	DA32	Р	Gross Floor Area Calculations
	DA33	Р	Area Calculations
	DA34	Р	Landscaped Areas
	DA35	Р	Finishes Board - Surf Road
	DA36	Р	Finishes Board - Whale Beach Road
	DA37	Р	Building Height Plane
	DA39	Р	BASIX Requirements
	DA40	Р	Retail 1 Plan
	DA41	Р	Apartment 1 Plan
	DA42	Р	Apartment 2 Plan (lower)
	DA43	Р	Apartment 2 Plan (upper)
	DA44	Р	Apartment 3 Plan
	DA45	P	Retail 2 Plan
	DA46	Р	Apartment 4 & Retail 3 Plan
	DA47	P	Apartment 5 Plan
	DA50	P	196 WBR View Impact Study
	DA51	P	196 WBR View Impact Study
	DA52	P	194 WBR View Impact Study
	DA53	P	194 WBR View Impact Study
	DA54	P	198 WBR View Impact Study
	DA55	P	200 WBR View Impact Study
	DA56	Р	229 WBR View Impact Study
	DA57	Р	229 WBR View Impact Study
	DA58	P	229 WBR View Impact Study
	DA59	P	229 WBR View Impact Study
	DA60	P	229 WBR View Impact Study
	DA61	P	233 WBR View Impact Study
	DA62	P	233 WBR View Impact Study
	DA100	P	Notification Site Plan
	DA101	P	Notification Elevations
	DA102	Р	Notification Elevations

Sheet

Issue Sheet Name

#### Keynote Legend

AC AC Condenser AFW Aluminium Framed Window Frameless Glass Balustrade CL Clothesline CPR Copper Roofing CS Concrete Slab CW Concrete Wall DR FE Paling Fence Footpath Fire Hydrant GΑ Garbage Storage Area GR Glazed Roofing LB Letterbox LT MR Membrane Roof MW Masonry Wall Planter Bed PV Photovoltaic Panels RP Ramp SG Steel framed Gate SP Stone Paving SPA ST Stone Wall TS Timber Screen TZ Terrazzo Screen

WB Window Box

# WHALE BEACH NEIGHBOURHOOD CENTRE



139 PALMGROVE ROAD, AVALON BEACH NSW 2107

02 9918 3843 0418 627 024

mailto:richard@richardcolearchitecture.com.au

www.richardcolearchitecture.com.au

DEVELOPMENT APPLICATION 231 Whale Beach Road, Whale Beach





t 02 9918 3843

0418 627 024

mailto:richard@richardcolearchitecture.com.au

www.richardcolearchitecture.com.au


acn:093 598 415 abn:58 093 598 415 nominated architect : Richard Cole B.Sc.(Arch) (Hons 1) B.Arch.(Hons1) Reg. No: 6538

INO.	Revision Description	Date
I	Addition of Substation	24/10/19
K	Issued for Review	12/12/2019
L	Preliminary DA	03/04/2020
М	Development Application	17/04/2020
0	Preliminary Revised DA	06/10/2020
Р	Revised Development Application	09/10/2020

## WHALE BEACH NEIGHBOURHOOD

DEVELOPMENT APPLICATION 231 Whale Beach Road, Whale Beach

Project number	1609	Checked by	RC
Date	OCTOBER 2020	Scale	1 : 500
Drawn by	KW		DA01

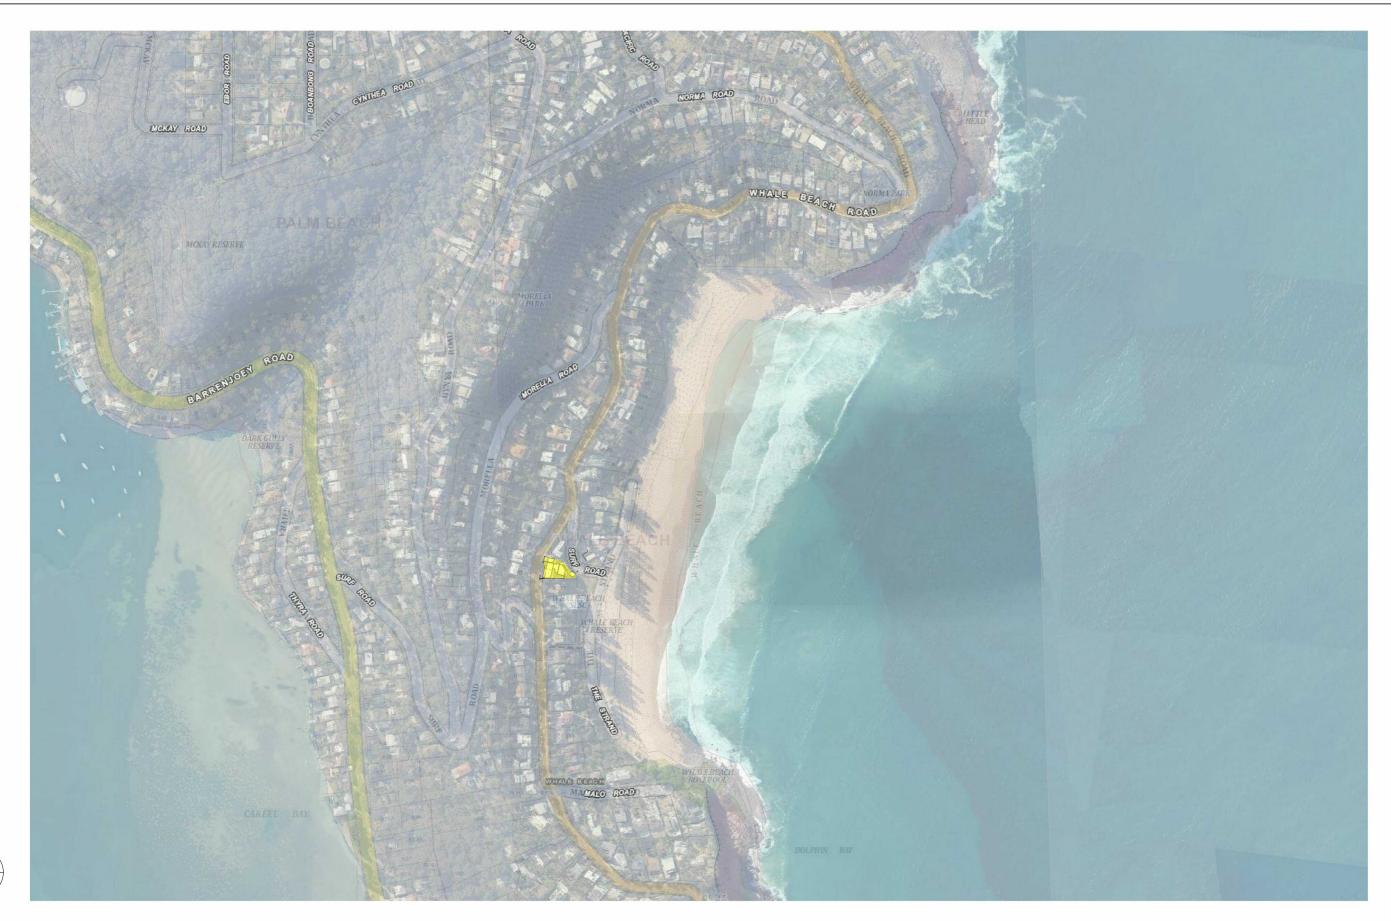



## DA Locality Plan 1:5000

139 PALMGROVE ROAD, AVALON BEACH NSW 2107 t 02 9918 3843

0418 627 024

mailto:richard@richardcolearchitecture.com.au

www.richardcolearchitecture.com.au

**	
	3 415 <b>abn</b> :58 093 598 415 <b>architect</b> : Richard Cole B.Sc.(Arch) (Hons 1) B.Arch.(Hons1) Reg. No: 6538


No.	Revision Description	Date
L	Preliminary DA	03/04/2020
M	Development Application	17/04/2020
0	Preliminary Revised DA	06/10/2020
Р	Revised Development Application	09/10/2020

## WHALE BEACH NEIGHBOURHOOD

DEVELOPMENT APPLICATION 231 Whale Beach Road, Whale Beach

Locality	Plan
----------	------

Project number	1609	Checked by	RC
Date	OCTOBER 2020	Scale	1 : 5000
Drawn by	RC		DA02

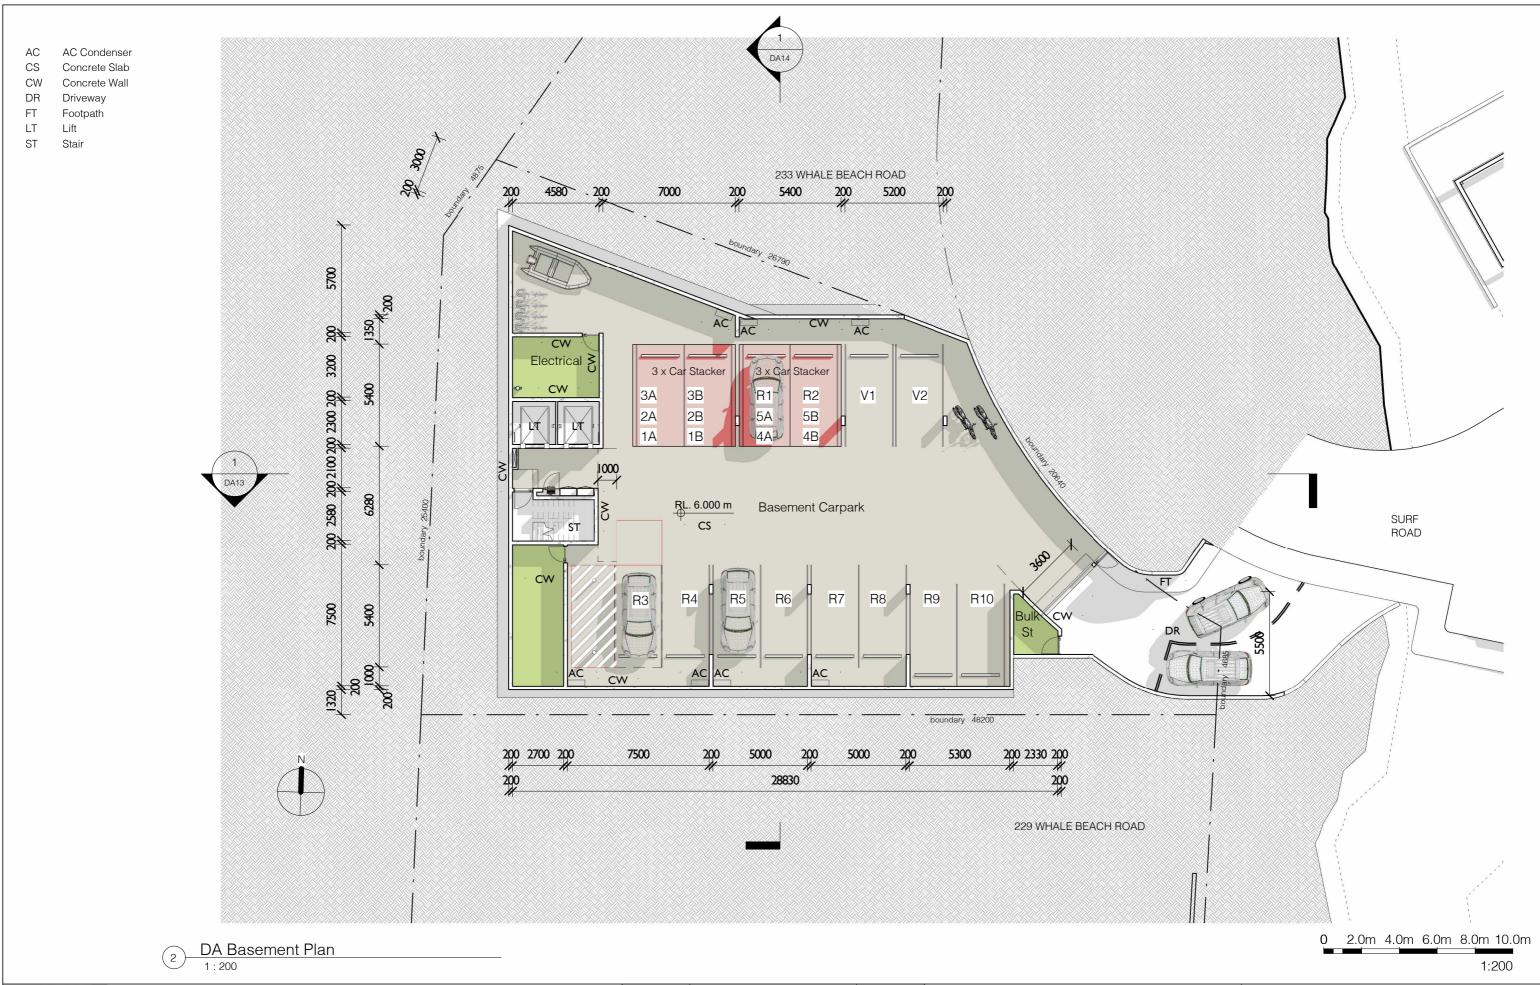

t 02 9918 3843

n 0418 627 024 mailto:richard@richardcolearchitecture.com.au

www.richardcolearchitecture.com.au


acn:093 598 415 abn:58 093 598 415 nominated architect: Richard Cole B.Sc.(Arch) (Hons 1) B.Arch.(Hons1) Reg. No: 6538

No.	Revision Description	Date
K	Issued for Review	12/12/2019
L	Preliminary DA	03/04/2020
M	Development Application	17/04/2020
N	Proposed Revised DA	15/07/2020
0	Preliminary Revised DA	06/10/2020
P	Revised Development Application	09/10/2020

## WHALE BEACH NEIGHBOURHOOD

DEVELOPMENT APPLICATION 231 Whale Beach Road, Whale Beach

Project number	1609	Checked by	RC
Date	OCTOBER 2020	Scale	1 : 200
Drawn by	KW		DA03

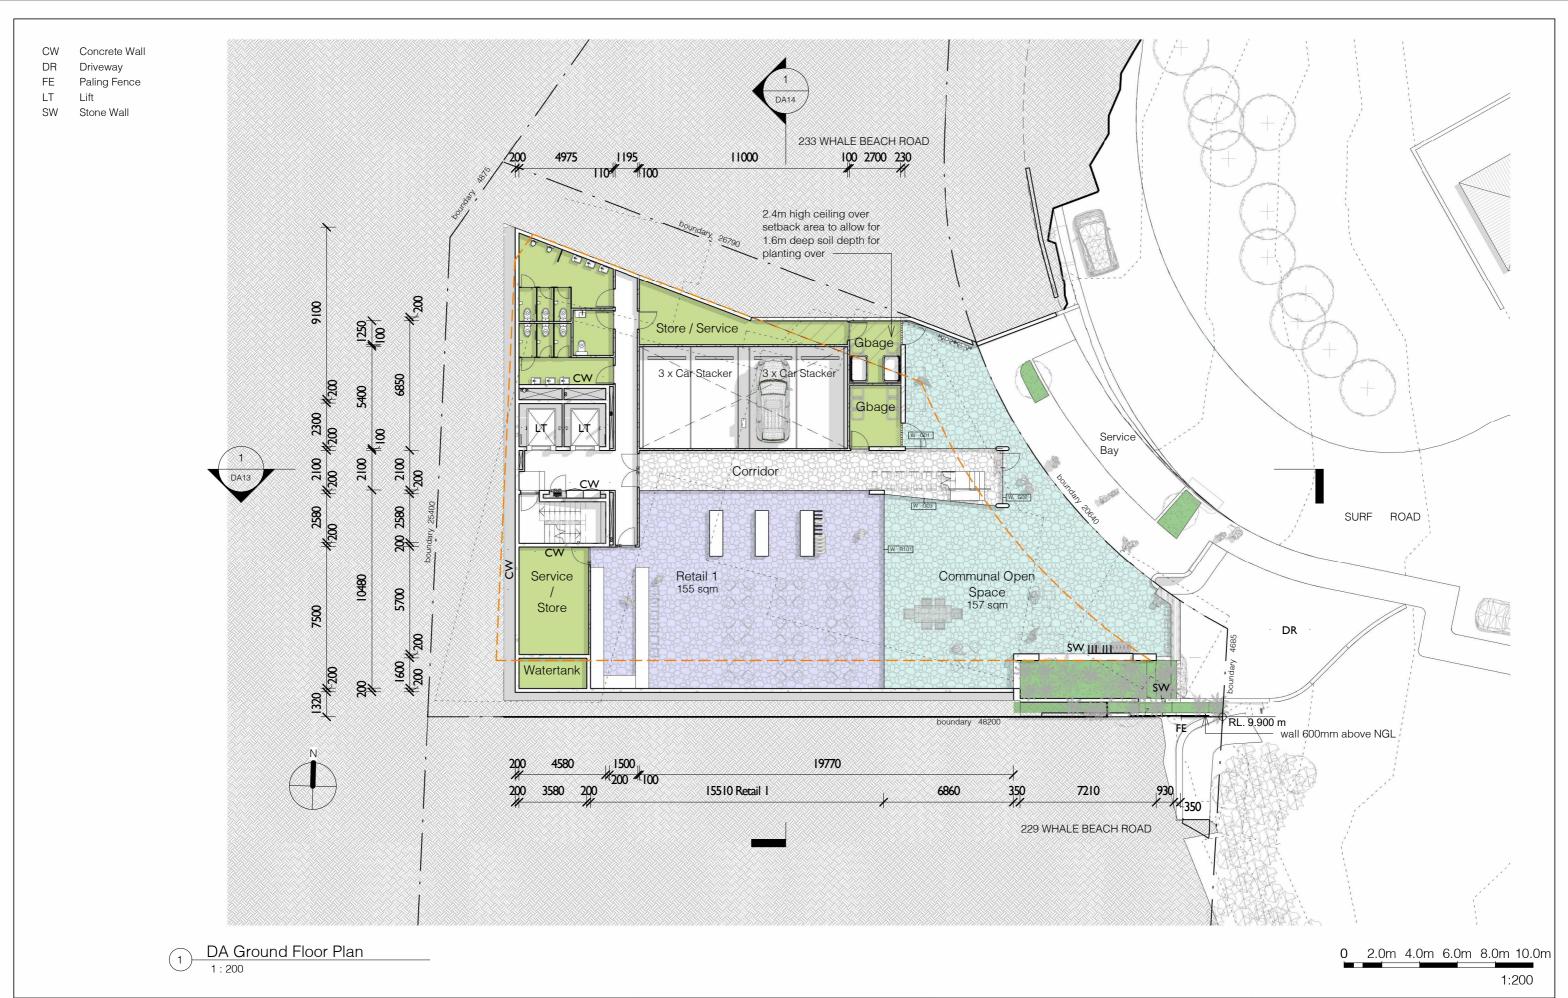

t 02 9918 3843

0418 627 024

mailto:richard@richardcolearchitecture.com.au

www.richardcolearchitecture.com.au

acn:093 598 415 abn:58 093 598 415 nominated architect : Richard Cole B.Sc.(Arch) (Hons 1) B.Arch.(Hons1) Reg. No: 6538


Date No. Revision Description Issued for Review 12/12/2019 Preliminary DA 03/04/2020 17/04/2020 Development Application Ν Proposed Revised DA 15/07/2020 Preliminary Revised DA 06/10/2020 09/10/2020 Revised Development Application

## WHALE BEACH NEIGHBOURHOOD

DEVELOPMENT APPLICATION 231 Whale Beach Road, Whale Beach

-loor Plan

Project number	1609	Checked by	RC
Date	OCTOBER 2020	Scale	1 : 200
Drawn by	KW		DA04

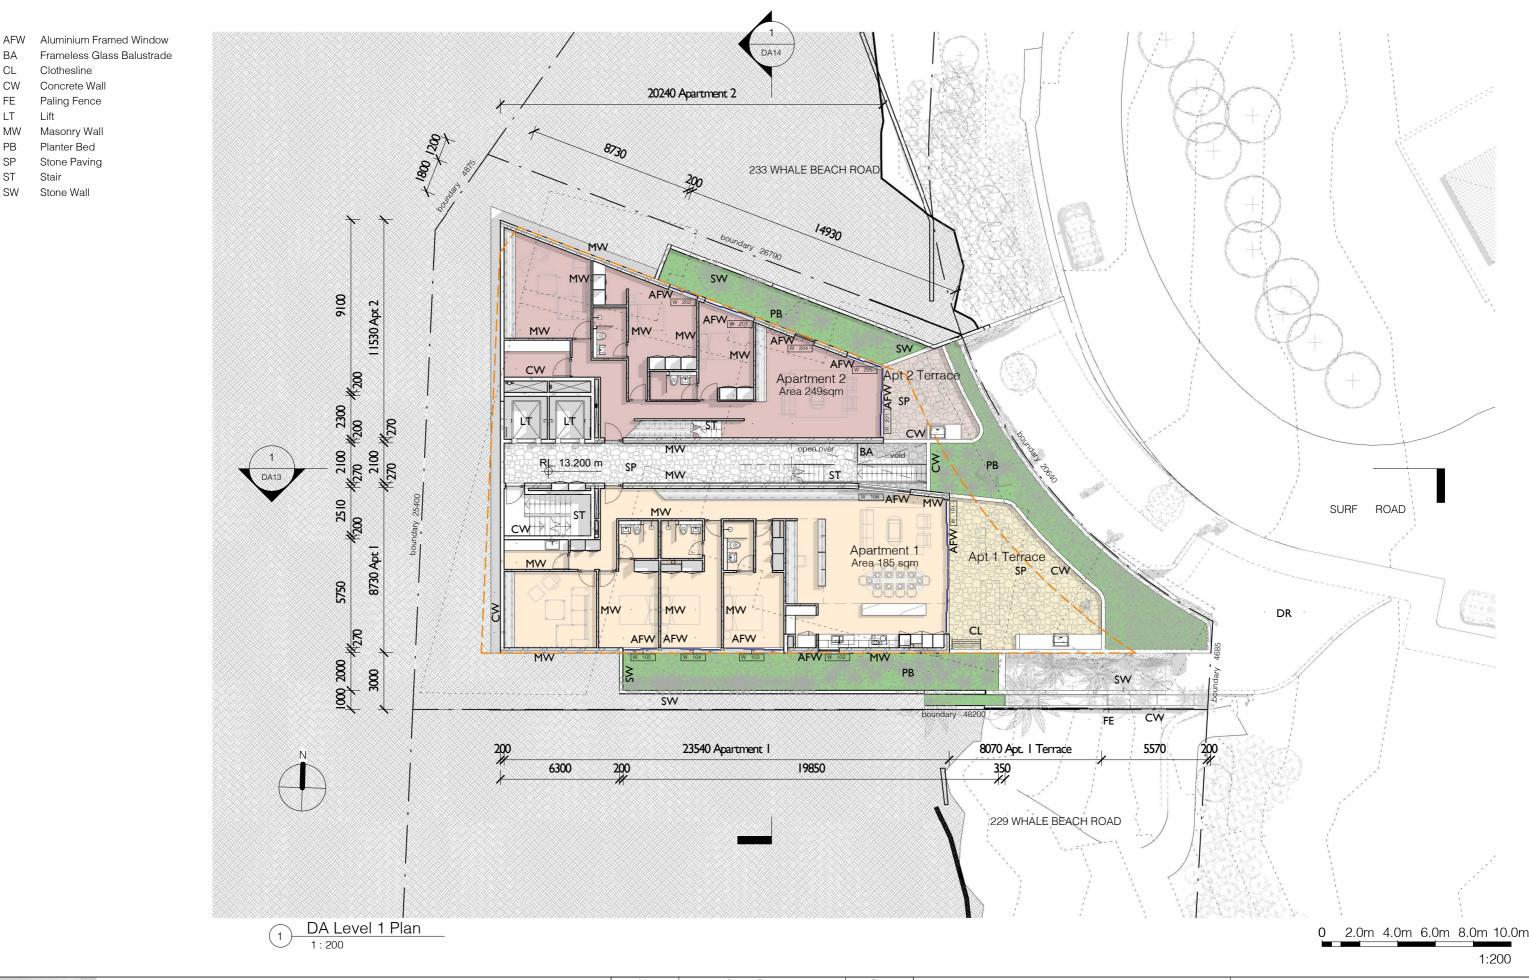

139 PALMGROVE ROAD, AVALON BEACH NSW 2107 02 9918 3843

ВА

CL

CW

FE

LT

MW

PΒ

SP

ST

SW

Clothesline

Concrete Wall

Paling Fence

Masonry Wall

Planter Bed

Stone Wall

Stone Paving

Lift

Stair

0418 627 024 mailto:richard@richardcolearchitecture.com.au

www.richardcolearchitecture.com.au

acn:093 598 415 abn:58 093 598 415 nominated architect : Richard Cole B.Sc.(Arch) (Hons 1) B.Arch.(Hons1) Reg. No: 6538


	No.	Revision Description	Date
	K	Issued for Review	12/12/2019
	L	Preliminary DA	03/04/2020
	М	M Development Application	
	N Proposed Revised DA O Preliminary Revised DA		15/07/2020
			06/10/2020
	Р	Revised Development Application	09/10/2020

## WHALE BEACH NEIGHBOURHOOD

DEVELOPMENT APPLICATION 231 Whale Beach Road, Whale Beach

evel	1	Plan	

Project number	1609	Checked by	RC
Date	OCTOBER 2020	Scale	1 : 200
Drawn by	KW		DA05

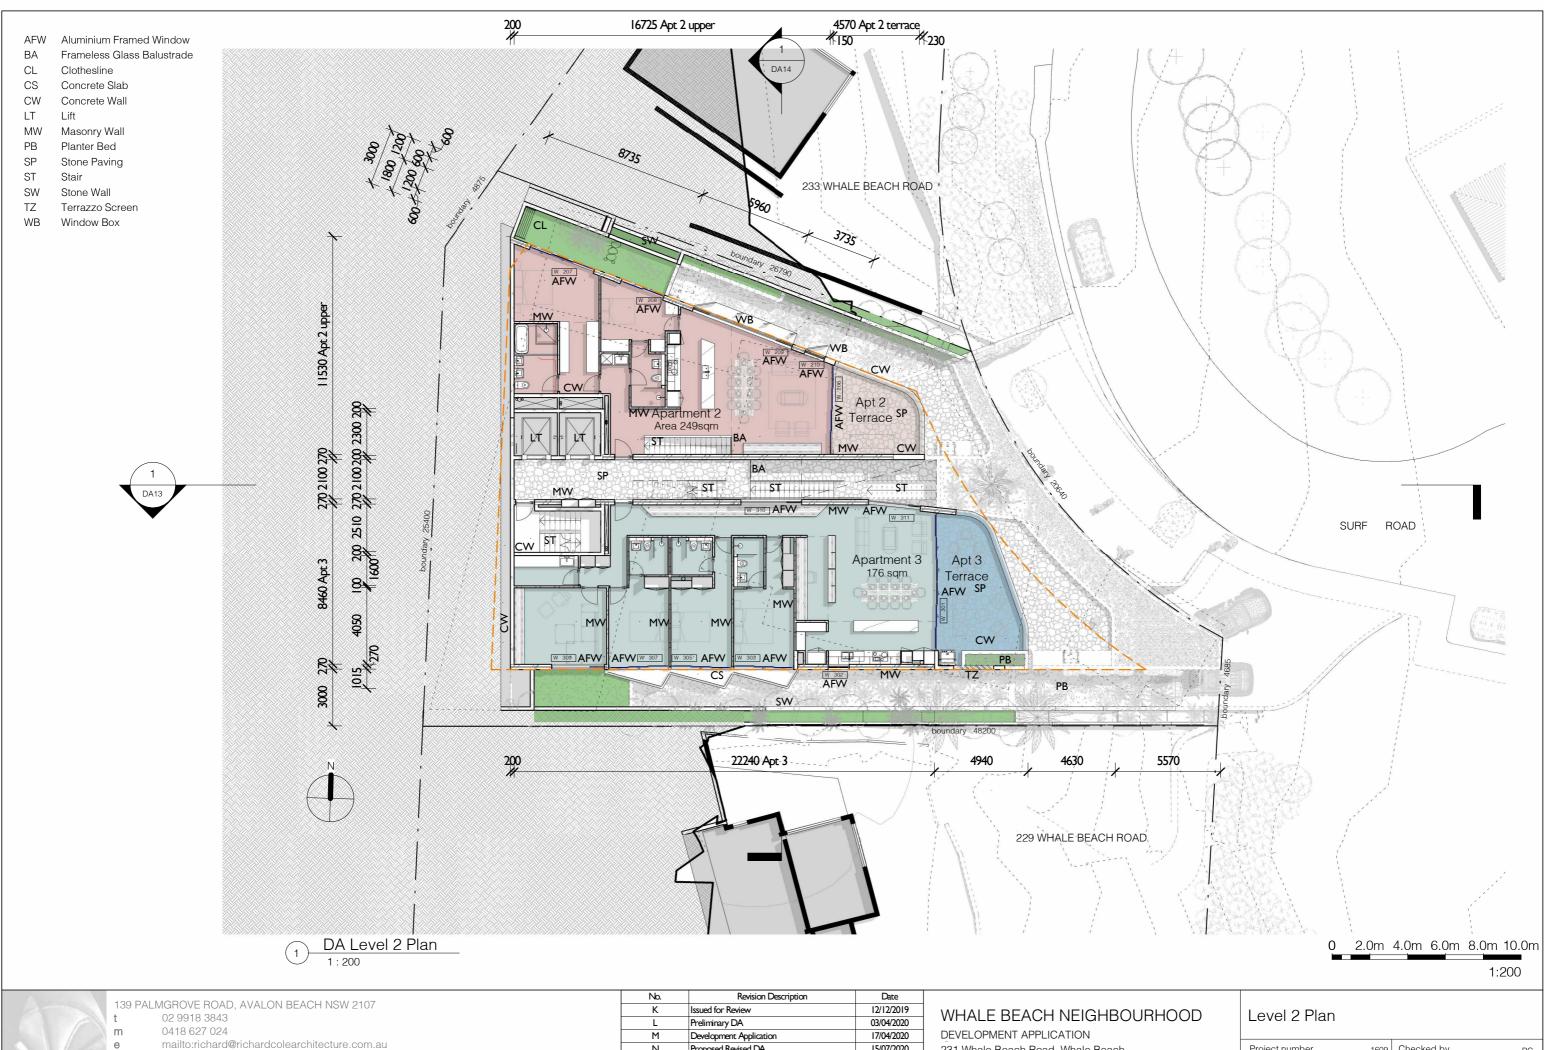


www.richardcolearchitecture.com.au acn:093 598 415 abn:58 093 598 415 nominated architect : Richard Cole B.Sc.(Arch) (Hons 1) B.Arch.(Hons1) Reg. No: 6538 Ν Proposed Revised DA 15/07/2020 Preliminary Revised DA 06/10/2020 Revised Development Application 09/10/2020

231 Whale Beach Road, Whale Beach

L	esl	ie	Ca	ssar

Project number	1609	Checked by	RC
Date	OCTOBER 2020	Scale	1 : 200
Drawn by	KW		DA06

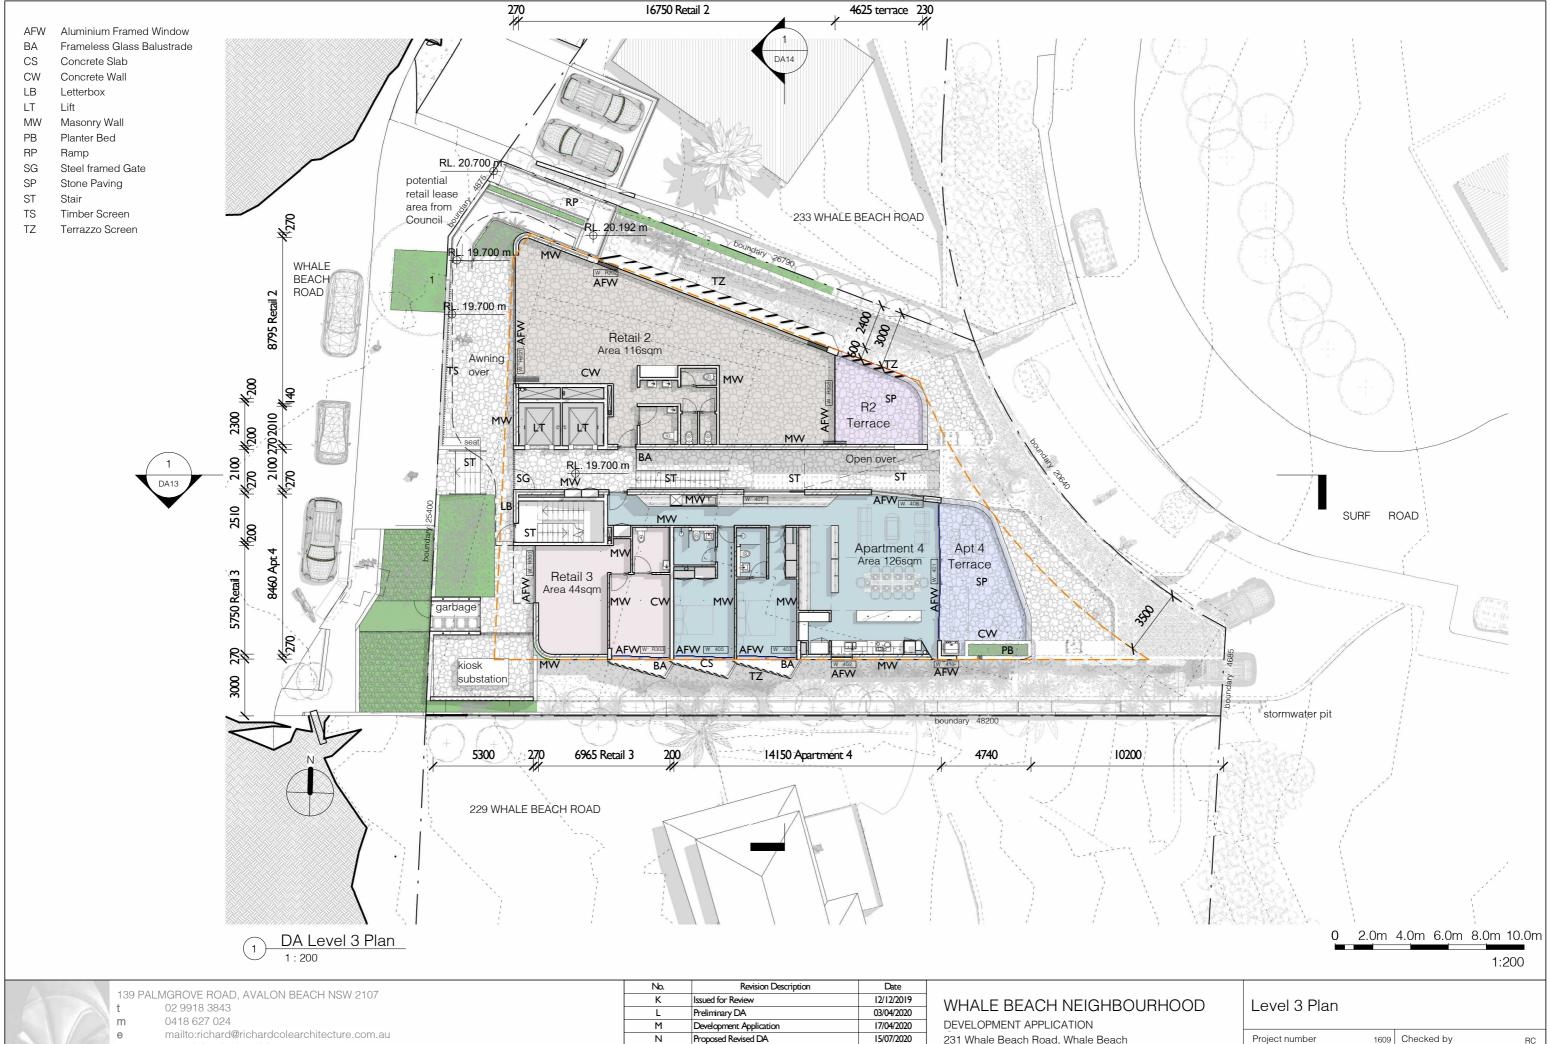

acn:093 598 415 abn:58 093 598 415 nominated architect : Richard Cole B.Sc.(Arch) (Hons 1) B.Arch.(Hons1) Reg. No: 6538


www.richardcolearchitecture.com.au

Ν Proposed Revised DA 15/07/2020 Preliminary Revised DA 06/10/2020 Revised Development Application 09/10/2020

231 Whale Beach Road, Whale Beach

101	
Leslie	Cassar

Project number	1609	Checked by	RC
Date	OCTOBER 2020	Scale	1 : 200
Drawn by	KW		DA07

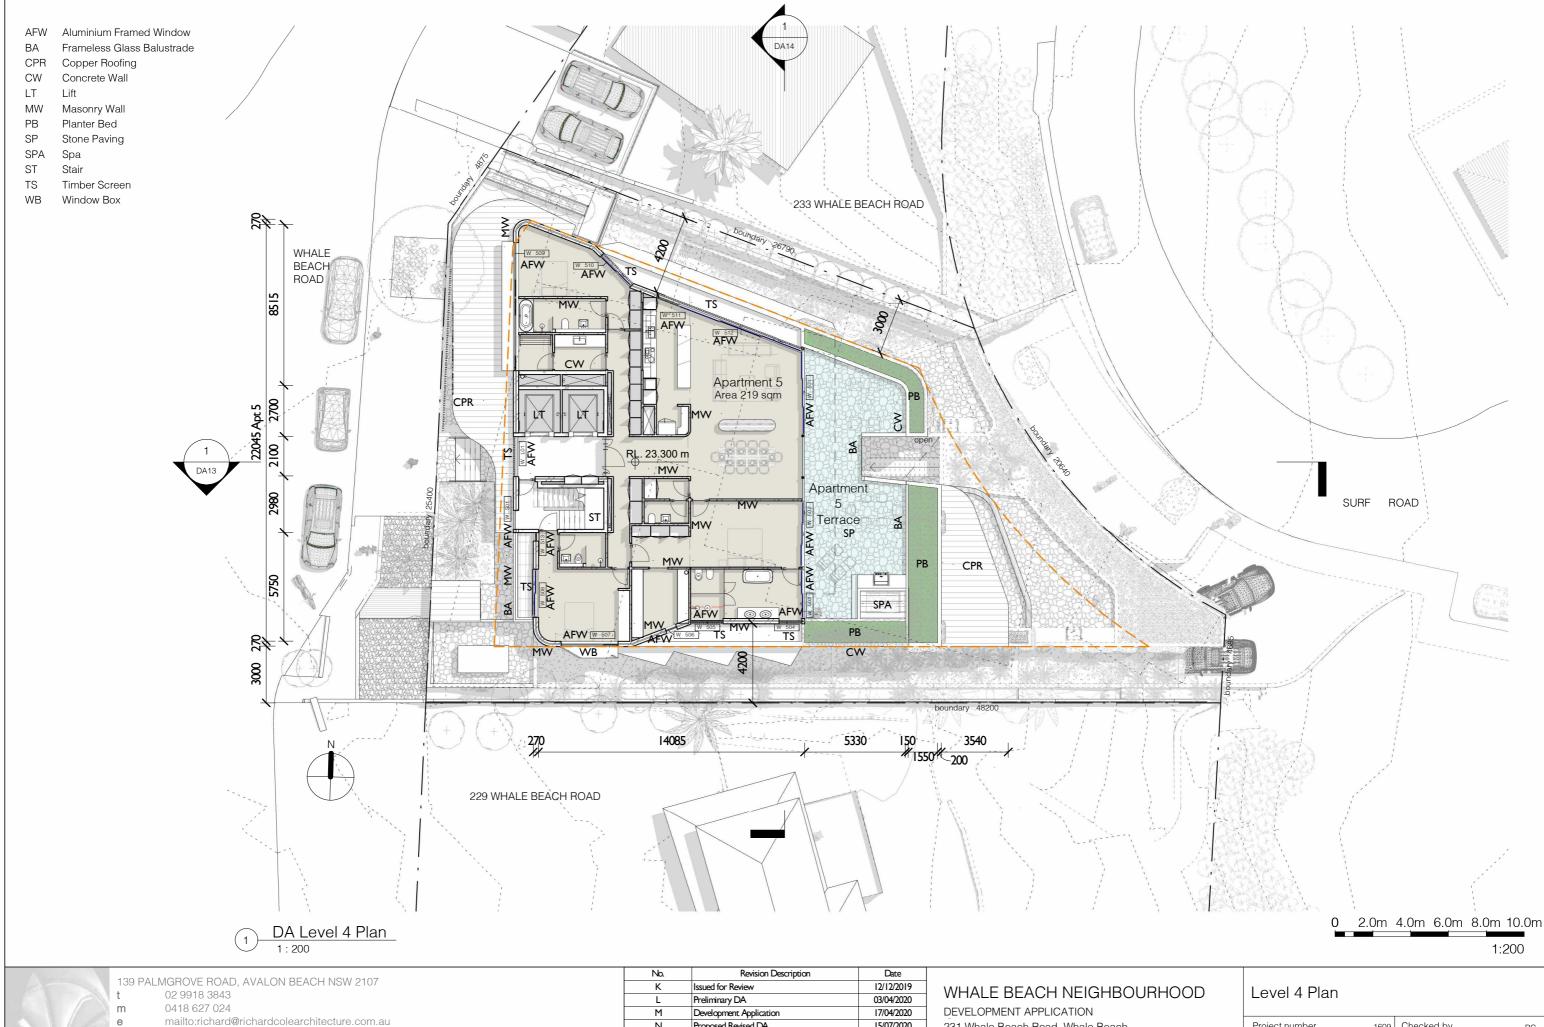

acn:093 598 415 abn:58 093 598 415 nominated architect : Richard Cole B.Sc.(Arch) (Hons 1) B.Arch.(Hons1) Reg. No: 6538


www.richardcolearchitecture.com.au

17/04/2020 Development Application Proposed Revised DA 15/07/2020 Preliminary Revised DA 06/10/2020 Revised Development Application 09/10/2020

231 Whale Beach Road, Whale Beach

101	
Leslie	Cassar

Project number	1609	Checked by	RC
Date	OCTOBER 2020	Scale	1 : 200
Orawn by	KW		DA08

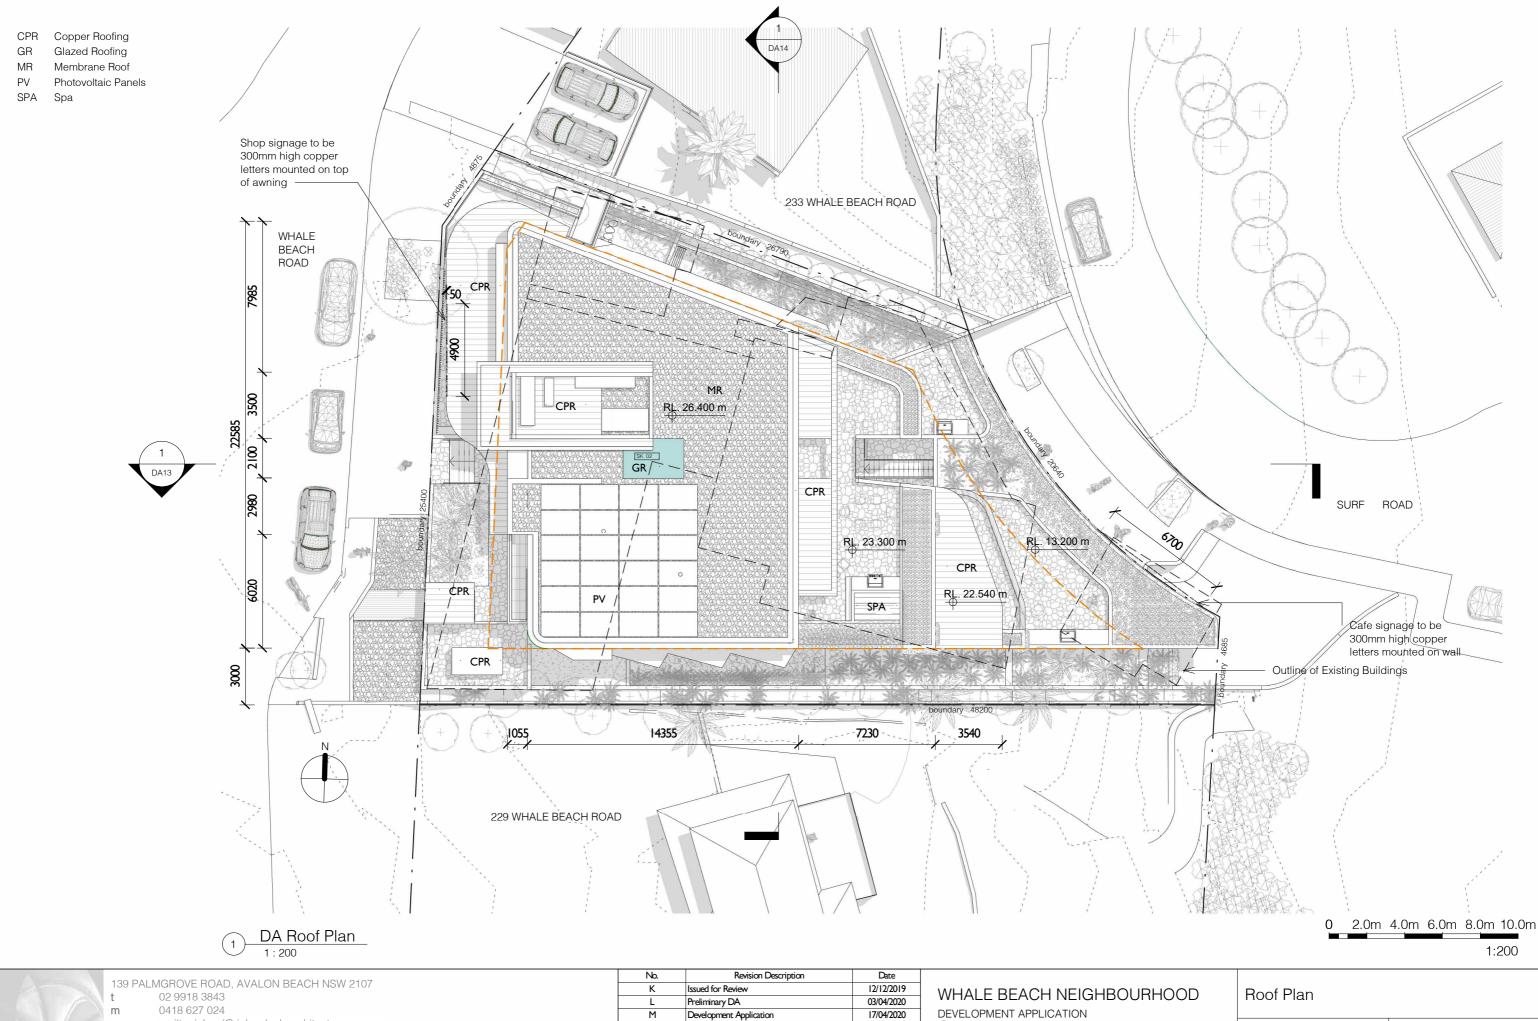

mailto:richard@richardcolearchitecture.com.au


www.richardcolearchitecture.com.au


acn:093 598 415 abn:58 093 598 415 nominated architect : Richard Cole B.Sc.(Arch) (Hons 1) B.Arch.(Hons1) Reg. No: 6538


	INO.	Revision Description	Late
	K	K Issued for Review	
L F		Preliminary DA	03/04/2020
	М	Development Application	17/04/2020
	N	Proposed Revised DA	15/07/2020
	0	Preliminary Revised DA	06/10/2020
	P	Revised Development Application	09/10/2020
		•	


231 Whale Beach Road, Whale Beach


Project number	1609	Checked by	RC
Date	OCTOBER 2020	Scale	1 : 200
Drawn by	KW		DA09

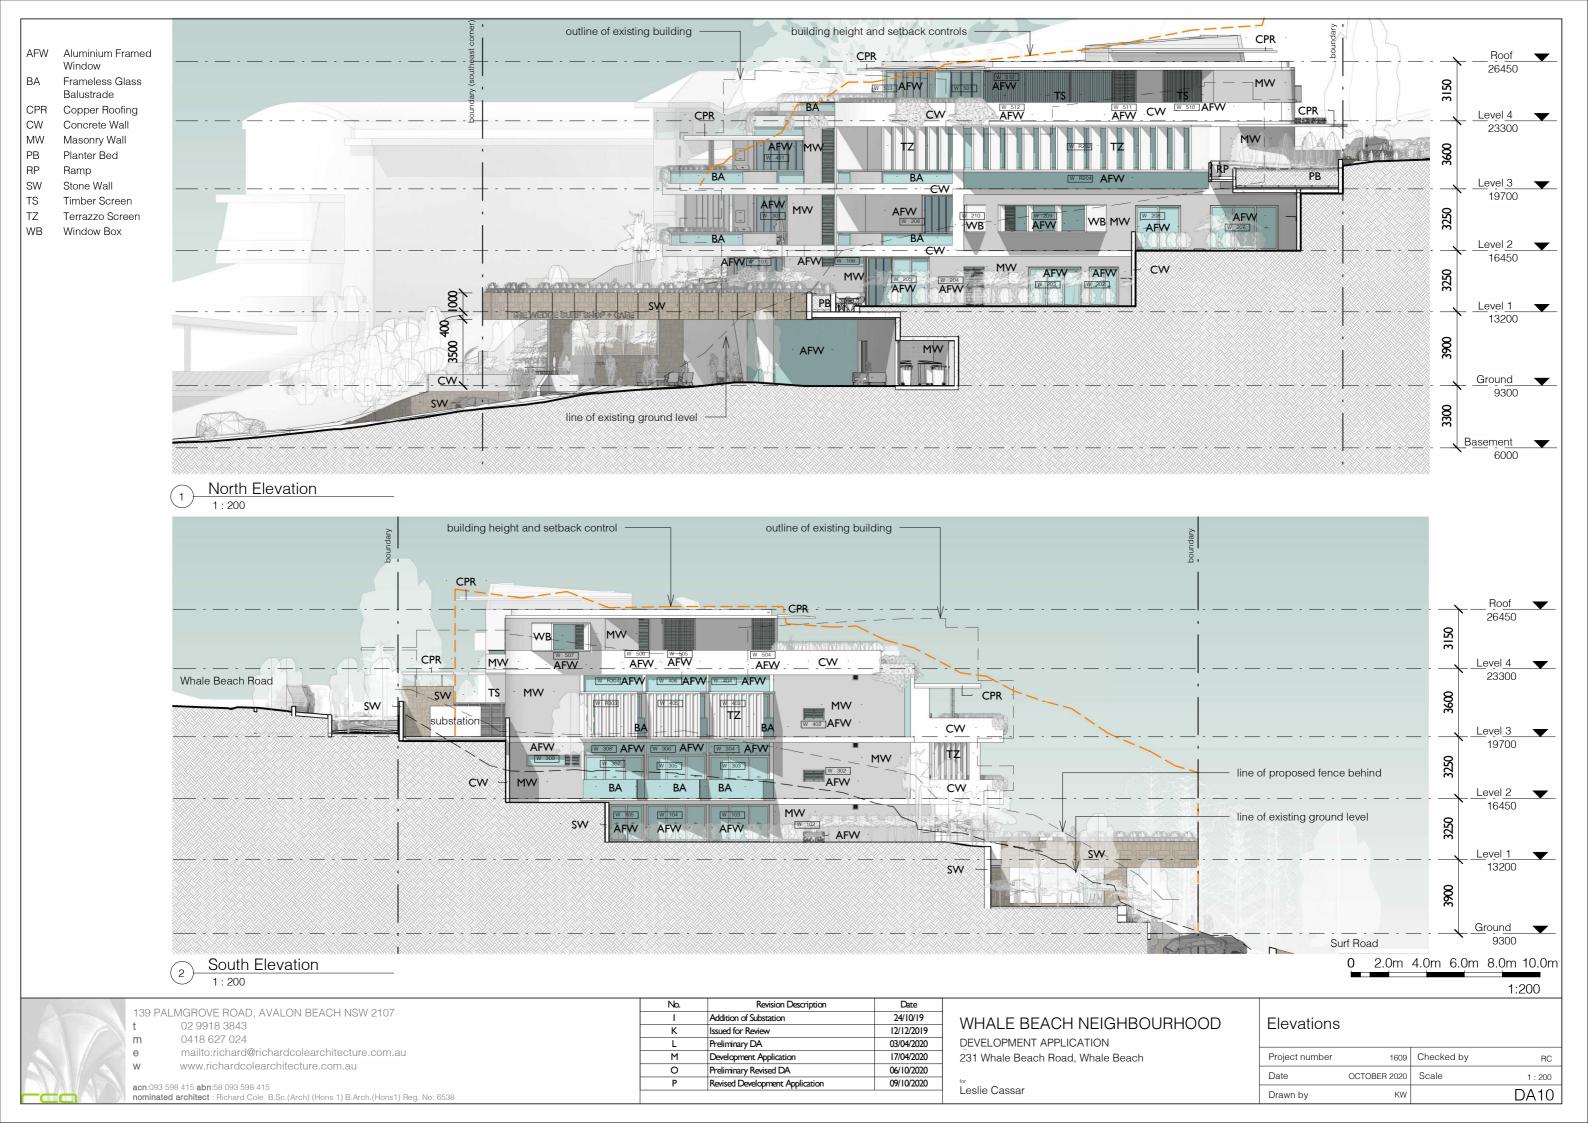

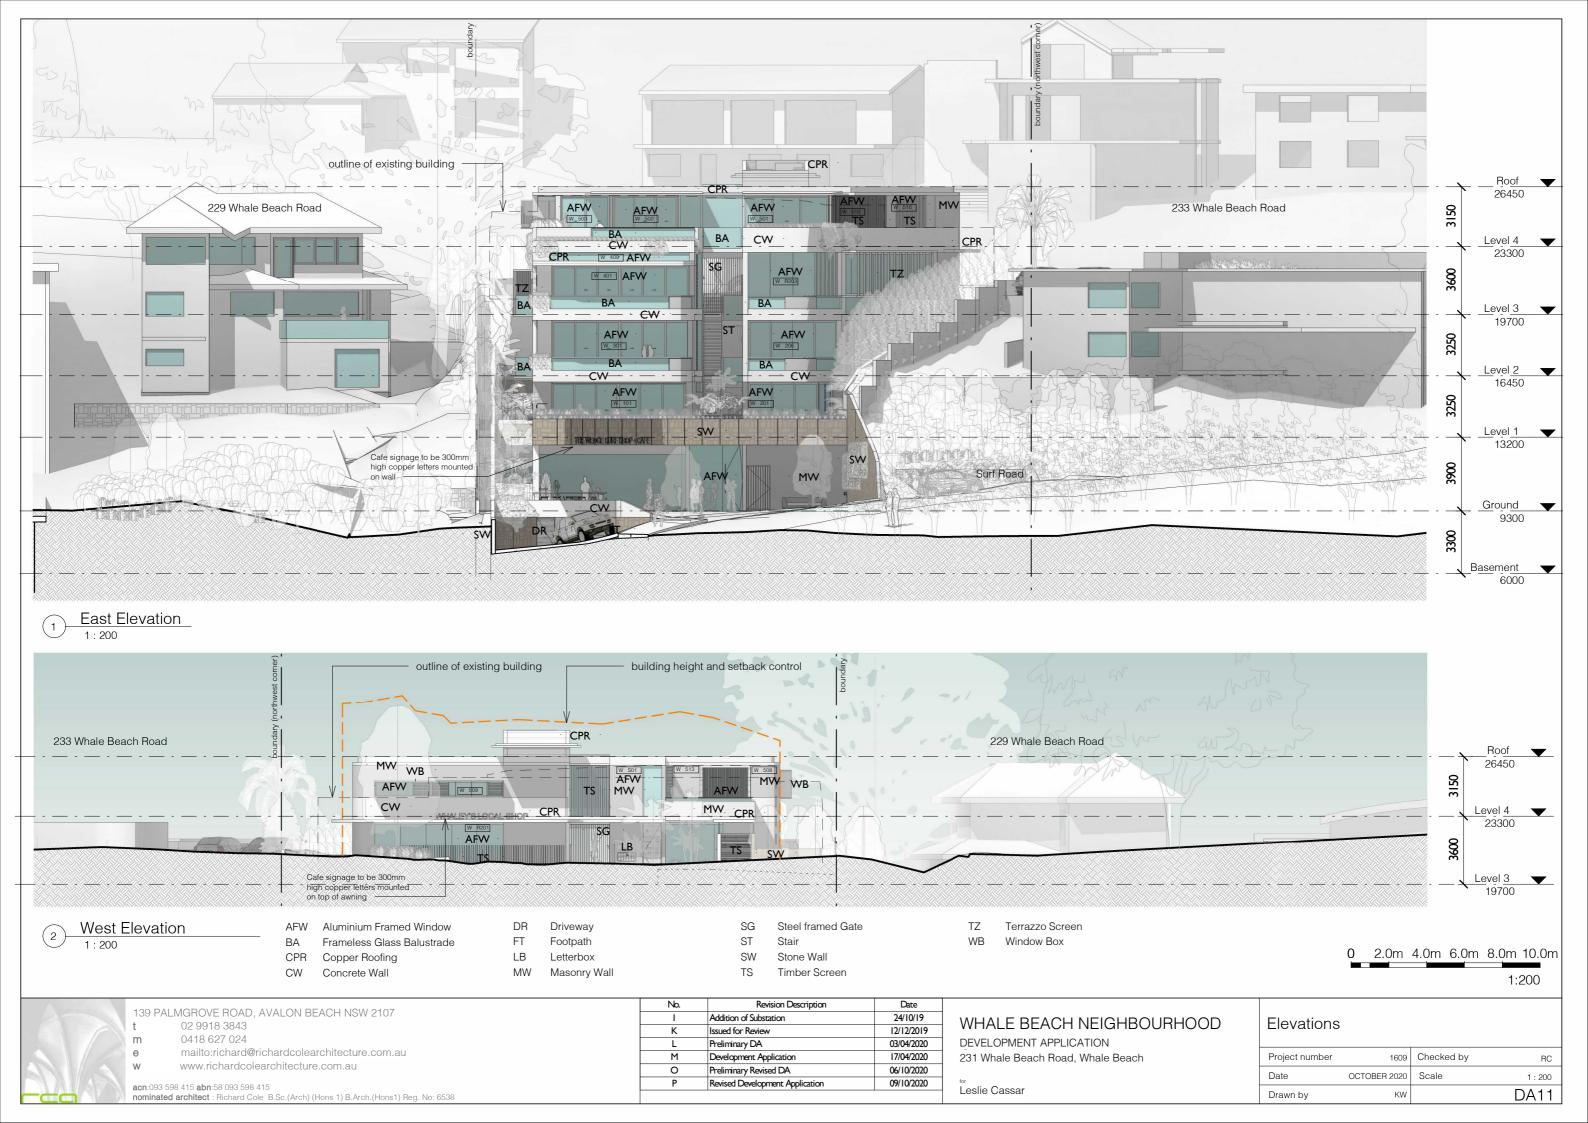

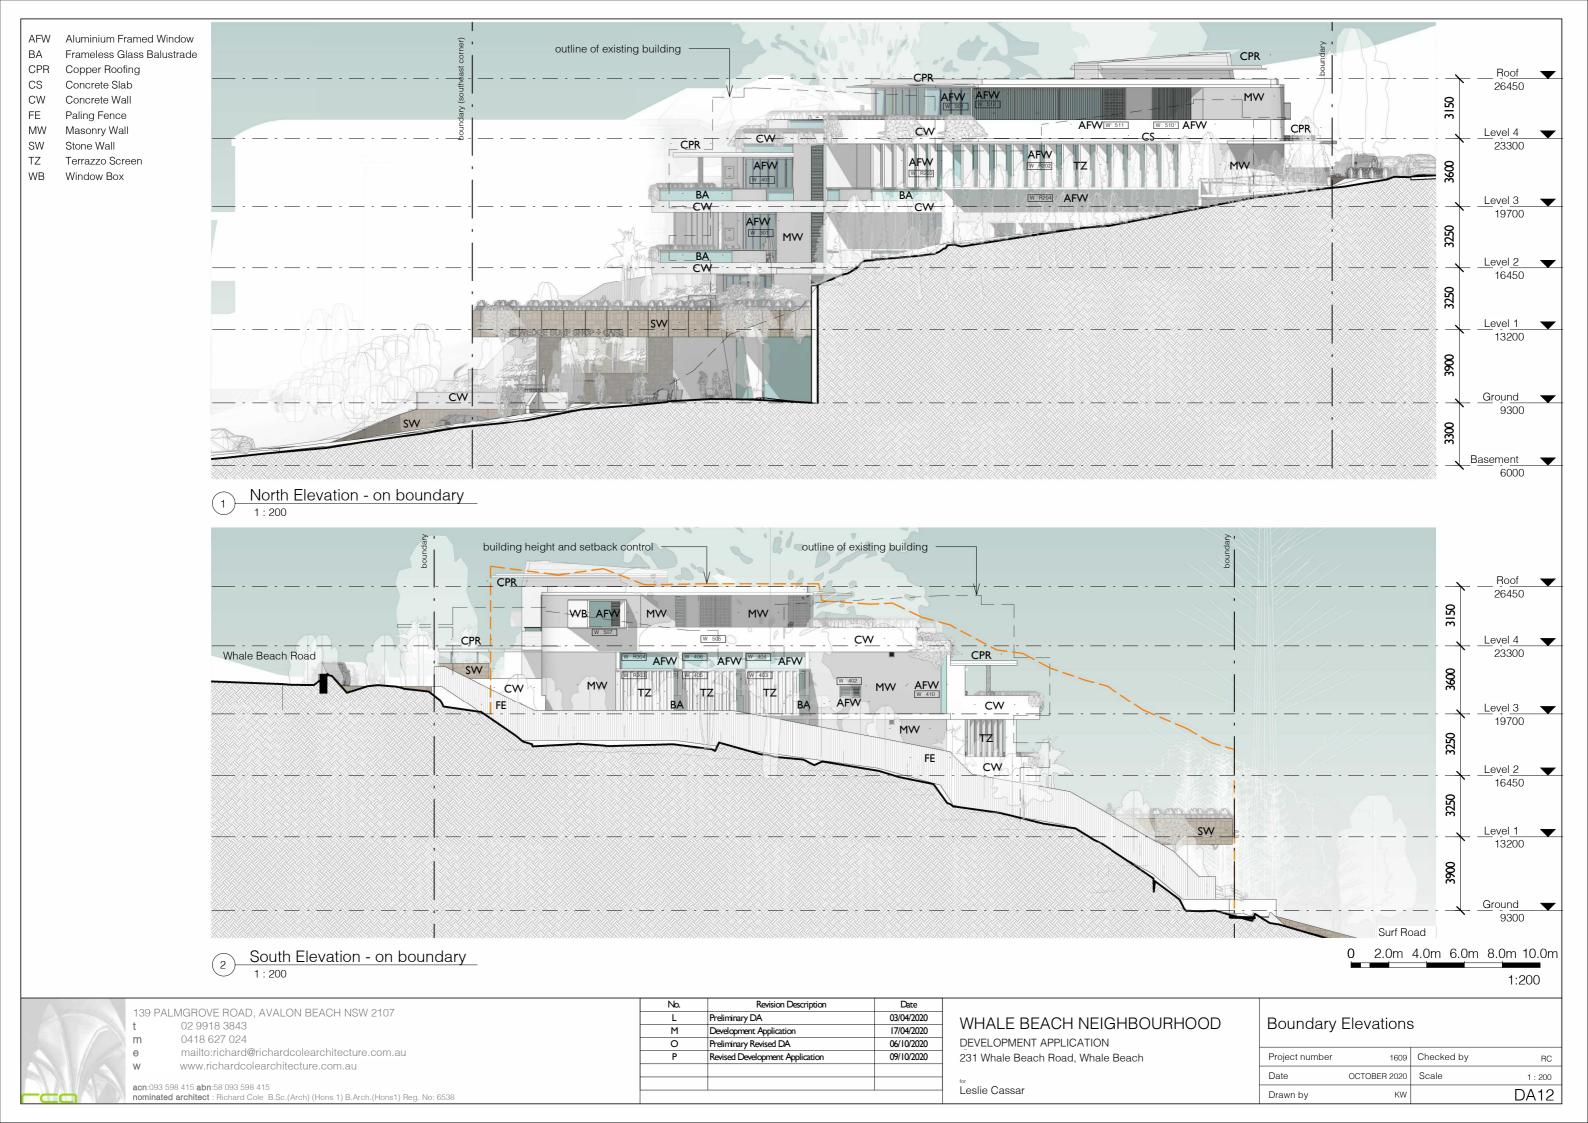

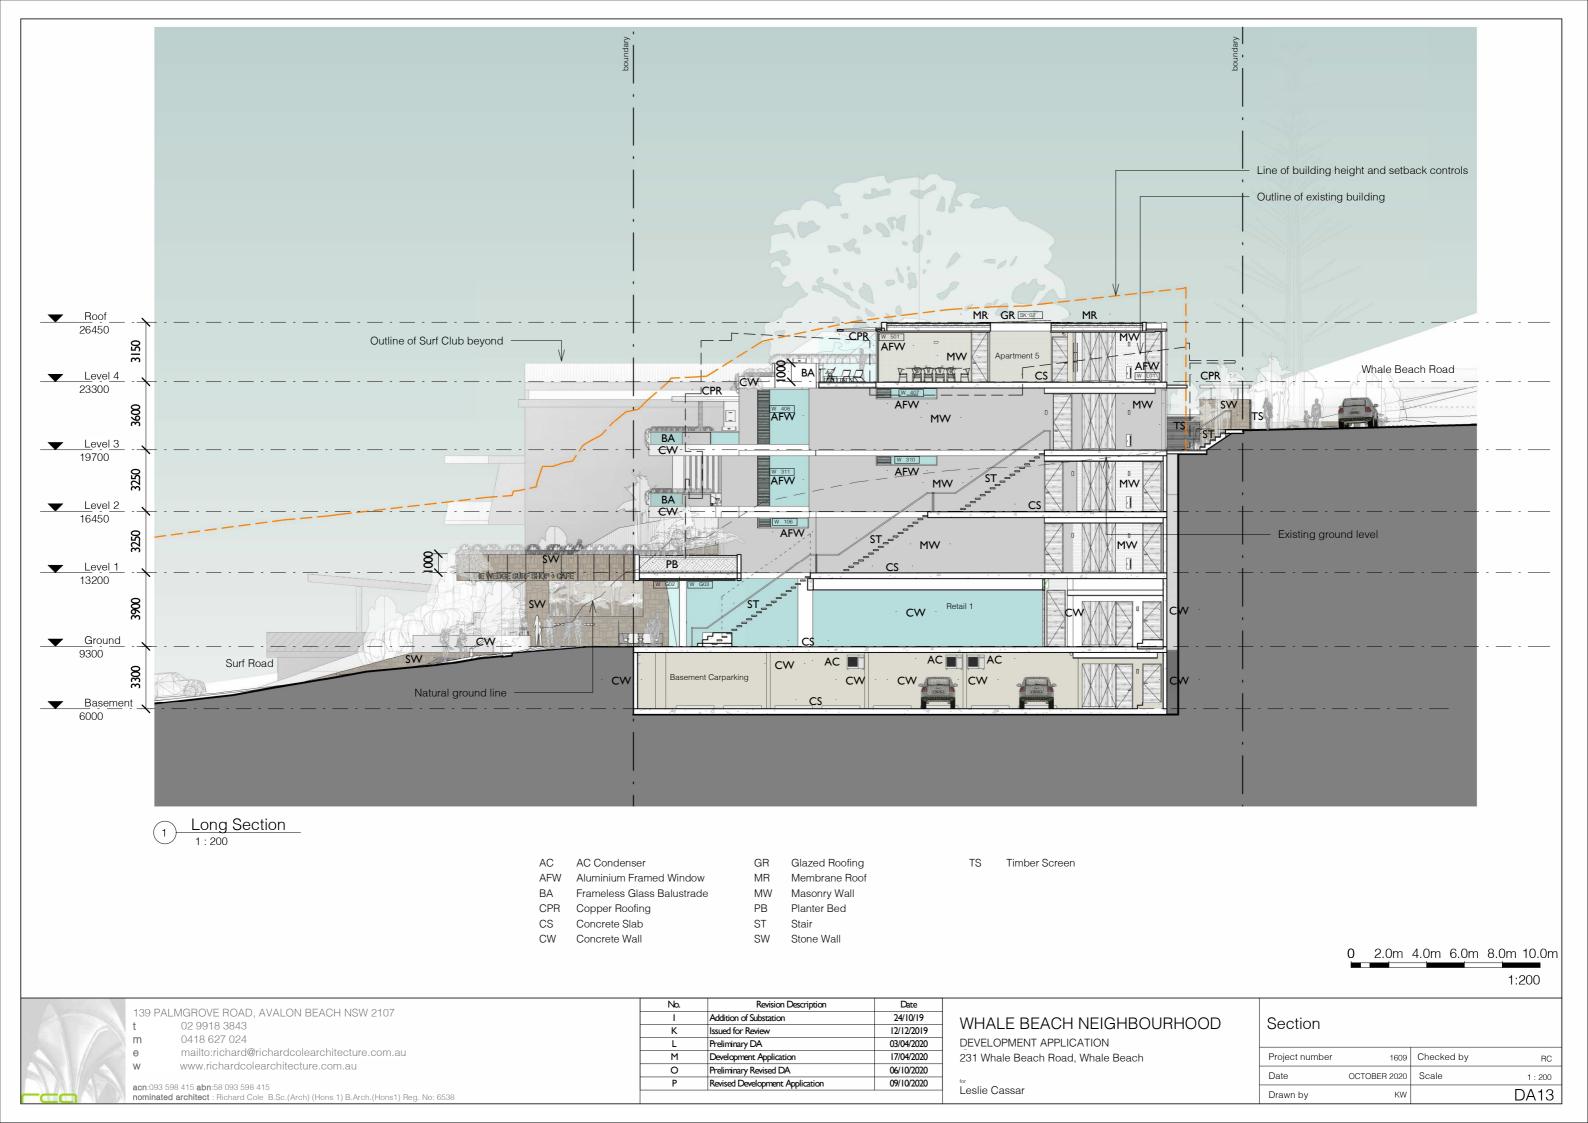

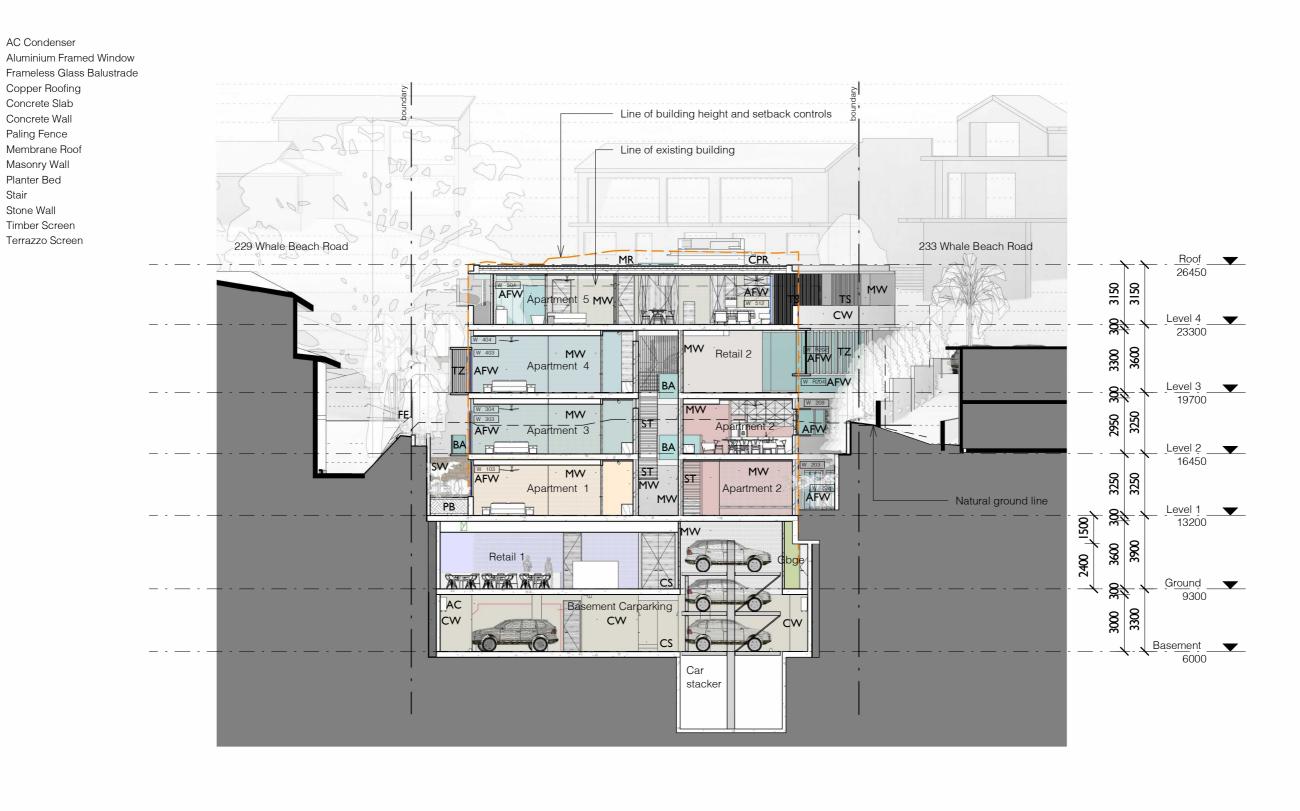

t 02 9918 3843 m 0418 627 024

CPR

CS

CW

FE

MR

MW

PΒ

ST

TS

mailto:richard@richardcolearchitecture.com.au

www.richardcolearchitecture.com.au

acn:093 598 415 abn:58 093 598 415 nominated architect : Richard Cole B.Sc.(Arch) (Hons 1) B.Arch.(Hons1) Reg. No: 6538

Cross Section 1

 No.
 Revision Description
 Date

 I
 Addition of Substation
 24/10/19

 K
 Issued for Review
 12/12/2019

 L
 Preliminary DA
 03/04/2020

 M
 Development Application
 17/04/2020

 O
 Preliminary Revised DA
 06/10/2020

 P
 Revised Development Application
 09/10/2020

## WHALE BEACH NEIGHBOURHOOD

DEVELOPMENT APPLICATION 231 Whale Beach Road, Whale Beach


101	
Leslie	Cassar

Section	

Project number	1609	Checked by	RC
Date	OCTOBER 2020	Scale	1 : 200
Drawn by	KW		DA14

0 2.0m 4.0m 6.0m 8.0m 10.0m

1:200

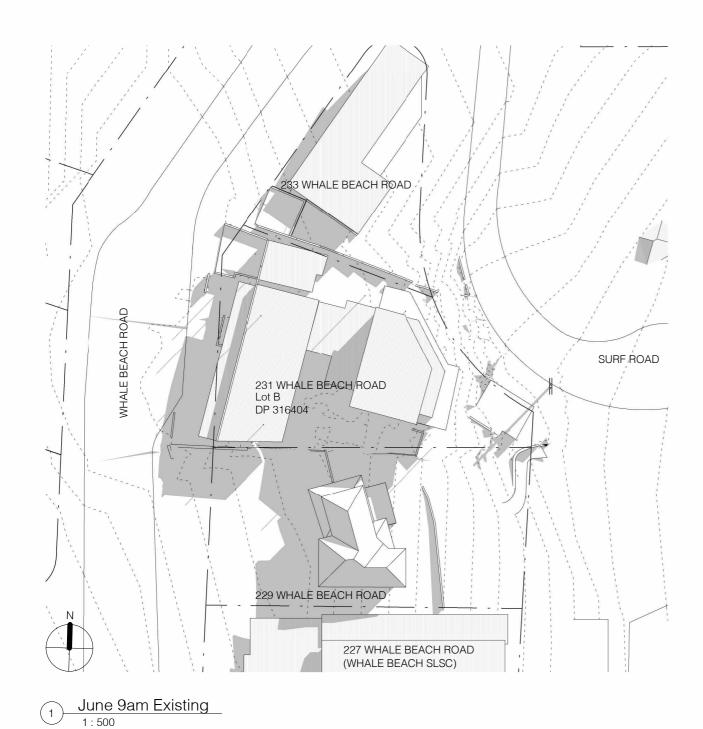

233 WHALE BEACH ROAD WHALE BEACH ROAD SURF ROAD 231 WHALE BEACH ROAD Lot B DP 316404 229 WHALE BEACH ROAD 227 WHALE BEACH ROAD (WHALE BEACH SLSC)

2 June 9am Proposed 1:500 0 5.0m 10.0m 15.0m 20.0m 25.0m

1:500

139 PALMGROVE ROAD, AVALON BEACH NSW 2107

t 02 9918 3843

n 0418 627 024 mailto:richard@richardcolearchitecture.com.au

www.richardcolearchitecture.com.au

acn:093 598 415 abn:58 093 598 415 nominated architect : Richard Cole B.Sc.(Arch) (Hons 1) B.Arch.(Hons1) Reg. No: 6538


	No.	Revision Description	Date
	F	Issued for Consultants	23/08/19
	K	Issued for Review	12/12/2019
ı	L	Preliminary DA	03/04/2020
Ī	М	Development Application	17/04/2020
	Р	Revised Development Application	09/10/2020
ı			

## WHALE BEACH NEIGHBOURHOOD

DEVELOPMENT APPLICATION 231 Whale Beach Road, Whale Beach


Shadow Diagram -	900am June 21

Project number	1609	Checked by	RC
Date	OCTOBER 2020	Scale	1 : 500
Drawn by	KW		DA15

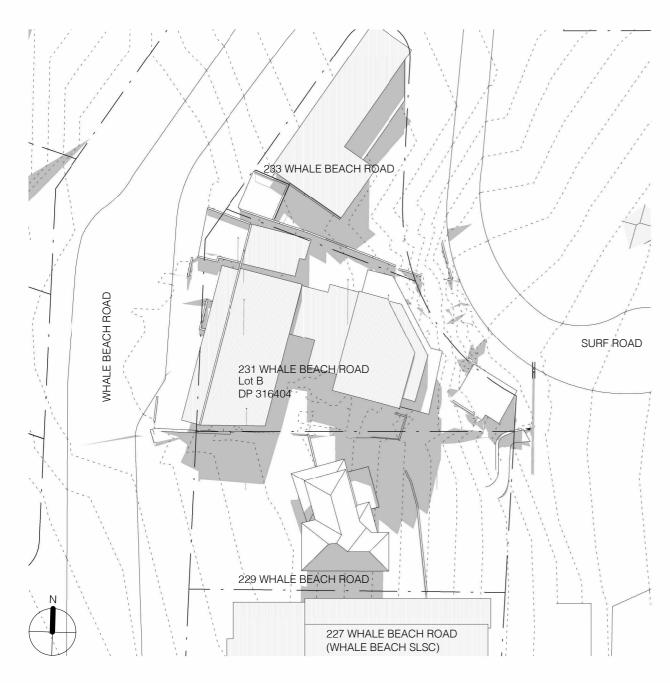

June 12noon Existing

1:500

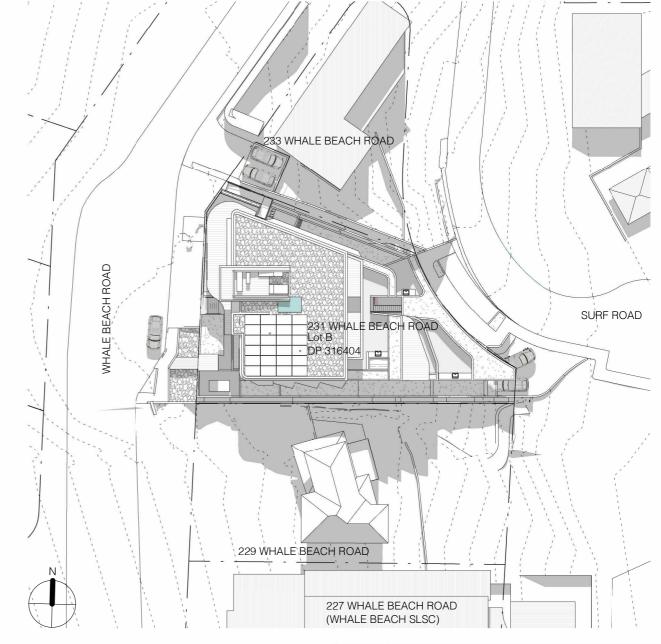

2 June 12noon Proposed 1:500

<b>Ø</b>	in acc     drawr     to ind	tify that the shadow diagrams submitted with this proposal are:  ordance with the Survey (prepared by a registered Surveyor) which is required to be submitted with the proposal;  no true — north  icate shadow cast by the proposal at 9am, noon, 3pm and 21 June  icate the shadow cast by existing buildings and structures on the site and in the surrounding area				
CERTIFIER'S	DETAILS					
Title		O Mr O Mrs	O Miss	Ms Ms	Other:	
Given Names		Karla		Family Name		Wilford
Company		Richard Cole Architecture				
Qualification (i.e Architect, Planner, Consultant, Surveyor)		Architect				

5.0m 10.0m 15.0m 20.0m 25.0m

1:500

139 PALMGROVE ROAD, AVALON BEACH NSW 2107

t 02 9918 3843

0418 627 024

e mailto:richard@richardcolearchitecture.com.au

www.richardcolearchitecture.com.au

acn:093 598 415 abn:58 093 598 415 nominated architect : Richard Cole B.Sc.(Arch) (Hons 1) B.Arch.(Hons1) Reg. No: 6538


No.	Revision Description	Date
F	Issued for Consultants	23/08/19
K	Issued for Review	12/12/2019
L	Preliminary DA	03/04/2020
М	Development Application	17/04/2020
Р	Revised Development Application	09/10/2020

## WHALE BEACH NEIGHBOURHOOD


DEVELOPMENT APPLICATION 231 Whale Beach Road, Whale Beach

Shadow Diagram - 1200noon June 21
-----------------------------------

Project number	1609	Checked by	RC
Date	OCTOBER 2020	Scale	1 : 500
Orawn by	KW		DA16

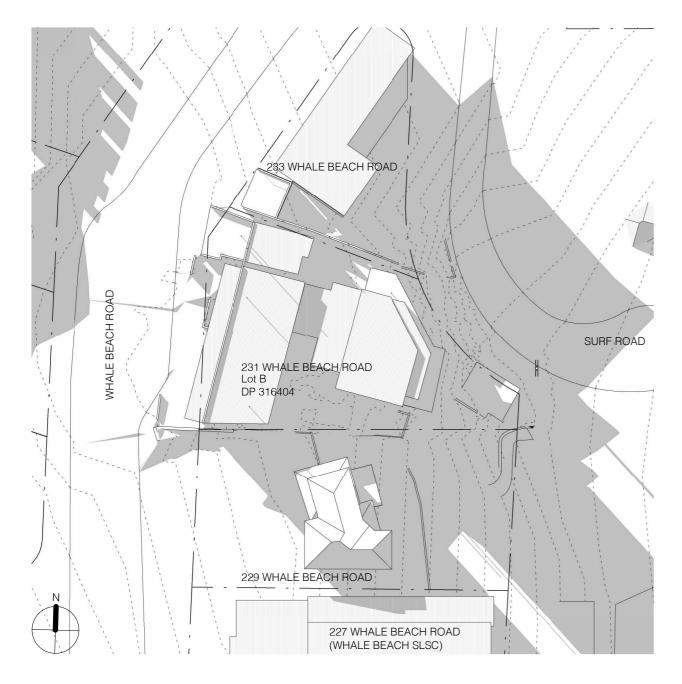

June 3pm Existing

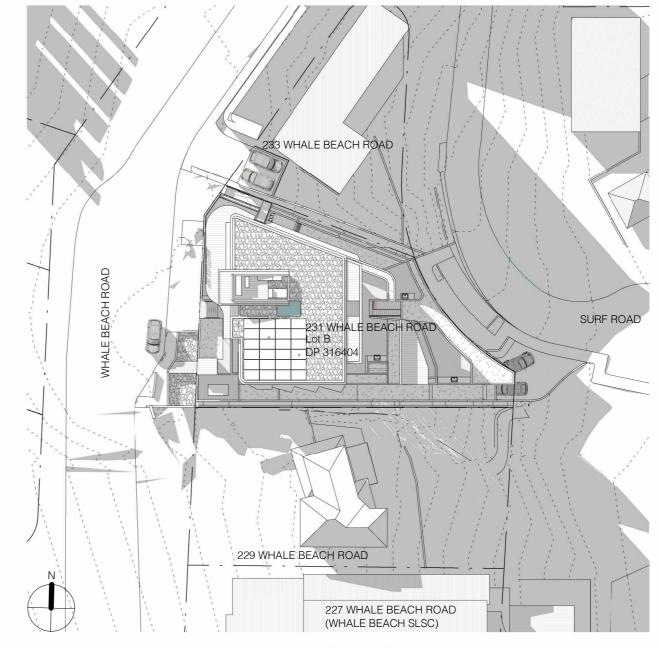

2 June 3pm Proposed 1:500

<b>Ø</b>	in acc     drawr     to ind	rtify that the shadow diagrams submitted with this proposal are: cordance with the Survey (prepared by a registered Surveyor) which is required to be submitted with the proposal; into true – north dicate shadow cast by the proposal at 9am, noon, 3pm and 21 June dicate the shadow cast by existing buildings and structures on the site and in the surrounding area				
CERTIFIER'S	DETAILS					
Title		O Mr O Mrs (	) Miss	Ms Ms	Other:	
Given Names		Karla		Family Name	×4.0	Wilford
Company		Richard Cole Architecture				
Qualification (i.e Architect, Planner, Consultant, Surveyor)		Architect				

5.0m 10.0m 15.0m 20.0m 25.0m

1:500

139 PALMGROVE ROAD, AVALON BEACH NSW 2107

t 02 9918 3843

0418 627 024

mailto:richard@richardcolearchitecture.com.au

www.richardcolearchitecture.com.au

acn:093 598 415 abn:58 093 598 415 nominated architect : Richard Cole B.Sc.(Arch) (Hons 1) B.Arch.(Hons1) Reg. No: 6538

No.	Revision Description	Date
F	Issued for Consultants	23/08/19
K	Issued for Review	12/12/2019
L	Preliminary DA	03/04/2020
М	Development Application	17/04/2020
P	Revised Development Application	09/10/2020

## WHALE BEACH NEIGHBOURHOOD


DEVELOPMENT APPLICATION 231 Whale Beach Road, Whale Beach

Shadow	Diagram	- 300pm	June	21

Project number	1609	Checked by	RC
Date	OCTOBER 2020	Scale	1 : 500
Drawn by	KW		DA17





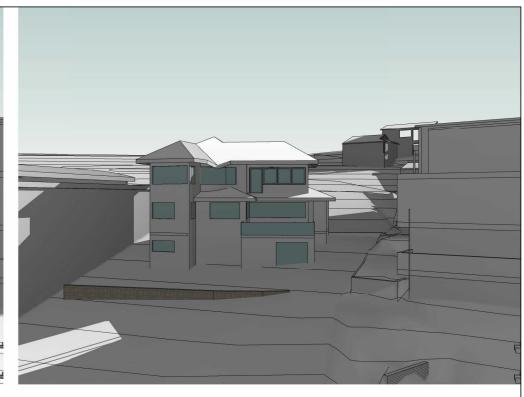


Neighbour - Shadow study 900am - Existing

Neighbour - Shadow study 1200noon - Existing

Neighbour - Shadow study 300pm - Existing





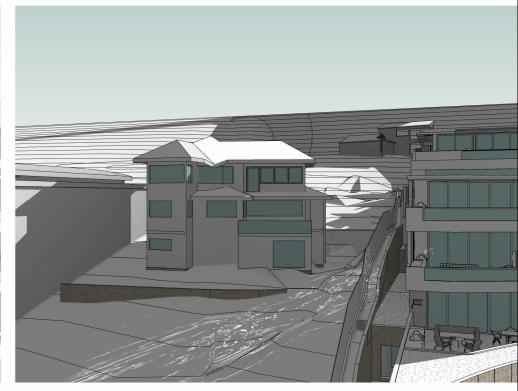

Neighbour - Shadow study 900am

Neighbour - Shadow study 1200noon

Neighbour - Shadow study 300pm

139 PALMGROVE ROAD, AVALON BEACH NSW 2107

t 02 9918 3843

m 0418 627 024

mailto:richard@richardcolearchitecture.com.au

www.richardcolearchitecture.com.au

	acn:093 598 415 abn:58 093 598 415
١	nominated architect : Richard Cole B.Sc.(Arch) (Hons 1) B.Arch.(Hons 1) Reg. No: 6538

No.	Revision Description	Date
F	Issued for Consultants	23/08/19
K	Issued for Review	12/12/2019
L	Preliminary DA	03/04/2020
М	Development Application	17/04/2020
Р	Revised Development Application	09/10/2020

## WHALE BEACH NEIGHBOURHOOD

DEVELOPMENT APPLICATION 231 Whale Beach Road, Whale Beach

Veighbouring	Shadow Studies	

Project number	1609	Checked by	RC
Date	OCTOBER 2020	Scale	
Orawn by	KW		DA18




Solar Access Northern View - June 22 800am



Solar Access Northern View - June 22 1000am



Solar Access Northern View - June 22 900am

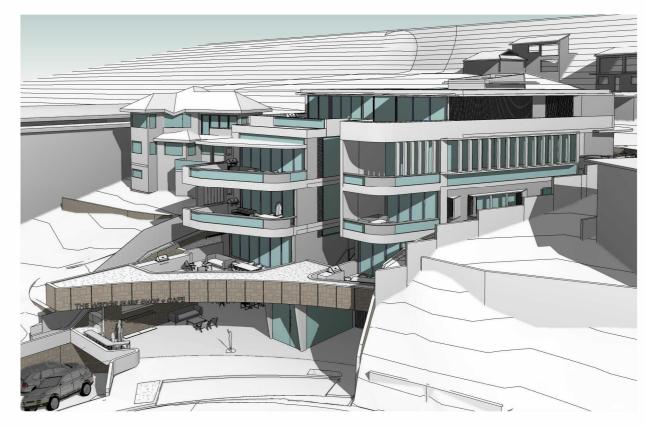

Solar Access Northern View - June 22 1100am

139 PALMGROVE ROAD, AVALON BEACH NSW 2107

t 02 9918 3843

m 0418 627 024

mailto:richard@richardcolearchitecture.com.au

www.richardcolearchitecture.com.au

acn:093 598 415 abn:58 093 598 415 nominated architect : Richard Cole B.Sc.(Arch) (Hons 1) B.Arch.(Hons1) Reg. No: 6538

No.	Revision Description	Date
F	Issued for Consultants	23/08/19
K	Issued for Review	12/12/2019
L	Preliminary DA	03/04/2020
M	Development Application	17/04/2020
Р	Revised Development Application	09/10/2020


## WHALE BEACH NEIGHBOURHOOD

DEVELOPMENT APPLICATION 231 Whale Beach Road, Whale Beach

Leslie Cassar

## Solar Access Study

Project number	1609	Checked by	RC
Date	OCTOBER 2020	Scale	
Drawn by	KW		DA19

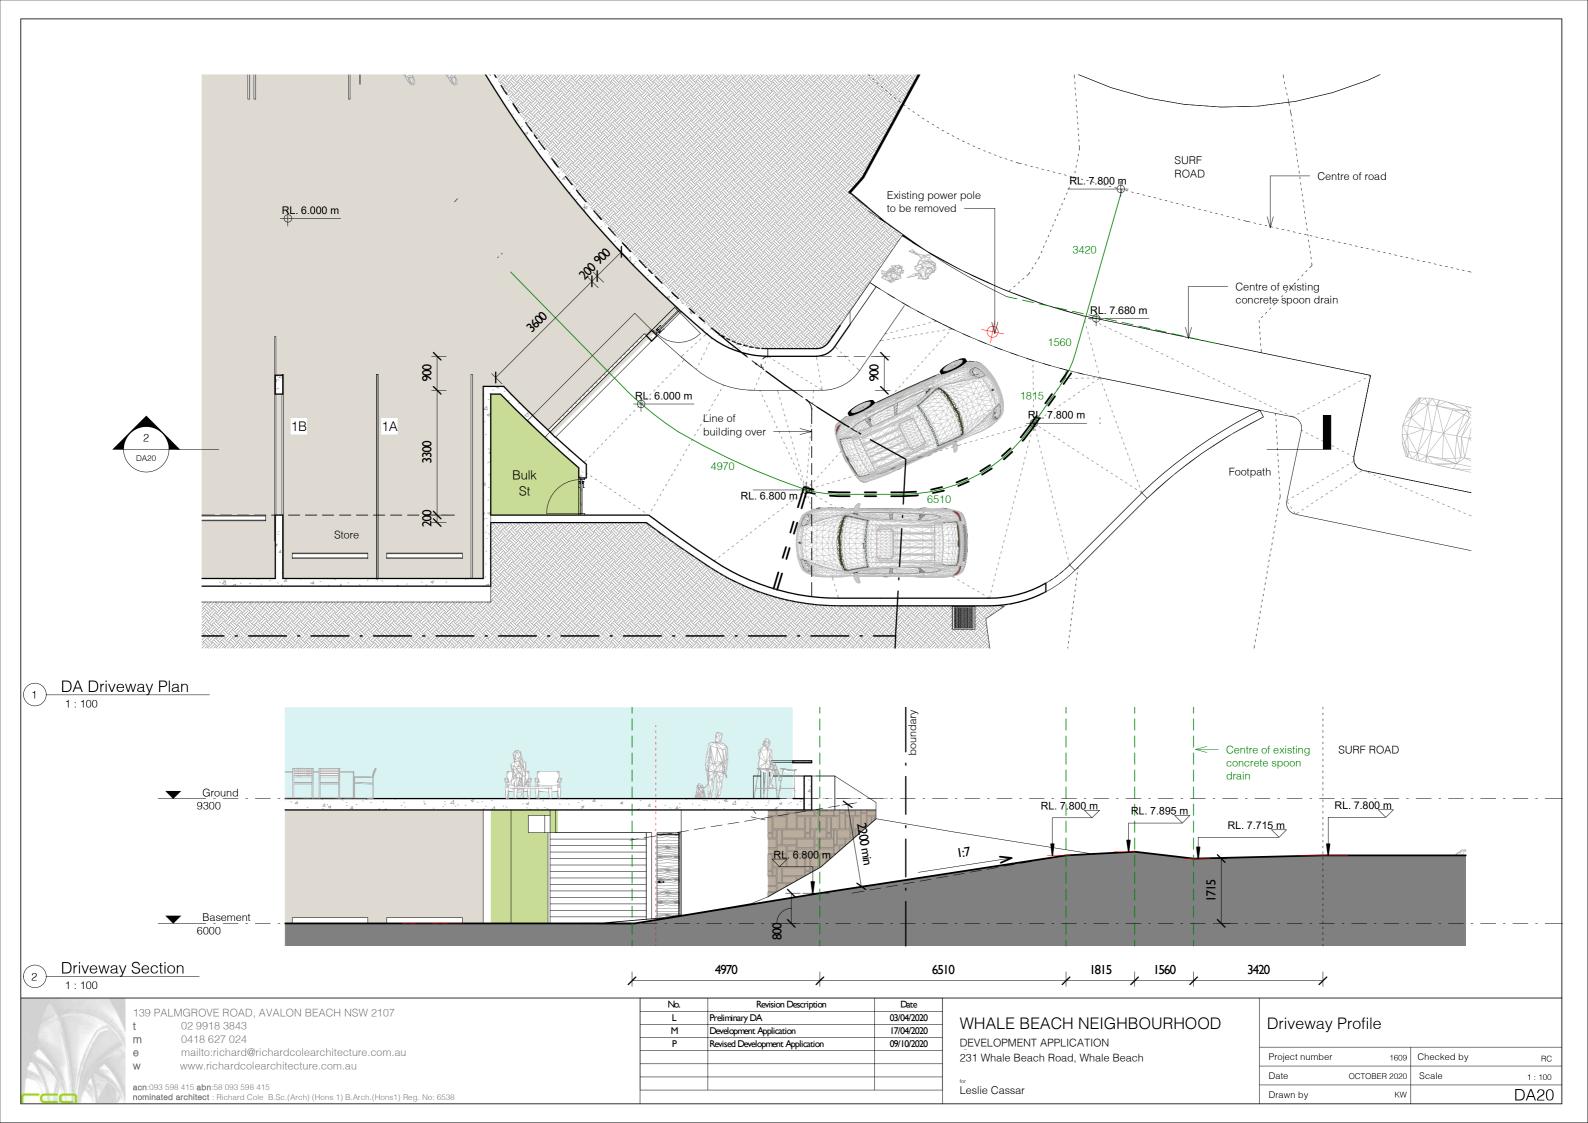





139 PALMGROVE ROAD, AVALON BEACH NSW 2107 t 02 9918 3843 m 0418 627 024

mailto:richard@richardcolearchitecture.com.au

www.richardcolearchitecture.com.au

acn:093 598 415 abn:58 093 598 415 nominated architect : Richard Cole B.Sc.(Arch) (Hons 1) B.Arch.(Hons1) Reg. No: 6538

No.	Revision Description	Date
L	Preliminary DA	03/04/2020
М	Development Application	17/04/2020
P	Revised Development Application	09/10/2020

## WHALE BEACH NEIGHBOURHOOD

DEVELOPMENT APPLICATION 231 Whale Beach Road, Whale Beach

Leslie Cassar

## Photomontage - Whale Beach Road

Project number	1609	Checked by	RC
Date	OCTOBER 2020	Scale	1:1
Drawn by	KW		DA21





VIEW OF EXISTING BUILDING FROM SURF ROAD VIEW OF PROPOSED BUILDING FROM SURF ROAD

139 PALMGROVE ROAD, AVALON BEACH NSW 2107 t 02 9918 3843

0418 627 024

mailto:richard@richardcolearchitecture.com.au

www.richardcolearchitecture.com.au

	acn:093 598 415 abn:58 093 598 415
N	nominated architect: Richard Cole B.Sc.(Arch) (Hons 1) B.Arch.(Hons1) Reg. No: 6538

No.	Revision Description	Date	Γ
М	Development Application	17/04/2020	1
P	Revised Development Application	09/10/2020	1
			1
			1
			1
			1


## WHALE BEACH NEIGHBOURHOOD

DEVELOPMENT APPLICATION 231 Whale Beach Road, Whale Beach

Leslie Cassar

## Photomontage - Surf Road

Project number	1609	Checked by	Checker
Date	OCTOBER 2020	Scale	1:1
Drawn by	Author		DA22

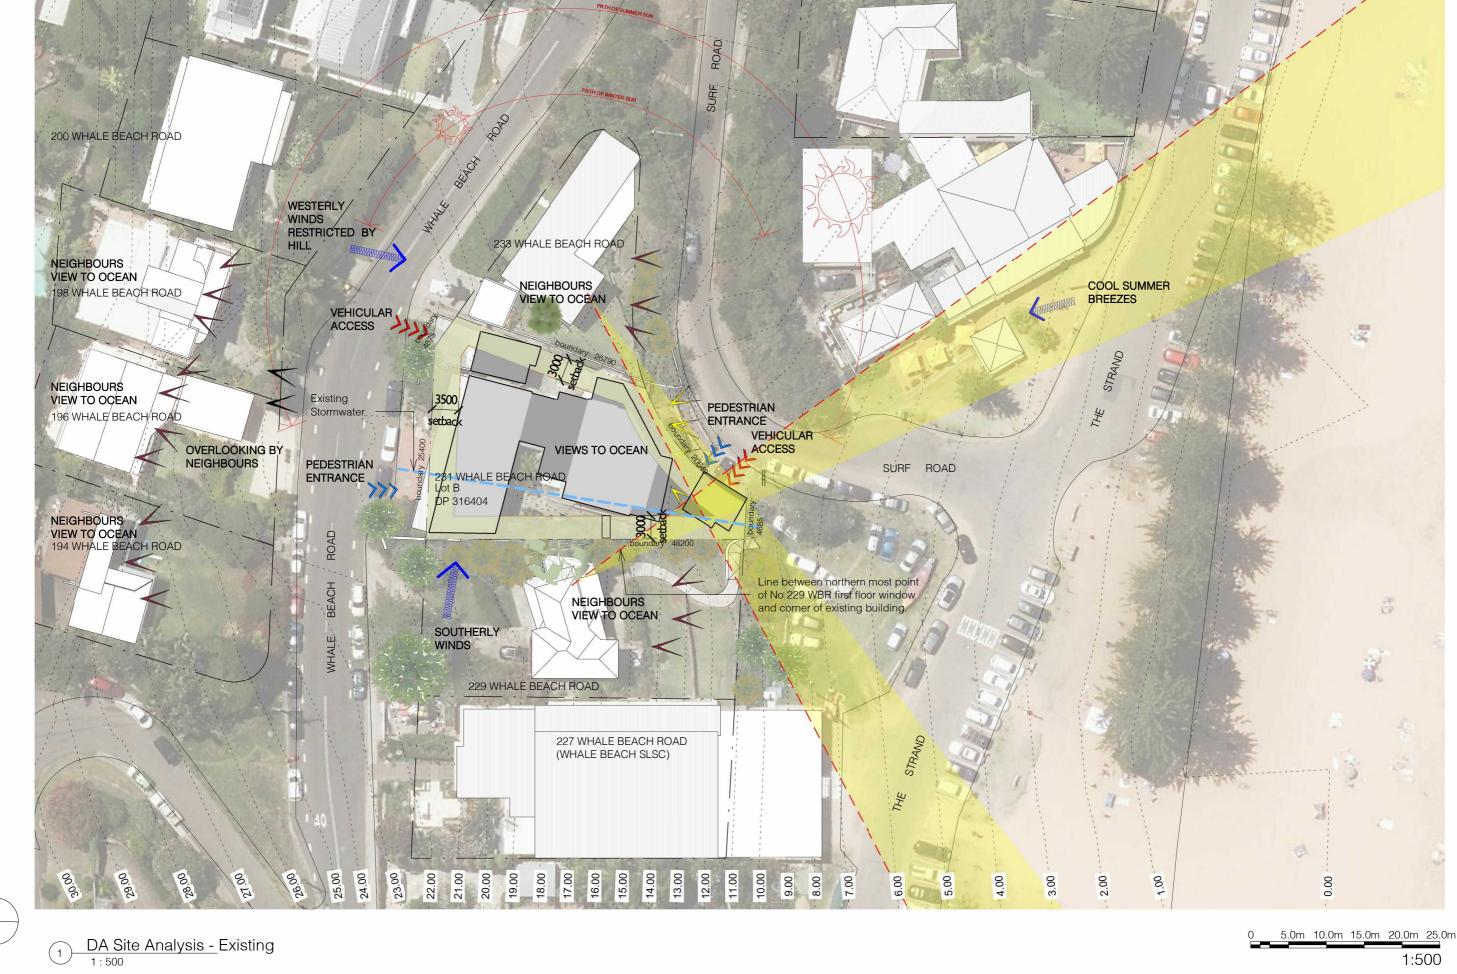



139 PALMGROVE ROAD, AVALON BEACH NSW 2107 t 02 9918 3843

n 0418 627 024 mailto:richard@richardcolearchitecture.com.au

www.richardcolearchitecture.com.au

acn:093 598 415 abn:58 093 598 415 nominated architect : Richard Cole B.Sc.(Arch) (Hons 1) B.Arch.(Hons1) Reg. No: 6538


No.	Revision Description	Date
Н	Issued for Services Consultants	27/09/19
K	Issued for Review	12/12/2019
L	Preliminary DA	03/04/2020
М	Development Application	17/04/2020
Р	Revised Development Application	09/10/2020

## WHALE BEACH NEIGHBOURHOOD

DEVELOPMENT APPLICATION 231 Whale Beach Road, Whale Beach

): <sub>1</sub> -	۸ ا، ، - : -	C
olte	Anaiysis	<ul> <li>Existing</li> </ul>

Project number	1609	Checked by	RC
Date	OCTOBER 2020	Scale	1 : 500
Drawn by	KW		DA23

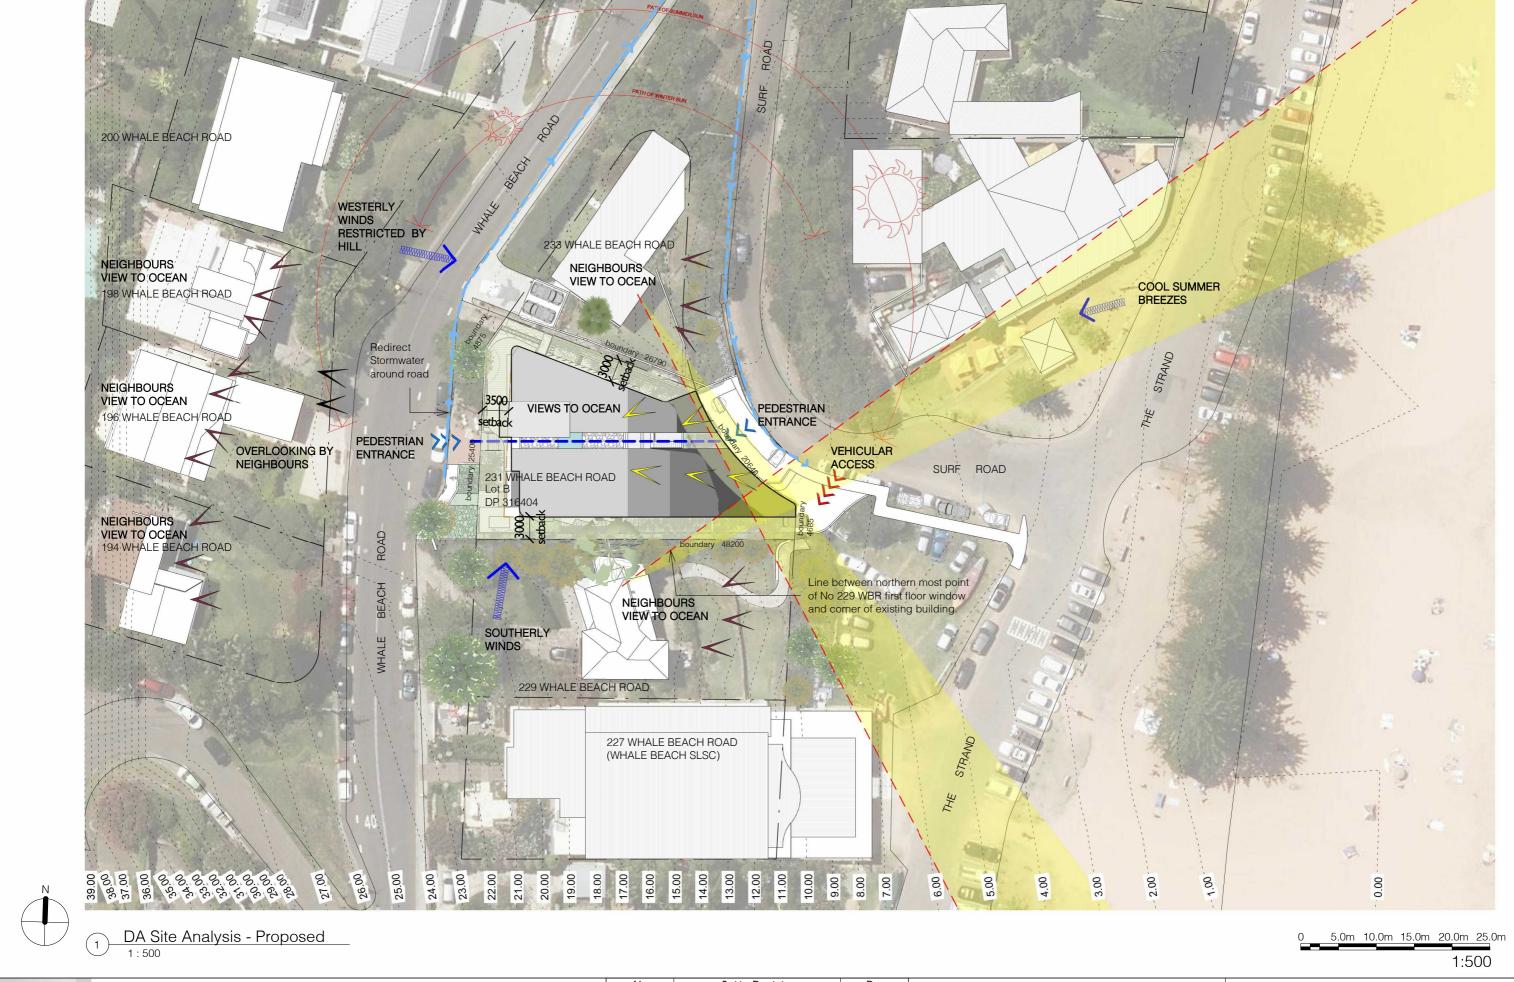

t 02 9918 3843 m 0418 627 024

mailto:richard@richardcolearchitecture.com.au

www.richardcolearchitecture.com.au

acn:093 598 415 abn:58 093 598 415 nominated architect : Richard Cole B.Sc.(Arch) (Hons 1) B.Arch.(Hons1) Reg. No: 6538

No.	Revision Description	Date
L	Preliminary DA	03/04/2020
М	Development Application	17/04/2020
P	Revised Development Application	09/10/2020

## WHALE BEACH NEIGHBOURHOOD

DEVELOPMENT APPLICATION 231 Whale Beach Road, Whale Beach


Leslie Cassar

## Site Analysis - Proposed

 Project number
 1609
 Checked by
 Checker

 Date
 OCTOBER 2020
 Scale
 1 : 500

 Drawn by
 Author
 DA24

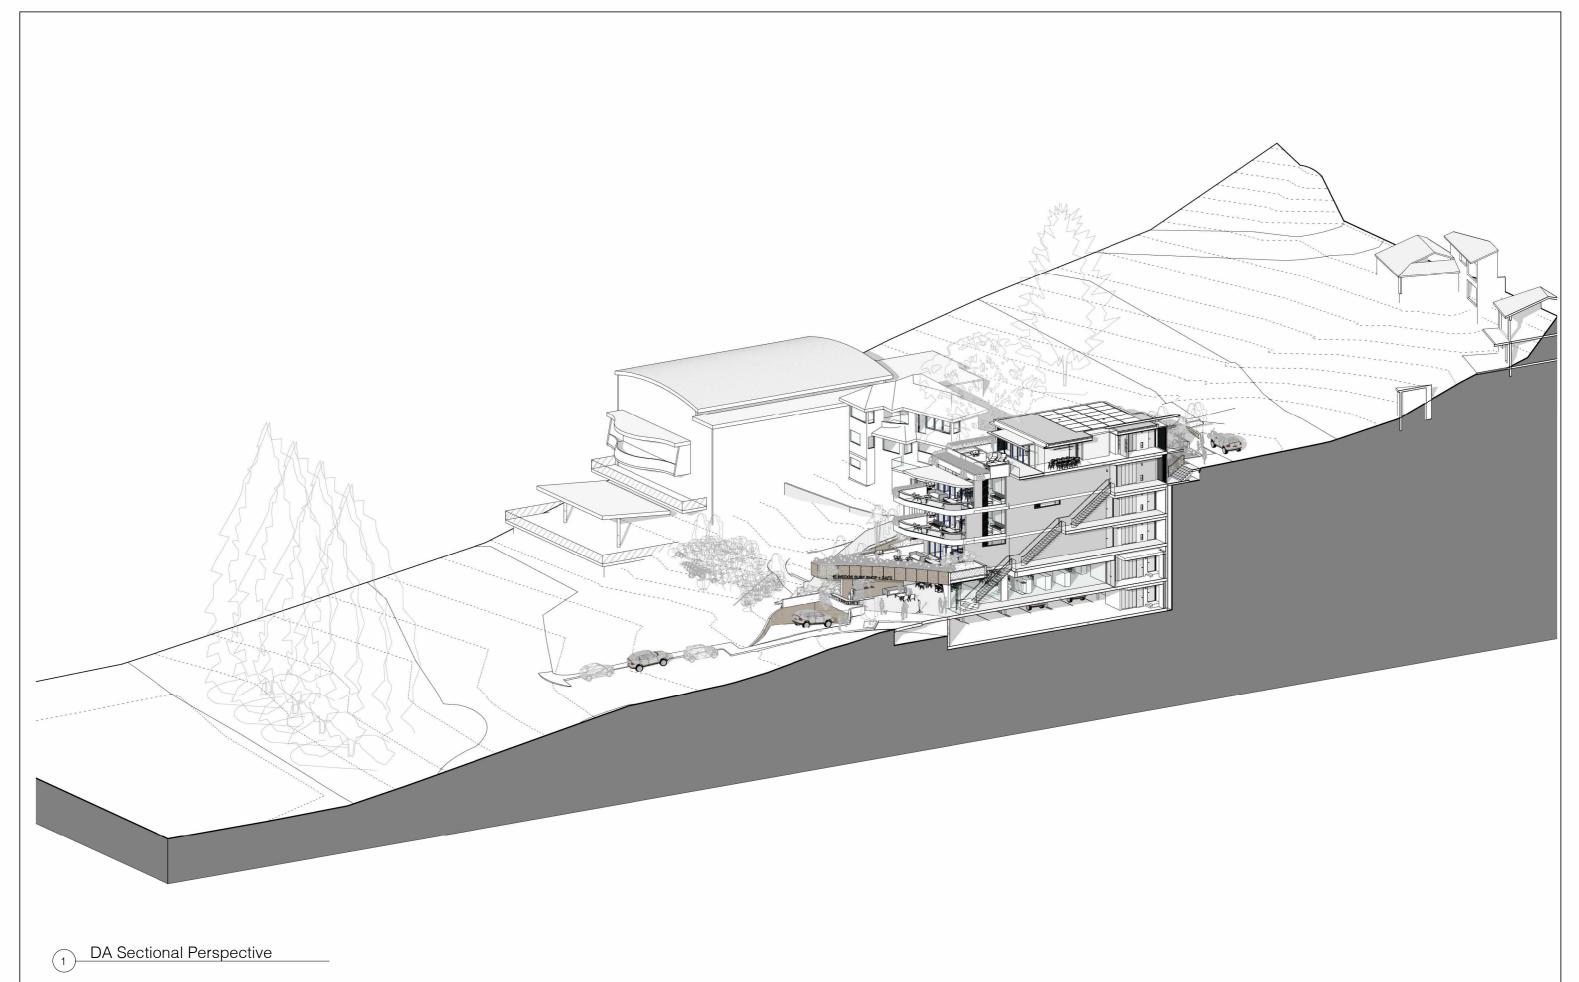

t 02 9918 3843 m 0418 627 024

mailto:richard@richardcolearchitecture.com.au

www.richardcolearchitecture.com.au

acn:093 598 415 abn:58 093 598 415 nominated architect : Richard Cole B.Sc.(Arch) (Hons 1) B.Arch.(Hons1) Reg. No: 6538

# No. Revision Description Date G Issued for discussion with Palm and Whale Beach Association K Issued for Review 12/12/2019 L Preliminary DA 03/04/2020 M Development Application 17/04/2020 P Revised Development Application 09/10/2020

## WHALE BEACH NEIGHBOURHOOD

DEVELOPMENT APPLICATION 231 Whale Beach Road, Whale Beach

Leslie Cassar

## Sectional Perspective (Site)

Project number	1609	Checked by	RC
Date	OCTOBER 2020	Scale	
Drawn by	KW		DA30

#### **BUILDING HEIGHT** PRIVATE OPEN SPACE OFFSTREET CARPARKING PITTWATER LEP: PITTWATER DCP: PITTWATER DCP: 8.5 metres or less in height For Shop Top Housing, residential flat buildings and multi dwelling housing, private Apartments of 2 or more bedrooms require 2 parking spaces per dwelling. Separate open space at upper levels in the form of front/rear or internal courtyard balconies and visitor parking is to be provided at a rate of 1 space per 3 dwellings rounded up. Secure terraces are required. The dimension of the balcony should be sufficient so that the area bicycle storage facilities must be provided within the building at the rate of 1 bicycle COMPLIES UNIT 1 can be usable for recreational purposes (ie a minimum area of 10m2 and a minimum rack per 3 dwellings. UNIT 2 COMPLIES width of 2.4 metres). First floor balconies along the side boundary must be designed to COMPLIES UNIT 3 limit overlooking and maintain privacy of adjoining residences. Retail/commercial premises require 1 carparking space per 30sqm GLA, plus the **RETAIL 1 COMPLIES** Balconies are prohibited from overhanging public property. number of on street carparking spaces lost by the development. Retail/commercial COMPLIES RETAIL 2 carparking spaces should not be restricted or obstructed (eg behind roller doors) RETAIL 3 **COMPLIES** PRIVATE OPEN SPACE COMPLIES APARTMENT 1 UNIT 4 50 sam Disabled parking is to be provided at the rate of 3% of the required carparking spaces **COMPLIES** APARTMENT 2 UNIT 5 36 sqm or 1 car space, whichever is the greater. APARTMENT 3 27 sqm APARTMENT 4 27 sqm **APARTMENT 5** 72 sqm APARTMENTS 1 - 5 (2 or more bedrooms each) 10 car spaces **COMPLIES COMPLIES VISITORS** 2 car spaces RETAIL (315 sqm) 10 car spaces DENSITY AND SCALE **LANDSCAPE** PITTWATER DCP: PITTWATER LEP TOTAL REQUIRED CAR SPACES: 22 Shop Top Housing in B1 Neighbourhood Centre is a maximum of 1 dwelling/ 150 square For shop top housing, a planter or landscaped area with minimum area of 4m2 is to be provided metres of site area. as a feature at the ground floor of the front building facade. This feature is to be positioned to APARTMENTS 1 - 5 (2 bedrooms each) 10 car spaces soften any hard edges of the building including any ramps, podiums or changes in levels. **VISITORS** 2 car spaces SITE AREA = 844 sgmRETAIL (315 sqm including 1 disabled space) 10 car spaces Number of dwellings = 5 For shop top housing, a minimum landscaped area of 20% of the site area, or 35m2 per dwelling, whichever is the greater, shall be provided. For shop top housing development TOTAL CAR SPACES PROVIDED: 22 **COMPLIES** landscaping is to be provided at the front and rear of the development. For development containing 3 or more dwellings, permanent seating is to be provided in the landscaped area. Above ground gardens are to be incorporated into each dwelling at all levels (other than ground PITTWATER DCP: TOTAL SITE AREA 844 sqm The commercial/retail component of the development must be a minimum of 25% of the gross floor area of the building. REQUIRED LANDSCAPED AREA 168.8 sqm The resubdivision of individual or groups of dwellings subsequent to development consent may be carried out by any method of subdivision including Strata Subdivision, 5 X 35 sqm 175 sqm Community Title Subdivision, or Torrens Title Subdivision. Parking spaces, loading bays, **COMPLIES** and space for any other purpose forming a part of a sole occupancy unit are to be LANDSCAPED AREAS 183.7 sam allocated to the dwelling. Includes 59.5sqm (7%) of deep soil >3m wide ADDITIONAL LANDSCAPED AREA Landscaped areas, access areas and signage not forming part of an individual dwelling 60.3 sqm SIDE & REAR SETBACKS must be included as common Planter Beds greater than 800mm deep PITTWATER DCP: property 3.0m along the adjoining side or rear boundary TOTAL PROPOSED LANDSCAPE AREA 244.4 sqm = 28.9%Gross Floor Area = 1275.77sqm Proposed Retail GLA = 315.12 sqm = 25% **COMPLIES COMPLIES** Where variation is sought to the minimum requirement for commercial floor space, the SOLAR ACCESS FRONT SETBACKS applicant is required to justify that the commercial viability of the centre will not be PITTWATER DCP: PITTWATER DCP: affected in the short or long term and that residents can continue to be provided with a The main private open space of each dwelling and the main private open space of any 3.5m or established building line, whichever is the greater full range of services and facilities. adjoining dwellings are to receive a minimum of 3 hours of sunlight between 9am and 3pm on June 21st. <u>AWNINGS</u> Note that an external terrace has also been provided for the retail space on Level 3 Windows to the principal living area of the proposal, and windows to the principal living PITTWATER DCP: Level 3 Terrace R2 = 18.4 sqm area of adjoining dwellings, are to receive a minimum of 3 hours of sunlight between 9am Continuous footpath awnings should be provided to the street adjoining business and 3pm on June 21st (that is, to at least 50% of the glazed area of those windows). development for weather protection for pedestrians. A landscaped area in the front setback on Whale Beach Road will also be available for Solar collectors for hot water or electricity shall receive at least 6 hours of sunshine Awnings are to comply with the relevant adopted Masterplan for the area. Where there the use of the retail tenant between 8.00am and 4.00pm during mid winter. is no Masterplan, new buildings shall provide awnings setback 3.5m from the face of the Developments should maximise sunshine to clothes drying areas of the proposed street kerb. development or adjoining dwellings. APARTMENT 1 COMPLIES WITH 8:00am to 11:00am COMPLIES WITH 8:00am to 11:00am APARTMENT 2 APARTMENT 3 COMPLIES WITH 8:00am to 11:00am APARTMENT 4 COMPLIES WITH 8:00am to 11:00am APARTMENT 5 COMPLIES WITH 8:00am to 11:00am

139 PALMGROVE ROAD, AVALON BEACH NSW 2107

t 02 9918 3843 m 0418 627 024

**COMPLIES** 

e mailto:richard@richardcolearchitecture.com.au

www.richardcolearchitecture.com.au

acn:093 598 415 abn:58 093 598 415
nominated architect: Richard Cole B.Sc.(Arch) (Hons 1) B.Arch.(Hons 1) Reg. No: 6538

No.	Revision Description	Date
F	Issued for Consultants	23/08/19
K	Issued for Review	12/12/2019
Р	Revised Development Application	09/10/2020

**COMPLIES WITH OBJECTIVES** 

## WHALE BEACH NEIGHBOURHOOD

**COMPLIES** 

DEVELOPMENT APPLICATION 231 Whale Beach Road, Whale Beach

Leslie Cassar

## Compliance Check

Project number	1609	Checked by	RC
Date	OCTOBER 2020	Scale	
Drawn by	KW		DA31



Preliminary DA

Development Application

Revised Development Application

Gross Floor Area Schedule

Ground	154.83
Level 1	317.70
Level 2	294.93
Level 3	289.67
Level 4	218.63
Grand total	1275.77

SITE AREA 844.7 sqm

gross floor area means the sum of the floor area of each floor of a building measured from the internal face of external walls, or from the internal face of walls separating the building from any other building, measured at a height of 1.4 metres above the floor, and includes:

- (a) the area of a mezzanine and
- (b) habitable rooms in a basement or an attic, and
- (c) any shop, auditorium, cinema, and the like, in a basement or attic,
- (d) any area for common vertical circulation, such as lifts and stairs, and
- (e) any basement:
- (ii) vehicular access, loading areas, garbage and services, and
- (f) plant rooms, lift towers and other areas used exclusively for mechanical services or ducting, and
- (g) car parking to meet any requirements of the consent authority (including access to that car parking), and
- (h) any space used for the loading or unloading of goods (including access to it), and
- (i) terraces and balconies with outer walls less than 1.4 metres high, and
- (j) voids above a floor at the level of a storey or storey above.

WHALE BEACH NEIGHBOURHOOD DEVELOPMENT APPLICATION 03/04/2020

231 Whale Beach Road, Whale Beach

Leslie Cassar


17/04/2020

09/10/2020

Project number	1609	Checked by	RC
Date	OCTOBER 2020	Scale	1 : 400
Drawn by	KW		DA32

acn:093 598 415 abn:58 093 598 415 nominated architect : Richard Cole B.Sc.(Arch) (Hons 1) B.Arch.(Hons1) Reg. No: 6538

0418 627 024 mailto:richard@richardcolearchitecture.com.au www.richardcolearchitecture.com.au

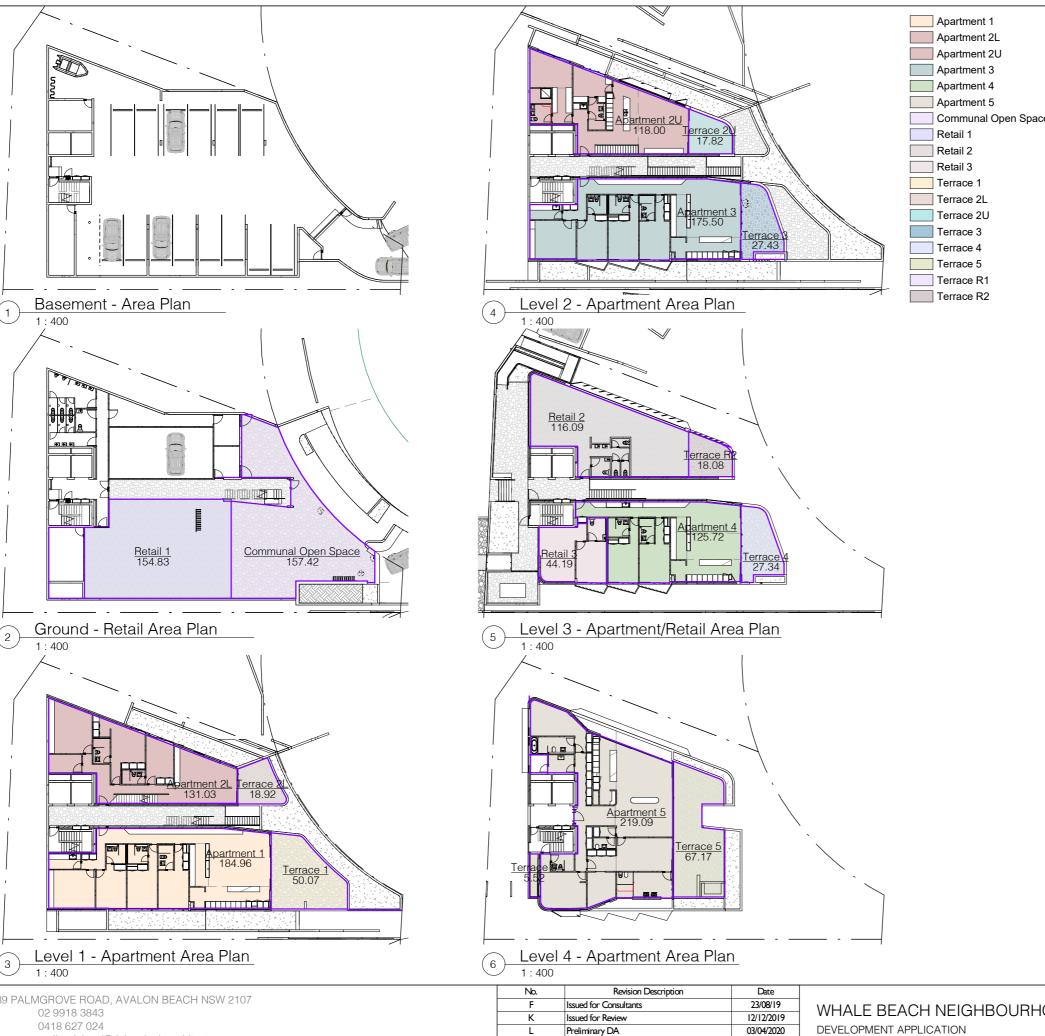

	Area Schedule - Apartments & Tenancies Exterior			
	Level	Name	Area	
	Level 1	Terrace 2L	18.92	
	Level 1	Terrace 1	50.07	
ce	Level 2	Terrace 3	27.43	
	Lavial O	Tarraga OLI	17.00	

Level 1	Terrace 2L	18.92
Level 1	Terrace 1	50.07
Level 2	Terrace 3	27.43
Level 2	Terrace 2U	17.82
Level 3	Terrace R2	18.08
Level 3	Terrace 4	27.34
Level 4	Terrace 5	72.69
Grand total		232.36

Area Schedule - Apartments Interior		
Level	Name	Area

Level 1	Apartment 1	184.96
Level 1	Apartment 2L	131.03
Level 2	Apartment 2U	118.00
Level 2	Apartment 3	175.50
Level 3	Apartment 4	125.72
Level 4	Apartment 5	219.09

Grand total

Area Schedule - Retail Interior				
Level Name Area				

954.31

Ground	Retail 1	154.83
Level 3	Retail 2	116.09
Level 3	Retail 3	44.19
O		015 10

Grand total 315.12

No.	Revision Description	Date
F	Issued for Consultants	23/08/19
K	Issued for Review	12/12/2019
L	Preliminary DA	03/04/2020
М	Development Application	17/04/2020
P	Revised Development Application	09/10/2020

## WHALE BEACH NEIGHBOURHOOD

231 Whale Beach Road, Whale Beach

Leslie Cassar

Area Calc	ulations		
Project number	1609	Checked by	RC
Date	OCTOBER 2020	Scale	1 : 400


KW


Drawn by

DA33

acn:093 598 415 abn:58 093 598 415 nominated architect : Richard Cole B.Sc.(Arch) (Hons 1) B.Arch.(Hons1) Reg. No: 6538

139 PALMGROVE ROAD, AVALON BEACH NSW 2107 0418 627 024 mailto:richard@richardcolearchitecture.com.au www.richardcolearchitecture.com.au

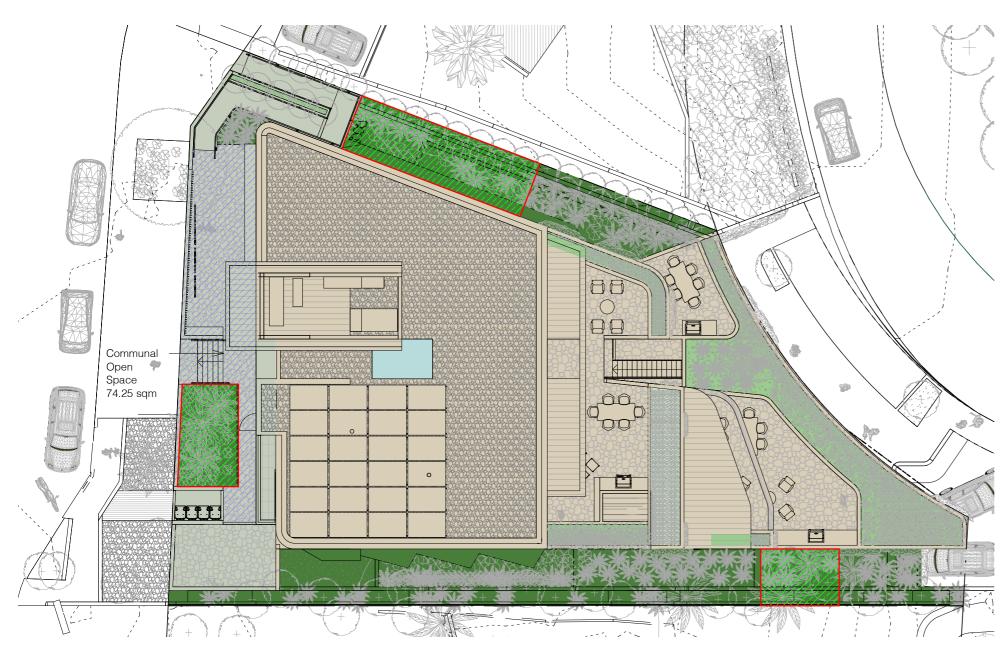

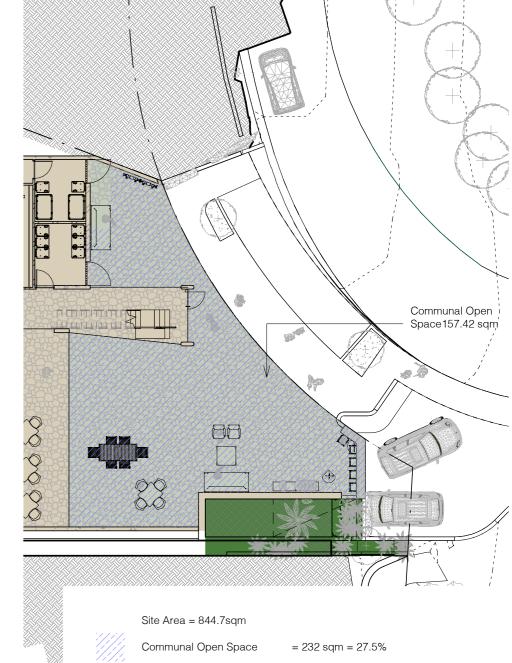

## **LANDSCAPE**

For shop top housing, a planter or landscaped area with minimum area of 4m<sup>2</sup> is to be provided as a feature at the ground floor of the front building facade. This feature is to be positioned to soften any hard edges of the building including any ramps, podiums or changes in levels.

For shop top housing, a minimum landscaped area of 20% of the site area, or 35m2 per dwelling, whichever is the greater, shall be provided. For shop top housing development landscaping is to be provided at the front and rear of the development. For development containing 3 or more dwellings, permanent seating is to be provided in the landscaped area.

Above ground gardens are to be incorporated into each dwelling at all levels (other than ground floor).

Residential Flat Buildings, Multi Dwelling Housing and Shop Top Housing

Provided the outcomes of this control are achieved, and the bulk and scale of the development is not increased, the following may be permitted: Areas with soil depth greater than 800mm above built structures (excluding drainage and waterproof membranes) may be included as landscaped area. Soil depths above built structures less than this will not be included as landscaped area.

**TOTAL SITE AREA** 844 sqm

REQUIRED LANDSCAPED AREA 168.8 sqm 5 X 35 sqm 175 sqm

Pittwater LEP Definition:

"landscaped area" means a part of a site used for growing plants, grasses and trees, but does not include any building, structure or hard paved area.



(planter beds less than 800mm deep)

= 183.7 sqm = 21.7%

= 59.5 sqm = 7.0%

Paths and recreation areas

> 3m wide as required by Apartment Design Guide

Additional Landscaped Area = 60.3 sqm = 7.0% (planter beds greater than 800mm deep)

Total Proposed Landscaped Area = 244 sqm = 28.9%

within landscaped area

Additional Planter Beds

Landscaped Area

Deep Soil Planting

0 2.0m 4.0m 6.0m 8.0m 10.0m

1:200



139 PALMGROVE ROAD, AVALON BEACH NSW 2107

02 9918 3843

0418 627 024 mailto:richard@richardcolearchitecture.com.au

www.richardcolearchitecture.com.au

acn:093 598 415 abn:58 093 598 415 nominated architect : Richard Cole B.Sc.(Arch) (Hons 1) B.Arch.(Hons1) Reg. No: 6538

No.	Revision Description	Date
F	Issued for Consultants	23/08/19
K	Issued for Review	12/12/2019
L	Preliminary DA	03/04/2020
М	Development Application	17/04/2020
P	Revised Development Application	09/10/2020


## WHALE BEACH NEIGHBOURHOOD

DEVELOPMENT APPLICATION 231 Whale Beach Road, Whale Beach

Project number	1609	Checked by	RC
Date	OCTOBER 2020	Scale	1 : 200
Drawn by	KW		DA34





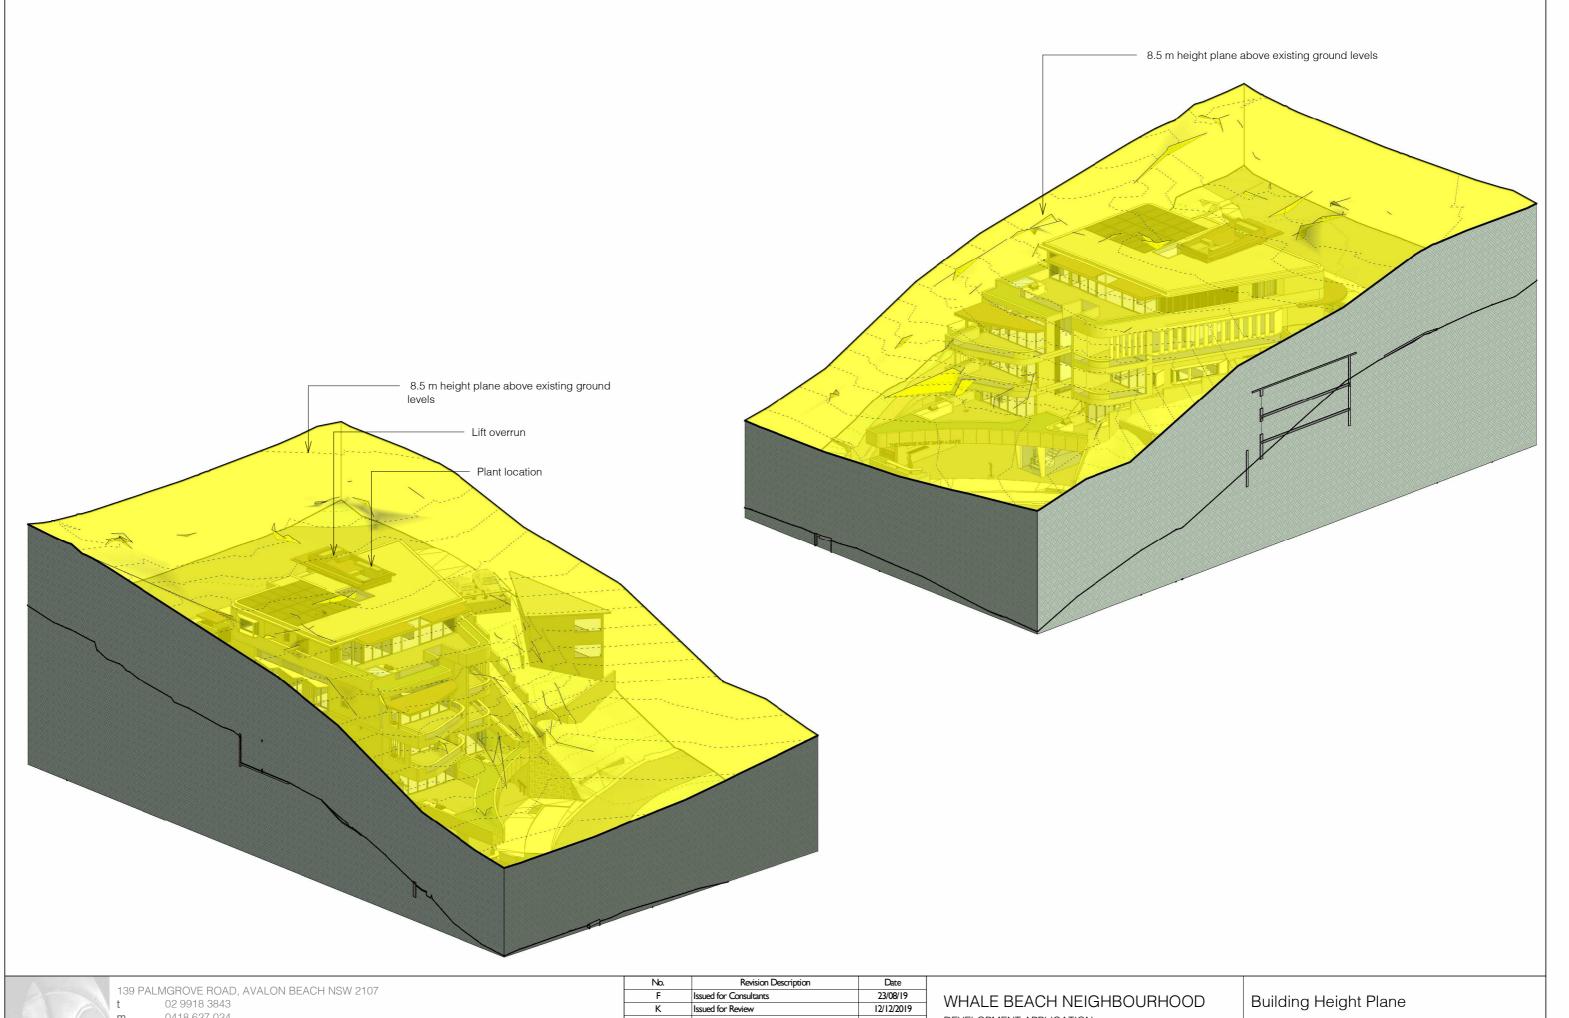

0418 627 024

mailto:richard@richardcolearchitecture.com.au

www.richardcolearchitecture.com.au

acn:093 598 415 abn:58 093 598 415 nominated architect : Richard Cole B.Sc.(Arch) (Hons 1) B.Arch.(Hons1) Reg. No: 6538

No.	Revision Description	Date
F	Issued for Consultants	23/08/19
K	Issued for Review	12/12/2019
L	Preliminary DA	03/04/2020
М	Development Application	17/04/2020
P	Revised Development Application	09/10/2020

## DEVELOPMENT APPLICATION

231 Whale Beach Road, Whale Beach

Project number	1609	Checked by	RC
Date	OCTOBER 2020	Scale	
Drawn by	KW		DA37

Type Mark	Mark	Keynote	Orientation	Area	Length	Unconnected Height	Comments
W	101	AFW	E	21.00	7120	2950	owning
W	102	AFW	S	0.67	1110	600	awning
W	103	AFW	S	6.26	3260	1950	
W	103	AFW	S	6.24	3300	1950	
W	105	AFW	S	3.69	2040	1950	
W	106	AFW	N	1.51	2743	550	
W	201	AFW	E	10.93	3846	2950	awning
W	202	AFW	NE	3.36	1600	2100	awi iii g
W	203	AFW	NE	5.88	2800	2100	
W	204	AFW	NE	2.64	1100	2400	
W	205	AFW	NE	5.17	1950	2650	+
W	206	AFW	E	14.02	5041	2950	awning
W	207	AFW	NE	8.64	3600	2400	awning
W	208	AFW	NE	5.76	2500	2400	awning
W	209	AFW	NE	7.84	5600	1400	external screen
W	210	AFW	NE	1.54	1100	1400	external screen
W	301	AFW	E	21.55	7304	2950	
W	302	AFW	S	0.67	1110	600	awning
W	302	AFW	S	7.38	3210	2300	
		_					+
W W	304	AFW	S	2.08	3200	651	
W	305 306	AFW	S	7.36	3200 3200	2300 650	
W			+				
W	307 308	AFW	S	7.36	3199 3260	2300 650	
W			S			600	
W	309	AFW		1.68	2800		
W	310	AFW	N N	7.29	3230 2751	500 2650	
W	401	AFW	E	18.98	7299	2600	owning
W	402	AFW	S			600	awning
W		AFW		0.67	1110		ovtornal caroon
W	403	AFW	S	7.38 2.89	3360	2300	external screen
W	405	AFW	S	7.36	3260	900 2300	ovtornal agraen
W					3250		external screen
W W	406 407	AFW	S N	2.88 1.86	3300 3230	900 575	
W						2925	
W W	408	AFW	N	8.05	2753	575	
W	409	AFW	E S	1.00	7477 302	3300	
W	501	AFW	E	21.13	7825	2700	awning
W	502	AFW	_				awning
W W	503	AFW	E	9.52 7.11	3527 2635	2700 2700	awning
W	503	AFW	S	3.24	1200	2700	external screen
		_	S				
W W	505	AFW	SE	4.60	1755	2700	external screen
	506	AFW		1.02	600	1700	external screen
W w	507	AFW	S	4.20	3000	1400	awning
W	508	AFW	W	6.89	2550	2700	external screen
W	509	AFW	W	5.42	6780	800	awning
W	510	AFW	NE	6.09	2257	2700	external screen
W	511	AFW	W	3.24	1200	2700	+
W	512	AFW	N	18.81	6965	2700	external screen
W	513	AFW	W	0.77	550	1700	
W	G01	AFW		19.12	5168	3700	
W	G02	AFW		10.36	2800	3700	

	Window Schedule for BASIX							
Type Mark	Mark	Keynote	Orientation	Area	Length	Unconnected Height	Comments	
W	G03	AFW		22.01	5948	3700		
W	L01	AFW	W	5.66	2335	2700	external screen	
W	R101	AFW		30.84	10480	3000		
W	R201	AFW	W	22.44	6800	3300	awning	
W	R202	AFW	NE	29.83	12971	2300	external screen	
W	R203	AFW	E	15.62	4734	3300	awning	
W	R204	AFW	NE	11.74	13046	900		
W	R301	AFW	W	9.98	3124	3300		
W	R303	AFW	S	7.13	3100	2300	external screen	
W	R304	AFW	S	2.79	3100	900		
W	S01	AFW	W	2.70	1100	2700		

#### Schedule of BASIX Commitments - Refer to BASIX Certificate prepared by Insight Energy

- 1. Commitments for Residential Flat Buildings
  - a. Dwellings

i. Water

The applicant must plant indigenous or low water species of vegetation as specified in the certificate

The project includes a spa with volume of 3 kilolitres

All dwellings must have 4 star rated taps and toilets, and 3 star rated shower heads, dishwashers and clothes washers

ii. Energy

All dwellings to have gas instantaneous hot water

All bathrooms and laundries are to have ducted exhausts manually operated

All kitchens to have manually operated exhaust fans, gas cooktop and electric oven

All dwellings to have 1 phase airconditioning,

Natural lighting is to be provided as shown in the certificate, all other lighting is to be LED

iii. Thermal Comfort

There is no inslab heating proposed

Construction of floor and walls is to be in accordance with the NatHERS Certificate

- b. Common areas and Central Systems/facilities
  - i.Water

A water tank of at least 5000l is to be installed to collect roof water, and to be connected to common garden areas

ii. Energy

Mechanical ventilation is proposed to the carparking area Lighting to the basement is to be fluorescent or LED, connected to sensors or manually operated

#### THERMAL PERFORMANCE REQUIREMENTS

Mixed Use Development - Thermal Assessment for Residential Apartments 1-5
231 Whale Beach Road, Whale Beach NSW 2107

See NatHERs Certificate for full information
Builder to confirm insulation and glazing requirements in NatHERs Certificate prior to construction

All insulation and glazing must meet BCA and Australian Standard requirements

	Construction	Added Insulation	
External walls	270mm Double brick with cavity 200mm Concrete walls  Apartments 1, 2  Apartments 3, 4  - Apartments 1 & 2 - No added to external walls - Apartments 3 & 4 - Fo bubble wrap added to external cavity brick wa common hallway.  No insulation required i external walls.		
Internal walls	100mm single skin brick	No insulation added	
Common Walls	200mm concrete walls separating apartments from stairwell, lift or retail	No insulation added	
External Flooring under Apartments	Suspended concrete slab 300mm thickness	No insulation added	
Ceilings between Floors	Suspended concrete slab 300mm thick with plasterboard lining beneath	Apartments 1-4 – No insulation required	
Ceiling to roof cavity	Apartment 5 – Suspended concrete slab 300mm thick with plasterboard lining beneath	Apartment 5 – R1.5 bulk insulation betwee suspended concrete and plasterboard.	
Roof	Concrete roof above Apartment 5	Waterproofing membrane	
Fixed floor coverings	Tiles to wet areas		
	Carpet to bedrooms		
	Timber flooring to living, dining, kitchen, pantry, hallways, media and other living zones.		
Glazing - All glazing to be in accordance with BCA standards.	Aluminum frames (draft sealed)	W101; W401 - Double glazed, clear/airgap/clear – U-value All remaining glazed doors and windows - Single glazed clear – U-value 6.70 SHGC 0.70	
Ceiling Penetration		This assessment has been rated with LED downlights and exhaust fans	



t 02 9918 3843

0418 627 024

mailto:richard@richardcolearchitecture.com.au

www.richardcolearchitecture.com.au


٧	www.nchardcolearchitecture.com.au
	3 415 <b>abn</b> :58 093 598 415 <b>architect</b> : Richard Cole B.Sc.(Arch) (Hons 1) B.Arch.(Hons1) Reg. No: 6538


No.	Revision Description	Date
F	Issued for Consultants	23/08/19
K	Issued for Review	12/12/2019
L	Preliminary DA	03/04/2020
М	Development Application	17/04/2020
Р	Revised Development Application	09/10/2020

#### WHALE BEACH NEIGHBOURHOOD

DEVELOPMENT APPLICATION 231 Whale Beach Road, Whale Beach

Project number	1609	Checked by	RC
Date	OCTOBER 2020	Scale	
Orawn by	KW		DA39

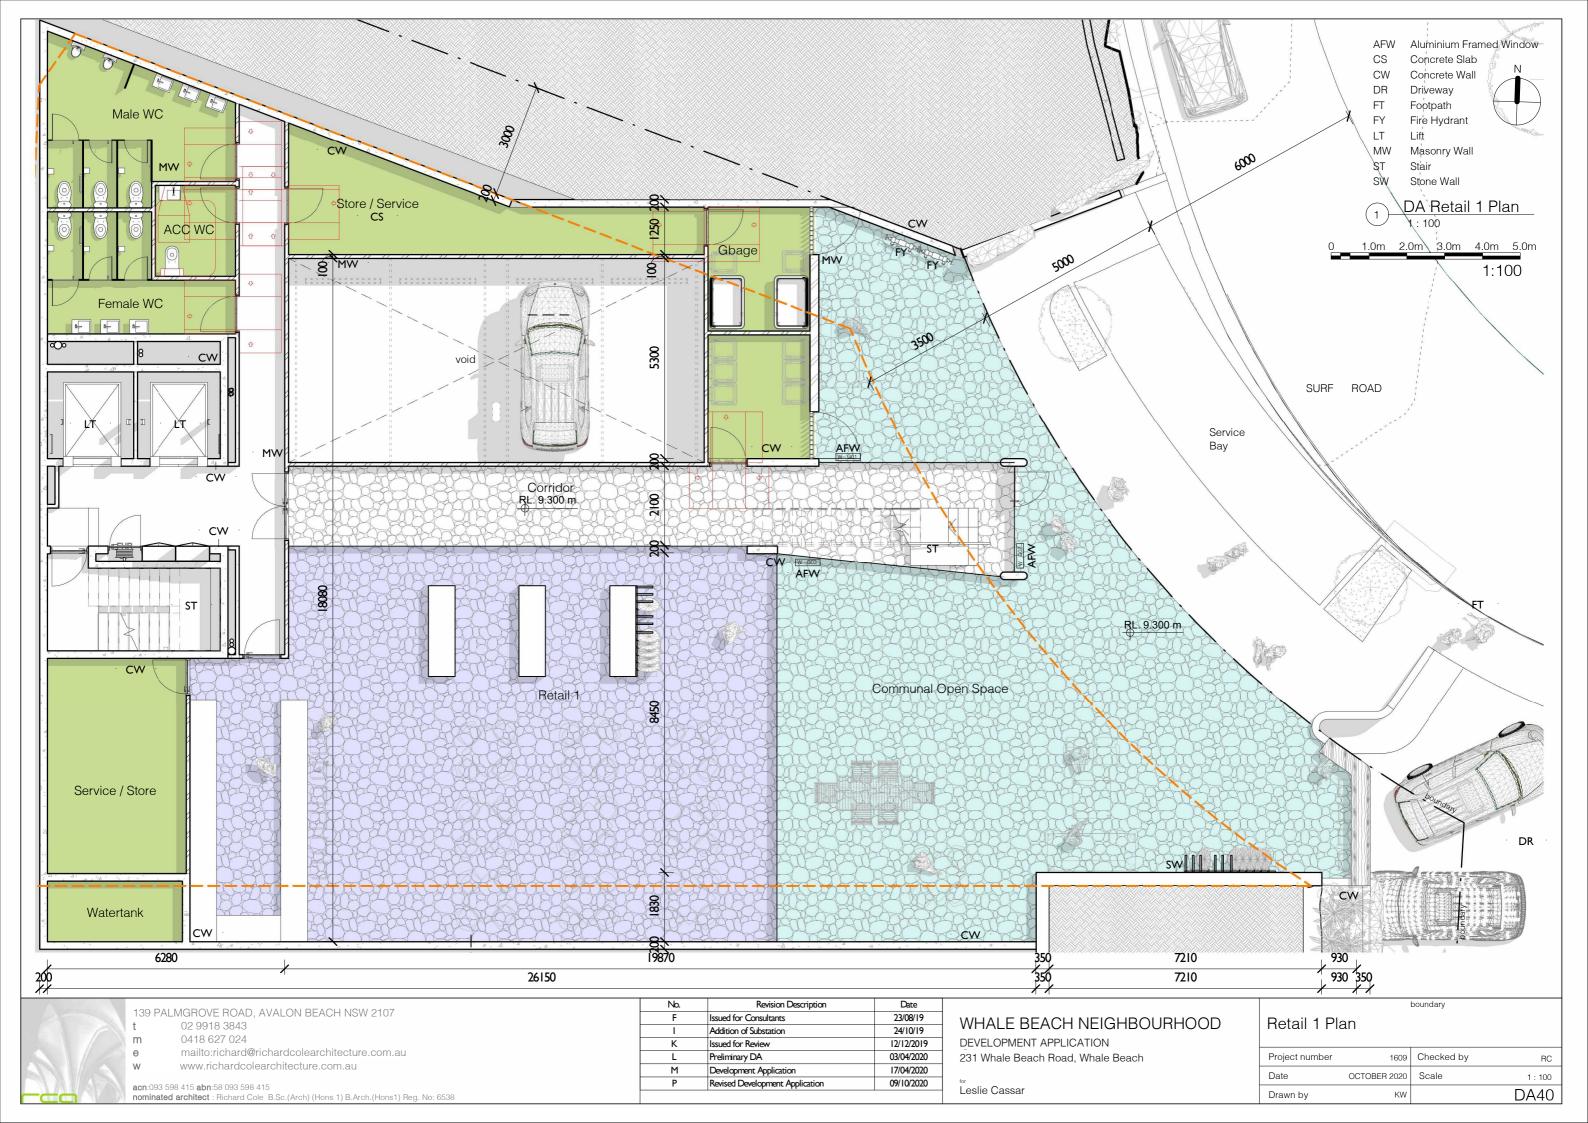

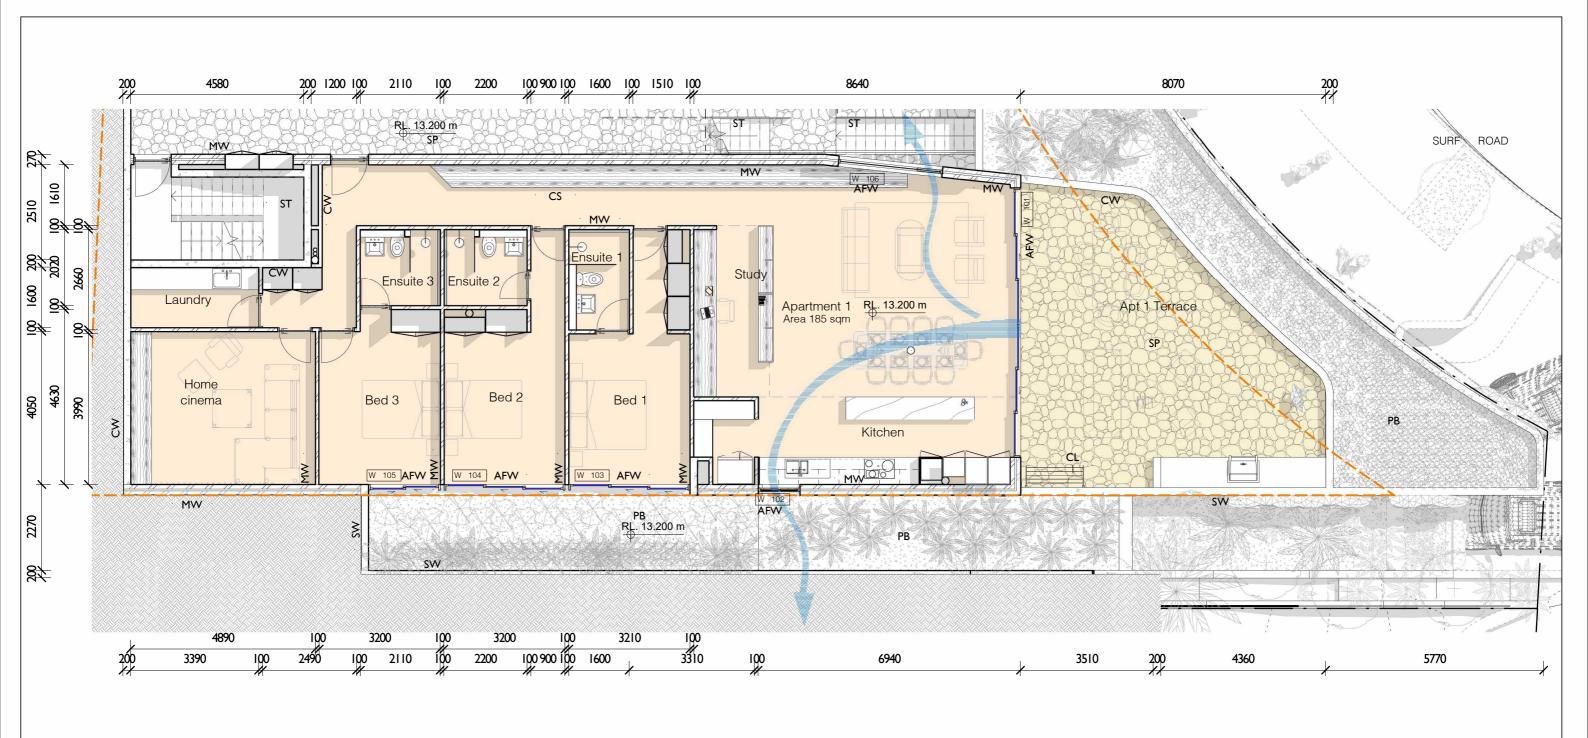

AFW Aluminium Framed Window

CL Clothesline

CS Concrete Slab

CW Concrete Wall

MW Masonry Wall

PB Planter Bed

SP Stone Paving

ST Stair

SW Stone Wall

DA Apartment 1 Plan

0 1.0m 2.0m 3.0m 4.0m 5.0m 1:100

139 PALMGROVE ROAD, AVALON BEACH NSW 2107

t 02 9918 3843

m 0418 627 024

mailto:richard@richardcolearchitecture.com.au

www.richardcolearchitecture.com.au

	acn:093 598 415 abn:58 093 598 415
K	nominated architect : Richard Cole, B.Sc. (Arch) (Hons 1) B. Arch (Hons 1) Beg, No: 6538


No.	Revision Description	Date	Γ
F Issued for Consultants		23/08/19	]
I	Addition of Substation	24/10/19	1
K	Issued for Review	12/12/2019	1
L	Preliminary DA	03/04/2020	1
М	Development Application	17/04/2020	]
Р	Revised Development Application	09/10/2020	

#### WHALE BEACH NEIGHBOURHOOD

DEVELOPMENT APPLICATION 231 Whale Beach Road, Whale Beach


101	
Leslie	Cassar

Project number	1609	Checked by	RC
Date	OCTOBER 2020	Scale	1 : 100
Drawn by	KW		DA41

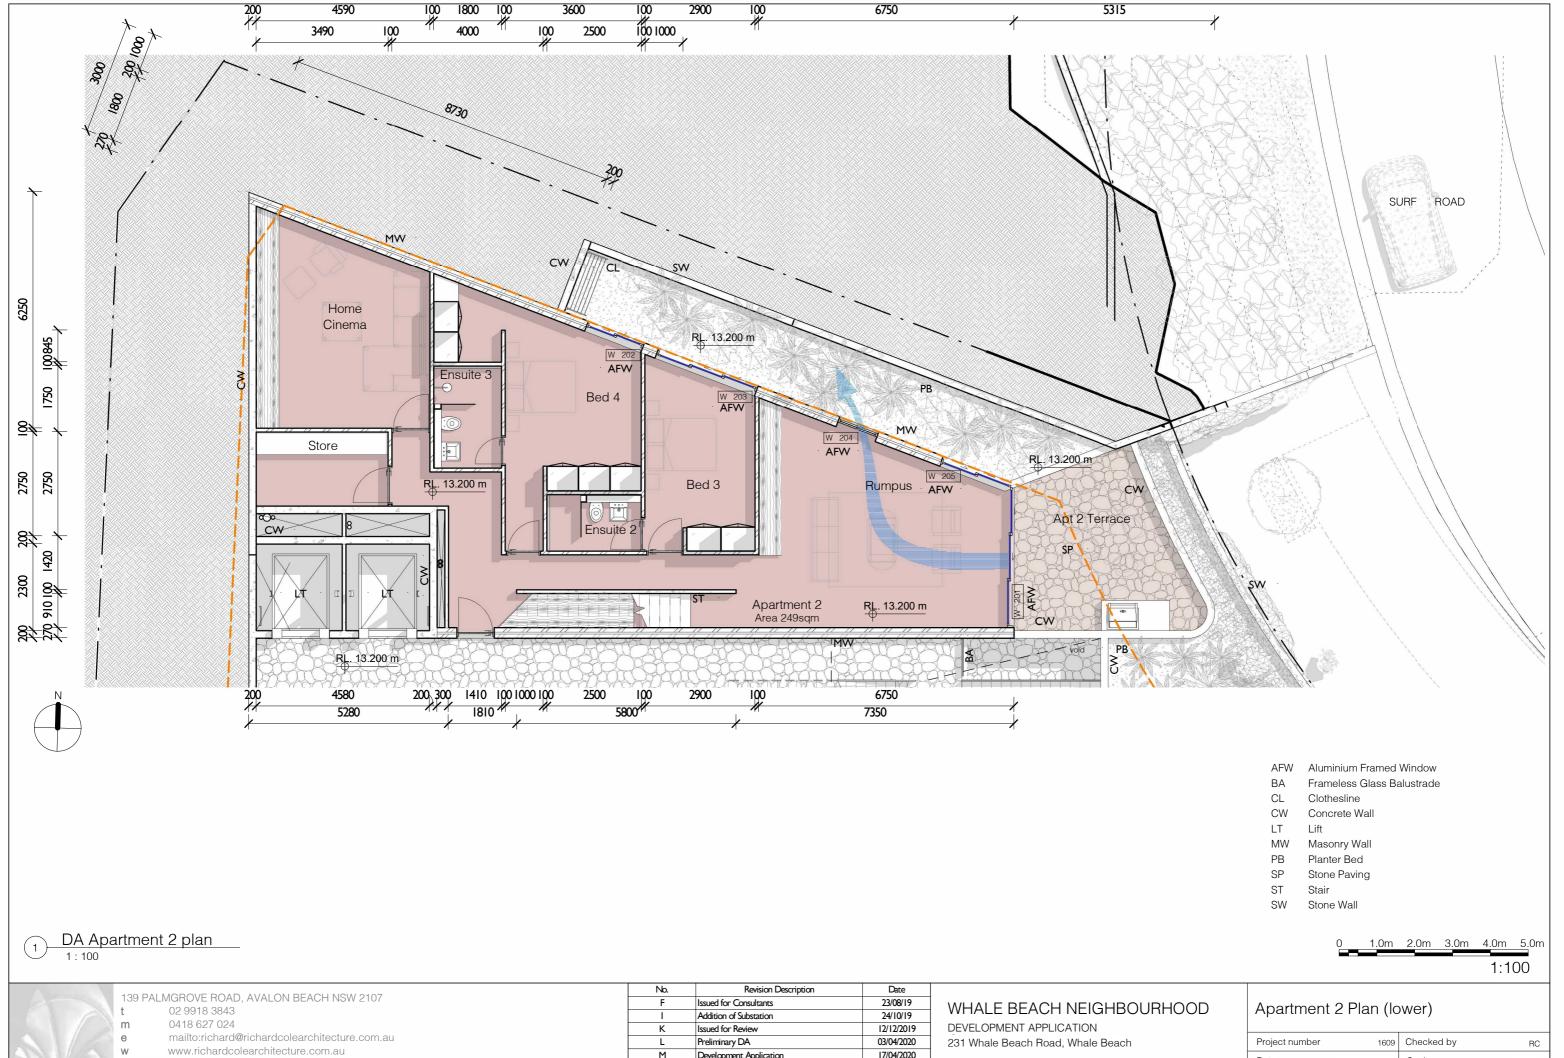

acn:093 598 415 abn:58 093 598 415 nominated architect : Richard Cole B.Sc.(Arch) (Hons 1) B.Arch.(Hons1) Reg. No: 6538 Development Application 17/04/2020 09/10/2020 Revised Development Application

Project number	1609	Checked by	RC
Date	OCTOBER 2020	Scale	1 : 100
Drawn by	KW		DA42

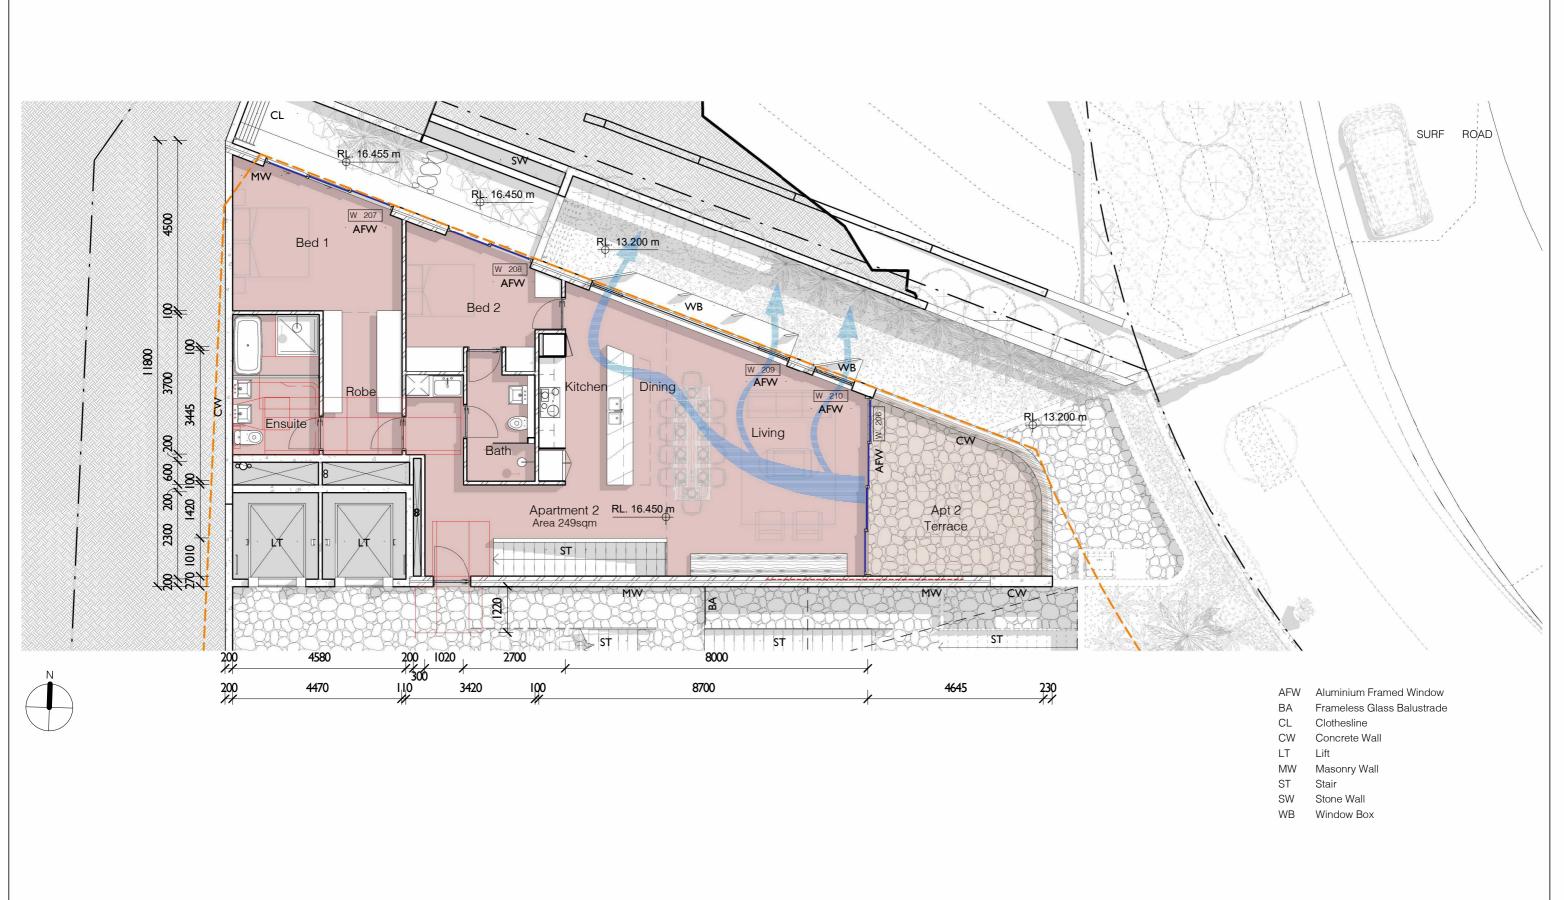

DA Apartment 2 Plan (upper)

139 PALMGROVE ROAD, AVALON BEACH NSW 2107

t 02 9918 3843 m 0418 627 024

mailto:richard@richardcolearchitecture.com.au

www.richardcolearchitecture.com.au

acn:093 598 415 abn:58 093 598 415 nominated architect : Richard Cole B.Sc.(Arch) (Hons 1) B.Arch.(Hons1) Reg. No: 6538

No.	Revision Description	Date
F	Issued for Consultants	23/08/19
I	Addition of Substation	24/10/19
K	Issued for Review	12/12/2019
L	Preliminary DA	03/04/2020
М	Development Application	17/04/2020
Р	Revised Development Application	09/10/2020

### WHALE BEACH NEIGHBOURHOOD


DEVELOPMENT APPLICATION 231 Whale Beach Road, Whale Beach


Leslie Cassar

Apartmen	t 2 Plan	(upper)	

Project number	1609	Checked by	RC
Date	OCTOBER 2020	Scale	1 : 100
Drawn by	KW		DA43

1:100

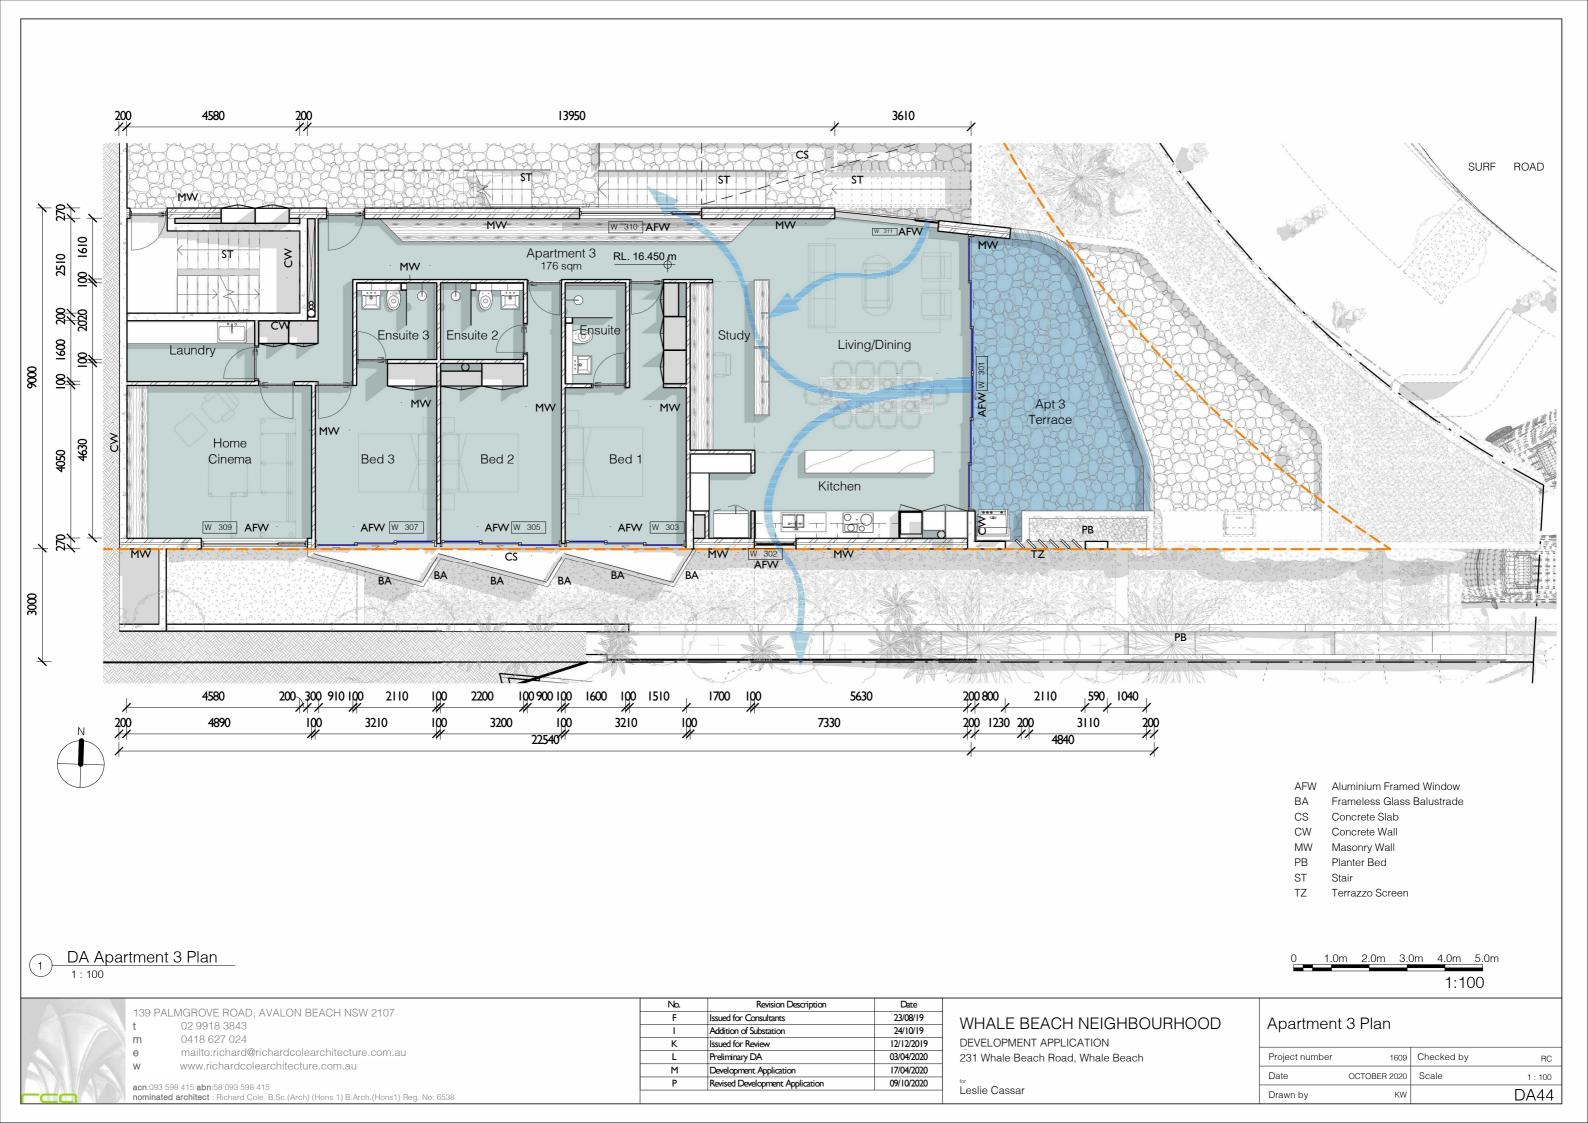

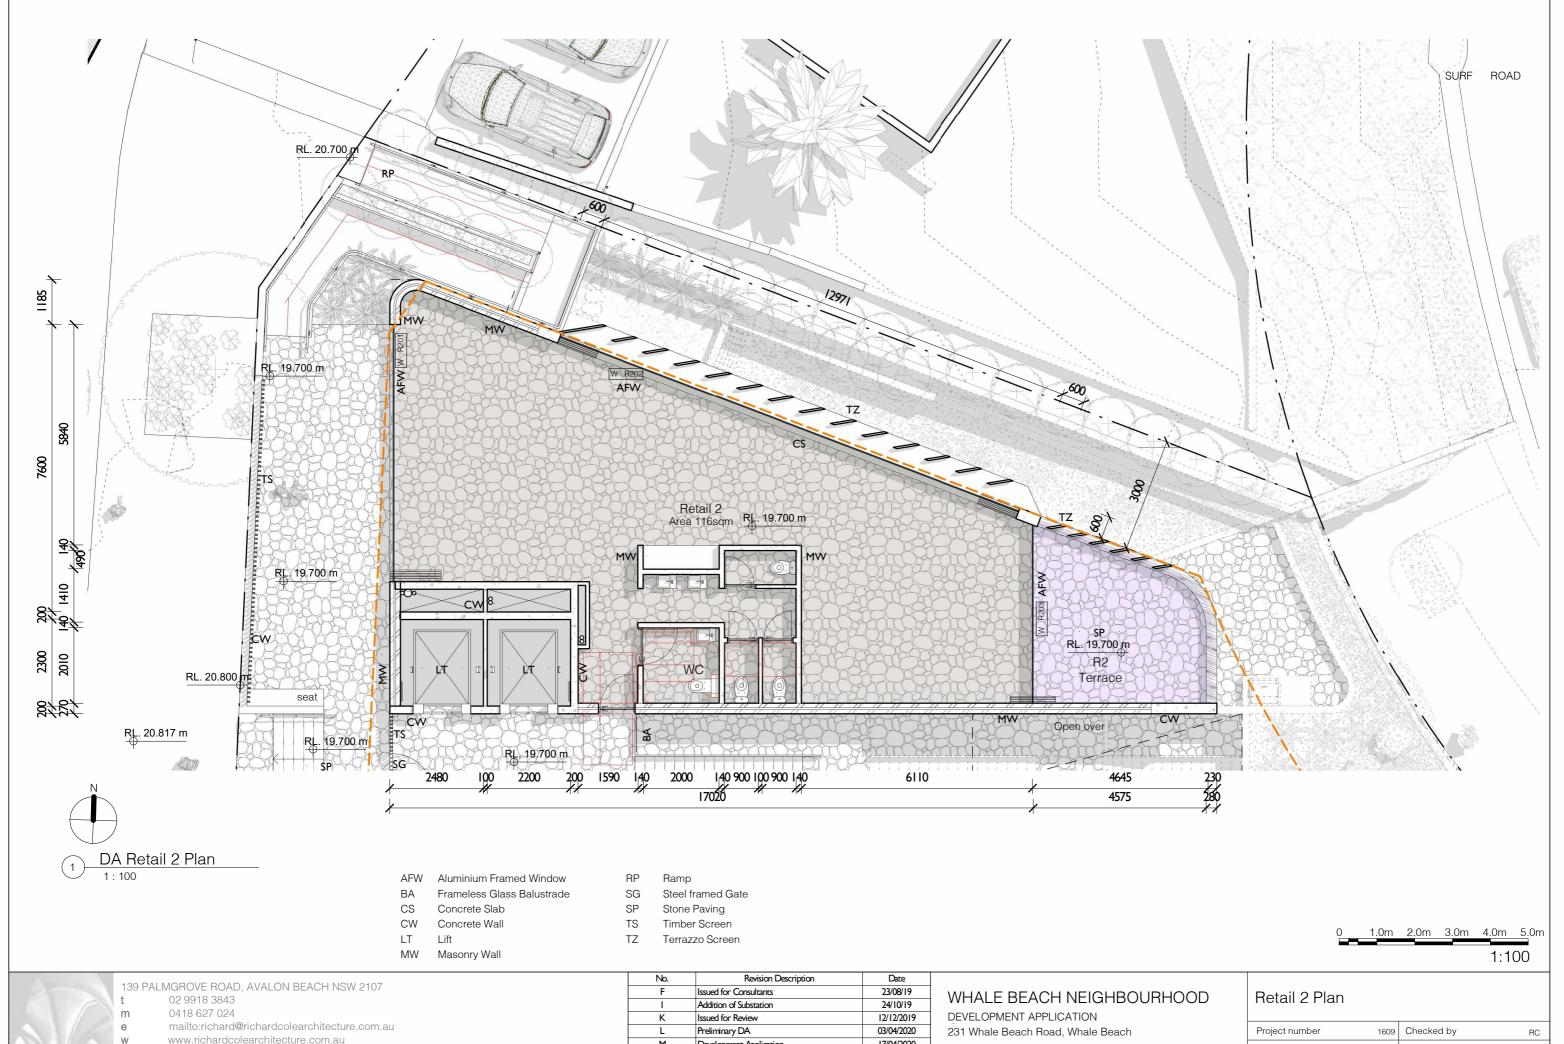


www.richardcolearchitecture.com.au

acn:093 598 415 abn:58 093 598 415 nominated architect : Richard Cole B.Sc.(Arch) (Hons 1) B.Arch.(Hons1) Reg. No: 6538

	Termini Zeer ipeer	
F	Issued for Consultants	23/08/19
I	Addition of Substation	24/10/19
K	Issued for Review	12/12/2019
L	Preliminary DA	03/04/2020
М	Development Application	17/04/2020
Р	Revised Development Application	09/10/2020

Project number	1609	Checked by	RC
Date	OCTOBER 2020	Scale	1 : 100
Orawn by	KW		DA45

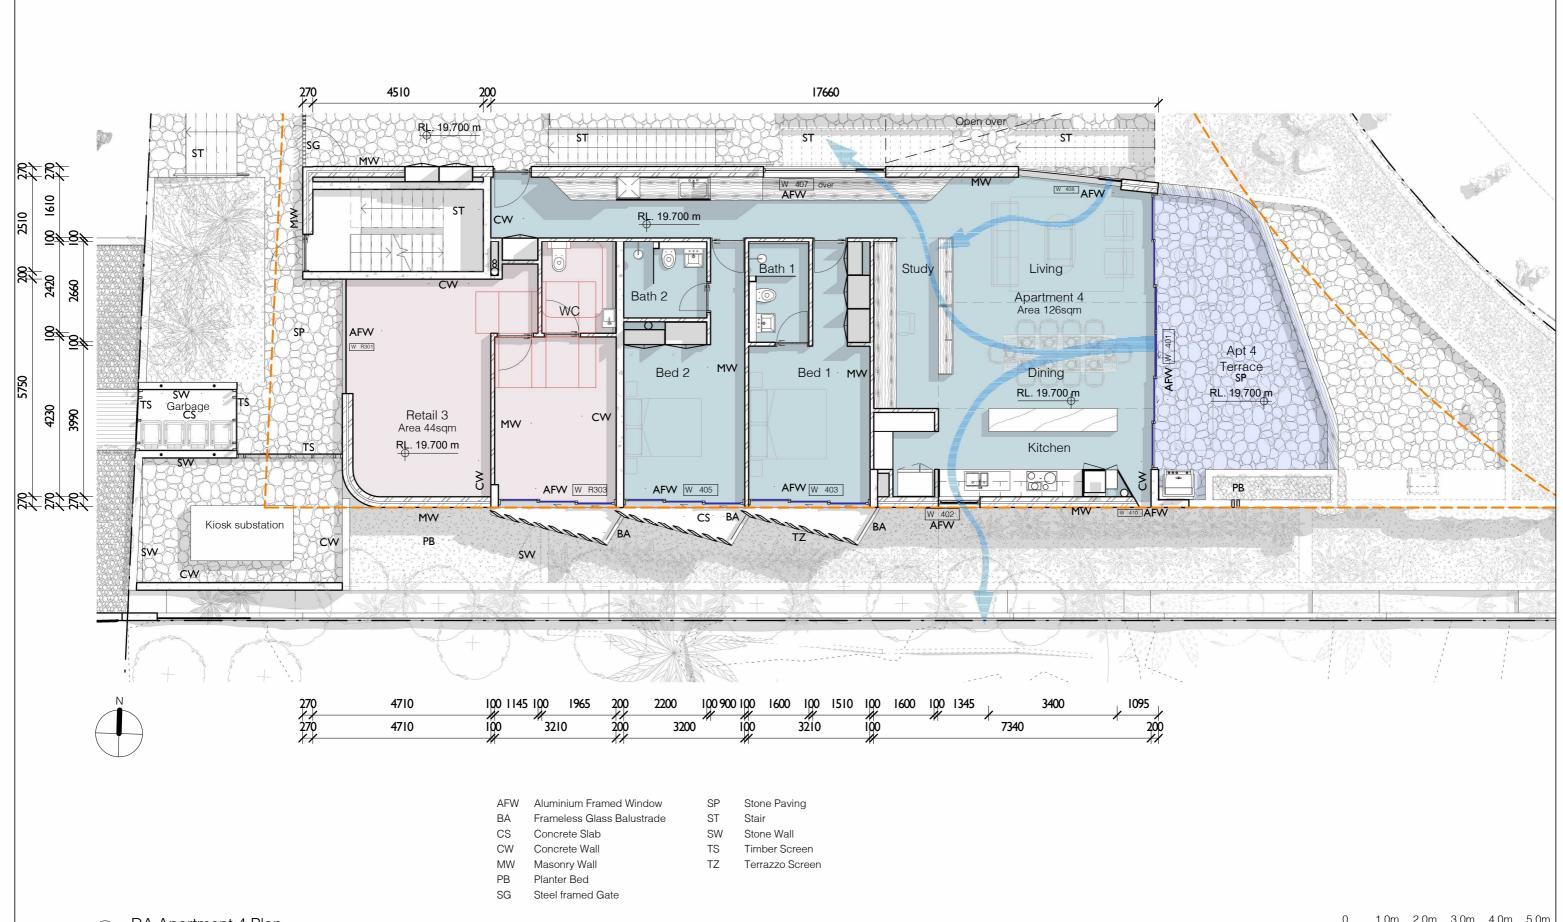

DA Apartment 4 Plan

1:100

1.0m 2.0m 3.0m 4.0m 5.0m 1:100

139 PALMGROVE ROAD, AVALON BEACH NSW 2107

t 02 9918 3843

**m** 0418 627 024

mailto:richard@richardcolearchitecture.com.au

www.richardcolearchitecture.com.au

acn:093 598 415 abn:58 093 598 415
nominated architect : Richard Cole B.Sc.(Arch) (Hons 1) B.Arch.(Hons1) Reg. No: 6538

No.	Revision Description	Date
F Issued for Consultants		23/08/19
I	Addition of Substation	24/10/19
K	Issued for Review	12/12/2019
L	Preliminary DA	03/04/2020
M	Development Application	17/04/2020
P	Revised Development Application	09/10/2020

#### WHALE BEACH NEIGHBOURHOOD

DEVELOPMENT APPLICATION 231 Whale Beach Road, Whale Beach


101	
Leslie	Cass


•		
Project number	1609	Checked by
Date	OCTOBER 2020	Scale

Apartment 4 & Retail 3 Plan

 Date
 OCTOBER 2020
 Scale
 1 : 100

 Drawn by
 KW
 DA46

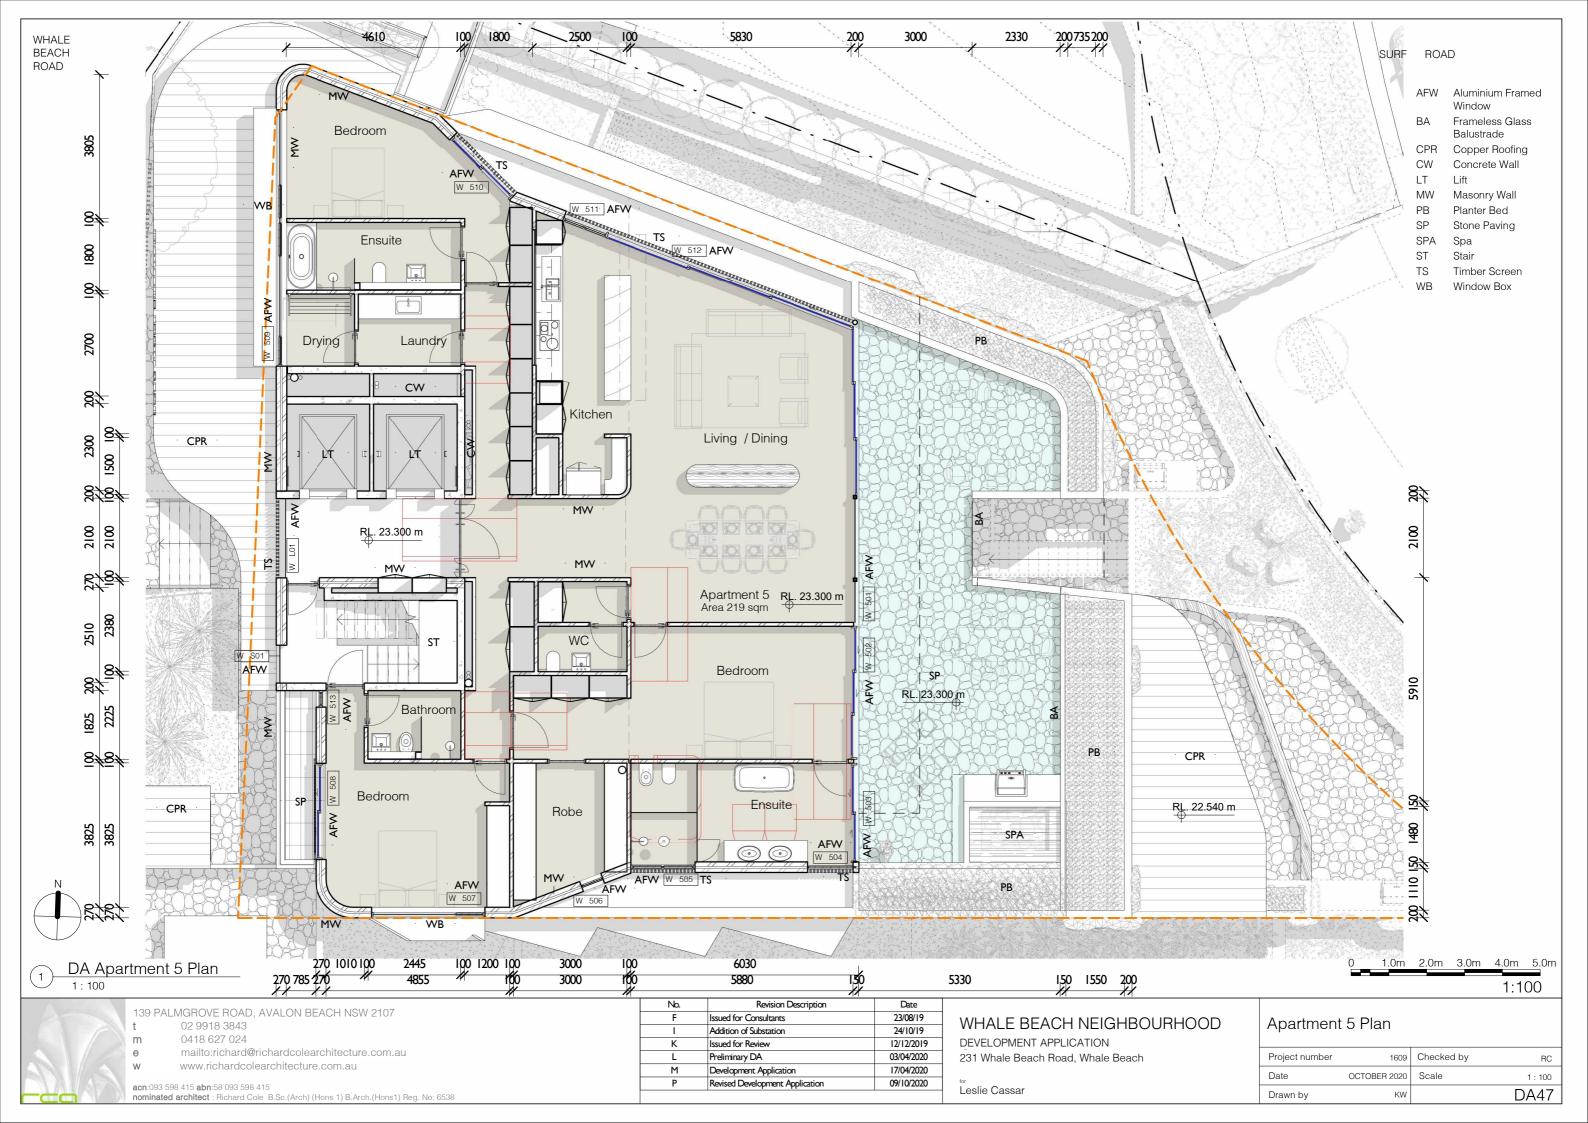

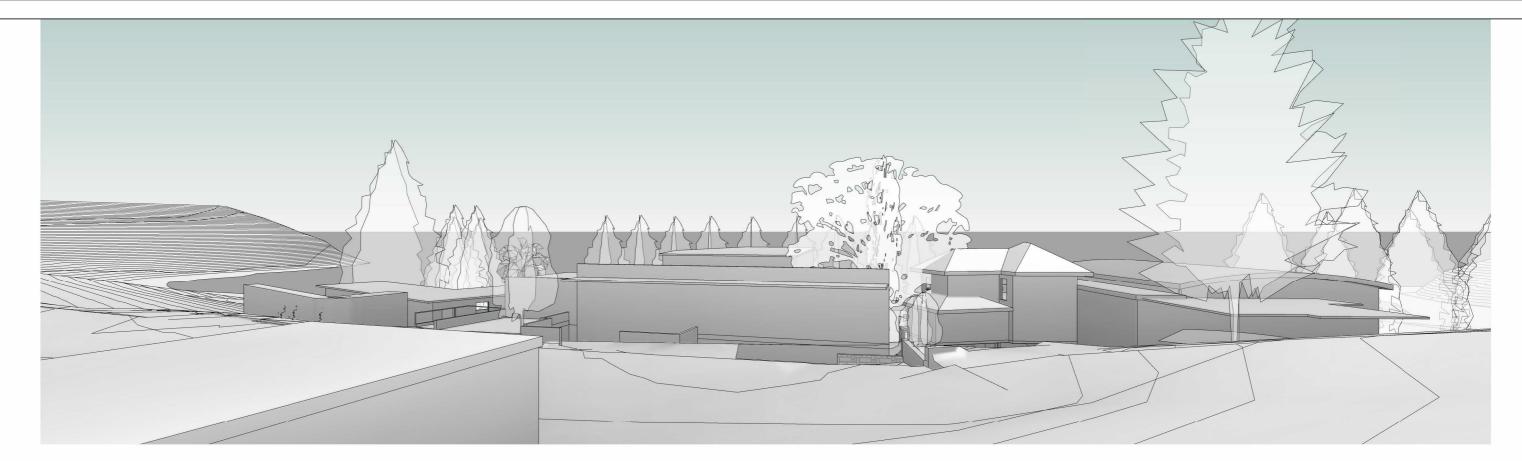

View from 196 Tiled verandah - existing



View from 196 Tiled verandah - proposed

139 PALMGROVE ROAD, AVALON BEACH NSW 2107 t 02 9918 3843

0418 627 024

mailto:richard@richardcolearchitecture.com.au

www.richardcolearchitecture.com.au

acn:093 598 415 abn:58 093 598 415 nominated architect : Richard Cole B.Sc.(Arch) (Hons 1) B.Arch.(Hons1) Reg. No: 6538

No.	Revision Description	Date
F	Issued for Consultants	23/08/19
K	Issued for Review	12/12/2019
М	Development Application	17/04/2020
P	Revised Development Application	09/10/2020

## WHALE BEACH NEIGHBOURHOOD

DEVELOPMENT APPLICATION 231 Whale Beach Road, Whale Beach

Project number	1609	Checked by	RC
Date	OCTOBER 2020	Scale	
Drawn by	KW		DA50



View from 196 upper balcony - existing



View from 196 upper balcony - proposed

139 PALMGROVE ROAD, AVALON BEACH NSW 2107 t 02 9918 3843

0418 627 024

mailto:richard@richardcolearchitecture.com.au

www.richardcolearchitecture.com.au

acn:093 598 415 abn:58 093 598 415 nominated architect : Richard Cole B.Sc.(Arch) (Hons 1) B.Arch.(Hons1) Reg. No: 6538

No.	Revision Description	Date
F	Issued for Consultants	23/08/19
K	Issued for Review	12/12/2019
М	Development Application	17/04/2020
P	Revised Development Application	09/10/2020

## WHALE BEACH NEIGHBOURHOOD

DEVELOPMENT APPLICATION 231 Whale Beach Road, Whale Beach

Leslie Cassar

# 196 WBR View Impact Study

Project number	1609	Checked by	RC
Date	OCTOBER 2020	Scale	
rawn by	KW		DA51



View from 194 lower balcony - existing



View from 194 lower balcony - proposed

139 PALMGROVE ROAD, AVALON BEACH NSW 2107 t 02 9918 3843

0418 627 024

mailto:richard@richardcolearchitecture.com.au

www.richardcolearchitecture.com.au


acn:093 598 415 abn:58 093 598 415 nominated architect : Richard Cole B.Sc.(Arch) (Hons 1) B.Arch.(Hons1) Reg. No: 6538

No.	Revision Description	Date
F	Issued for Consultants	23/08/19
K	Issued for Review	12/12/2019
М	Development Application	17/04/2020
P	Revised Development Application	09/10/2020

## WHALE BEACH NEIGHBOURHOOD

DEVELOPMENT APPLICATION 231 Whale Beach Road, Whale Beach

Project number	1609	Checked by	RC
Date	OCTOBER 2020	Scale	
Drawn by	KW		DA52

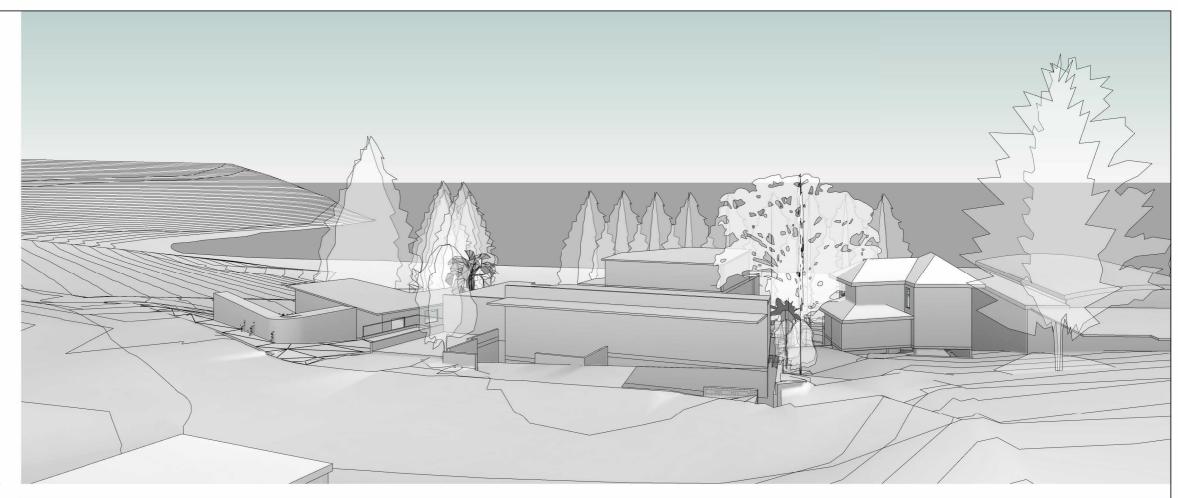

View from 194 upper balcony - existing



View from 194 upper balcony - proposed

139 PALMGROVE ROAD, AVALON BEACH NSW 2107 t 02 9918 3843

0418 627 024

mailto:richard@richardcolearchitecture.com.au

www.richardcolearchitecture.com.au


acn:093 598 415 abn:58 093 598 415 nominated architect : Richard Cole B.Sc.(Arch) (Hons 1) B.Arch.(Hons1) Reg. No: 6538

	No.	Revision Description	Date
	F	Issued for Consultants	23/08/19
	K	Issued for Review	12/12/2019
ı	М	Development Application	17/04/2020
ĺ	Р	Revised Development Application	09/10/2020
I			
1			

## WHALE BEACH NEIGHBOURHOOD

DEVELOPMENT APPLICATION 231 Whale Beach Road, Whale Beach

Project number	1609	Checked by	RC
Date	OCTOBER 2020	Scale	
Drawn by	KW		DA53

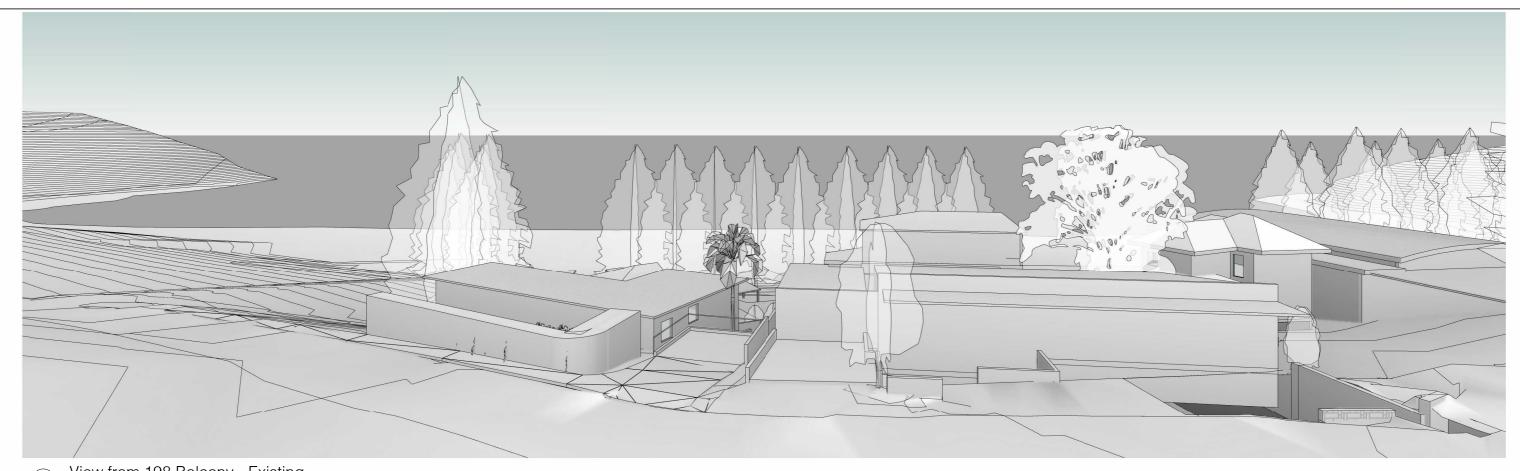

View from 198 Balcony - Existing



139 PALMGROVE ROAD, AVALON BEACH NSW 2107 t 02 9918 3843

0418 627 024

mailto:richard@richardcolearchitecture.com.au

www.richardcolearchitecture.com.au

acn:093 598 415 abn:58 093 598 415 nominated architect : Richard Cole B.Sc.(Arch) (Hons 1) B.Arch.(Hons1) Reg. No: 6538

No.	Revision Description	Date
F	Issued for Consultants	23/08/19
K	Issued for Review	12/12/2019
М	Development Application	17/04/2020
P	Revised Development Application	09/10/2020

## WHALE BEACH NEIGHBOURHOOD

DEVELOPMENT APPLICATION 231 Whale Beach Road, Whale Beach

198 WBR View Im	pact Study
-----------------	------------

Project number	1609	Checked by	RC
Date	OCTOBER 2020	Scale	
Drawn by	KW		DA54



View from 200 balcony - existing



View from 200 balcony - proposed

139 PALMGROVE ROAD, AVALON BEACH NSW 2107 t 02 9918 3843

0418 627 024

mailto:richard@richardcolearchitecture.com.au

www.richardcolearchitecture.com.au

acn:093 598 415 abn:58 093 598 415 nominated architect : Richard Cole B.Sc.(Arch) (Hons 1) B.Arch.(Hons1) Reg. No: 6538


No.	Revision Description	Date
F	Issued for Consultants	23/08/19
K	Issued for Review	12/12/2019
М	Development Application	17/04/2020
P	Revised Development Application	09/10/2020

## WHALE BEACH NEIGHBOURHOOD


DEVELOPMENT APPLICATION 231 Whale Beach Road, Whale Beach

200 WBR View Impa	act Study
-------------------	-----------

Project number	1609	Checked by	RC
Date	OCTOBER 2020	Scale	
Drawn by	KW		DA55

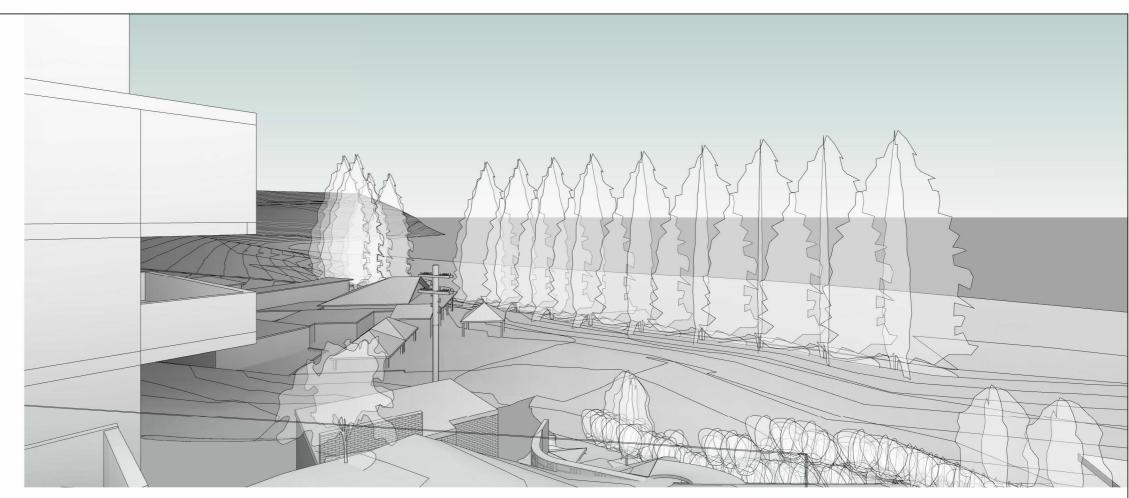

View from 229 verandah - existing 2

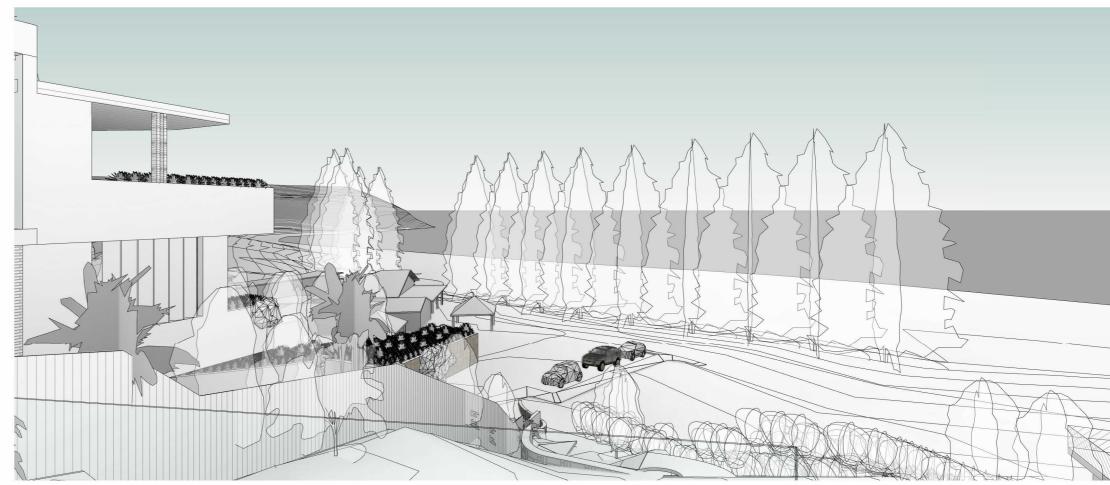

View from 229 verandah - proposed 2

139 PALMGROVE ROAD, AVALON BEACH NSW 2107 t 02 9918 3843

0418 627 024

mailto:richard@richardcolearchitecture.com.au

www.richardcolearchitecture.com.au

acn:093 598 415 abn:58 093 598 415 nominated architect : Richard Cole B.Sc.(Arch) (Hons 1) B.Arch.(Hons1) Reg. No: 6538

No.	Revision Description	Date
F	Issued for Consultants	23/08/19
K	Issued for Review	12/12/2019
М	Development Application	17/04/2020
P	Revised Development Application	09/10/2020

## WHALE BEACH NEIGHBOURHOOD


DEVELOPMENT APPLICATION 231 Whale Beach Road, Whale Beach

229 WBR View Impact Stu	udy
-------------------------	-----

Project number	1609	Checked by	RC
Date	OCTOBER 2020	Scale	
Drawn by	KW		DA56



229 WBR - View 1 (top floor) - existing

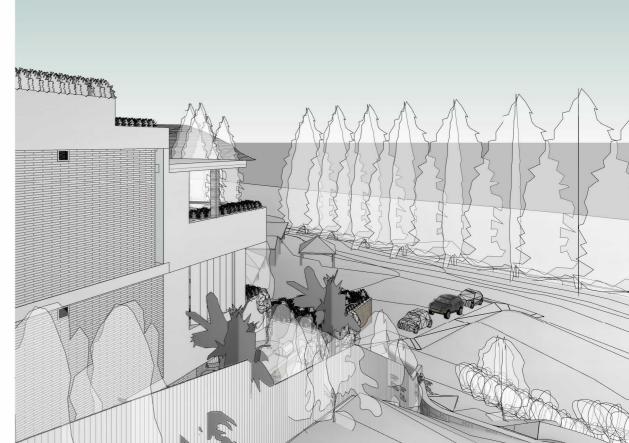

229 WBR - View 1(top floor) - proposed

#### WHALE BEACH NEIGHBOURHOOD

DEVELOPMENT APPLICATION 231 Whale Beach Road, Whale Beach

Leslie Cassar

Date

17/04/2020


09/10/2020


# 229 WBR View Impact Study


Project number 1609 Checked by Checker Date OCTOBER 2020 Scale 1:100 Drawn by DA57 Author


www.richardcolearchitecture.com.au

acn:093 598 415 abn:58 093 598 415 nominated architect : Richard Cole B.Sc.(Arch) (Hons 1) B.Arch.(Hons1) Reg. No: 6538

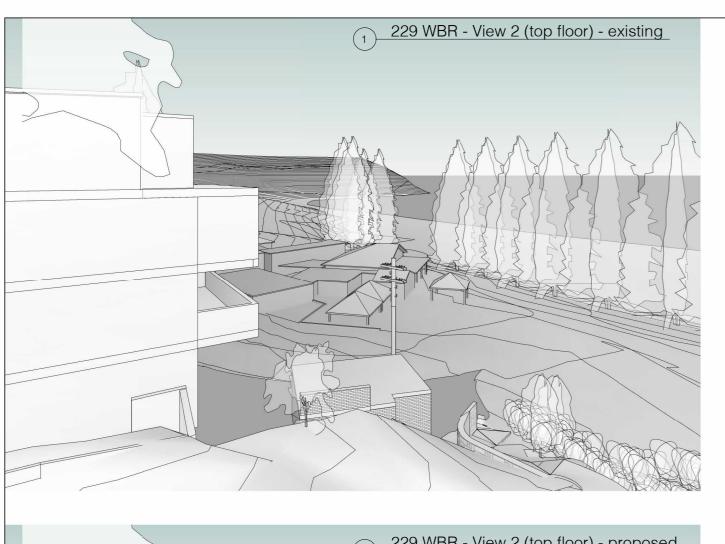

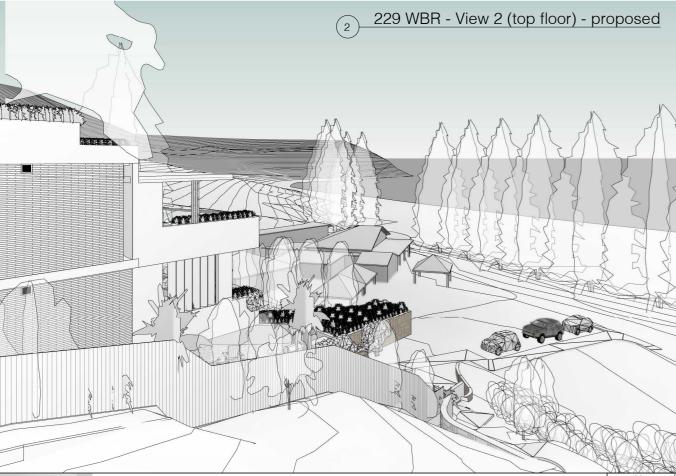

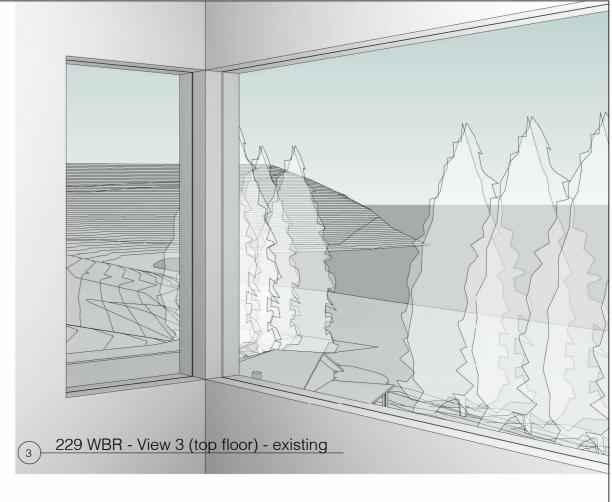

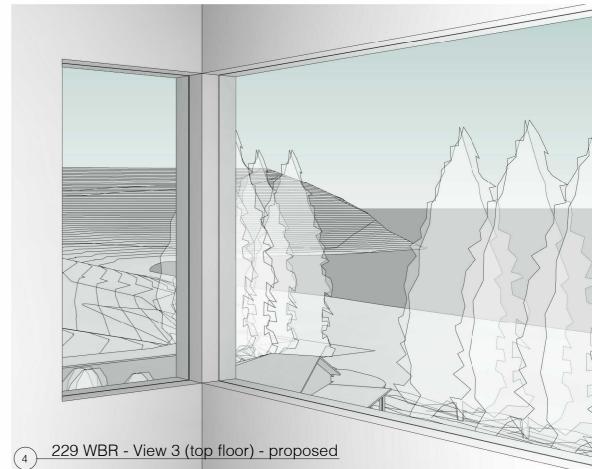

139 PALMGROVE ROAD, AVALON BEACH NSW 2107 t 02 9918 3843

0418 627 024

mailto:richard@richardcolearchitecture.com.au

www.richardcolearchitecture.com.au

acn:093 598 415 abn:58 093 598 415 nominated architect : Richard Cole B.Sc.(Arch) (Hons 1) B.Arch.(Hons1) Reg. No: 6538

1 40.	Tichian Dadripaan	Date
М	Development Application	17/04/2020
Р	Revised Development Application	09/10/2020


## WHALE BEACH NEIGHBOURHOOD

DEVELOPMENT APPLICATION 231 Whale Beach Road, Whale Beach

Leslie Cassar

### 229 WBR View Impact Study

Project number 1609 Checked by Checker Date OCTOBER 2020 Scale Drawn by DA58 Author

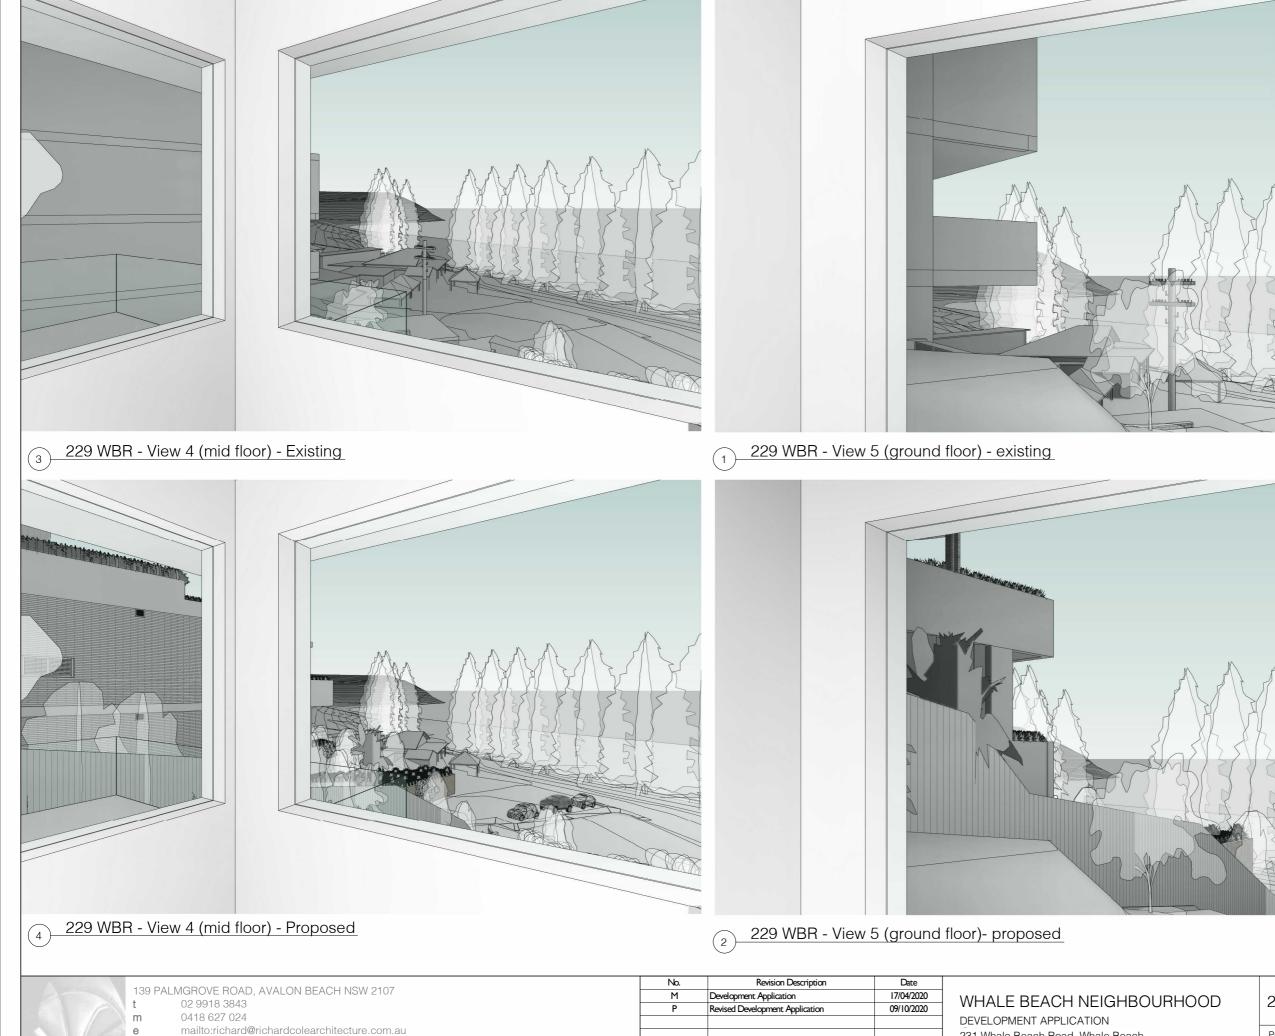

www.richardcolearchitecture.com.au


acn:093 598 415 abn:58 093 598 415 nominated architect : Richard Cole B.Sc.(Arch) (Hons 1) B.Arch.(Hons1) Reg. No: 6538 M Development Application 17/04/2020
P Revised Development Application 09/10/2020
DEVELOPMENT APPLICATION 231 Whale Beach Road, Whale Beach

Leslie Cassar


WHALE BEACH NEIGHBOURHOOD
DEVELOPMENT APPLICATION
231 Whale Beach Road, Whale Beach
Date OCTOBER 2020 Scale
Drawn by Author

Checker

DA59

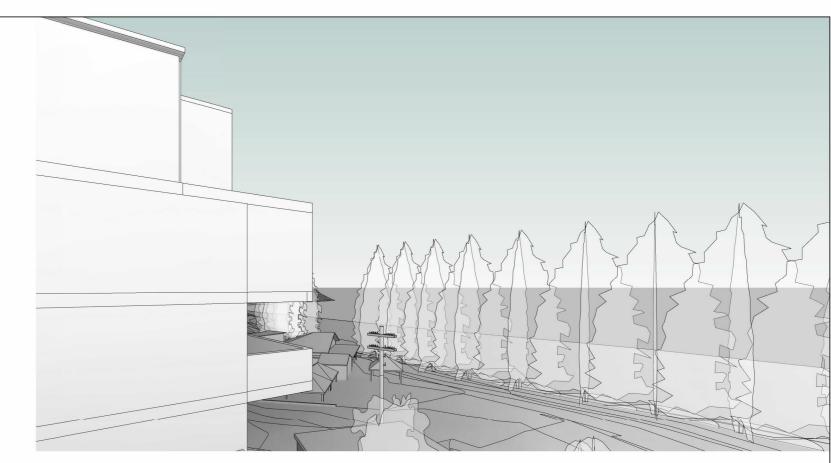

229 View from northern corner of balcony - existing

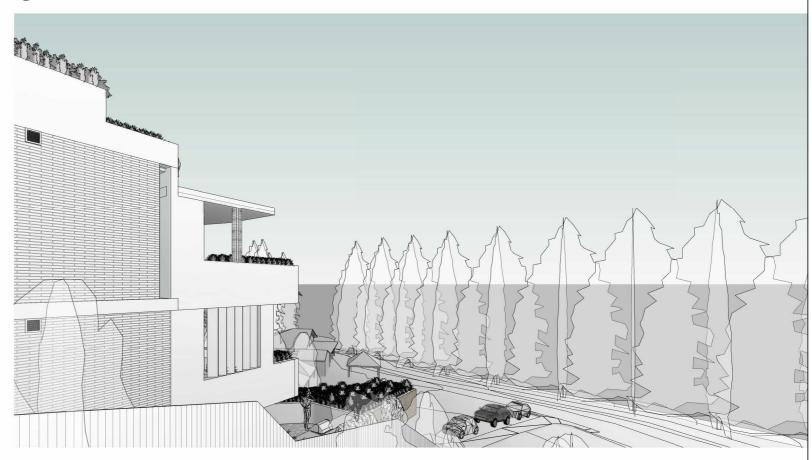

229 View from northern corner of balcony - proposed

139 PALMGROVE ROAD, AVALON BEACH NSW 2107 t 02 9918 3843

1 0418 627 024
mailto:richard@richardcolearchitecture.co

mailto:richard@richardcolearchitecture.com.au www.richardcolearchitecture.com.au

acn:093 598 415 abn:58 093 598 415 nominated architect : Richard Cole B.Sc.(Arch) (Hons 1) B.Arch.(Hons1) Reg. No: 6538

No.	Revision Description	Date
М	Development Application	17/04/2020
P	Revised Development Application	09/10/2020

## WHALE BEACH NEIGHBOURHOOD

DEVELOPMENT APPLICATION 231 Whale Beach Road, Whale Beach


Leslie Cassar

## 229 WBR View Impact Study


 Project number
 1609
 Checked by
 Checker

 Date
 OCTOBER 2020
 Scale

 Drawn by
 Author
 DA60

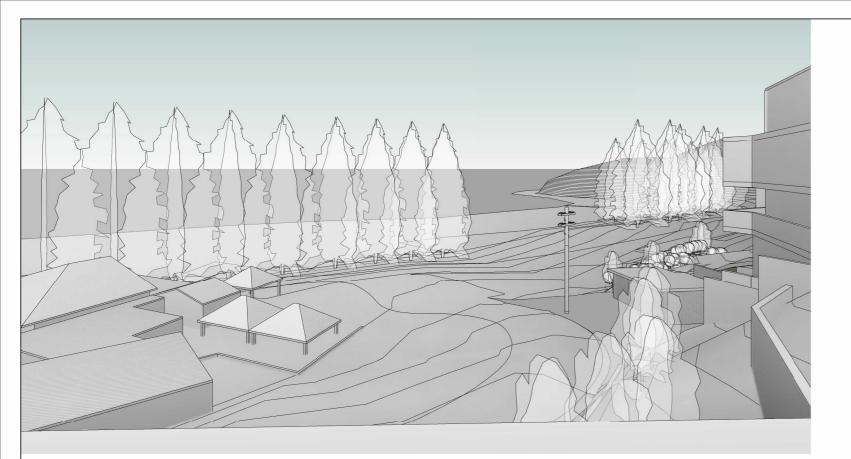

233 View from centre of balcony - existing

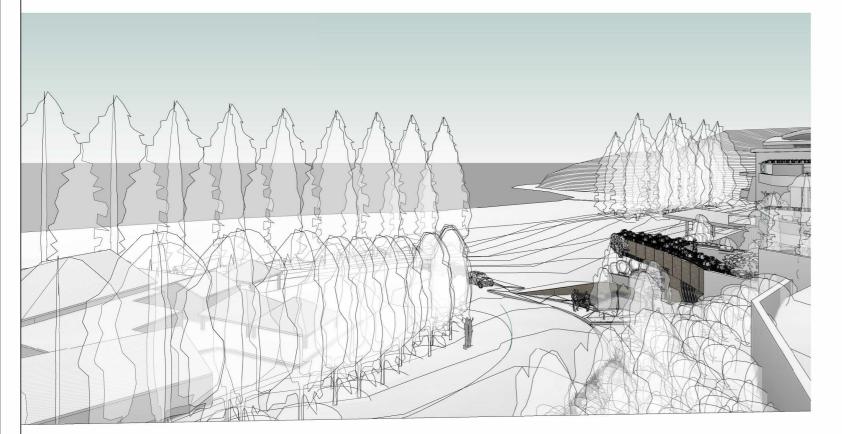


233 View from centre of balcony - proposed


139 PALMGROVE ROAD, AVALON BEACH NSW 2107 02 9918 3843 0418 627 024

mailto:richard@richardcolearchitecture.com.au


www.richardcolearchitecture.com.au

acn:093 598 415 abn:58 093 598 415 nominated architect : Richard Cole B.Sc.(Arch) (Hons 1) B.Arch.(Hons1) Reg. No: 6538

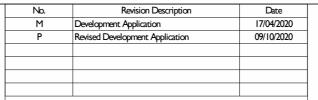

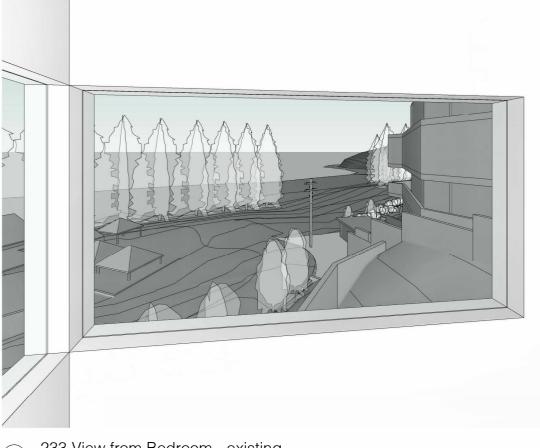

233 View from Bedroom - existing

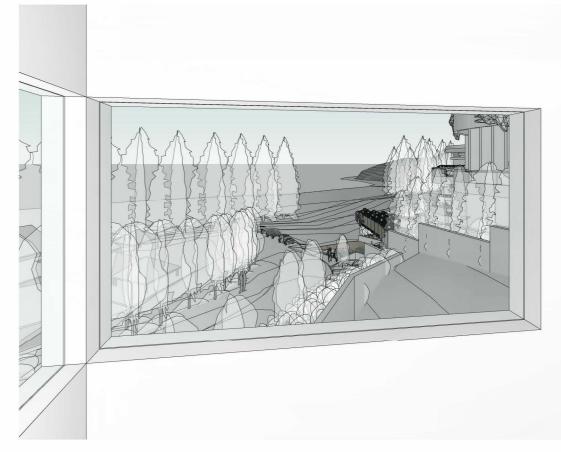

233 View from Bedroom - proposed


WHALE BEACH NEIGHBOURHOOD

DEVELOPMENT APPLICATION 231 Whale Beach Road, Whale Beach


Leslie Cassar

233 WBR View Impact Study

Project number 1609 Checked by Checker Date OCTOBER 2020 Scale Drawn by DA61 Author

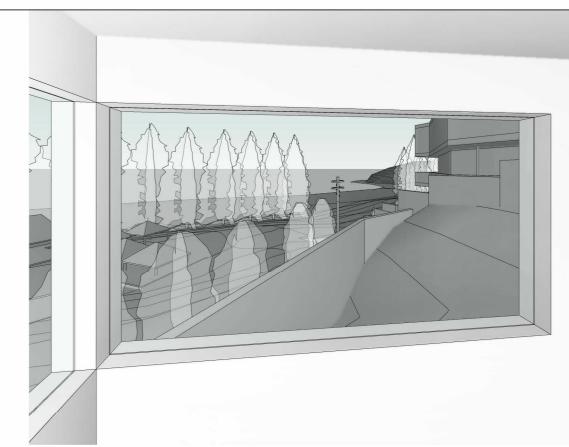

233 View from lower bedroom - existing

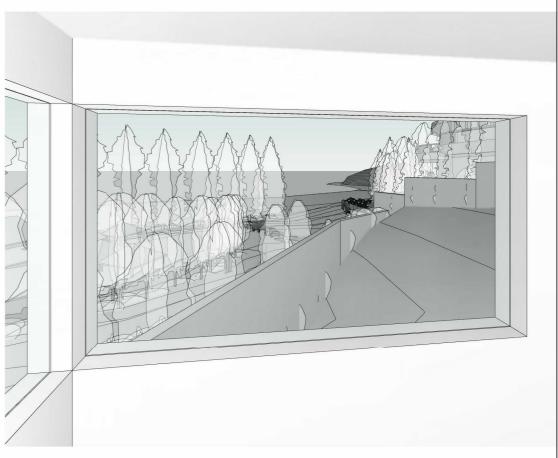

233 View from lower bedroom - proposed

139 PALMGROVE ROAD, AVALON BEACH NSW 2107

02 9918 3843 0418 627 024

mailto:richard@richardcolearchitecture.com.au

www.richardcolearchitecture.com.au

No.	Revision Description
М	Development Application
P	Revised Development Application
	•

#### WHALE BEACH NEIGHBOURHOOD

DEVELOPMENT APPLICATION 231 Whale Beach Road, Whale Beach

Leslie Cassar

Date

17/04/2020

09/10/2020

### 233 WBR View Impact Study

1609 Checked by Project number Checker Date OCTOBER 2020 Scale Drawn by DA62 Author

acn:093 598 415 abn:58 093 598 415 nominated architect : Richard Cole B.Sc.(Arch) (Hons 1) B.Arch.(Hons1) Reg. No: 6538





139 PALMGROVE ROAD, AVALON BEACH NSW 2107

02 9918 3843

0418 627 024

mailto:richard@richardcolearchitecture.com.au

www.richardcolearchitecture.com.au

acn:093 598 415 abn:58 093 598 415 nominated architect : Richard Cole B.Sc.(Arch) (Hons 1) B.Arch.(Hons1) Reg. No: 6538

	No.	Revision Description	Date
L Preliminary DA		Preliminary DA	03/04/2020
	M Development Application		17/04/2020
	Р	Revised Development Application	09/10/2020

### WHALE BEACH NEIGHBOURHOOD

DEVELOPMENT APPLICATION 231 Whale Beach Road, Whale Beach

Leslie Cassar

#### Notification Site Plan

Project number	1609	Checked by	RC
Date	OCTOBER 2020	Scale	1 : 500
Drawn by	KW		DA100

