

The builder shall check and verify all dimensions and verify all errors and omissions to the Architect. Do not scale the drawings. Drawings shall not be used for construction purposes until issued by the Architect for construction.

Sally Bamford and Rob Wilkie

North Manly NSW 2100

Section and Basix

Date: 24.06.2020

DA04

Checked By: SH

Project Name

Bamkie House


7 Corrie Rd


Drawing Title

Scale: as noted

2019 15

Status: DA

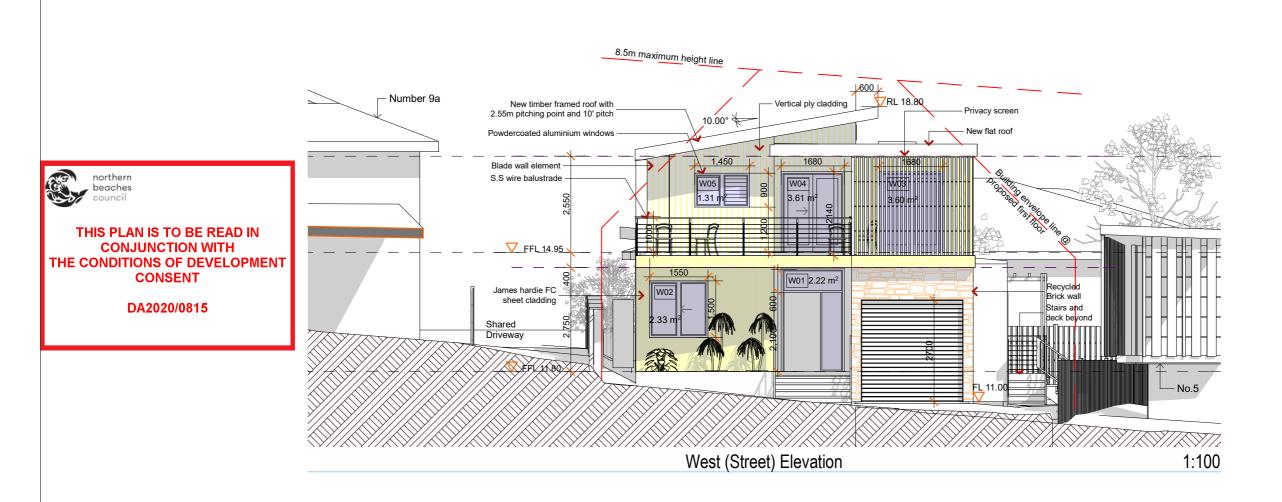

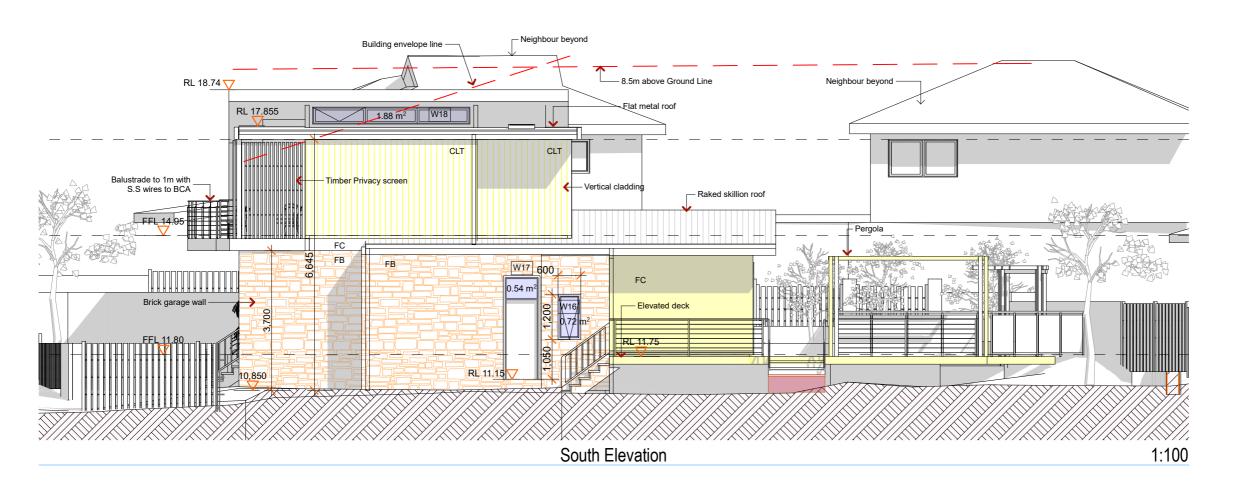

The builder shall check and verify all dimensions and verify all errors and omissions to the Architect. Do not scale the drawings. Drawings shall not be used for construction purposes until issued by the Architect for construction.

Cient

Sally Bamford and Rob Wilkie

Project Name

Bamkie House

7 Corrie Rd
North Manly NSW 2100

Drawing Title:

West and South Elevations

Scale: as noted

2019 15

Status: DA

Date: 24.06.2020

DA05

Checked By: SH







nstar.com.au

northern beaches

THIS PLAN IS TO BE READ IN **CONJUNCTION WITH** THE CONDITIONS OF DEVELOPMENT CONSENT

DA2020/0815

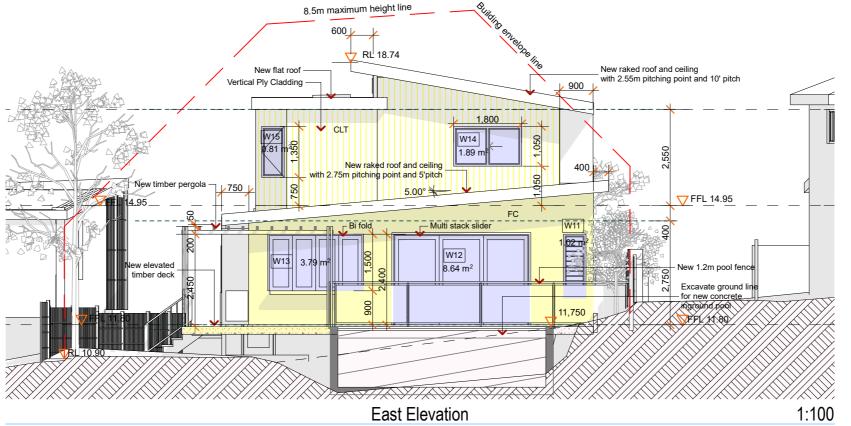

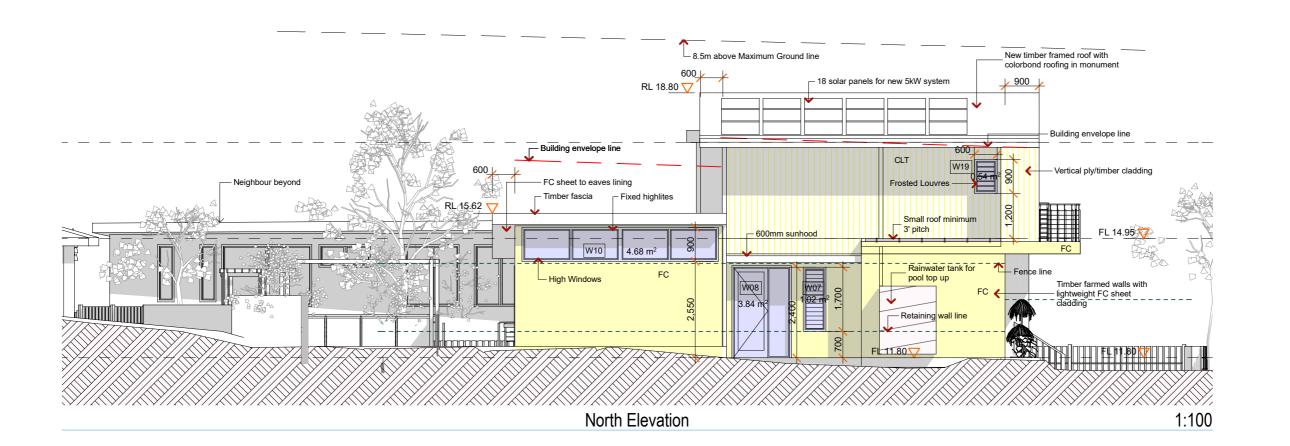


Sally Bamford and Rob Wilkie Project Name


Bamkie House 7 Corrie Rd North Manly NSW 2100

North and East Elevations

Scale: as noted Date: 24.06.2020 Checked By: SH

Status: DA 2019 15 DA06

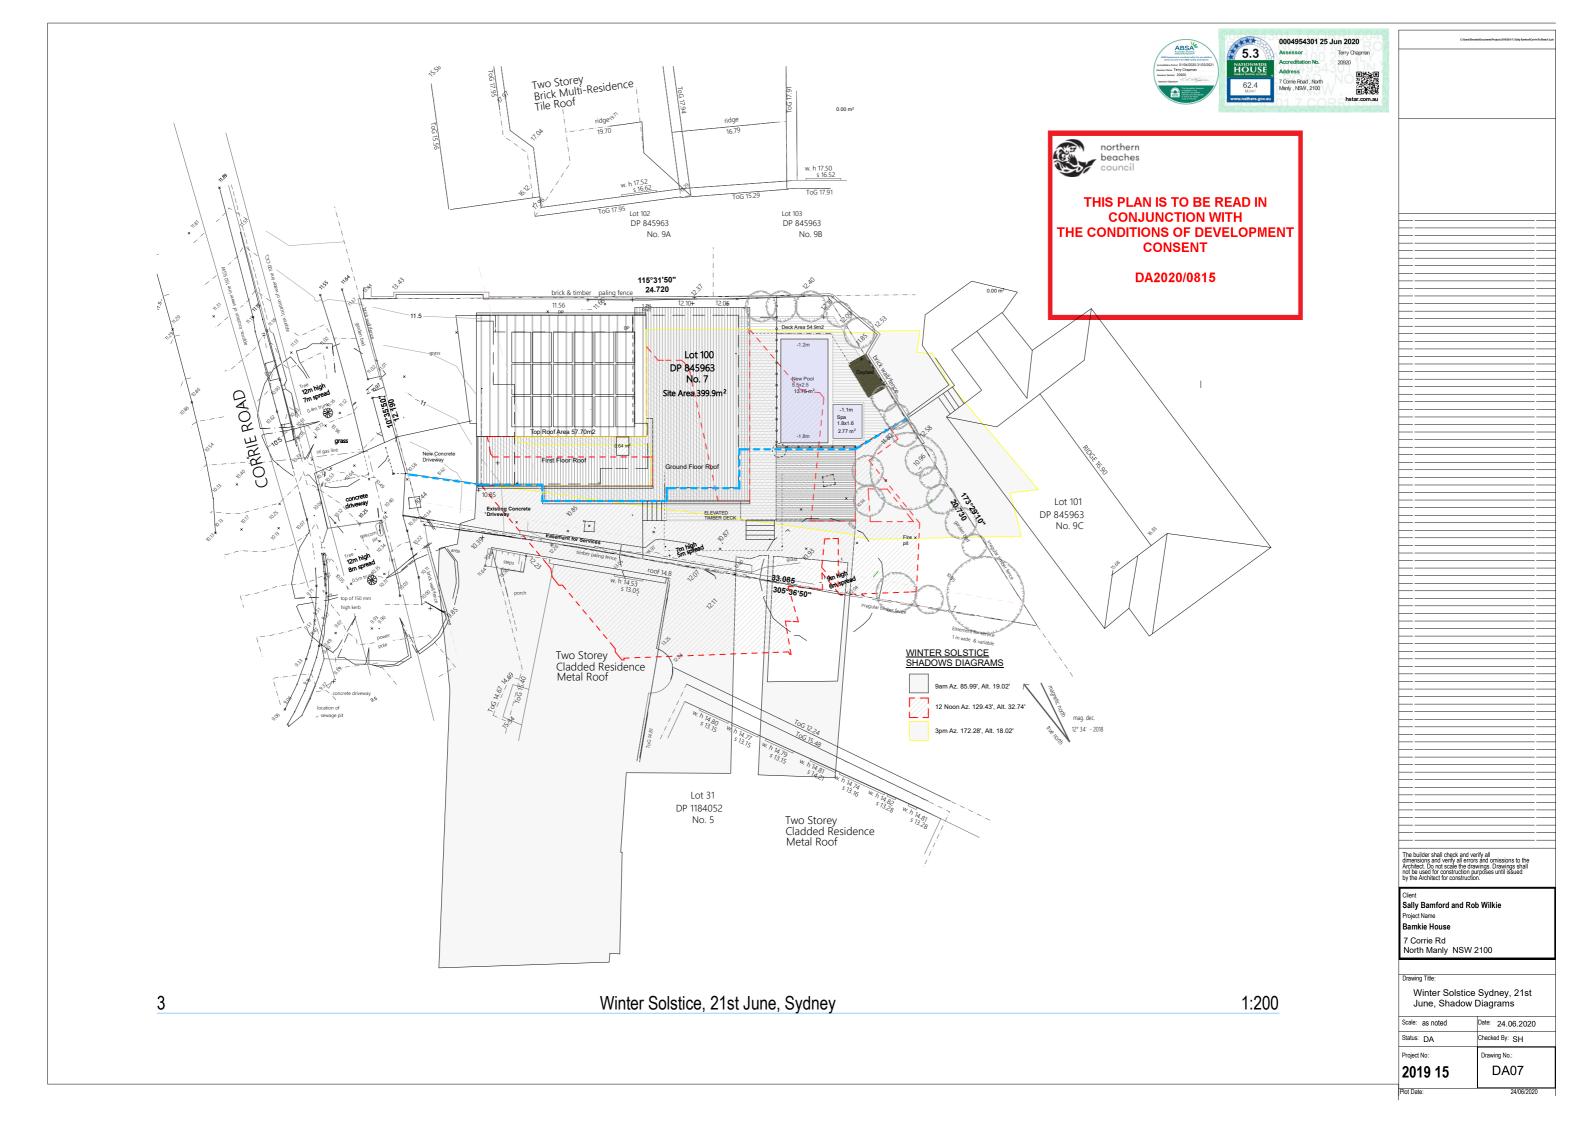


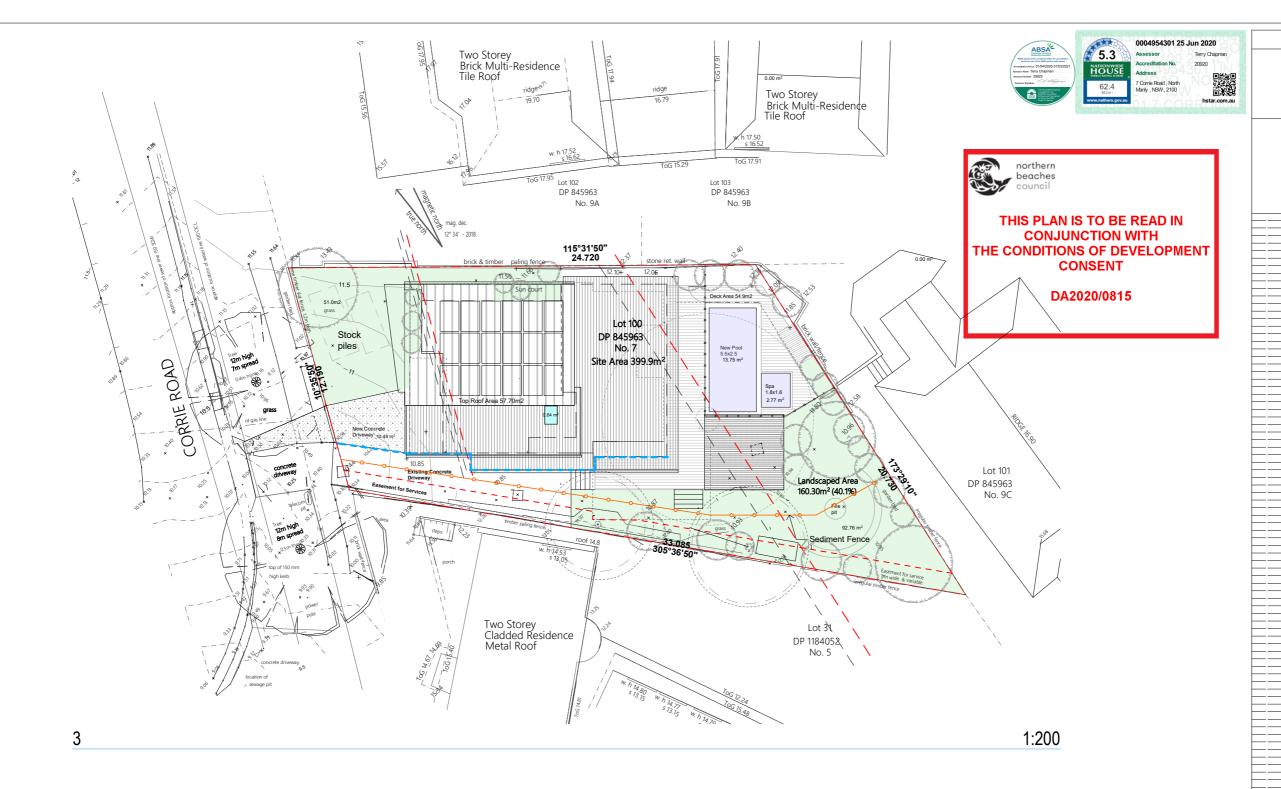

Polution Prevention

Use the following measures to prevent pollution on site;

- 1. restrict access to one stable entry and exit point
- 2.install and maintain adequate sediment and erosion controls
- 3. preserve grassed area and the maximum cover of natural vegetation by minimising the amount of land disturbed.
- 4. ensure that stockpiles of sand, gravel, soil, and similar materials are located so that the material doesn't spill onto the road or pavement, wash into drainage lines, watercourses or depressions.
- 5. minimise on site vehicle activity during wet weather
- 6. Do not pump or allow any unclean water to enter the stormwater system from excess materials or cleaning tools.
- 7. Sediment fences are to be laid along the contour as much as possible and are to be of suitable geotextile fabric and supported every three metres with star pickets and a lower trench depth of 150mm

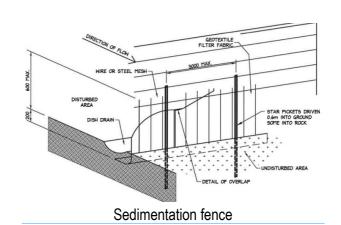

The builder shall check and verify all dimensions and verify all errors and omissions to the Architect. Do not scale the drawings. Drawings shall not be used for construction purposes until issued by the Architect for construction.

Sally Bamford and Rob Wilkie Project Name

Bamkie House 7 Corrie Rd North Manly NSW 2100

Drawing Title: Sediment and Erosion Plan

Scale: as noted Date: 24.06.2020

Status: DA Checked By: SH 2019 15 DA08 Plot Date:







2020	C: Use nt Sherafee Trocuments Projects 2009/2019 13 Sally Stanford Conte Rd Sheb
erry Chapman	
1920	
国際会員 第一条 第二条 国際 hstar.com.au	
nstar.com.au	

Window Type	Al. Slider	Fixed and louvres	Casement	Louvres	Casement	Fixed	Fixed	Louvres	Al. Bi-fold	Al. Slide
ID	W02	W05	W06	W07	W09	W10	W10	W11	W13	W1
From Room	Bed 3	Ens	Bed 3	Bath	Living	Living	Living	Living	Kitchen	Bed
Height Width	1,500	900	1,700	1,700	1,700	900	900	1,700	1,500	1,05
Width	1,550	1,450	600	600	600	2,600	2,600	600	2530	1,80
Eave size	1.80m	900	600	600	600	350	350	600	600	60
Glass type.	Toned	Frosted	clear	Frosted	clear	toned	toned	Clear	Clear	Clea
2D Symbol			<u> </u>	. ==	=	 		=		
Elevation	U- 4.52 SHGC 0.59	U- 3.91 SHGC 0.62 U- 4.51 SHGC 0.54	U- 4.9 SHGC 0.53	U- 4.51 SHGC 0.54	U- 4.9 SHGC 0.53	U- 3.91 SHGC 0.62		U- 4.51 SHGC 0.54	U- 4.63 SHGC 0.47	U- 4.52 SHGC 0.59

External Glass Doors

					External Glass Doors				
Window Type	Casement	Awning	Awning and Fixed	Louvres	Fixed and Pivot	Slider	Hinged and Fixed	Multi stack Slide	er Hinged and Fixed
ID	W15	W16	W18	W19	W01	W03, W04	W08	W1:	2 W17
From Room	Bed 2			Ensuite	Entry	Hall + Bed 2	Dining	Livin	
Height Width	1,350		450	900	2100,600	2140	2400	244	0 2100, 600
Width	600			600	600, 1600	1680	900,600	3600	
Eave size	900		600	900	2000	2000	600	600	
Glass type.	Clear	Clear	Clear	Frosted	Clear	Toned	Clear	Clea	r Frosted
2D Symbol		=	<u> </u>	==					
Elevation	U- 4.9 SHGC 0.53	U- 4.9 SHGC 0.53	U- 3.91 SHGC 0.62 U- 4.9 SHGC 0.53	U- 4.51 SHGC 0.54	U- 3.91 SHGC 0.62	U- 4.52 SHGC 0.59	Door U- 5.4 SHGC 0.58 U- 3.91 SHGC 0.62	U- 4.52 SHGC 0.59	Door U- 5.4 SHGC 0.58 U- 3.91 SHGC 0.62



THIS PLAN IS TO BE READ IN **CONJUNCTION WITH** THE CONDITIONS OF DEVELOPMENT CONSENT

DA2020/0815

The builder shall check and verify all dimensions and verify all errors and omissions to the Architect. Do not scale the drawings. Drawings shall not be used for construction purposes until issued by the Architect for construction.

Client
Sally Bamford and Rob Wilkie
Project Name
Bamkie House 7 Corrie Rd North Manly NSW 2100

Drawing Title:

Window and Door Schedule

Scale: as noted Date: 24.06.2020 Status: DA Checked By: SH Drawing No.: DA09 2019 15

Plot Date:



External Finishes Schedule 7 Corrie Road, North Manly June 2020



THIS PLAN IS TO BE READ IN CONJUNCTION WITH THE CONDITIONS OF DEVELOPMENT CONSENT

DA2020/0815

Item	Description	Finish	Colour	Image
Lightweight Cladding	James Hardie or Weathertex TBC	Dulux weathershield or similar	Resene, Double Gravel	
External Walls	Plywood Cladding	Natural, Limed	Porters Light White Liming	
External Walls	Austral Reclaimed Brick	Natural, recycled	Varies	
Doors and Windows	Aluminium external	Powdercoated Matt	Colorbond, Monument	
Roof and Gutters	Colorbond	Trimdek Profile	Colorbond, Monument	

Item	Description	Finish	Colour	Image
Eaves	FC sheet	Flat external finish	Dulux Natural White	
Decking	Timber Hardwood	Natural water Based	Blackbutt	
Timber trims	Posts, timber screens	Natural water Based	Blackbutt	
Handrails and Balustrades	External, Powdercoated Aluminium and StainlessSteel Wires	Stainless Steel Powdercoated Aluminium, rectangular	Colorbond, Monument Matt finish	

Notes/Additional Items





THIS PLAN IS TO BE READ IN

CONJUNCTION WITH

THE CONDITIONS OF DEVELOPMENT

CONSENT

DA2020/0815