

ACTION PLANS

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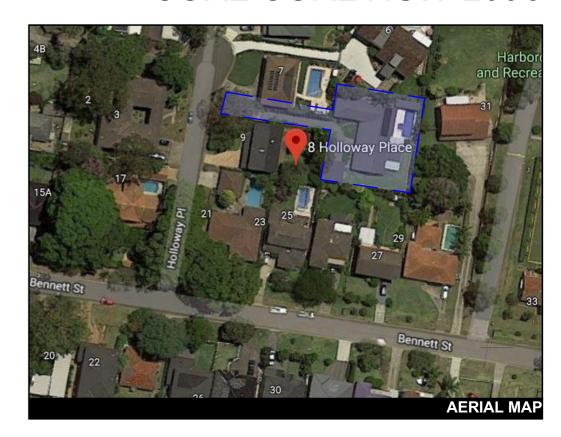
DEVELOPMENT APPLICATION

THESE PLANS ARE FOR DEVELOPEMENT APPROVAL ONLY.

ITEM DETAILS	DEVELOPMENT APPLICATION			
ADDRESS	8 HOLLOWAY PLACE, CURL CURL, NSW 209	16		
LOT & DP/SP	LOT 7 DP 242144			
COUNCIL	NORTHERN BEACHES COUNCIL (WARRING)	AH)		
SITE AREA	1081.27m ² 929.25 m ² (WITHOUT DRIVEWAY)			
FRONTAGE	N/A			
CONTROLS	PERMISSIBLE / REQUIRED	EXISTING	PROPOSED	COMPLIANCE
CONTROLS	m / m² / %	m / m² / %	m / m² / %	
<u>LEP</u>				
LAND ZONING	R2 – LOW DENSITY RESIDENTIAL	R2	R2	YES
MINIMUM LOT SIZE	450m²	1081.27m²	UNCHANGED	YES
FLOOR SPACE RATIO	NOT IDENTIFIED	N/A	N/A	N/A
MAXIMUM BUILDING HEIGHT	8.5m	4.4m	7.585m	YES
HAZARDS				
ACID SULFATE SOILS	IDENTIFIED - CLASS 5	N/A	N/A	N/A
FLOOD PLANNING	IDENTIFIED	N/A	N/A	N/A
DEVELOPMENT ON SLOPING LAND	IDENTIFIED – AREA A	N/A	N/A	N/A
HIGH/MED/LOW FLOOD RISK PRECINCT	IDENTIFIED - LOW & MED FLOOD RISK	N/A	N/A	N/A
DCP				
WALL HEIGHT	7.2m	4.1m	5.9m	YES
NUMBER OF STOREYS	N/A	N/A	N/A	N/A
SIDE BOUNDARY ENVELOPE	5m	5m	5m	YES
SIDE BOUNDARY SETBACKS	0.9m	N: 0m TO DECK N: 1.826m TO DWEL. S: 1.2m TO GARAGE S: 5.8m TO DWEL. W:1.261m TO DWEL. W: 0.985m TO GAR.	N: UNCHANGED N: UNCHANGED S: UNCHANGED S: UNCHANGED W: UNCHANGED W: 0.976 TO OFFICE	NO YES YES YES YES YES
FRONT BOUNDARY SETBACK	6.5m	N/A	N/A	N/A
REAR BOUNDARY SETBACK	6.0m	1.8m TO DECK 9.86m TO DWEL.	UNCHANGED UNCHANGED	NO YES
LANDSCAPE OPEN SPACE	40% (371.7m²)	379.77m ²	UNCHANGED	YES
PRIVATE OPEN SPACE	60m²	300.47m ²	UNCHANGED	YES

SHEET NUMBER	SHEET NAME	DATE PUBLISHE
DA00	COVER	30/03/2020
DA01	SITE ANALYSIS	30/03/2020
DA02	${\tt SITE/ROOF/SEDIMENT\ EROSION/WASTE\ MANAGEMENT/STORMWATER\ CONCEPT\ PLAN}$	30/03/2020
DA03	EXISTING GROUND FLOOR PLAN	30/03/2020
DA04	PROPOSED GROUND FLOOR PLAN	30/03/2020
DA05	PROPOSED FIRST FLOOR PLAN	30/03/2020
DA06	EXISTING GARAGE FLOOR PLAN	30/03/2020
DA07	PROPOSED CARPORT FLOOR PLAN	30/03/2020
DA08	PROPOSED HOME OFFICE FLOOR PLAN	30/03/2020
DA09	NORTH / EAST ELEVATION	30/03/2020
DA10	SOUTH / WEST ELEVATION	30/03/2020
DA11	LONG / CROSS SECTION	30/03/2020
DA12	NORTH / EAST ELEVATION - CARPORT/HOME OFFICE	30/03/2020
DA13	SOUTH / WEST ELEVATION - CARPORT/HOME OFFICE	30/03/2020
DA14	LONG / CROSS SECTION - CARPORT/HOME OFFICE	30/03/2020
DA15	AREA CALCULATIONS	30/03/2020
DA16	SAMPLE BOARD	30/03/2020
DA17	WINTER SOLSTICE 9 AM	30/03/2020
DA18	WINTER SOLSTICE 12 PM	30/03/2020
DA19	WINTER SOLSTICE 3 PM	30/03/2020
DA20	BASIX COMMITMENTS	30/03/2020

8 HOLLOWAY PLACE, CURL CURL NSW 2096



NCC & AS COMPLIANCES SPECIFICATIONS

- EARTHWORKS: METHOD OF EXCAVATIONAND FILL - PART 3.1.1 OF NCC - SURFACE SUBSOIL-STORMWATER DRAINAGE - PART 3.1.2 OF NCC

- TERMITE-RISK MANAGEMENT - PART 3.1.3 OF NCC

- FOOTINGS & SLAB - PART 3.2 OF NCC INCLUDING AS2870

- MASONRY CONSTRUCTION - PART 3.3 OF NCC INCLUDING AS3700 - SUB FLOOR VENTILATION - PART 3.4.1 OF NCC

- FRAMING - PART 3.4 OF NCC

- ROOF, WALL-CLADDING, GUTTERS & DOWNPIPES - PART 3.5 OF NCC - GLAZING - PART 3.6 OF NCC INCLUDING AS1288

- FIRE SEPARATION - PART 3.7.1 OF NCC

- SMOKE ALARMS - PART 3.7.2 OF NCC

- HEATING APPLIANCES - PART 3.7.3 OF NCC - WET AREAS-PROTECTION OF WALLS & FLOORS - PART 3.8.1 OF NCC

- MINIMUM ROOF HEIGHTS - PART 3.8.3 OF NCC

- FACILITIES REQUIRRED & SANITARY DOOR CONSTRUCTION - PART 3.8.3 OF NCC

- LIGHT: NATURAL AND ARTIFICIAL - PART 3.8.4 OF NCC - VENTILATION & LOCATION OF TOILETS - PART 3.8.5 OF NCC

- SOUND INSULATION - PART 3.8.6 OF NCC

- STAIR CONSTRUCTION INCLUDING DIMENSIONS - PART 3.9.1 OF NCC

- BALUSTRADES & OTHER BARRIERS - PART 3.9.2 OF NCC - FENCING & OTHER PROVISIONS - REGS & AS1926

- PENCING & OTHER PROVISIONS - REGS & AS 1920 - DEMOLITION WORKS - AS2601-1991 THE DEMOLITION OF STRUCTURES.

- ALL WATERPROOF MEMBRANES TO COMPLY WITH WITH AS 3740-2004
- ALL PLUMBING & DRAINAGE WORK TO COMPLY WITH AS 3500

- SITE CLASSIFICATION AS TO AS 2870

- ALL PLASTERBOARD WORK TO COMPLY WITH AS 2588-1998 - ALL STRUCTURAL STEEL WORK TO COMPLY WITH AS 4100 & AS 1554

AL STEEL WORK TO COMPLY WITH AS 4100 & AS 1554 - ALL CONCRETE WORK TO COMPLY WITH AS 3600

- ALL ROOF SHEETING WORK TO COMPLY WITH AS 1562-1992

- ALL SKYLIGHTS TO COMPLY WITH WITH AS 4285-2007

- ALL CERAMIC TILING TO COMPLY WITH AS 3958.1-2007 & 3958.2-1992
- ALL GLAZING ASSEMBLIES TO COMPLY WITH AS2047 & 1288

- ALL TIMBER RETAINING WALLS ARE TO COMPLY WITH AS 1720.1-2010,

AS 1720.2-2006, AS 1720.4-2006, AS 1170.1-1989 & AS 1170.4-1993 - ALL RETAINING WALLS ARE TO COMPLY WITH 3700 - 2011 & AS 3600 -2001

- ALL CONSTRUCTION TO COMPLY TO AS3959- 1991



DEMOLISHED

DP

DOWNPIPE

PROJECT ADDRESS

8 HOLLOWAY PLACE,

CURL CURL NSW 2096

DATE

2020

Monday, 30 March

SCALE

1:200 @A3

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SECOND DESIGN AMENDMENT

DA DOCUMENTATION

13/11/19


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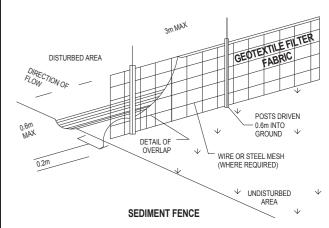
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DUST CONTROL:

TO REDUCE DUST GENERATED BY WIND ACTION, THE REMOVAL OF THE TOP SOIL IS TO BE MINIMISED. TO PREVENT DUST GENERATION, WATERING DOWN OF THE SITE, ESPECIALLY DURING THE MOVEMENT OF MACHINERY IS REQUIRED. WHERE EXCAVATING INTO ROCK, KEEP THE SURFACE MOIST TO MINIMISE DUST. CONSTRUCT A GRAVEL ENTRY/EXIT POINT USING BLUE METAL AND RESTRICT ALL VEHICLE MOVEMENTS WITHIN THE SITE TO A MINIMUM. ENSURE WIND BREAKS, SUCH AS EXISTING FENCES ARE MAINTAINED DURING THE CONSTRUCTION PHASE UNTIL NEW LANDSCAPING IS PROVIDED OR REINSTATED. PREVENT DUST BY COVERING STOCKPILES

SEDIMENT NOTE:

- 1. ALL EROSION AND SEDIMENT CONTROL MEASURES TO BE INSPECTED AND MAINTAINED DAILY BY THE SITE MANAGER.
- 2. MINIMISE DISTURBED AREAS, REMOVE EXCESS SOIL FROM EXCAVATEDAREA AS SOON AS POSSIBLE. 3. ALL MATERIAL STOCKPILE TO BE CLEAR FROM DRAINS, GUTTERS AND FOOTPATHS, OR WITHIN SEDIMENT FENCE AREA
- 4. DRAINAGE TO BE CONNECTED TO STORMWATER AS SOON AS POSSIBLE. IF STORED ON SITE, IT MUST BE FILTERED BEFORE RELEASING INTO STORMWATER SYSTEM OR WATERWAYS.
- 5. ROADS AND FOOTPATHS TO BE SWEPT DAILY.

STOCKPILES:

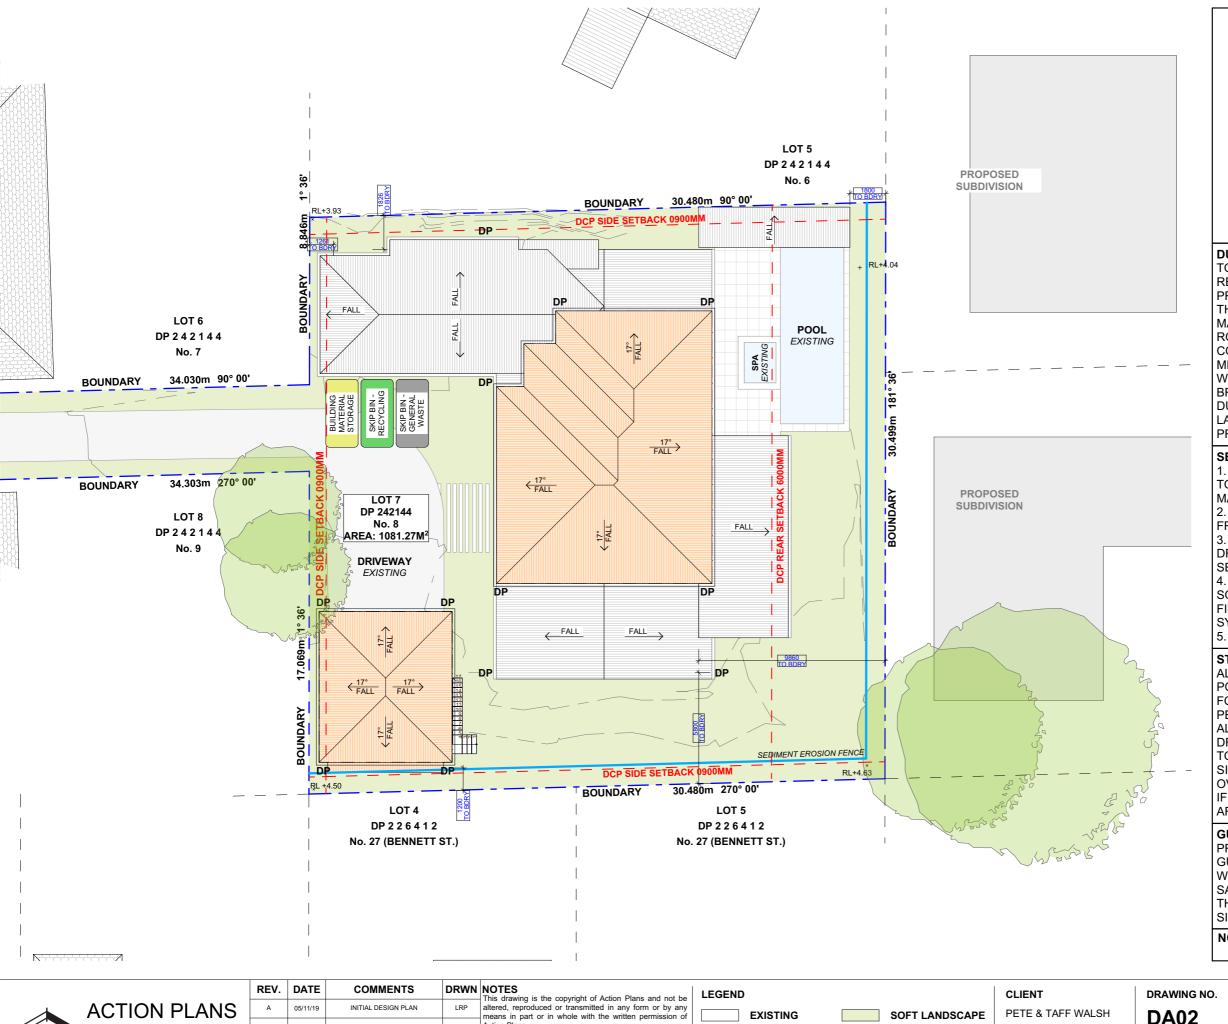ALL STOCKPILES ARE TO BE KEPT ON-SITE WHERE POSSIBLE. ANY MATERIALS PLACED ON THE FOOTPATHS OR NATURE STRIPS REQUIRE COUNCIL'S PERMISSION.

ALL STOCKPILES ARE TO BE PLACED AWAY FROM THE DRAINAGE LINES AND STREET GUTTERS. IT IS BEST TO LOCATE THESE ON THE HIGHEST PART OF THE SITE IF POSSIBLE. PLACE WATERPROOF COVERING OVER STOCKPILES.

IF REQUIRED PROVIDE DIVERSION DRAIN & BANK AROUND STOCKPILES.

GUTTER PROTECTION:

PROVIDE PROTECTION TO DOWNHILL GRATE IN GUTTER BY MEANS OF SAND BAGS OR BLUE METAL WRAPPED IN GEOTEXTILE FABRIC. WHEN SOIL OR SAND BUILDS UP AROUND THIS SEDIMENT BARRIER, THE MATERIAL SHOULD BE RELOCATED BACK TO THE SITE FOR DISPOSAL.

NOTE: ALL PROPOSED STORMWATER TO CONNECT WITH EXISTING




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Do not scale measure from draw

dimensions on site prior to commencement of any work,



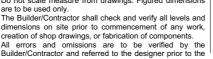

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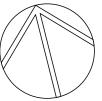
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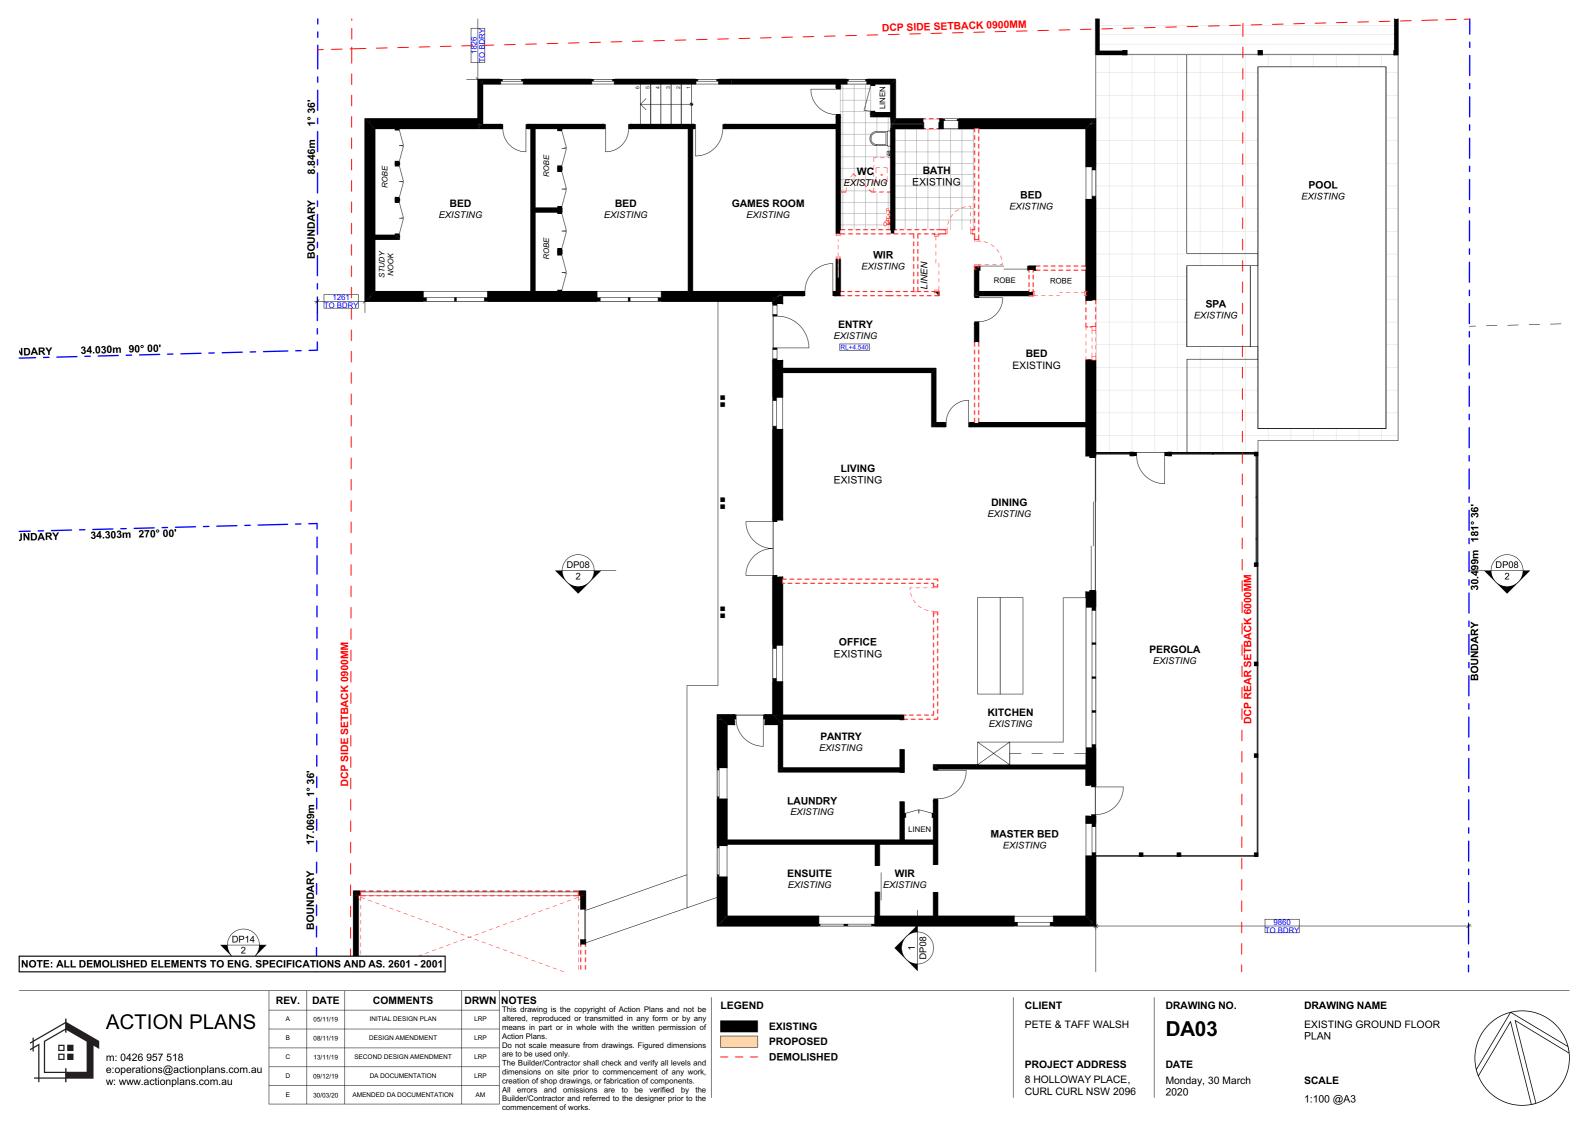
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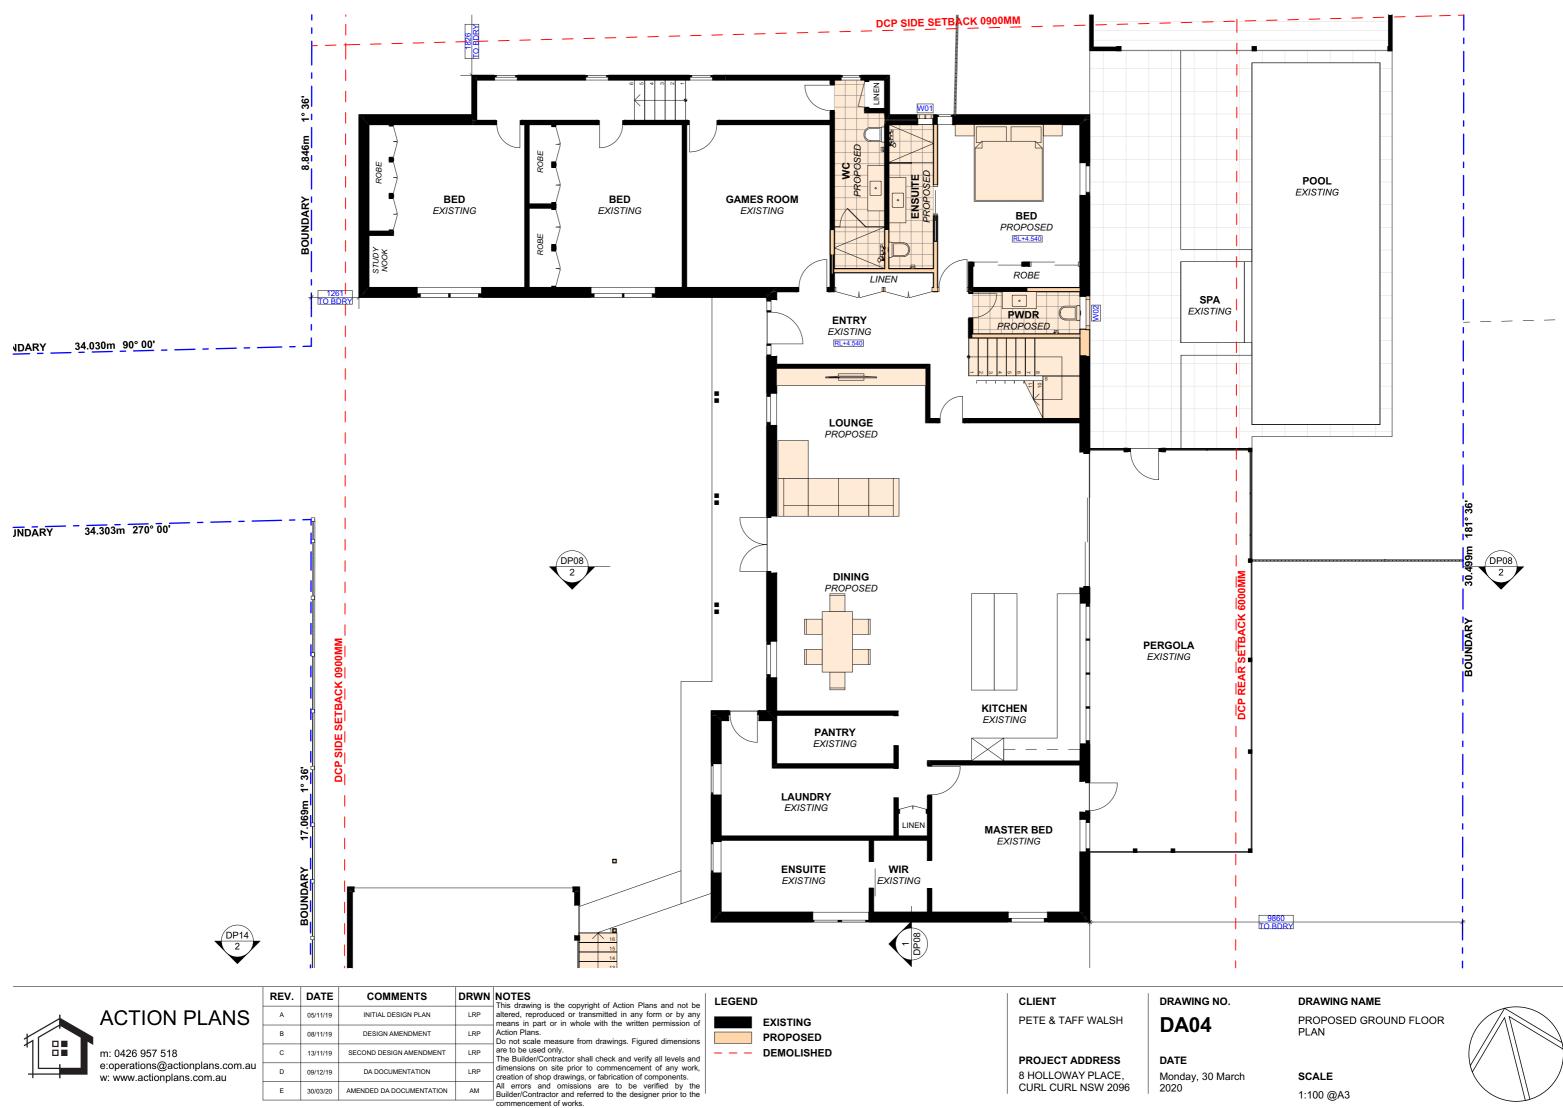
SITE / ROOF / SEDIMENT **EROSION / WASTE** MANAGEMENT / STORMWATER CONCEPT PLAN

SCALE

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commencement of works.


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commencement of works.

PROPOSED --- DEMOLISHED

PROJECT ADDRESS 8 HOLLOWAY PLACE, CURL CURL NSW 2096

DATE Monday, 30 March


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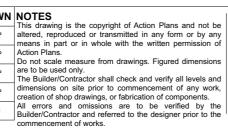


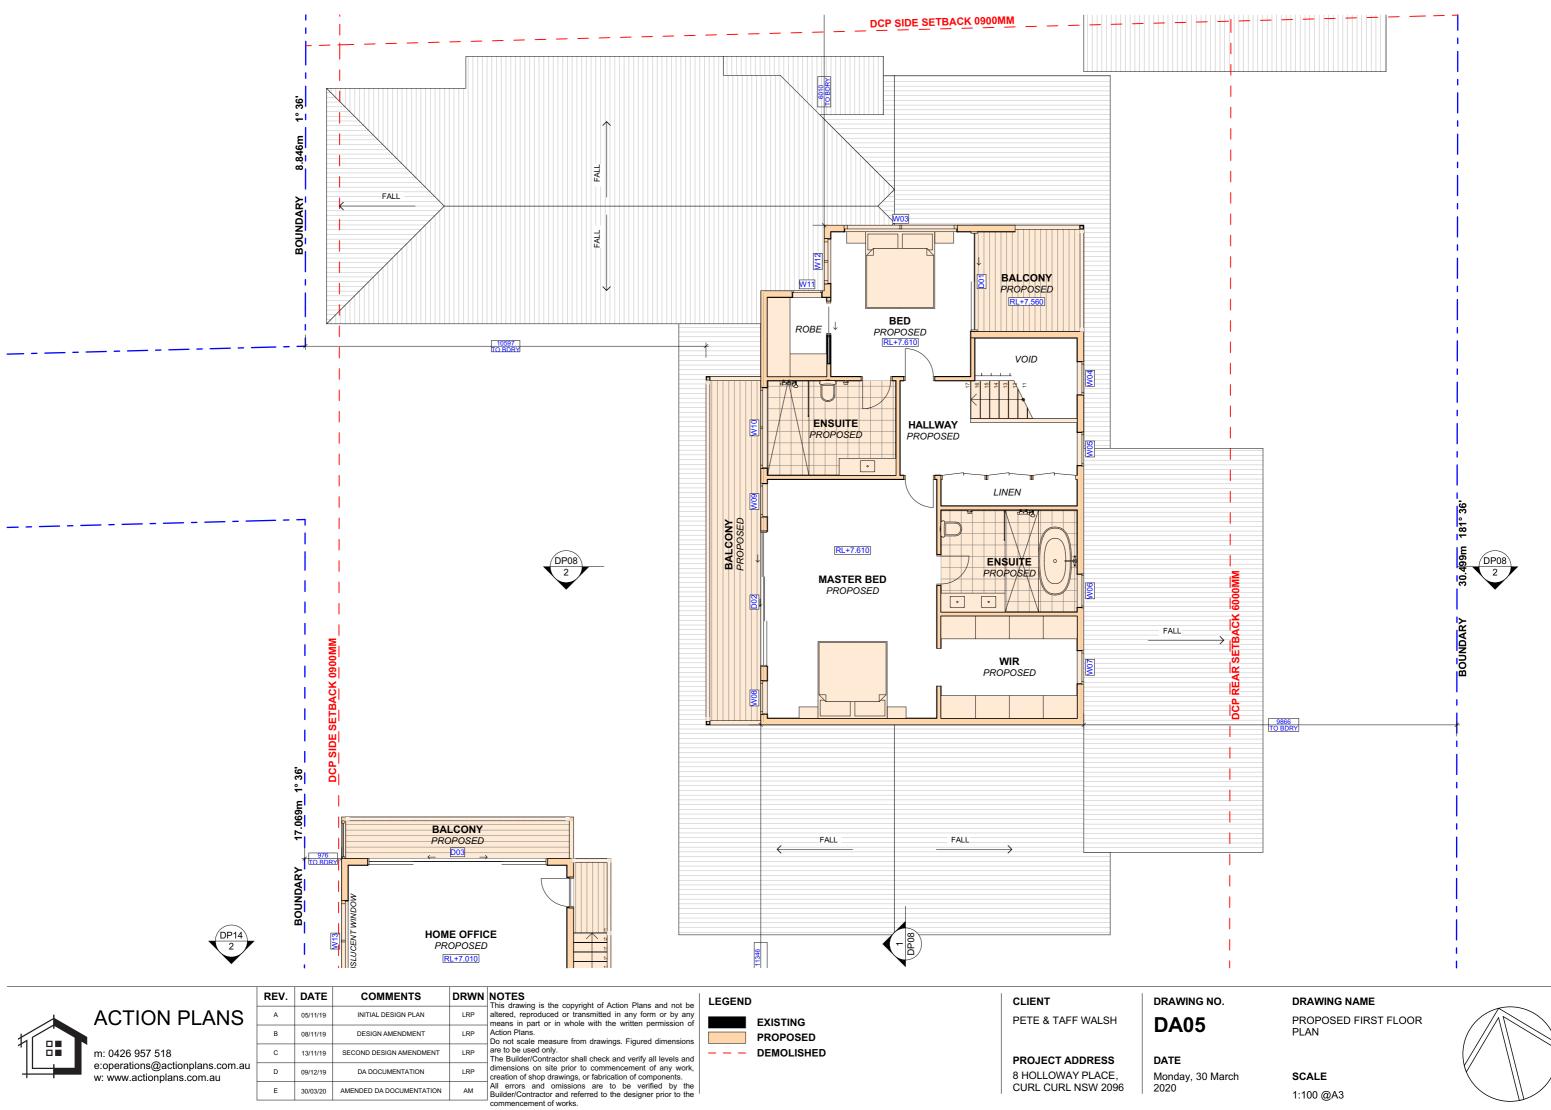


NOTE: ALL DEMOLISHED ELEMENTS TO ENG. SPECIFICATIONS AND AS. 2601 - 2001



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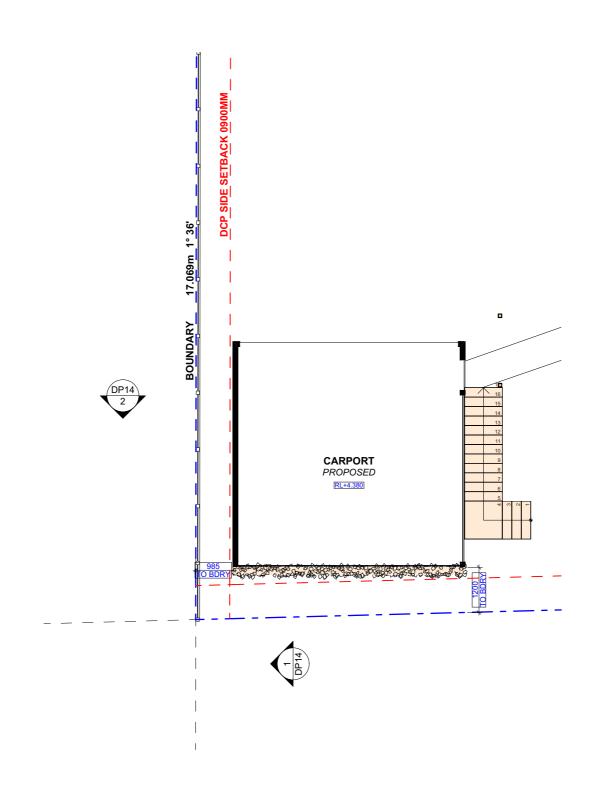
DATE Monday, 30 March 2020 DRAWING NAME

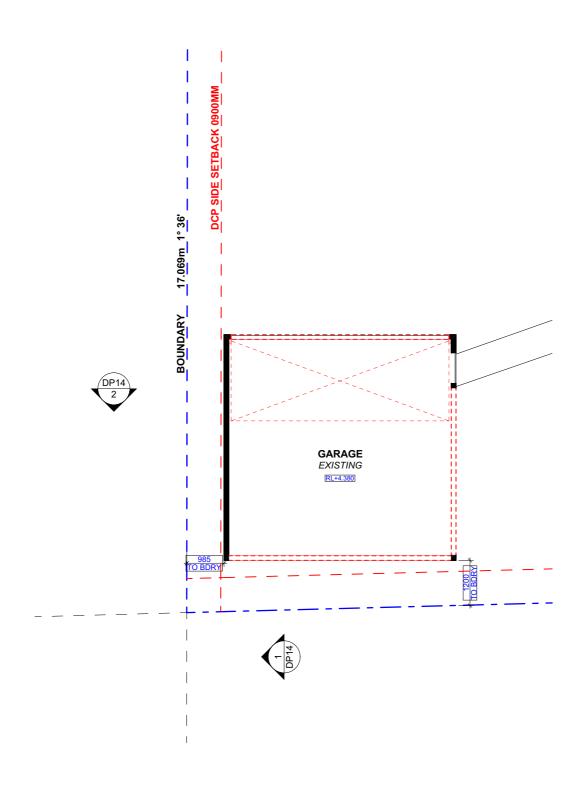EXISTING GARAGE FLOOR PLAN

SCALE
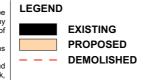
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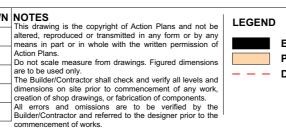






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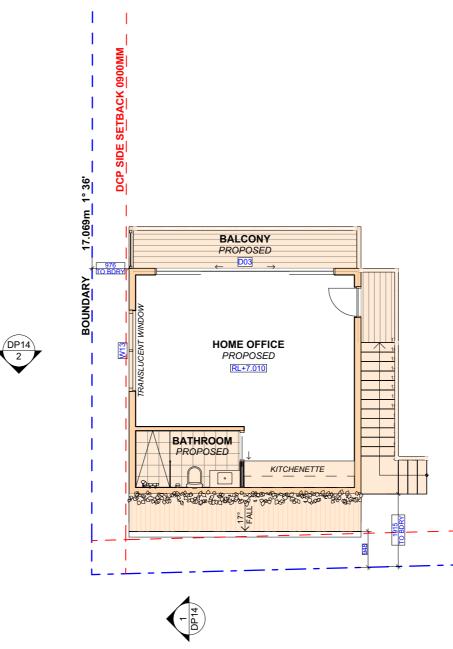
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DA07

DATE Monday, 30 March 2020 DRAWING NAME

PROPOSED CARPORT FLOOR PLAN







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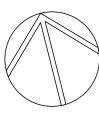
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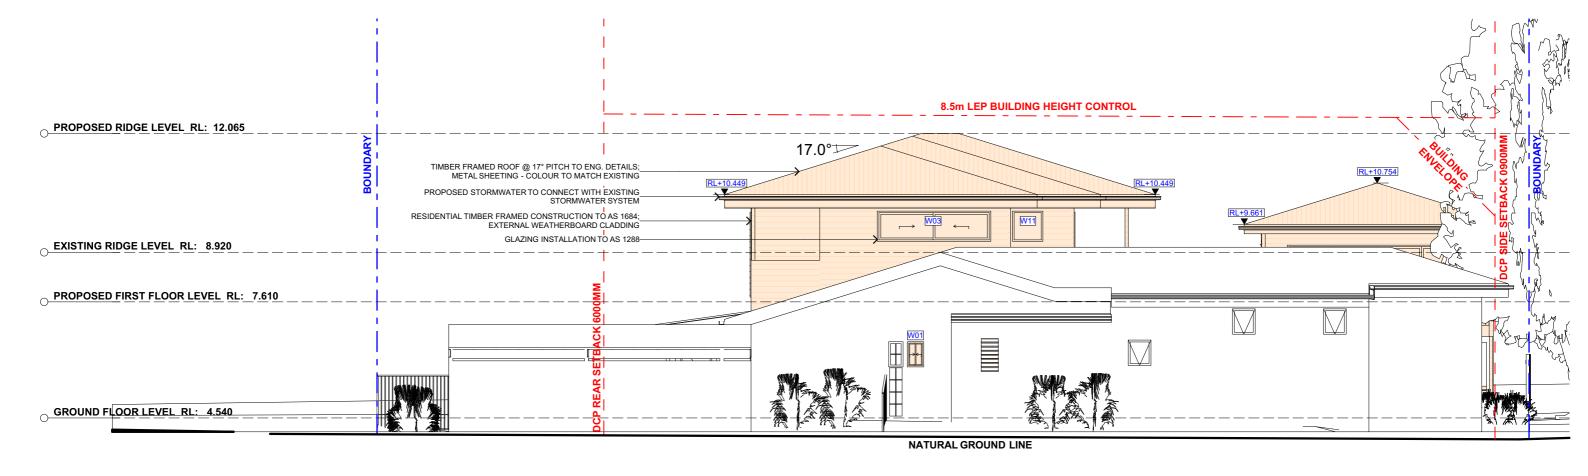
DA08

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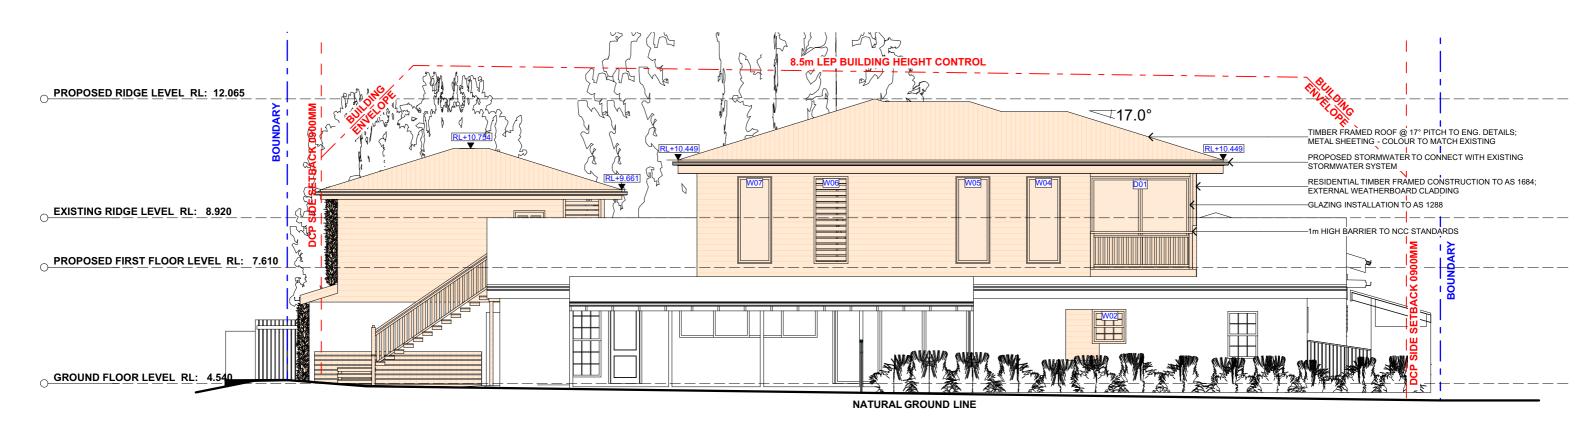
1:100 @A3

DRAWING NAME PROPOSED HOME OFFICE FLOOR PLAN SCALE





1 NORTH ELEVATION 1:100



2 EAST ELEVATION 1:100



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DA09

9 NORTH / EAST ELEVATION

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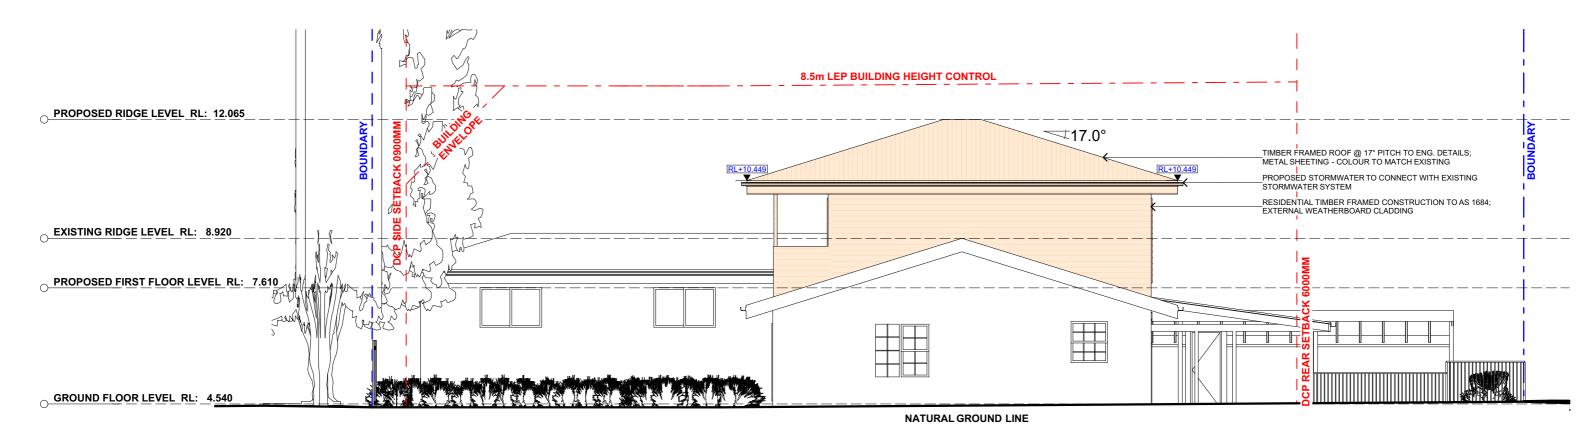
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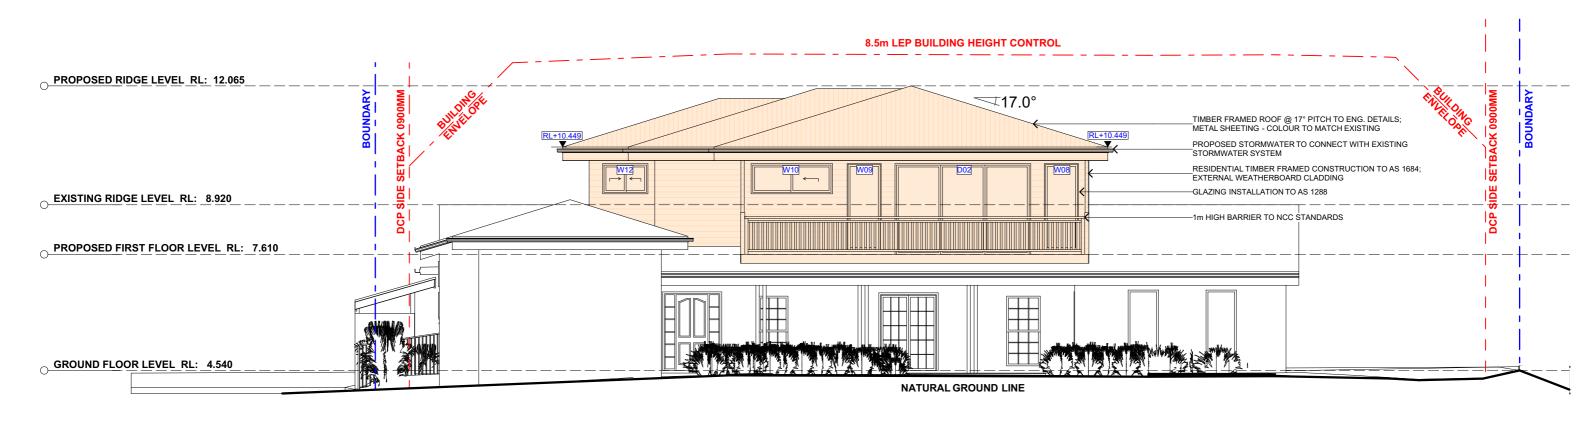
SCALE

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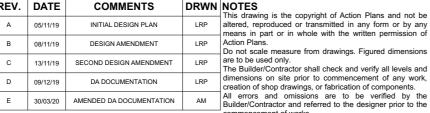
SOUTH ELEVATION 1:100




WEST ELEVATION 1:100



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					commencement of works.



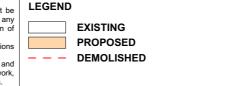

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PROJECT ADDRESS
8 HOLLOWAY PLACE,
CURL CURL NSW 2096

DRAWING NO.
DA10


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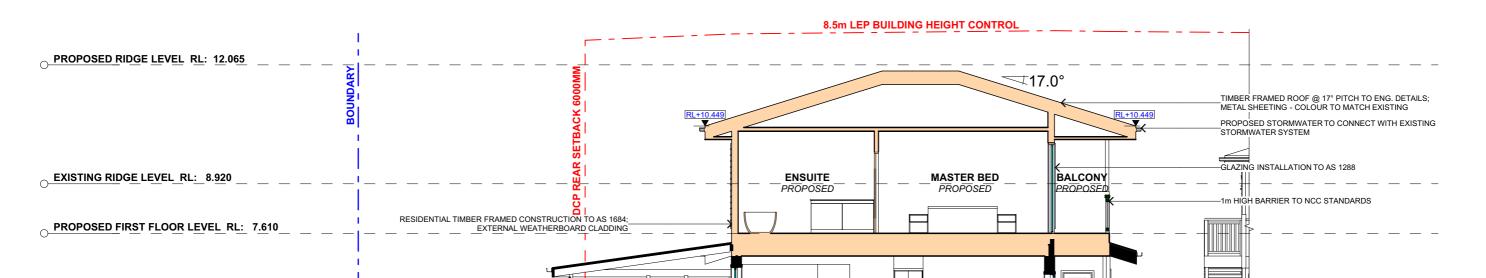
SOUTH / WEST ELEVATION

DRAWING NAME

DATE

Monday, 30 March



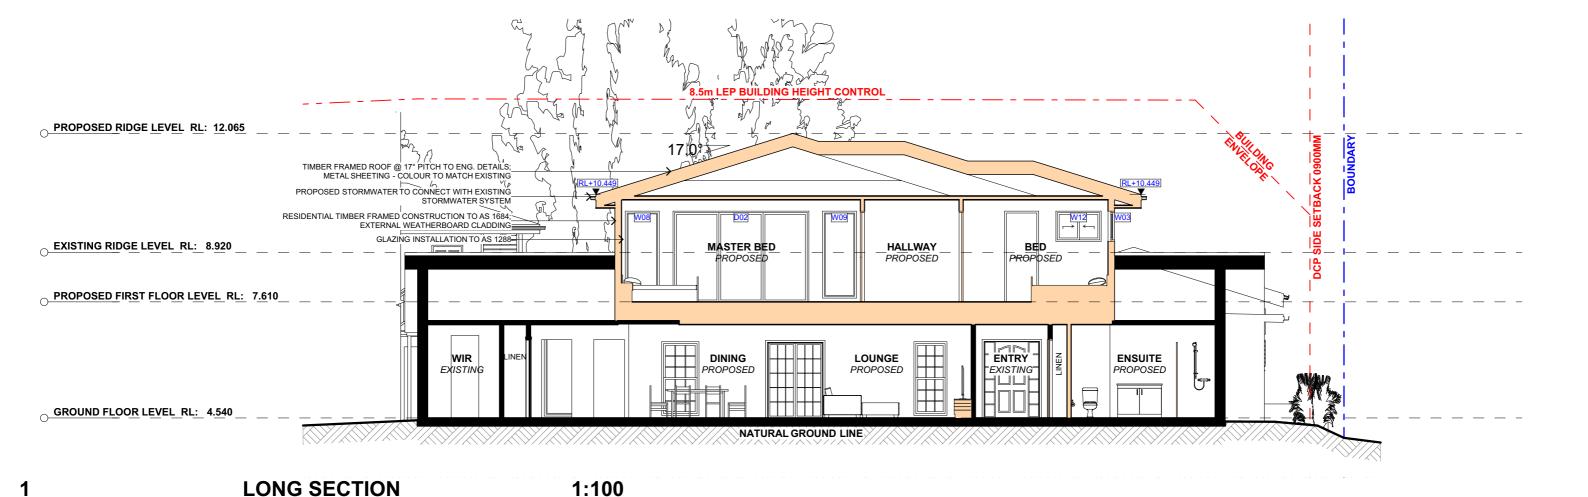

KITCHEN

EXISTING

CROSS SECTION 1:100



GROUND FLOOR LEVEL_RL: 4.540

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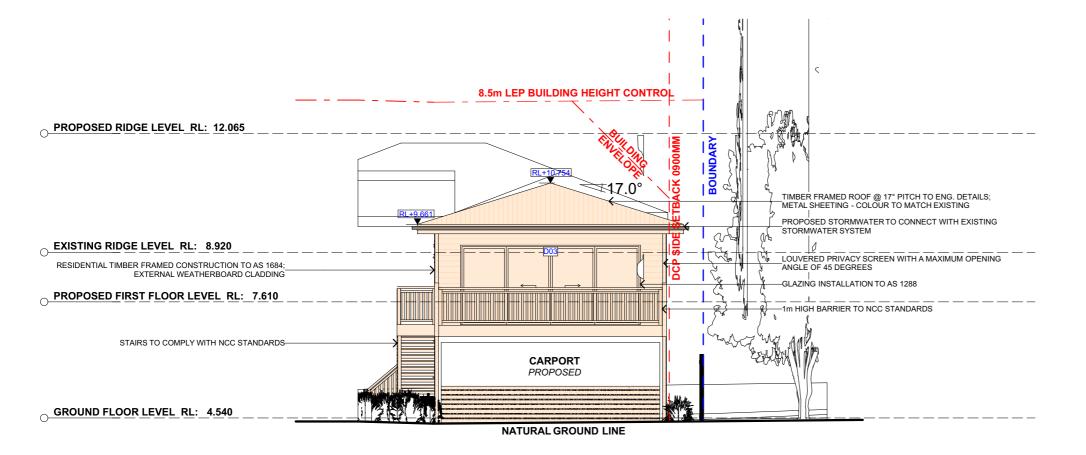
NATURAL GROUND LINE

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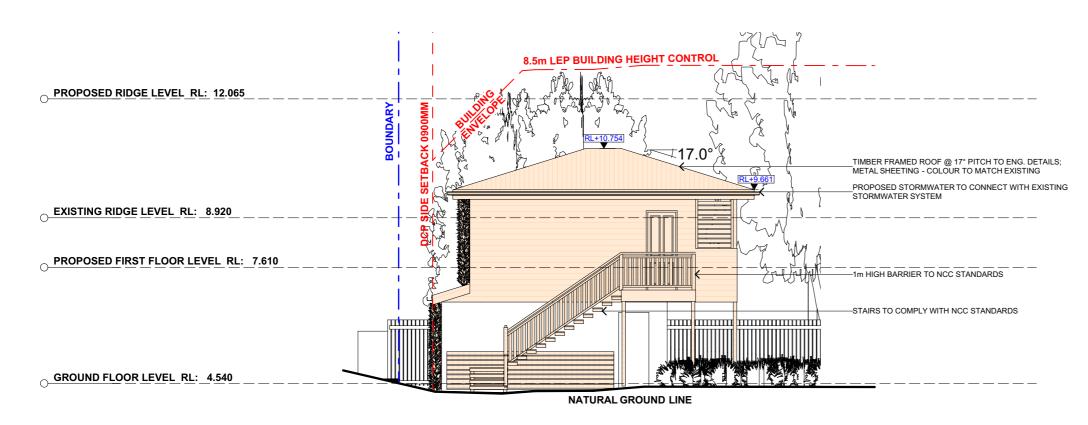
LONG / CROSS SECTION

DRAWING NAME

PROJECT ADDRESS DATE 8 HOLLOWAY PLACE, Monday, 30 March CURL CURL NSW 2096 2020



1 NORTH ELEVATION - CARPORT/ HOME OFFICE 1:100



2 EAST ELEVATION - CARPORT/HOME OFFICE 1:10



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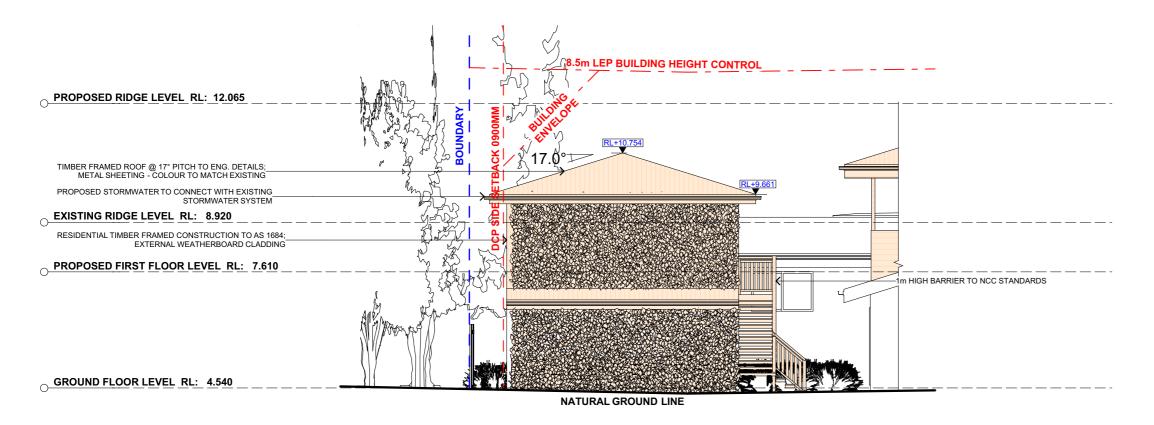
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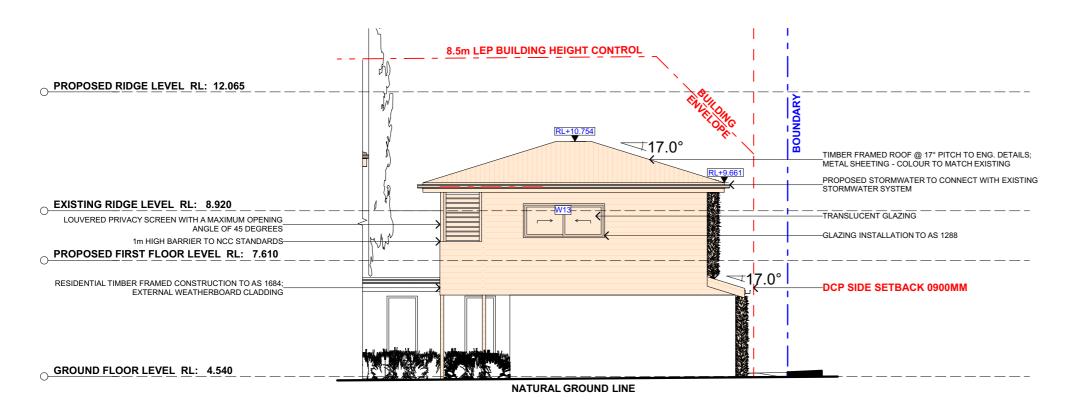
PROJECT ADDRESS 8 HOLLOWAY PLACE, CURL CURL NSW 2096 DA12

DATE Monday, 30 March 2020 DRAWING NAME

NORTH / EAST ELEVATION -CARPORT/HOME OFFICE



SOUTH ELEVATION - CARPORT/HOME OFFICE 1:100



2 WEST ELEVATION - CARPORT/HOME OFFICE 1:100



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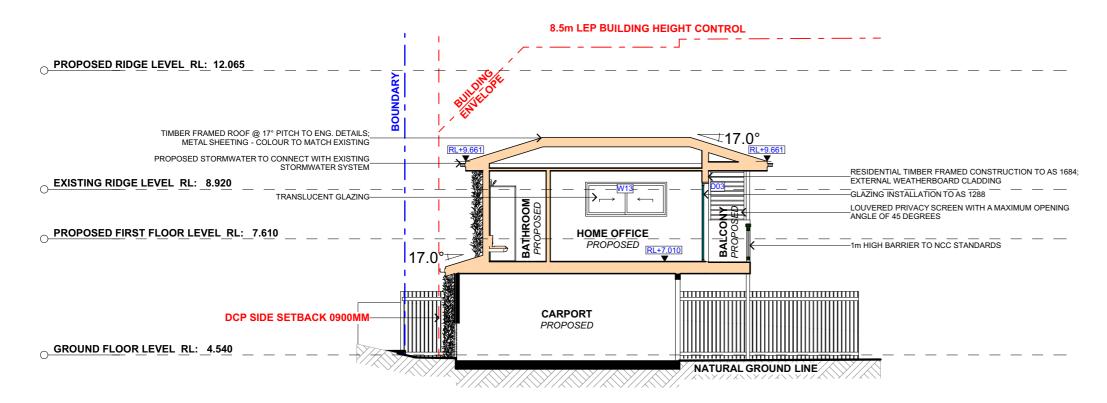
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CLIENT


PROJECT ADDRESS 8 HOLLOWAY PLACE, CURL CURL NSW 2096 DA13

DATE Monday, 30 March 2020 DRAWING NAME

SOUTH / WEST ELEVATION -CARPORT/HOME OFFICE




LONG SECTION - CARPORT/HOME OFFICE 1:100

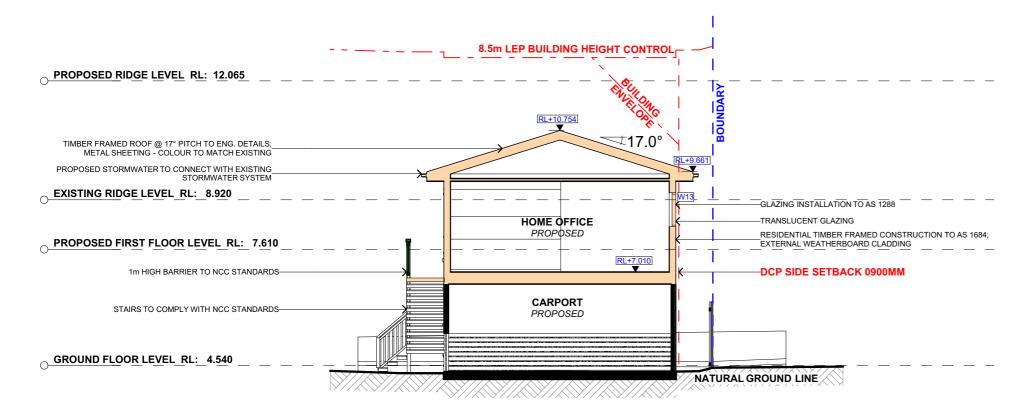

CROSS SECTION - CARPORT/HOME OFFICE 1:100



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В	08/11/19	DESIGN AMENDMENT	LRP	Action Plans. Do not scale measure from drawings. Figured dimensions
С	13/11/19	SECOND DESIGN AMENDMENT	LRP	are to be used only. The Builder/Contractor shall check and verify all levels and
D	09/12/19	DA DOCUMENTATION	LRP	dimensions on site prior to commencement of any work, creation of shop drawings, or fabrication of components.
E	30/03/20	AMENDED DA DOCUMENTATION	AM	All errors and omissions are to be verified by the Builder/Contractor and referred to the designer prior to the

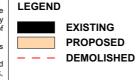

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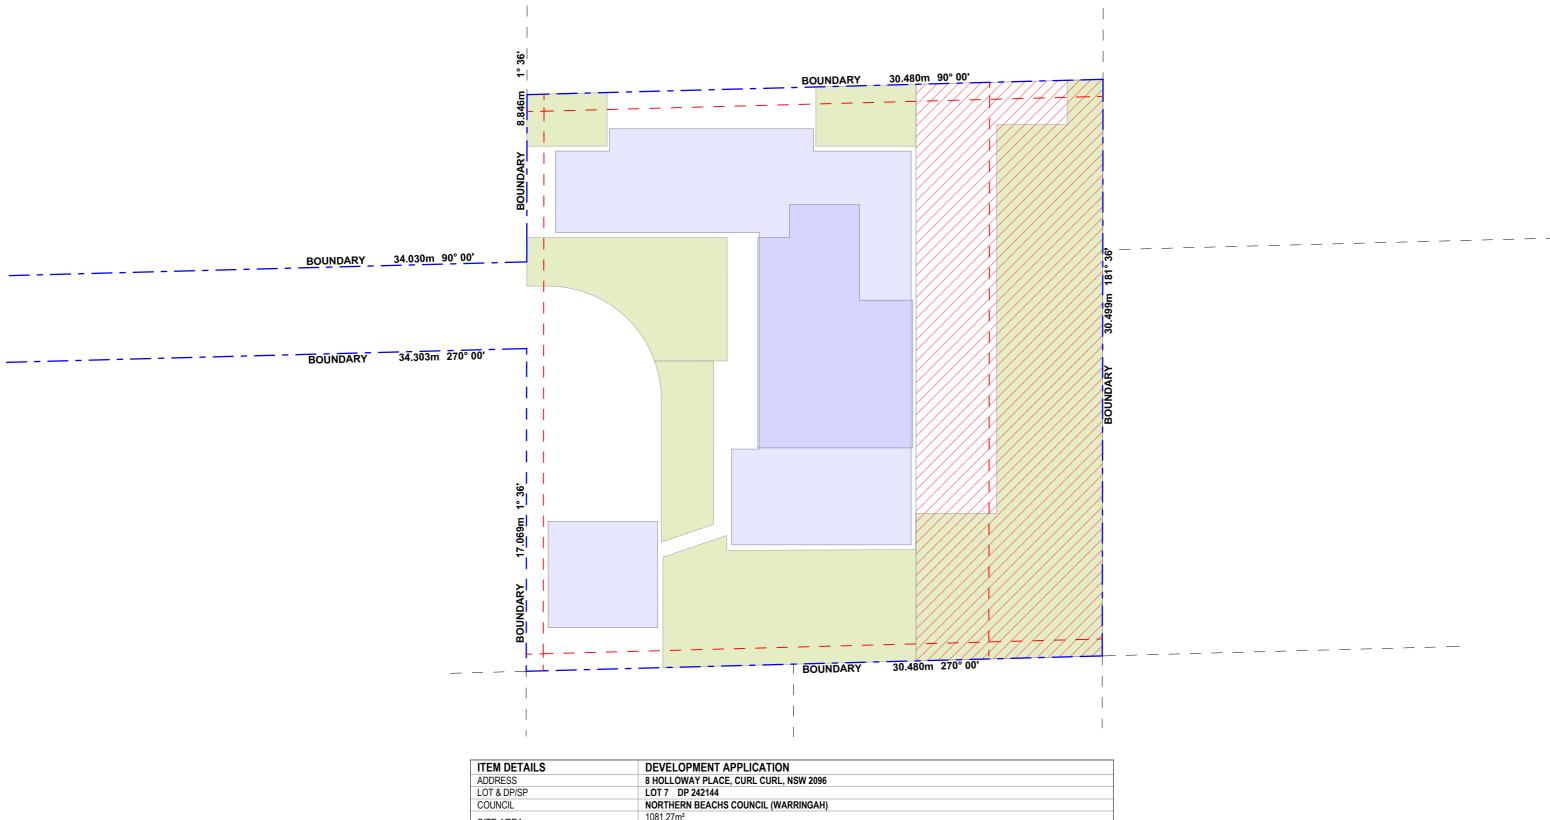
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PROJECT ADDRESS 8 HOLLOWAY PLACE, CURL CURL NSW 2096 DRAWING NO. **DA14**

2020

DATE Monday, 30 March

DRAWING NAME LONG / CROSS SECTION -CARPORT/HOME OFFICE



ITEM DETAILS	DEVELOPMENT APPLICATION			
ADDRESS	8 HOLLOWAY PLACE, CURL CURL, NSW 2096			
LOT & DP/SP	LOT 7 DP 242144			
COUNCIL	NORTHERN BEACHS COUNCIL (WARRINGAH)			
SITE AREA	1081.27m ² 929.25 m ² (WITHOUT DRIVEWAY)			
CONTROLS	PERMISSIBLE / REQUIRED	EXISTING	PROPOSED	COMPLIANCE
CONTROLS	m / m² / %	m / m² / %	m / m² / %	
LEP				
LAND ZONING	R2 – LOW DENSITY RESIDENTIAL	R2	R2	YES
MINIMUM LOT SIZE	450m²	1081.27m²	UNCHANGED	YES
FLOOR SPACE RATIO	NOT IDENTIFIED	N/A	N/A	N/A
DCP				
LANDSCAPE OPEN SPACE	40% (371.7m²)	379.77m ²	UNCHANGED	YES
PRIVATE OPEN SPACE	60m²	300.47m ²	UNCHANGED	YES



	REV.	DATE	COMMENTS	DRWN	NOTES
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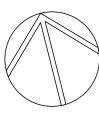
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PROJECT ADDRESS 8 HOLLOWAY PLACE, CURL CURL NSW 2096 DRAWING NO.

DATE

DRAWING NAME
AREA CALCULATIONS

Monday, 30 March 2020





RWF-01 RENDERED WALL FINISH.

'SURFMIST' OR SIMILAR TO MATCH EXISTING.

WHERE MARKED ON ELEVATION.



ASD-01 ALUMINIUM SLIDING DOOR.

'IRONSTONE & CLEAR FINISH' OR SIMILAR

WHERE MARKED ON ELEVATION.





PAINTED COLOURBOND METAL ROOF SHEETING.

'IRONSTONE' OR SIMILAR TO MATCH EXISTING.

WHERE MARKED ON ELEVATION.



AWF-01 ALUMINIUM WINDOW FRAME.

SASH.

'IRONSTONE & CLEAR FINISH' OR SIMILAR

WHERE MARKED ON ELEVATION.



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REV.	DATE	COMMENTS	DRWN	N
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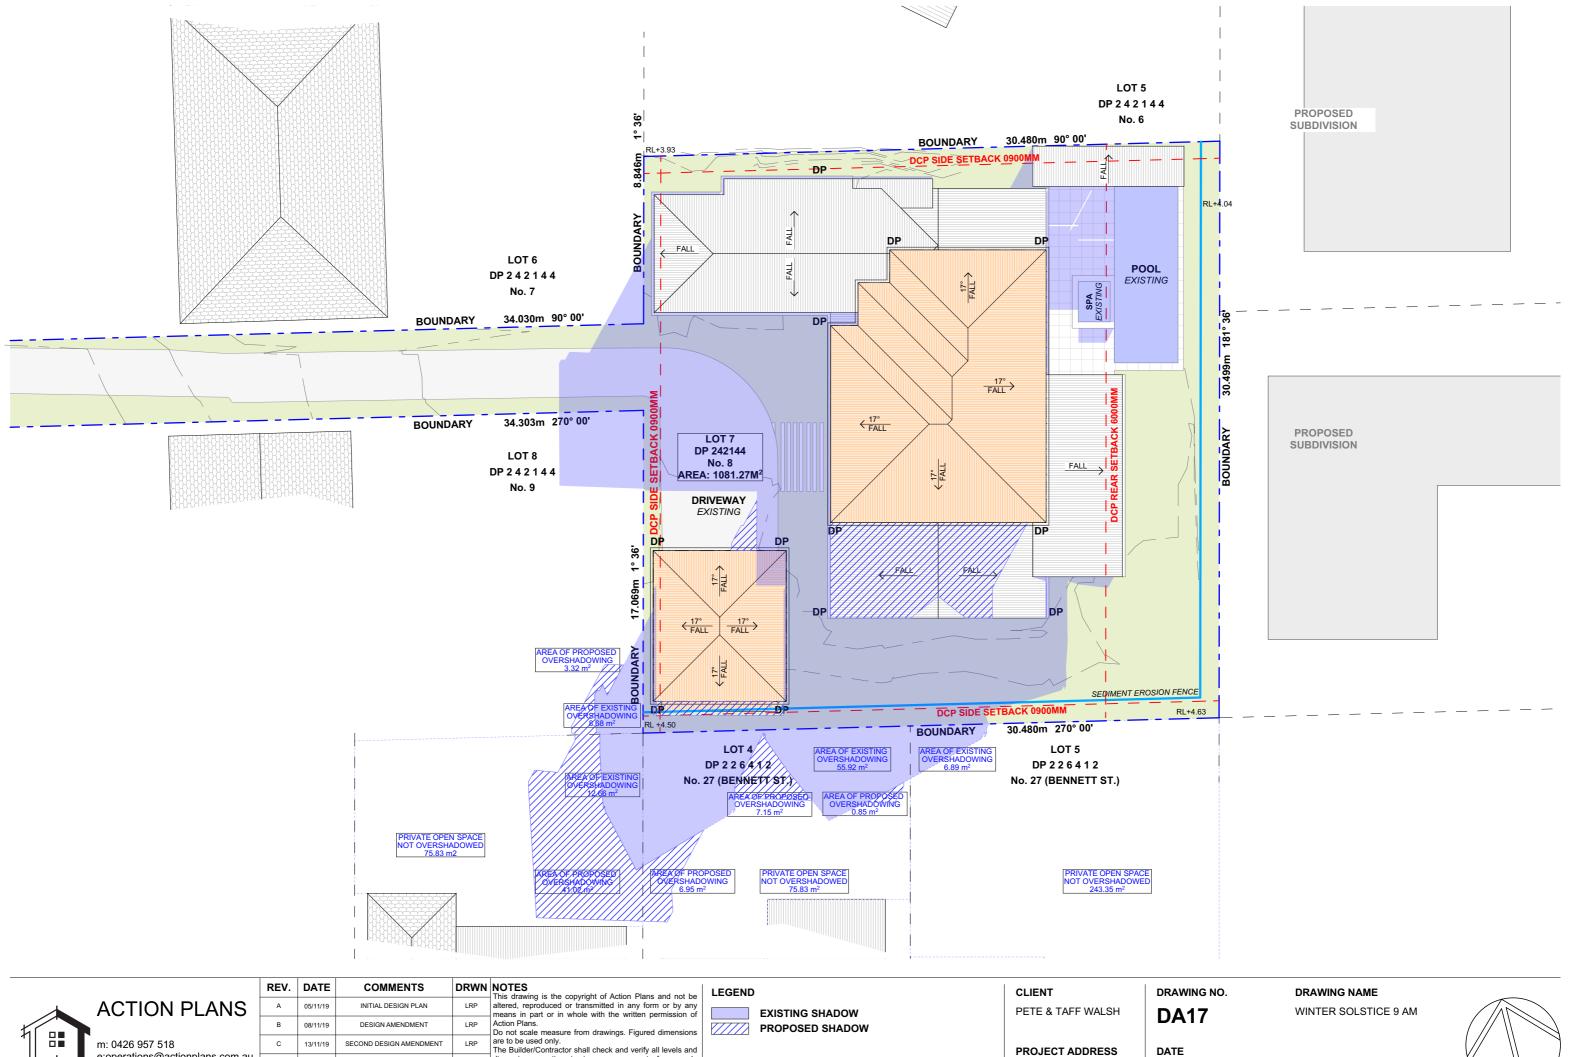
DA16

DATE Monday, 30 March 2020

DRAWING NAME SAMPLE BOARD

SCALE

@A3





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	В	08/11/19	DESIGN AMENDMENT	LRP	Action Plans. Do not scale measure from drawings. Figured dimensions
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1	D	09/12/19	DA DOCUMENTATION	LRP	dimensions on site prior to commencement of any work, creation of shop drawings, or fabrication of components.
	E	30/03/20	AMENDED DA DOCUMENTATION	AM	All errors and omissions are to be verified by the Builder/Contractor and referred to the designer prior to the
					commencement of works.


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8 HOLLOWAY PLACE,

CURL CURL NSW 2096

Monday, 30 March 2020





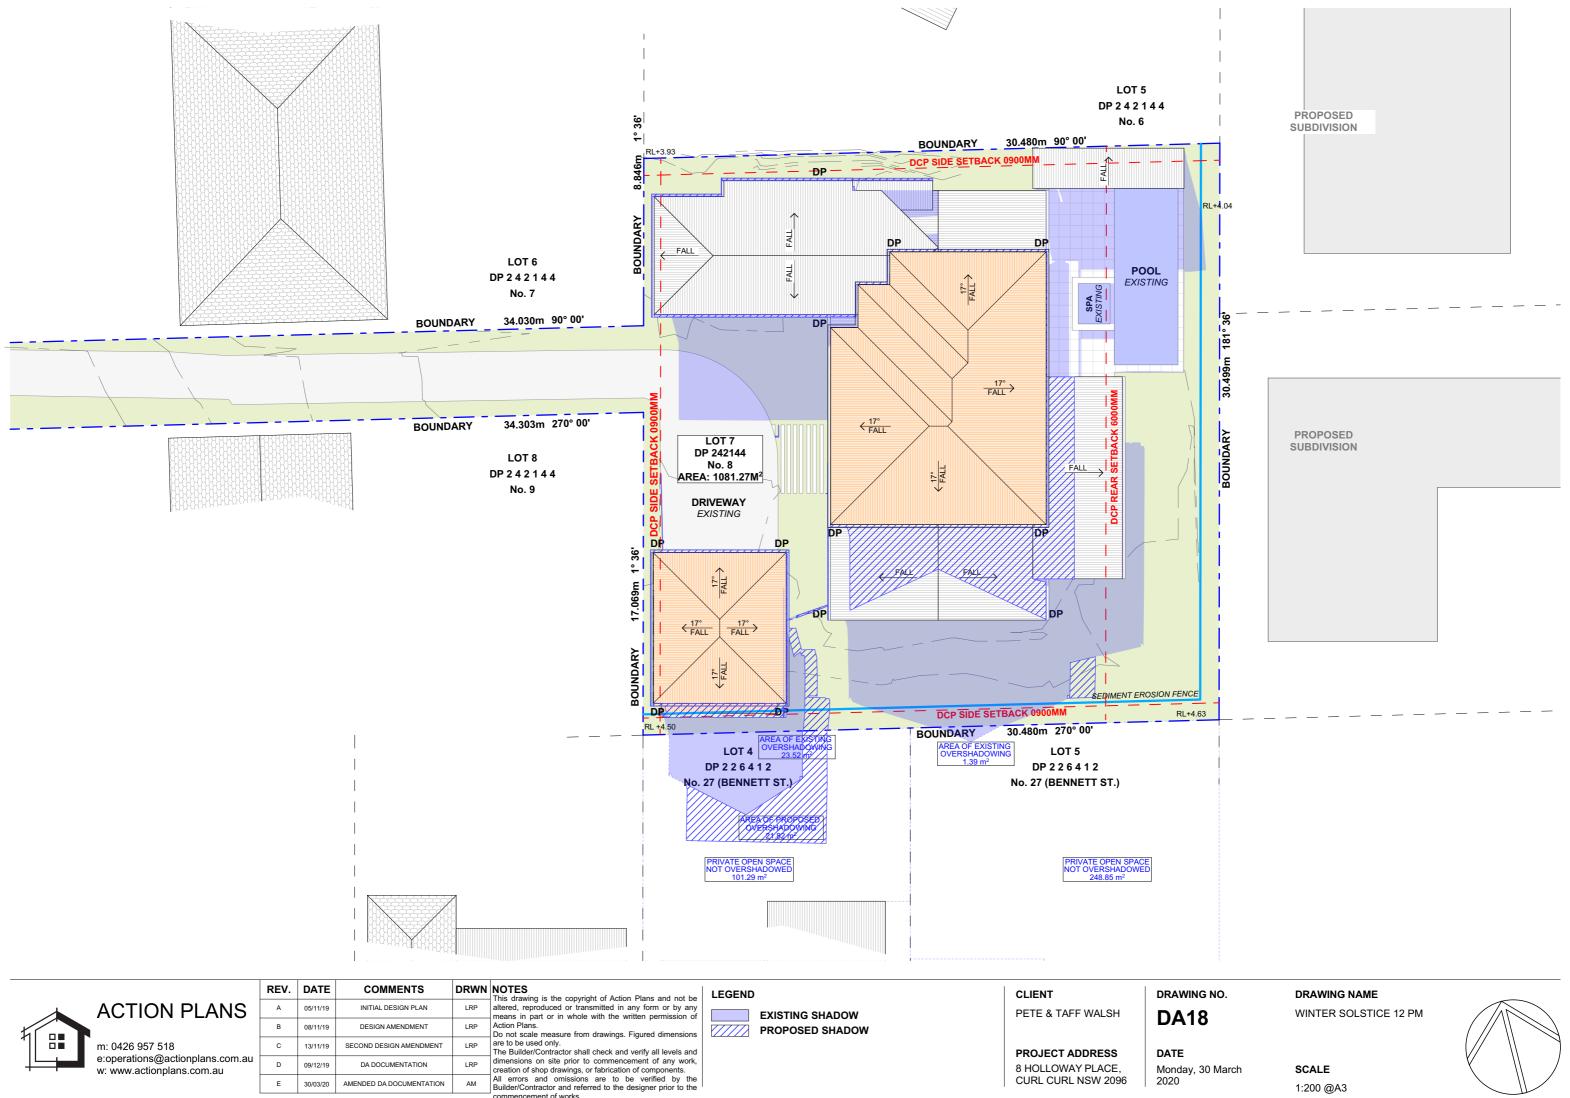

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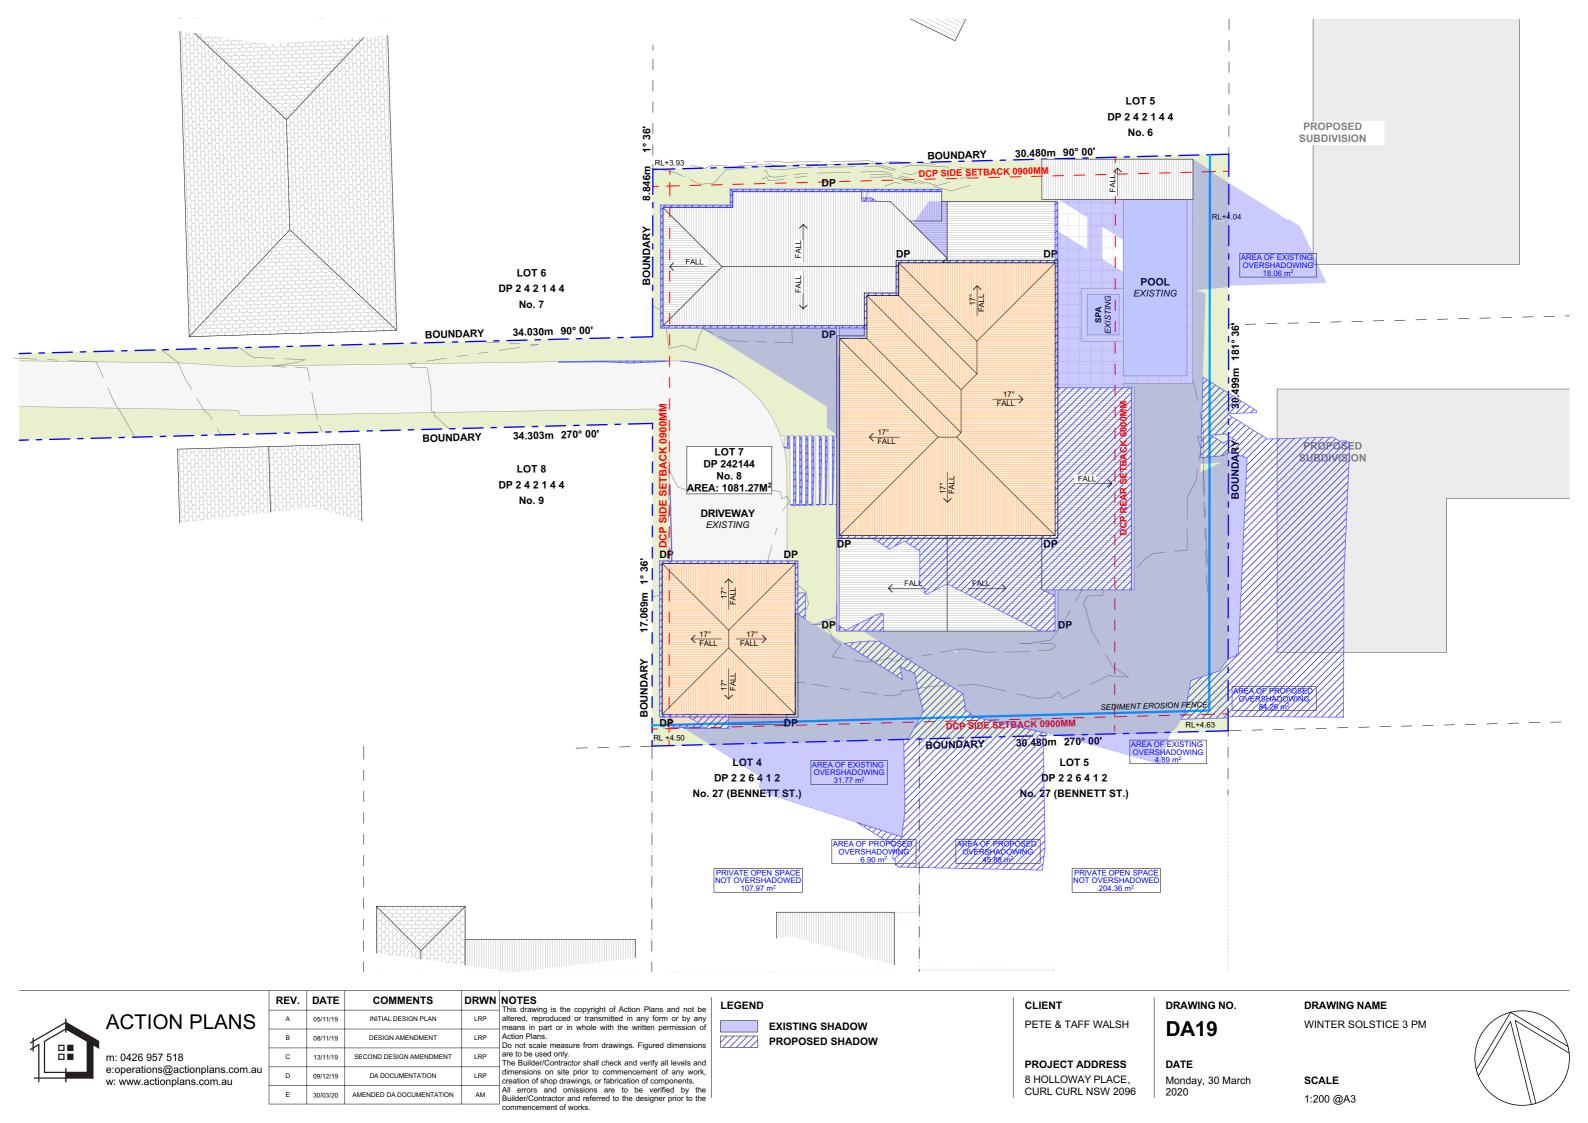
8 HOLLOWAY PLACE, CURL CURL NSW 2096

SCALE 1:200 @A3

Monday, 30 March

2020





BASIX Certificate

Building Sustainability Index www.basix.nsw.gov.au

Alterations and Additions

Certificate number: A365107

This certificate confirms that the proposed development will meet the NSW government's requirements for sustainability, if it is built in accordance with the commitments set out below. Terms used in this certificate, or in the commitments, have the meaning given by the document entitled "BASIX Alterations and Additions Definitions" dated 06/10/2017 published by the Department. This document is available at www.basix.nsw.gov.au

Secretary
Date of issue: Thursday, 28, November 2019
To be valid, this certificate must be lodged within 3 months of the date of issue.



Project address Project name Street address	8 HOLLOWAY PLACE, CURL CURL NSW 20 8 HOLLOWAY Place CURL CURL 2096
Local Government Area	Northern Beaches Council
Plan type and number	Deposited Plan 242144
Lot number	7
Section number	
Project type	
Dwelling type	Separate dwelling house
Type of alteration and addition	My renovation work is valued at \$50,000 or mand does not include a pool (and/or spa).

Certificate Prepared by (please complete before submitting to Council or PCA)
Name / Company Name: Action Plans
ABN (if applicable): 17118297587

Fixtures and systems	Show on DA Plans	Show on CC/CDC Plans & specs	Certifier Check
Lighting			
The applicant must ensure a minimum of 40% of new or altered light fixtures are fitted with fluorescent, compact fluorescent, or light-emitting-diode (LED) lamps.		~	✓
Fixtures			
The applicant must ensure new or altered showerheads have a flow rate no greater than 9 litres per minute or a 3 star water rating.		✓	✓
The applicant must ensure new or altered toilets have a flow rate no greater than 4 litres per average flush or a minimum 3 star water rating.		✓	✓
The applicant must ensure new or altered taps have a flow rate no greater than 9 litres per minute or minimum 3 star water rating.		✓	

Construction	Show on DA Plans	Show on CC/CDC Plans & specs	Certifier Check		
nsulation requirements					
The applicant must construct the new or alterethe table below, except that a) additional insula	✓	✓	✓		
		istadant is loss than zinz, by insulation opening	-		
is not required for parts of altered construction Construction		Other specifications	-		
is not required for parts of altered construction	where insulation already exists.	.,	_		
is not required for parts of altered construction Construction	where insulation already exists. Additional insulation required (R-value)	.,	_		

Legend
In these commitments, "applicant" means the person carrying out the development.

Commitments identified with a "v" in the "Show on DA plans" column must be shown on the plans accompanying the development application for the proposed development (if a levelopment application is to be lodged for the proposed development).

Commitments identified with a "v" in the "Show on CC/CDC plans & specs" column must be shown in the plans and specifications accompanying the application for a construction certificate / complying development certificate for the proposed development.

Commitments identified with a "v" in the "Certifier check" column must be certified by a certifying authority as having been fulfilled, before a final occupation certificate for the development may be issued.

	equirements						Show on DA Plans	Show on CC/CDC Plans & specs	Certifier Check
Vindows a	and glazed do	ors				·			
					hading devices, in accordance with reach window and glazed door.	the specifications listed in the table below.	✓	✓	~
The followin	g requirements	must also	be satisf	ied in relatior	n to each window and glazed door:			✓	~
have a U-va must be cald	lue and a Solar culated in accord	Heat Gair dance with	n Coeffici h Nationa	ent (SHGC) r	no greater than that listed in the tab	ear glazing, or toned/air gap/clear glazing must le below. Total system U-values and SHGCs s. The description is provided for information		~	~
					f each eave, pergola, verandah, bal than 2400 mm above the sill.	lcony or awning must be no more than 500 mm	✓	✓	✓
Pergolas wit	th polycarbonate	roof or s	imilar tra	nslucent mate	erial must have a shading coefficien	nt of less than 0.35.		✓	~
Dorgolas wit	th fixed battens i	must have				ich they are situated, unless the pergola also		_	_
		dow. The	spacing I	petween batte	ens must not be more than 50 mm.				_
shades a pe Overshadow specified in	erpendicular wind ving buildings or the 'overshadow	vegetatio	on must b	e of the heightable below.	ht and distance from the centre and	the base of the window and glazed door, as	~	✓	~
shades a pe Overshadow specified in Windows	erpendicular wind wing buildings or the 'overshadow and glazed o	vegetatio	on must b nn in the	e of the heightable below.	nt and distance from the centre and	the base of the window and glazed door, as	~	✓	✓
shades a per Overshadow specified in Windows Window / do	erpendicular wind ving buildings or the 'overshadow	vegetatio	on must b nn in the	e of the heightable below.	ht and distance from the centre and		~	✓	~
shades a pe Overshadow specified in Windows Window / do no.	erpendicular wind wing buildings or the 'overshadow and glazed o	vegetation	on must be mn in the lazing in Oversh Height	e of the heightable below. requirementation adowing Distance	nt and distance from the centre and	the base of the window and glazed door, as	~	V	✓
shades a pe Overshadow specified in Windows Window / do no. W01	erpendicular wind ving buildings or the 'overshadow and glazed (oor Orientation	vegetation ving' column ving' c	on must be men in the lazing I	e of the heightable below. requirement adowing Distance (m)	nt and distance from the centre and nts Shading device eave/verandah/pergola/balcony	Frame and glass type standard aluminium, single pyrolytic low-e,	✓	*	✓
shades a pe Overshadow specified in Windows	erpendicular wind ving buildings or the 'overshadow and glazed of oor Orientation	vegetation	on must be men in the Oversh Height (m)	e of the height table below. requirement adowing Distance (m)	nts Shading device eave/verandah/pergola/balcony >=750 mm eave/verandah/pergola/balcony	Frame and glass type standard aluminium, single pyrolytic low-e, (U-value: 5.7, SHGC: 0.47) standard aluminium, single pyrolytic low-e,	✓	V	*

							Show on DA Plans	Show on CC/CDC Plans & specs	Certifier Check
Window / door no.	Orientation	Area of glass inc. frame (m2)	Oversha Height (m)	Distance (m)	Shading device	Frame and glass type			
					>=750 mm	(U-value: 5.7, SHGC: 0.47)			
W05	E	2.07	0	0	eave/verandah/pergola/balcony >=750 mm	standard aluminium, single pyrolytic low-e, (U-value: 5.7, SHGC: 0.47)			
W06	E	2.07	0	0	eave/verandah/pergola/balcony >=750 mm	standard aluminium, single pyrolytic low-e, (U-value: 5.7, SHGC: 0.47)			
W07	E	2.07	0	0	eave/verandah/pergola/balcony >=750 mm	standard aluminium, single pyrolytic low-e, (U-value: 5.7, SHGC: 0.47)			
W08	W	2.07	0	0	eave/verandah/pergola/balcony >=750 mm	standard aluminium, single pyrolytic low-e, (U-value: 5.7, SHGC: 0.47)			
W09	W	2.07	0	0	eave/verandah/pergola/balcony >=750 mm	standard aluminium, single pyrolytic low-e, (U-value: 5.7, SHGC: 0.47)			
W10	W	1.72	0	0	eave/verandah/pergola/balcony >=750 mm	standard aluminium, single pyrolytic low-e, (U-value: 5.7, SHGC: 0.47)			
W11	N	0.64	0	0	eave/verandah/pergola/balcony >=750 mm	standard aluminium, single pyrolytic low-e, (U-value: 5.7, SHGC: 0.47)			
W12	W	0.96	0	0	eave/verandah/pergola/balcony >=750 mm	standard aluminium, single pyrolytic low-e, (U-value: 5.7, SHGC: 0.47)			
W13	W	1.94	10	0.9	eave/verandah/pergola/balcony >=750 mm	standard aluminium, single pyrolytic low-e, (U-value: 5.7, SHGC: 0.47)			
D01	E	6.32	0	0	eave/verandah/pergola/balcony >=750 mm	standard aluminium, single pyrolytic low-e, (U-value: 5.7, SHGC: 0.47)			
D02	W	8.62	0	0	eave/verandah/pergola/balcony >=750 mm	standard aluminium, single pyrolytic low-e, (U-value: 5.7, SHGC: 0.47)			
D03	N	10	0	0	eave/verandah/pergola/balcony >=900 mm	standard aluminium, single pyrolytic low-e, (U-value: 5.7, SHGC: 0.47)			

Planning & Environment Building Sustainability Index www.basix.nsw.gov.au



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All window & door dimensions, orientation, glazing materials, opening types, frame types are to be confirmed by a suitably qualified person prior to the ordering of any such materials are to take place.
U value takes precedence over glazing type/colour in all cases.
all new glazing must meet the BASIX specified frame and glass type, <u>OR</u> meet the ecified U value and SHGC value.

CLIENT

PETE & TAFF WALSH

PROJECT ADDRESS 8 HOLLOWAY PLACE. CURL CURL NSW 2096 DRAWING NO.

DA20

DATE

Monday, 30 March 2020

DRAWING NAME BASIX COMMITMENTS