
DRAWING NO.	DRAWING TITLE				
1 INTRODUCTOR'	Y DOCUMENTS				
DA-A00	COVER SHEET				
DA-A01	SITE PLAN				
DA-A02	SITE ANALYSIS PLAN				
DA-A03	LOWER GROUND DEMOLITION PLAN				
DA-A04	GROUND FLOOR DEMOLITION PLAN				
DA-A05	EXCAVATION AND FILL PLAN				
DA-A06	COMPLIANCE DIAGRAM				
DA-A07	COMPLIANCE DIAGRAMS				
DA-A08	BASIX SUMMARY				
2 GENERAL ARRA	NGEMENT				
DA-D01	LOWER GROUND FLOOR PLAN				
DA-D02	GROUND FLOOR PLAN				
DA-D03	FIRST FLOOR PLAN				
DA-D04	GARAGE FLOOR PLAN				
DA-D05	ROOF PLAN				
DA-E01	ELEVATION SOUTH				
DA-E02	ELEVATION NORTH				
DA-E03	ELEVATIONS EAST + WEST				
DA-F01	SECTIONS A+B+C				
DA-F02	SECTIONS D				
DA-F03	SECTIONS E				
3 APPENDICES					
DA-M01	SCHEDULE OF MATERIALS + FINISHES				
DA-P01	3D PERSPECTIVES				
DA-S01	SHADOW DIAGRAM EXISTING - WINTER - VIEW 1				
DA-S02	SHADOW DIAGRAM EXISTING - WINTER - VIEW 2 (WITH PHOTOS)				
DA-S03	SHADOW DIAGRAM EXISTING - WINTER - VIEW 2 (WITH PHOTOS) (1)				
DA-S04	SHADOW DIAGRAM PROPOSED - WINTER - VIEW 1				
DA-S05	SHADOW DIAGRAM PROPOSED - WINTER - VIEW 2				
DA-W01	WASTE MANAGEMENT & CVMP SITE PLAN				
DA-W02	DRIVEWAY PROFILE				

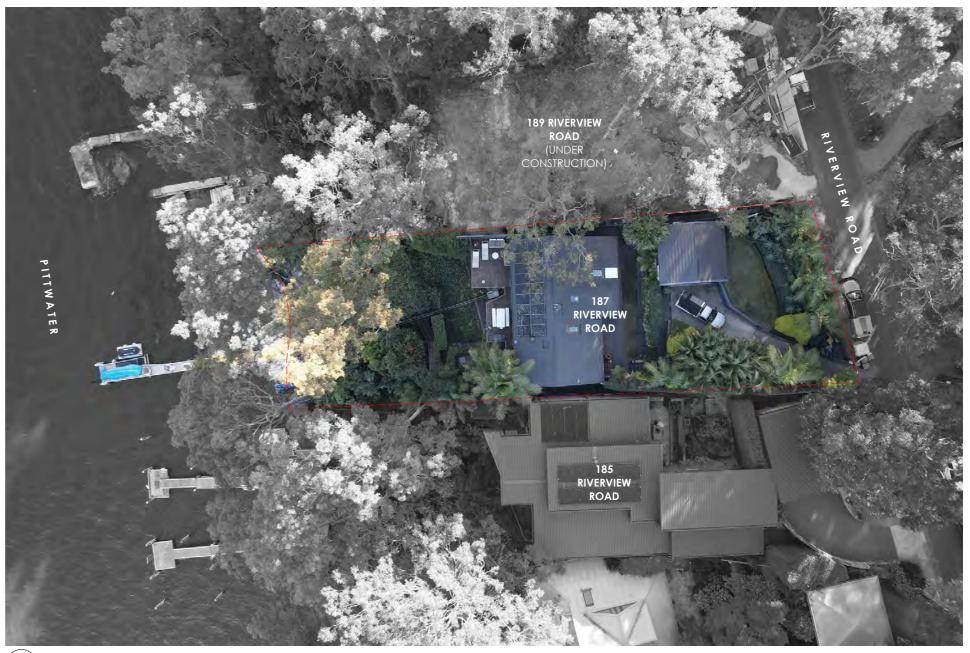

SITE AERIAL PHOTO








EV DATE DESCRIPTION


A 28.09.2023 FOR DEVELOPMENT APPLICATION


scale **NTS**  CLIENT DRAWING
ADAM & VANESSA COVER SHEET
RICHARDS
FIRST ISSUE REV.
28.09.2023 A


ADDRESS
187 RIVERVIEW ROAD
AVALON BEACH


DA-AOO

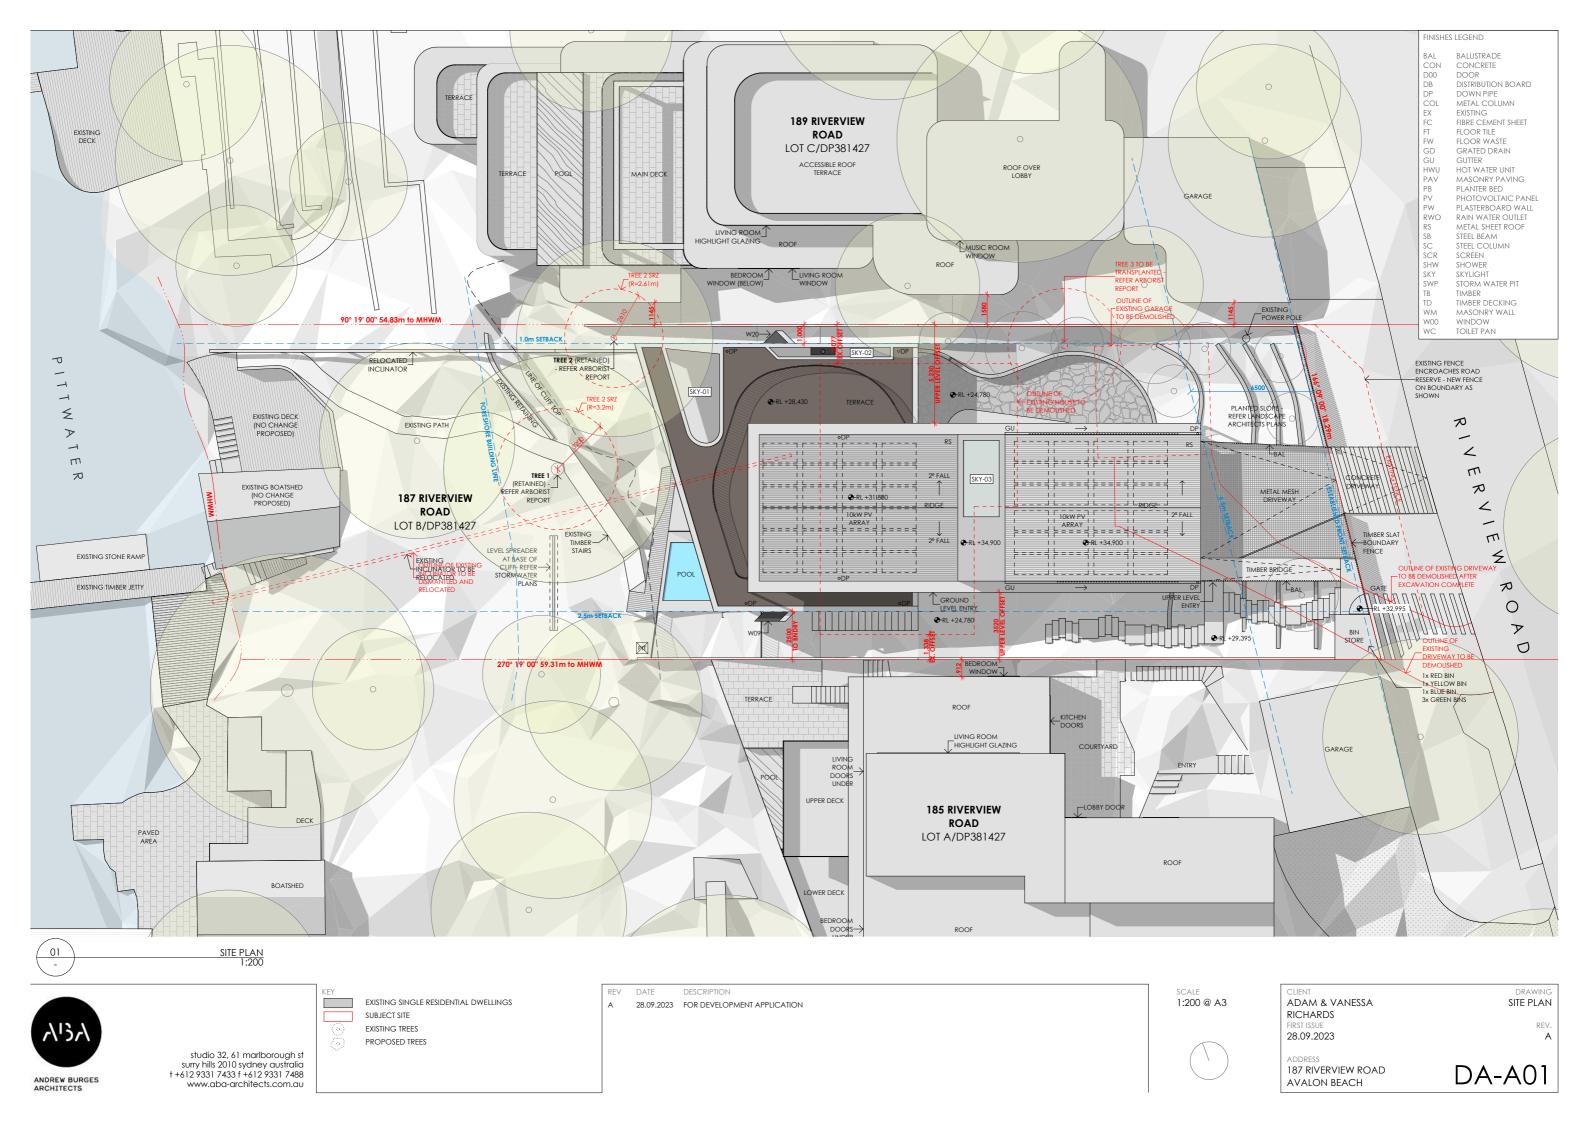

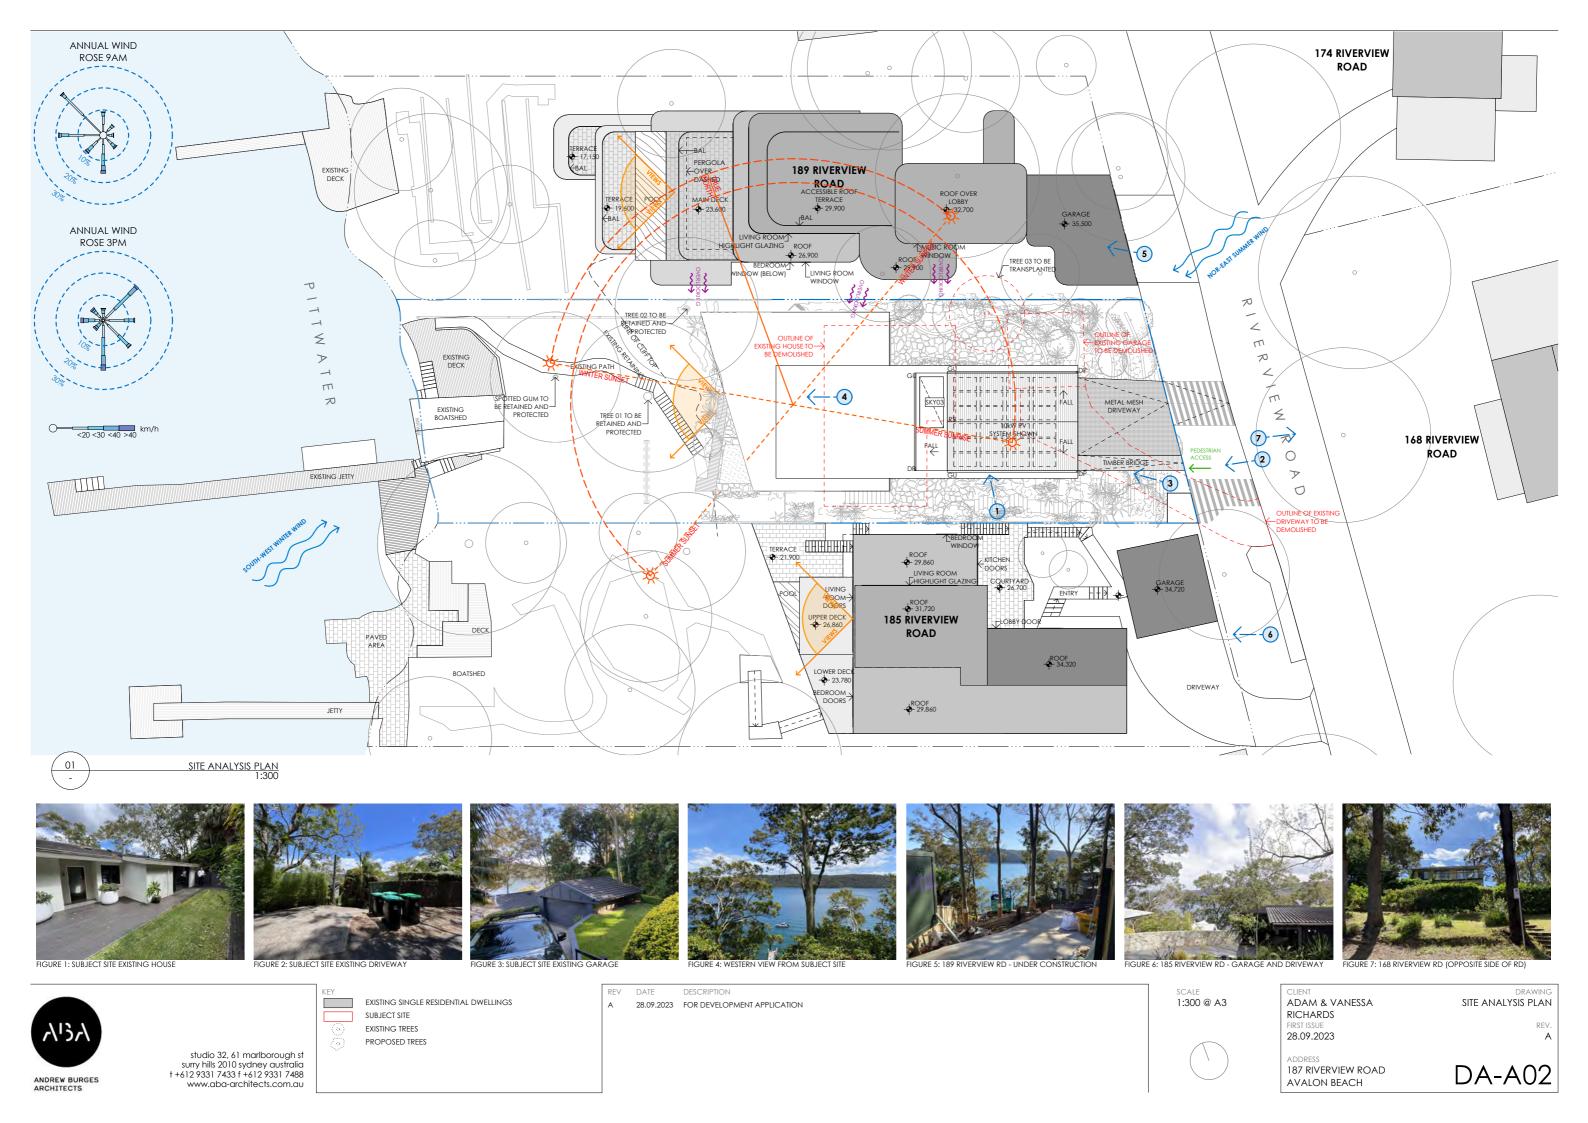

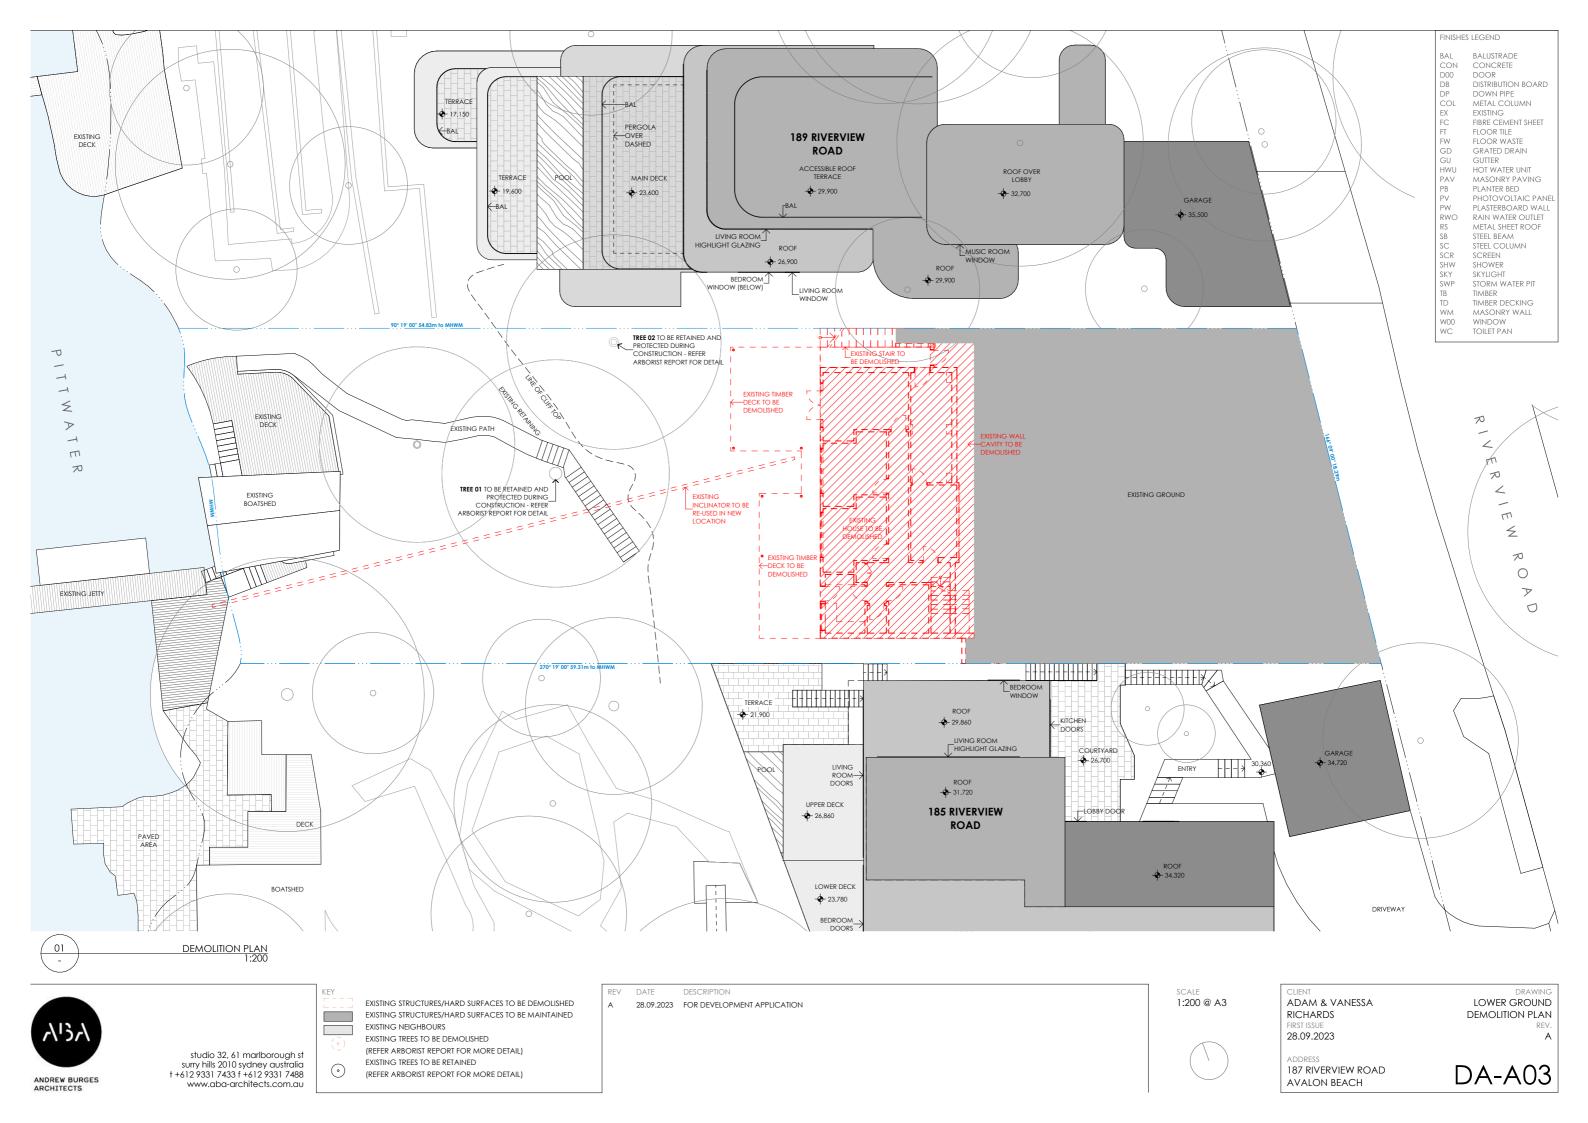

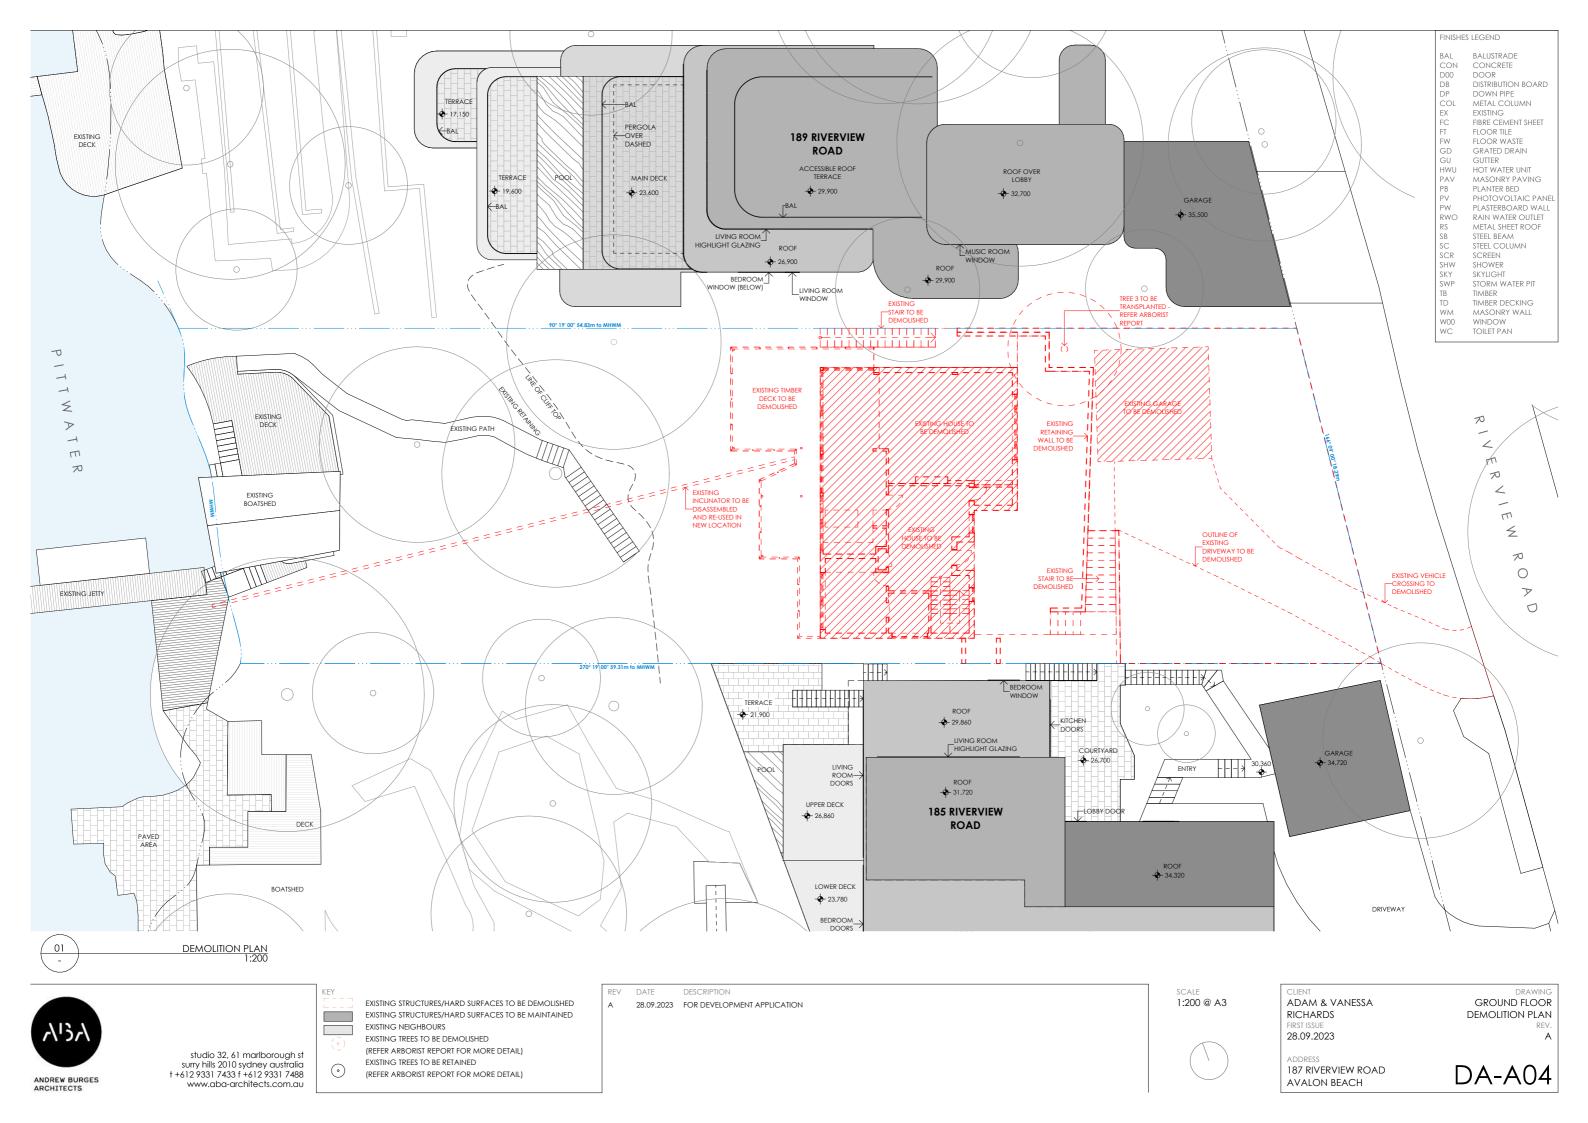

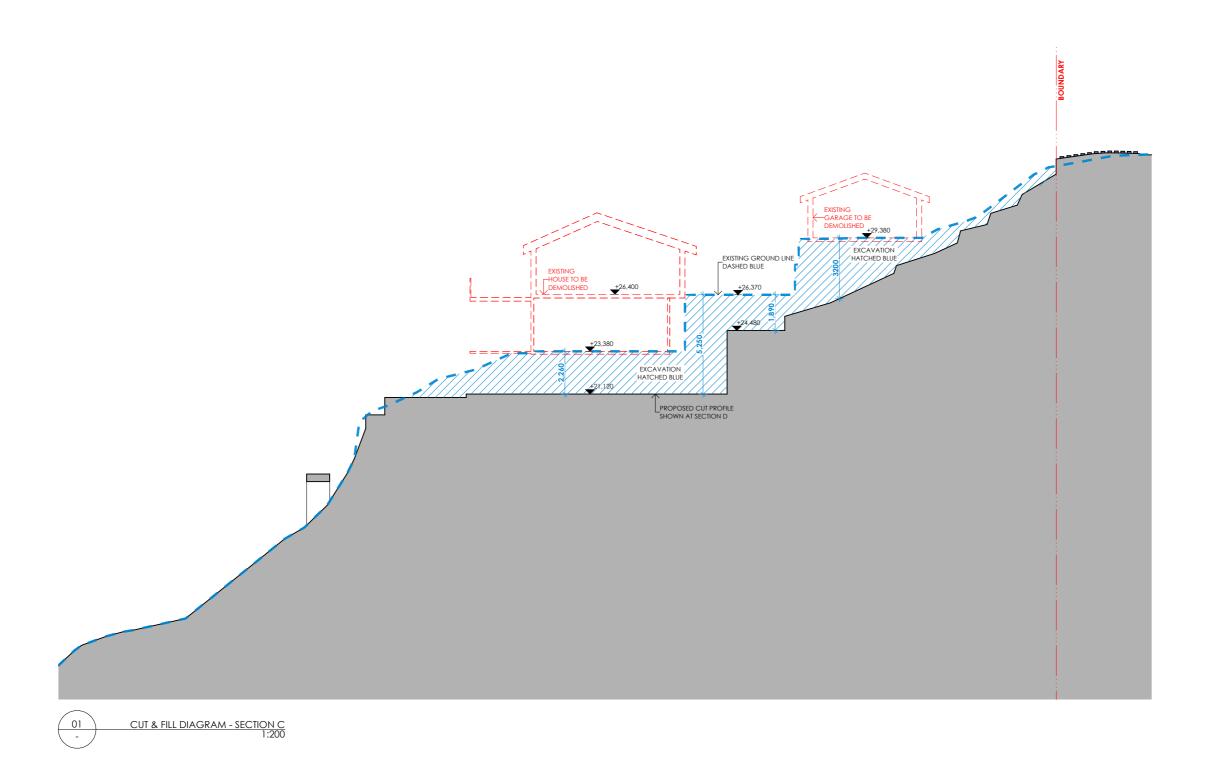



ANDREW BURGES ARCHITECTS

EXISTING STRUCTURES/HARD SURFACES TO BE MAINTAINED EXISTING NEIGHBOURS PROPOSED MASONRY STRUCTURE PROPOSED TIMBER FRAMED STRUCTURE PROPOSED CONCRETE STRUCTURE PROPOSED METAL STRUCTURE PROPOSED GLAZING


DESCRIPTION A 28.09.2023 FOR DEVELOPMENT APPLICATION SCALE 1:200 @ A3

CLIENT ADAM & VANESSA **RICHARDS** 28.09.2023

**EXCAVATION AND FILL** PLAN

187 RIVERVIEW ROAD AVALON BEACH

**DA-A05** 

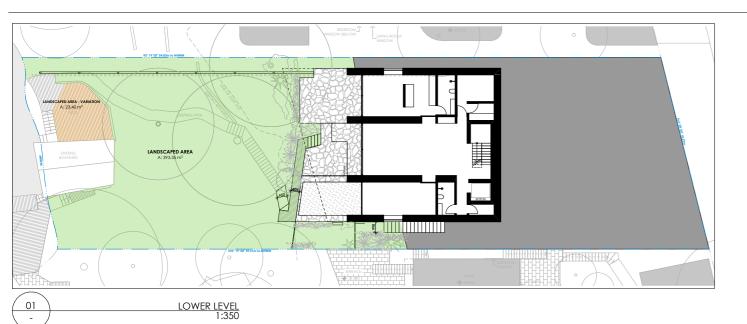


LANDSCAPED AREA: =1012m<sup>2</sup> SITE AREA: PERMITTED 6% VARIATION: =60m<sup>2</sup> LOWER GROUND: =393.3m<sup>2</sup> =166.9m<sup>2</sup> GROUND: UPPER: =nil 6% VARIATION: =23.4 + 36.6m<sup>2</sup>


 $=60m^{2}$ 

=620.2m<sup>2</sup> TOTAL: MIN. REQUIRED:  $=607m^{2}$ 

ADDITIONAL DEEP SOIL

(NOT INCLUDED IN TOTAL) =113m<sup>2</sup>

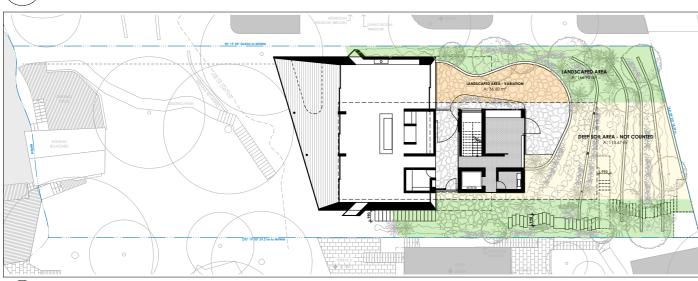

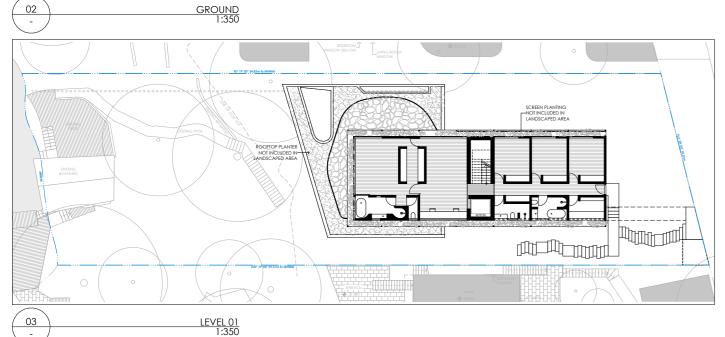

EXISTING GROUND
LINE DASHED BLUE EXISTING TIMBER STAIR— STRUCTURE

SECTION F - MAXIMUM WALL HEIGHT 1:200 04



studio 32, 61 marlborough st surry hills 2010 sydney australia † +612 9331 7433 f +612 9331 7488 www.aba-architects.com.au




DESCRIPTION A 28.09.2023 FOR DEVELOPMENT APPLICATION SCALE 1:350 @ A3

CLIENT ADAM & VANESSA **RICHARDS** 28.09.2023

COMPLIANCE DIAGRAM

187 RIVERVIEW ROAD AVALON BEACH

**DA-A06** 

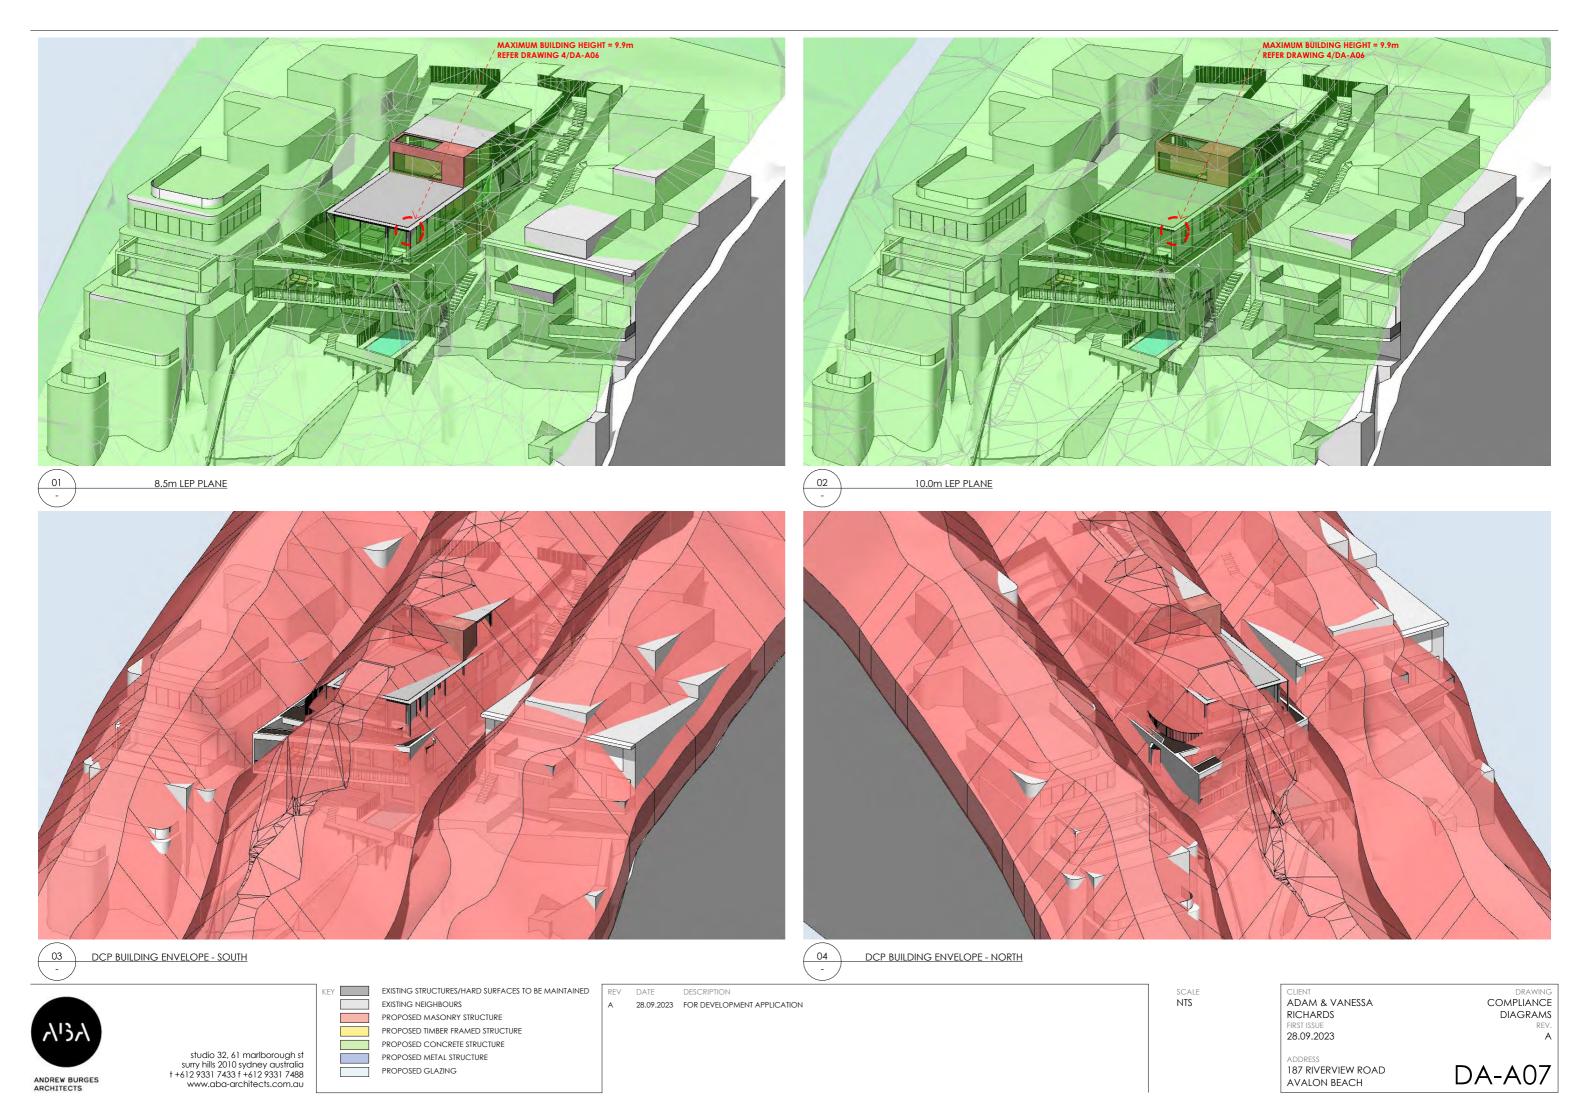

# **BASIX COMMITMENTS**

### WATER AND ENERGY

#### Landscape

The applicant must plant indigenous or low water use species of vegetation throughout 50 square metres of the site.

#### Fixtures

The applicant must install showerheads with a minimum rating of 4 star (>4.5 but <=6 L/min plus spray force and/or coverage tests) in all showers in the development.

The applicant must install a toilet flushing system with a minimum rating of 6 star in each toilet.

The applicant must install taps with a minimum rating of 6 star in the kitchen.

The applicant must instal basin taps with a minimum rating of 6 star in each bathroom.

Alternative water - Rainwater tank

The applicant must install a rainwater tank of at least 5000 liters on the site. This tank must meet, and be installed in accordance with, the requirements of all applicable regulatory authorities.

The applicant must configure the rainwater tank to collect rainwater runoff from at least 236 square metres of roof area.

The applicant must connect the rainwater tank to the cold water tap supplying the clothes washer and to at least one outdoor tap.

The applicant must connect the tank to at least one outdoor tap in the development.

#### Swimming pool

The swimming pool must not have a volume greater than 24 kilolitres.

The swimming pool must be outdoors.

Hot water recirculation/divrsion system

The applicant must install an on demand hot water recirculation system which regulates all hot water throughout the development.

#### Hot water

The applicant must install the following hot water system in the development, of a system with a higher enrgy rating: gas instantaneous.

### Cooling system

The applicant must install the followng cooling system, or a system with a higher energy rating, in at least 1 living area: 1-phase airconditioning; Energy rating: 5 star

The applicant must install the followng cooling system, or a system with a higher energy rating, in at least 1 bedroom: 1-phase airconditioning; Energy rating: 5 star

The cooling system must provide for day/night zoning between living areas and bedrooms.

## Heating system

The applicant must install the followng heating system, or a system with a higher energy rating, in at least 1 living area: 1-phase airconditioning; Energy rating: 5 star

The applicant must install the followng heating system, or a system with a higher energy rating, in at least 1 bedroom: 1-phase airconditioning; Energy rating: 5 star

The heating system must provide for day/night zoning between living areas and bedrooms.

### Ventilation

The applicant must install the following ventilaton systems:

At least 1 bathroom: no mechanical ventilation (natural ventilation)

Kitchen: individual fan, ducted to facade or roof, manually operated switch.

Laundry: individual fan, not ducted, manually operated switch

### Artificial lighting

The applicant must ensure that the "primary type of artificial lighting" is fluorescent or light emitting diode (LED) lighting in each of the following rooms;

- at least 6 of the bedrooms / study; dedicated
- at least 3 of the living / dining rooms; dedicated
- the kitchen; dedicated
- all bathrooms/toilets; dedicated
- the laundry; dedicated
- all hallways: dedicated

#### Natural lighting

The applicant must install a window and/or skylight in 5 bathroom(s)/toilet(s)

The applicant must install a timer for the swimming pool pump.

### Swimming pool

The applicant must install the following heating system for the swimming pool in the declopment: gas

The applicant must install a timer for swimming pool pump.

The applicant must install a photovoltaic system with the capacity to generate at least 6 peak kilowatts of electricity. The applicant must connect this system to the electrical system.

The applicant must install a gas cooktop &electric oven in the kitchen.

The applicant must construct each refrigerator space in the development so that it is "well ventilated".

# NATHERS THERMAL COMMITMENTS

### THERMAL COMMITMENTS

Nather Certificate number Assessor number: 20758

## Climate zone: 56

ALM-004-03 Glass Air Fill High Solar Gain low-E -Clear Frame Aluminium

U-VALUE = 4.30 SHGC = 0.53

# **External Wall**

Window

Concrete Blobk Bulk Insulation R1.7

Weatherbourd Cavity Panel Direct Fix Bulk Insulation R2.50

Concrete Block to earth Bulk Insulation R1.7

## Internal Wall

Cavity wall, direct fix plasterboard, single gap Bulk Insulation in Contact with Floor R 1.5 Concrete Block Bulk Insulation, Air Gap R 1.5

# External Floor

Concrete Slab on Ground 100mm Bare Bul Insulation in Contact with Floor R 2.5 Suspended Concrete Slab 150mm Bare Bulk Insulation in Contact with Floor R 2.5

# **External Ceilina**

Concrete, Plasterboard Bulk Insulation R2.3 No roofspace cavity.

Plasterboard Bulk Insulation R5 No roofspace cavity. Plasterboard No Insulation to Garage

### Internal Floor/Ceiling

Concrete Above Plasterboard No Insulation

### Roof (Horizontal area)

Concrete Bulk Insulation, No Air Gap Above R 3.4 2° slope Skillion roof.

corrugated Iron Bulk Reflective Side Down No Air Gap Above, R0.7, 2° slope Skillion roof.

Ceilings Fans living room, dining room and kitchen.

# DOOR AND WINDOW SCHEDULE

## DOOR & WINDOW TYPES

ALM-004-03 Glass Air Fill High Solar Gain low-E -Clear Frame Aluminium

U-VALUE = 4.30 SHGC = 0.53

SKY 1 Double-glazed clear Skylight

DOOR & WINDOW SCHEDULE							
CODE	LOCATION	WIDTH (m)	HEIGHT (m)		TYPE		
W-01	GUEST BED	3.88	3.00	W	TYPE 1		
W-02	RUMPUS	4.85	3.00	W	TYPE 1		
W-03	GYM	3.00	3.00	W	TYPE 1		
W-04	GYM	1.80	0.90	S	TYPE 1		
W-05	GUEST BED	1.80	0.90	Ν	TYPE 1		
W-06	LIVING	4.36	3.15	W	TYPE 1		
W-07	KITCHEN	3.70	3.15	W	TYPE 1		
W-08	DINING	4.30	3.15	W	TYPE 1		
W-09	DINING	1.24	2.35	S	TYPE 1		
W-10	DINING	0.90	3.15	Е	TYPE 1		
W-11	ENTRY	2.10	3.60	S	TYPE 1		
W-12	LIFT LOBBY	1.05	3.10	S	TYPE 1		
W-13	WC	3.63	0.50	S	TYPE 1		
W-14	WC	1.98	0.50	Е	TYPE 1		
W-15	TV ROOM	4.65	3.06	E	TYPE 1		
W-16	TV ROOM	3.35	3.15	Ν	TYPE 1		
W-17	STAIRWELL	1.90	1.41	Ν	TYPE 1		
W-18	ENTRY	2.10	3.60	Ν	TYPE 1		
W-19	LIVING	4.11	3.15	E	TYPE 1		
W-20	LIVING	0.87	2.70	NW	TYPE 1		
W-21	MAIN BED	5.45	2.80	W	TYPE 1		
W-22	ENSUITE	2.00	2.80	W	TYPE 1		
W-23	ENSUITE	0.85	1.93	S	TYPE 1		
W-24	ENSUITE	0.90	1.93	S	TYPE 1		
W-25	STUDY	4.40	1.93	S	TYPE 1		
W-26	BATH 1	0.99	1.20	S	TYPE 1		
W-27	BATH 2	0.99	1.20	S	TYPE 1		
W-28	LAUNDRY	3.30	0.70	S	TYPE 1		
W-29	BED 4	2.30	2.35	Ν	TYPE 1		
W-30	BED 3	2.30	2.35	Ν	TYPE 1		
W-31	BED 2	2.30	2.35	Ν	TYPE 1		
W-32	STUDY	4.40	2.80	Ν	TYPE 1		
W-34	MAIN BED	2.65	2.80	Ν	TYPE 1		
W-35	GARAGE	5.15	1.85	W	TYPE 1		
W-36	GARAGE	2.68	2.67	S	TYPE 1		
W-37	GARAGE	1.28	2.67	Ν	TYPE 1		
W-38	BATH 1	3.30	0.70	S	TYPE 1		
W-39	BATH 2	3.30	0.70	S	TYPE 1		
SKY-01	DECK	2.70	4.00	SKY	UNGLAZED		
SKY-02	LIVING	0.52	5.20	SKY	SKY 1		
SKY-03	STAIRWELL	4.05	2.20	SKY	SKY 1		








28.09.2023 FOR DEVELOPMENT APPLICATION


DESCRIPTION


SCALE


ADAM & VANESSA **RICHARDS** 28.09.2023 187 RIVERVIEW ROAD **AVALON BEACH** 


**BASIX SUMMARY** 

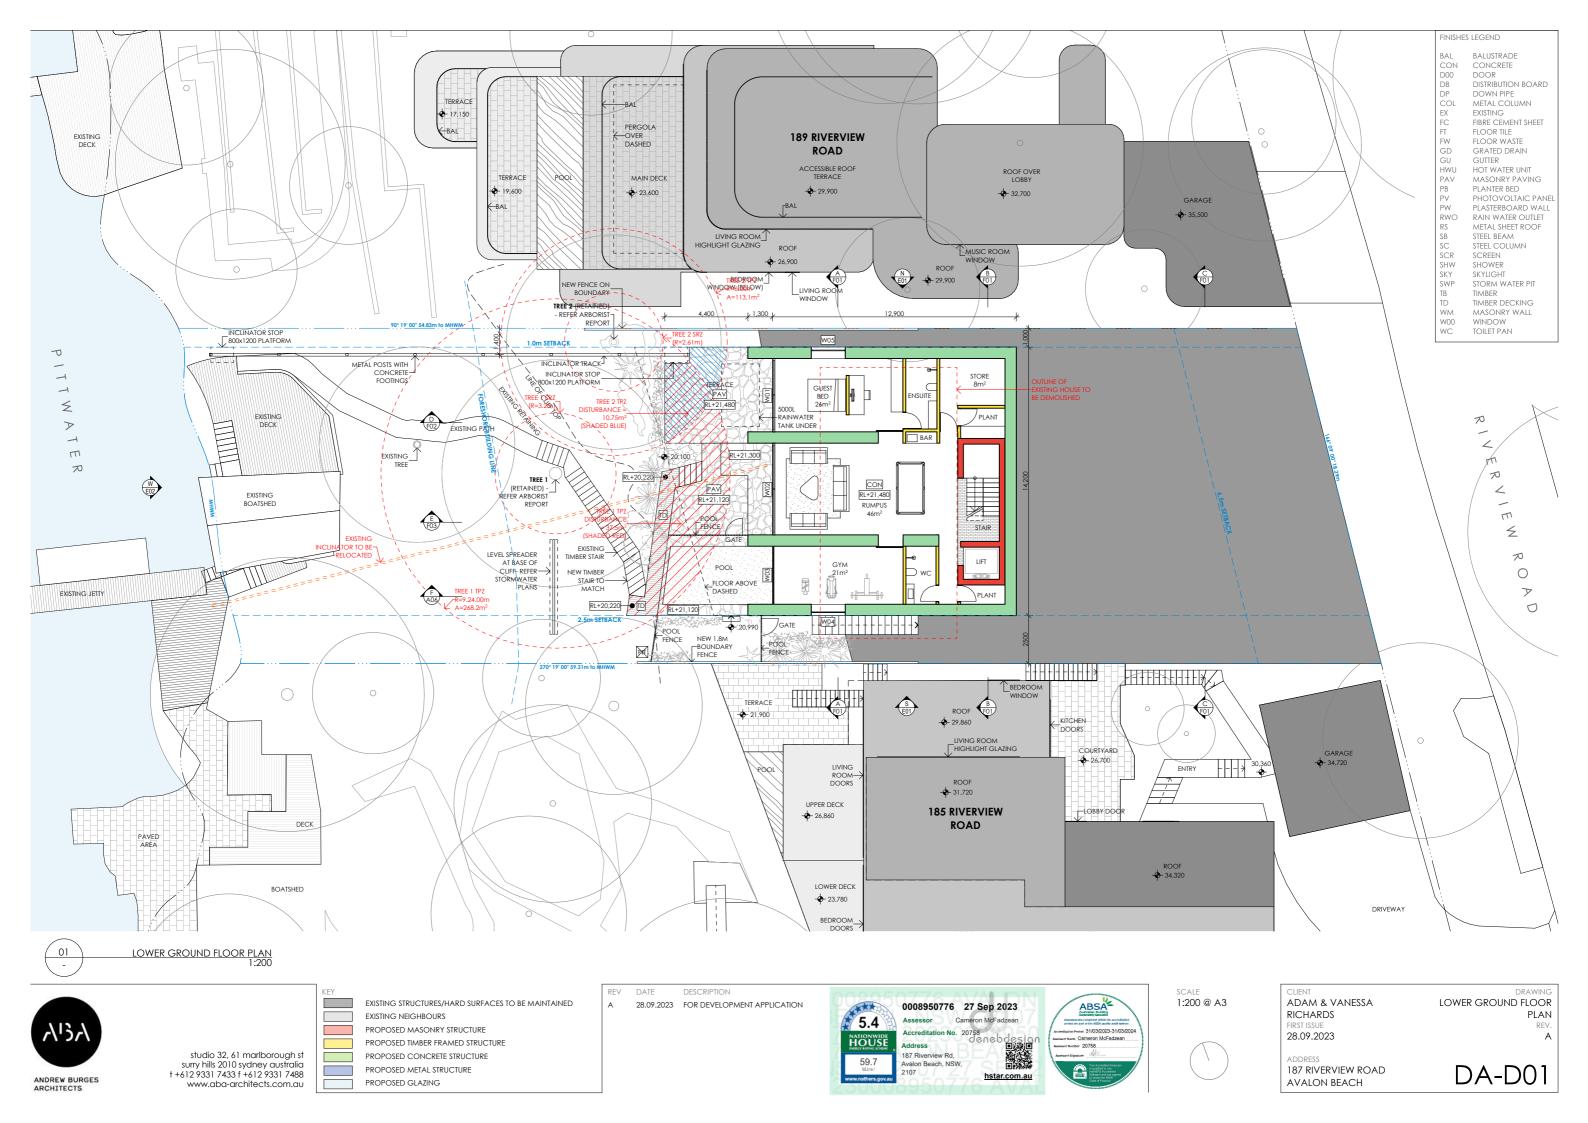


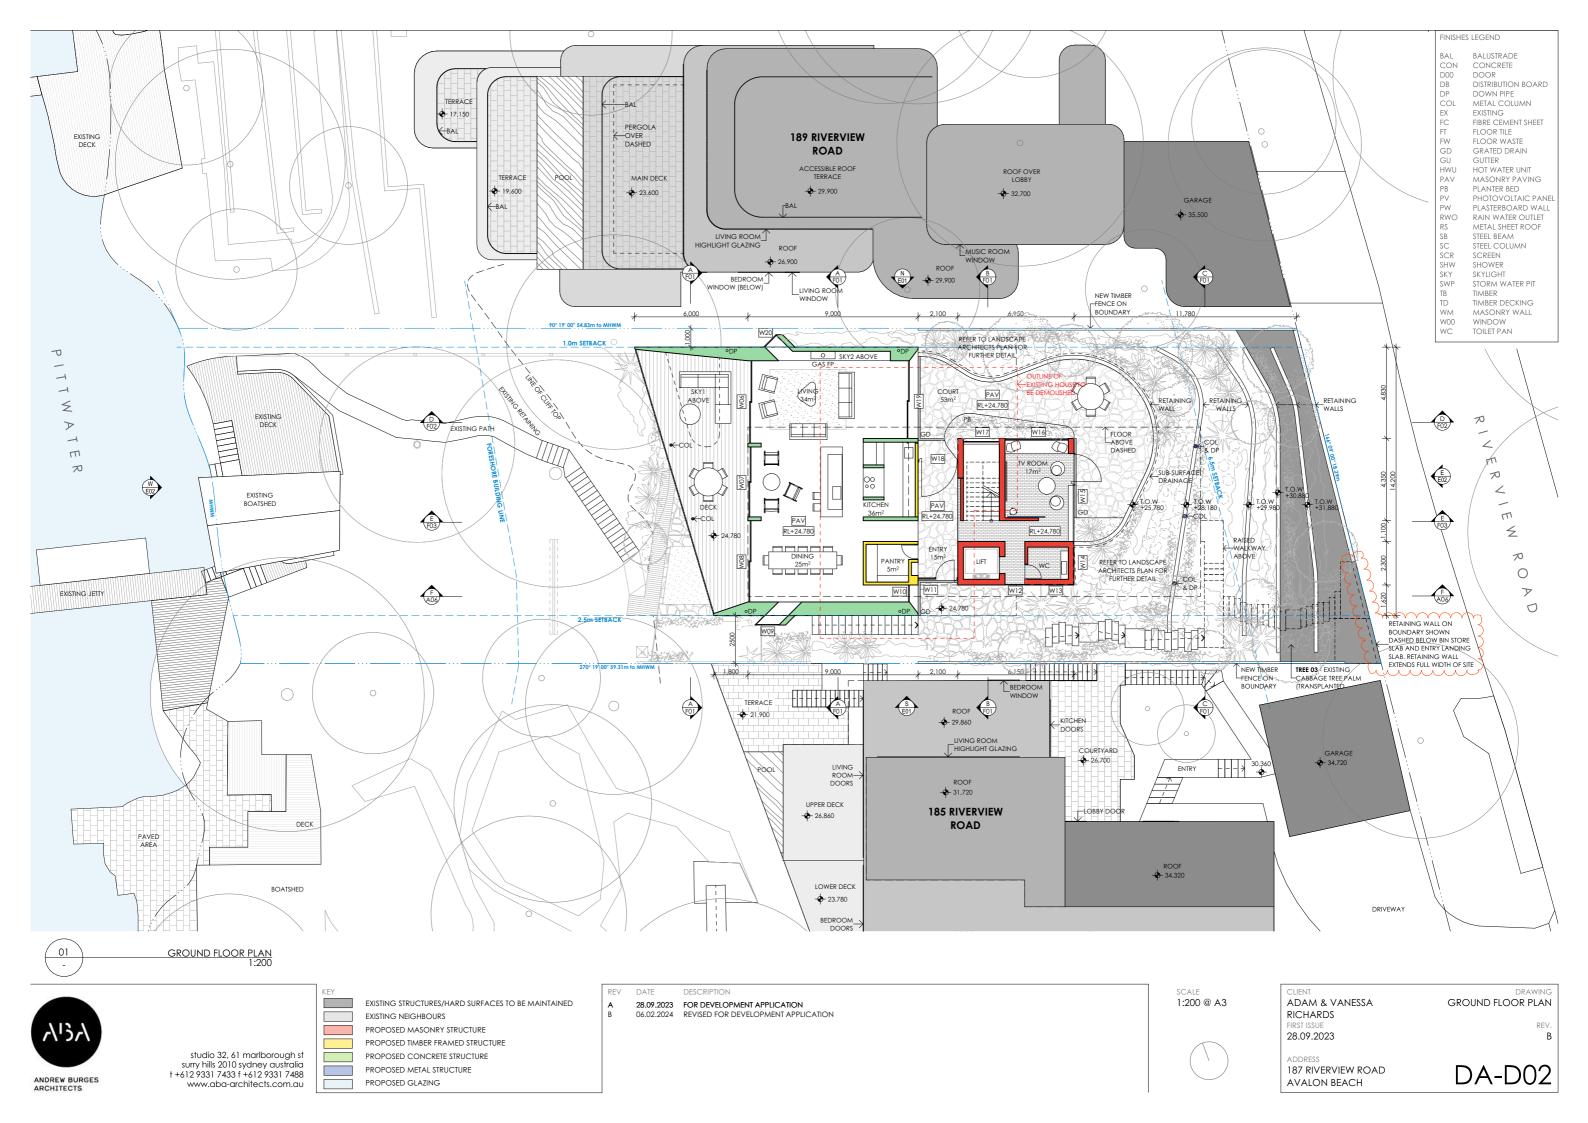

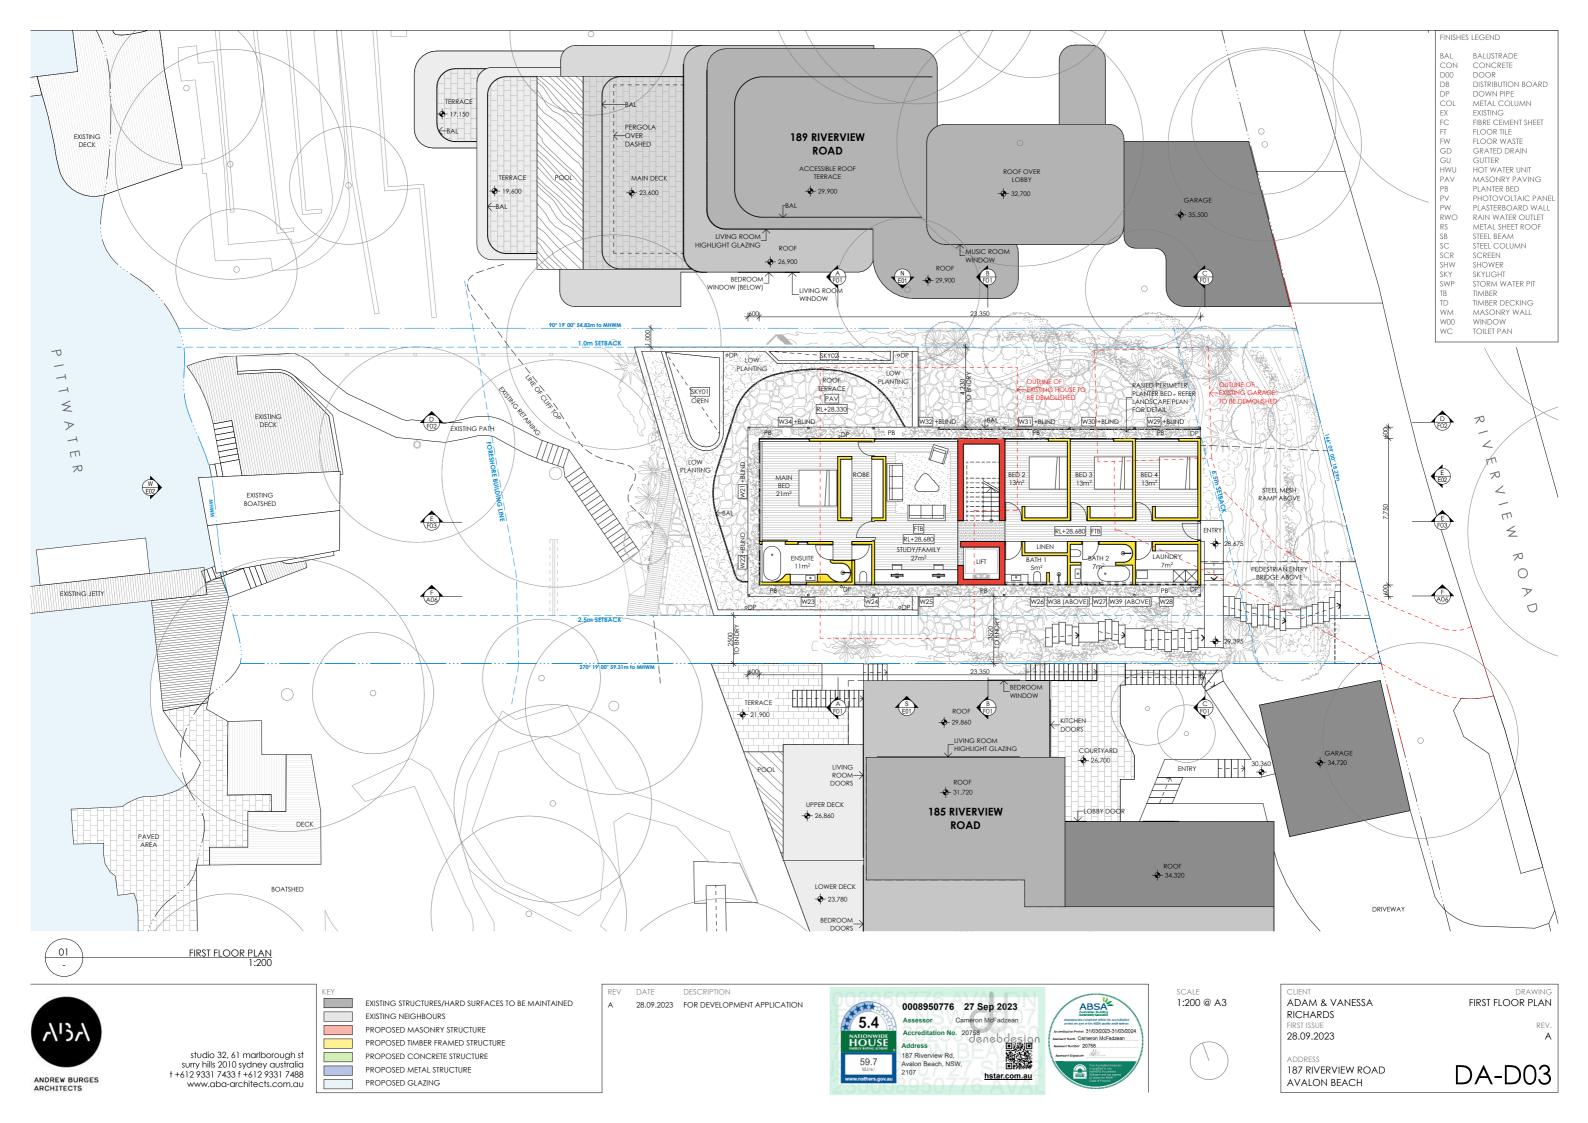

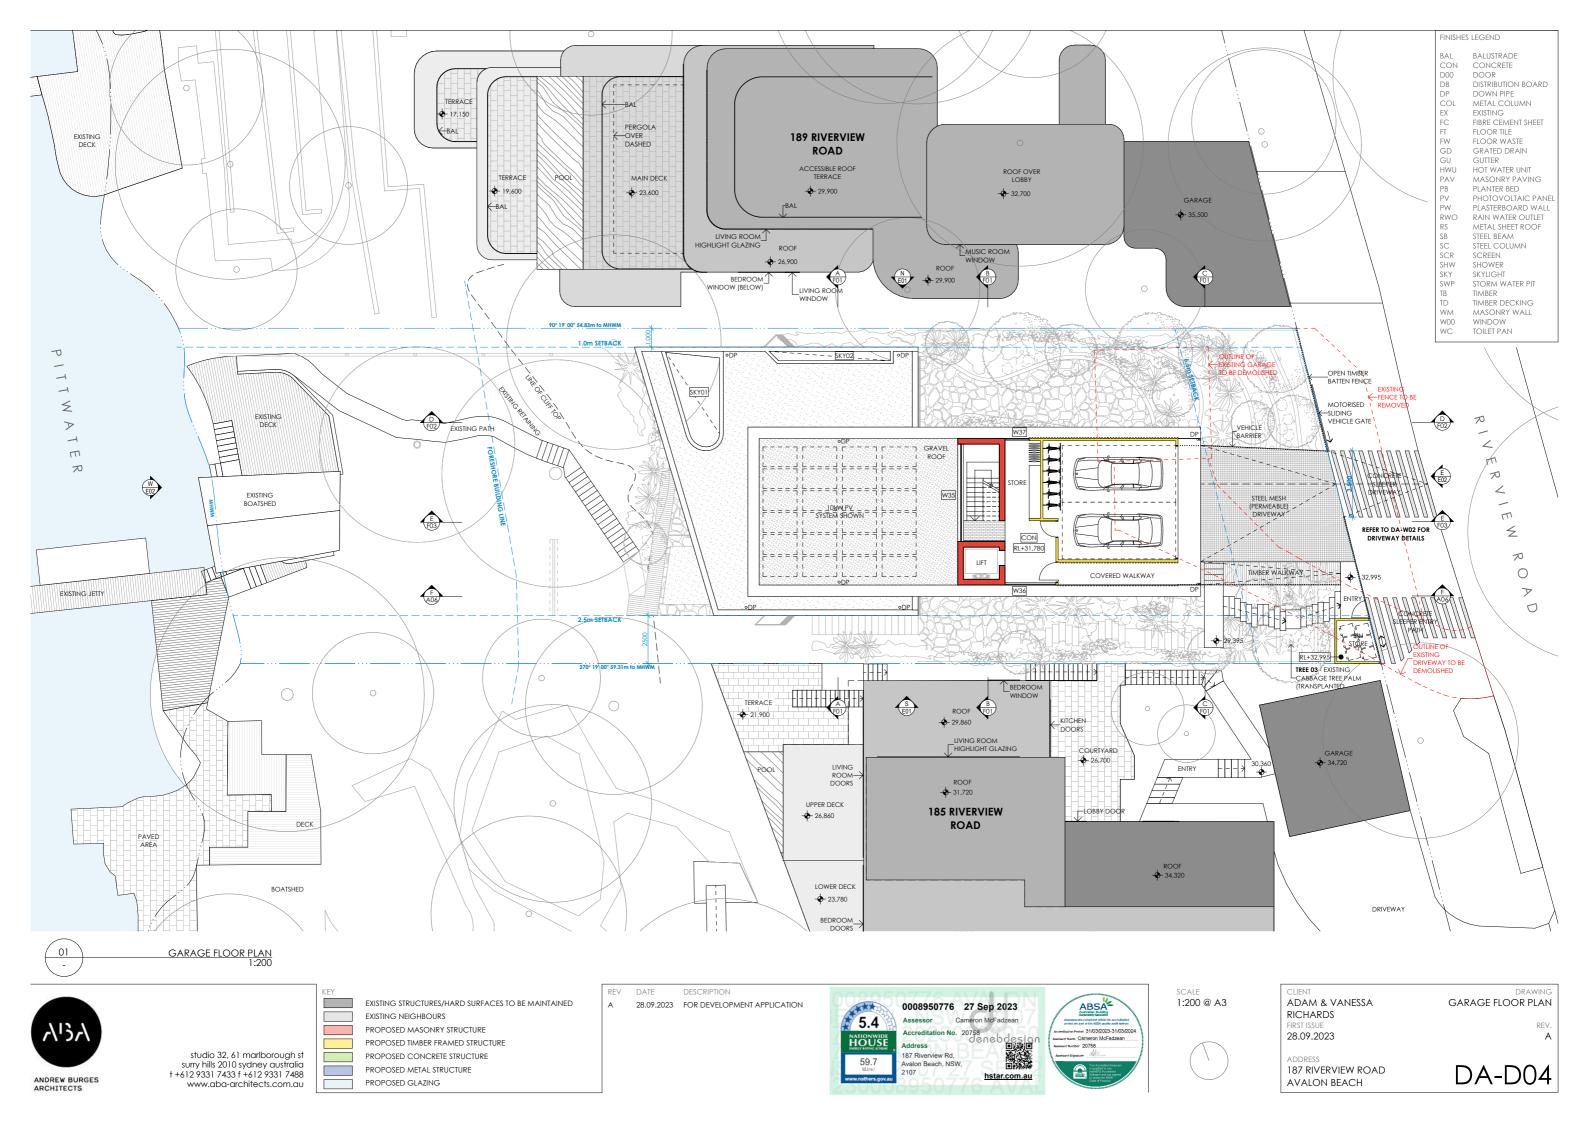

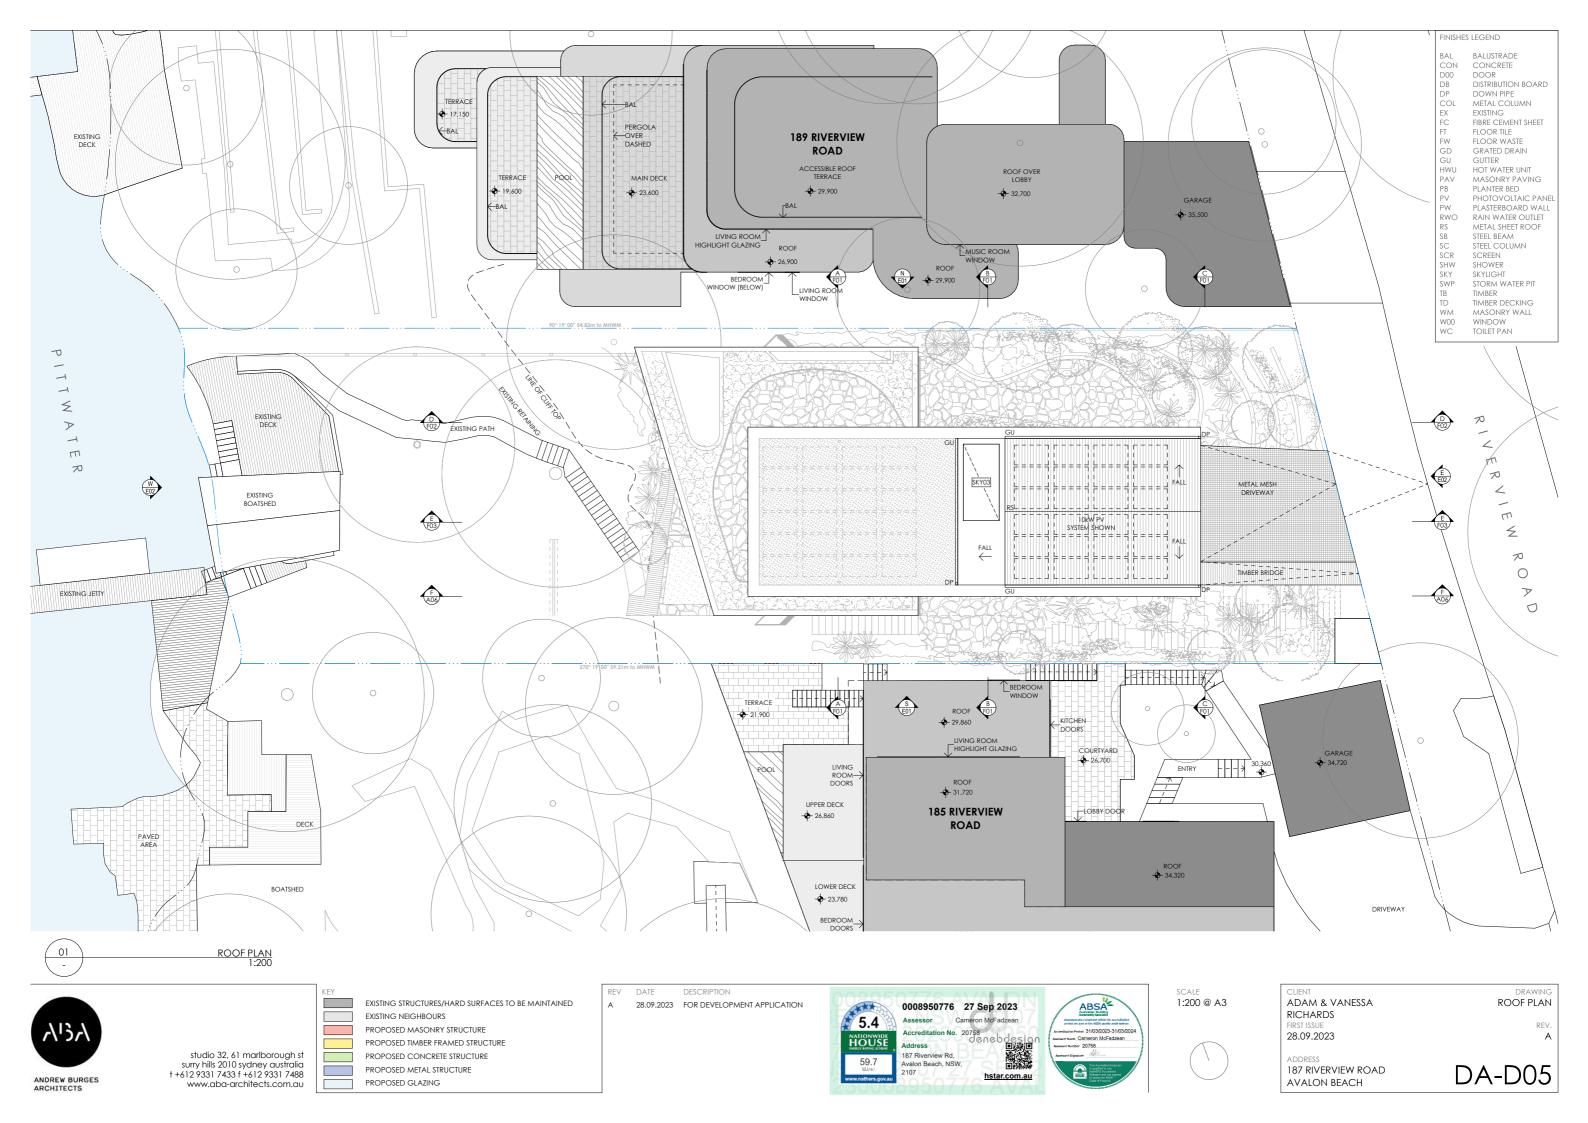

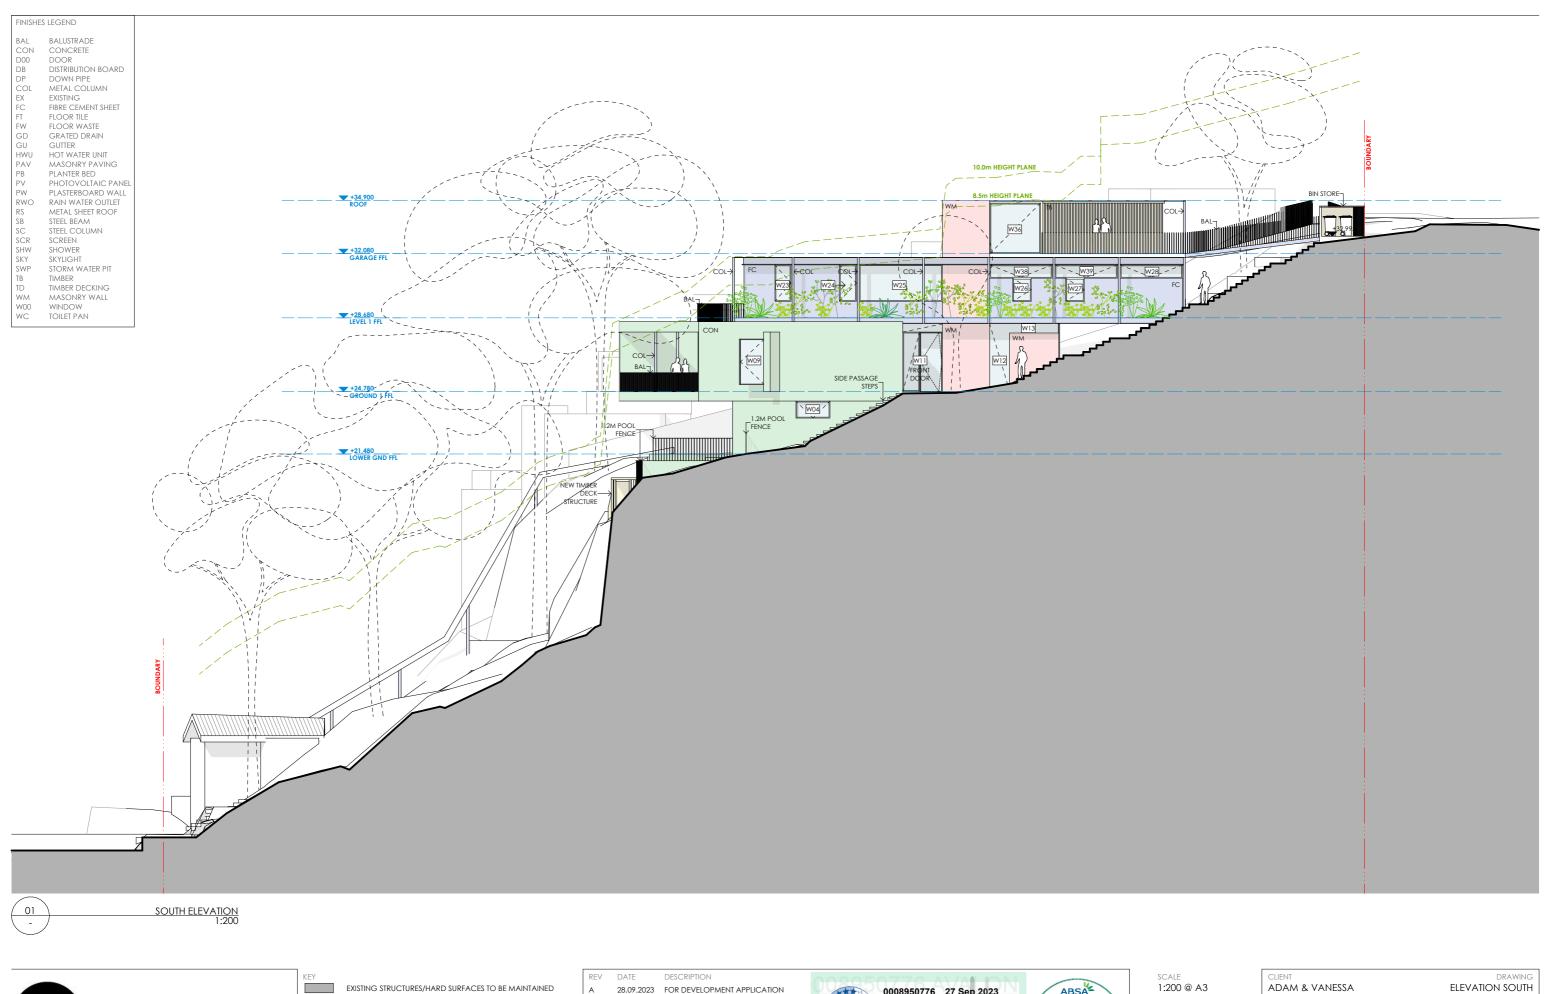



studio 32, 61 marlborough st surry hills 2010 sydney australia † +612 9331 7433 f +612 9331 7488 www.aba-architects.com.au




A 28.09.2023 FOR DEVELOPMENT APPLICATION



1:200 @ A3

CLIENT ADAM & VANESSA	DRAW ELEVATION SOU
RICHARDS FIRST ISSUE	F
28.09.2023	
ADDRESS 187 RIVERVIEW ROAD	D 4 F0
AVALON BEACH	DA-EU

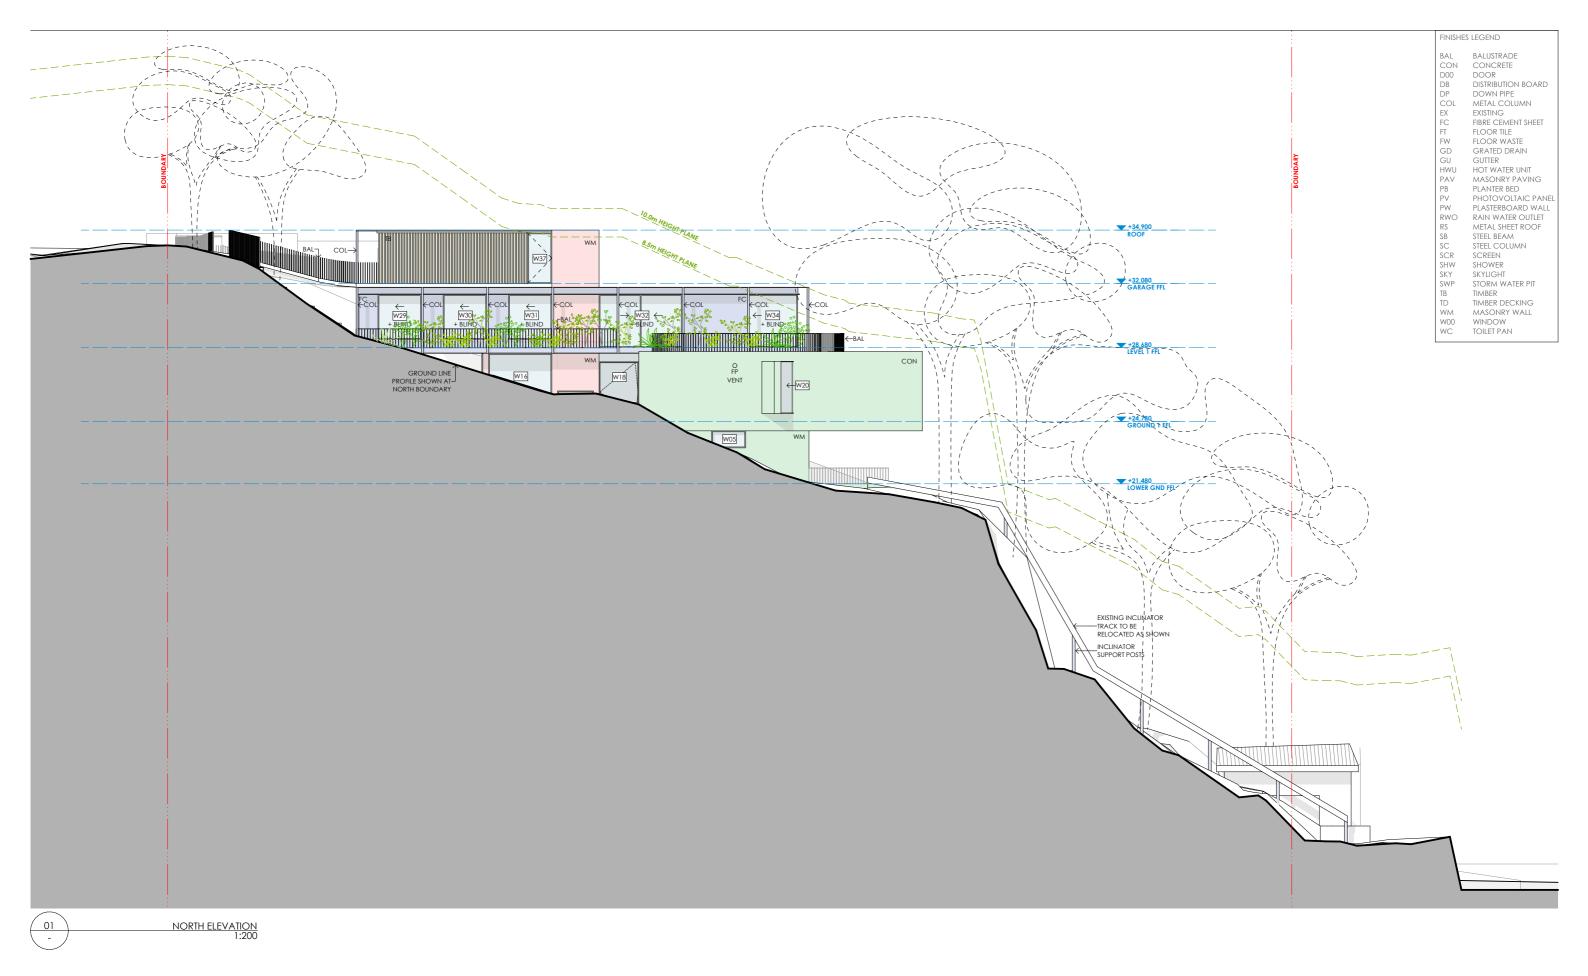



studio 32, 61 marlborough st surry hills 2010 sydney australia t +612 9331 7433 f +612 9331 7488 www.aba-architects.com.au



REV DATE DESCRIPTION
A 28.09.2023 FOR DEVELOPMENT APPLICATION



Amendment of the condition of the condit


1:200 @ A3

CLIENT
ADAM & VANESSA
RICHARDS
FIRST ISSUE
28.09.2023
ADDRESS
187 RIVERVIEW ROAD

AVALON BEACH

DRAWING ELEVATION NORTH

REV. A

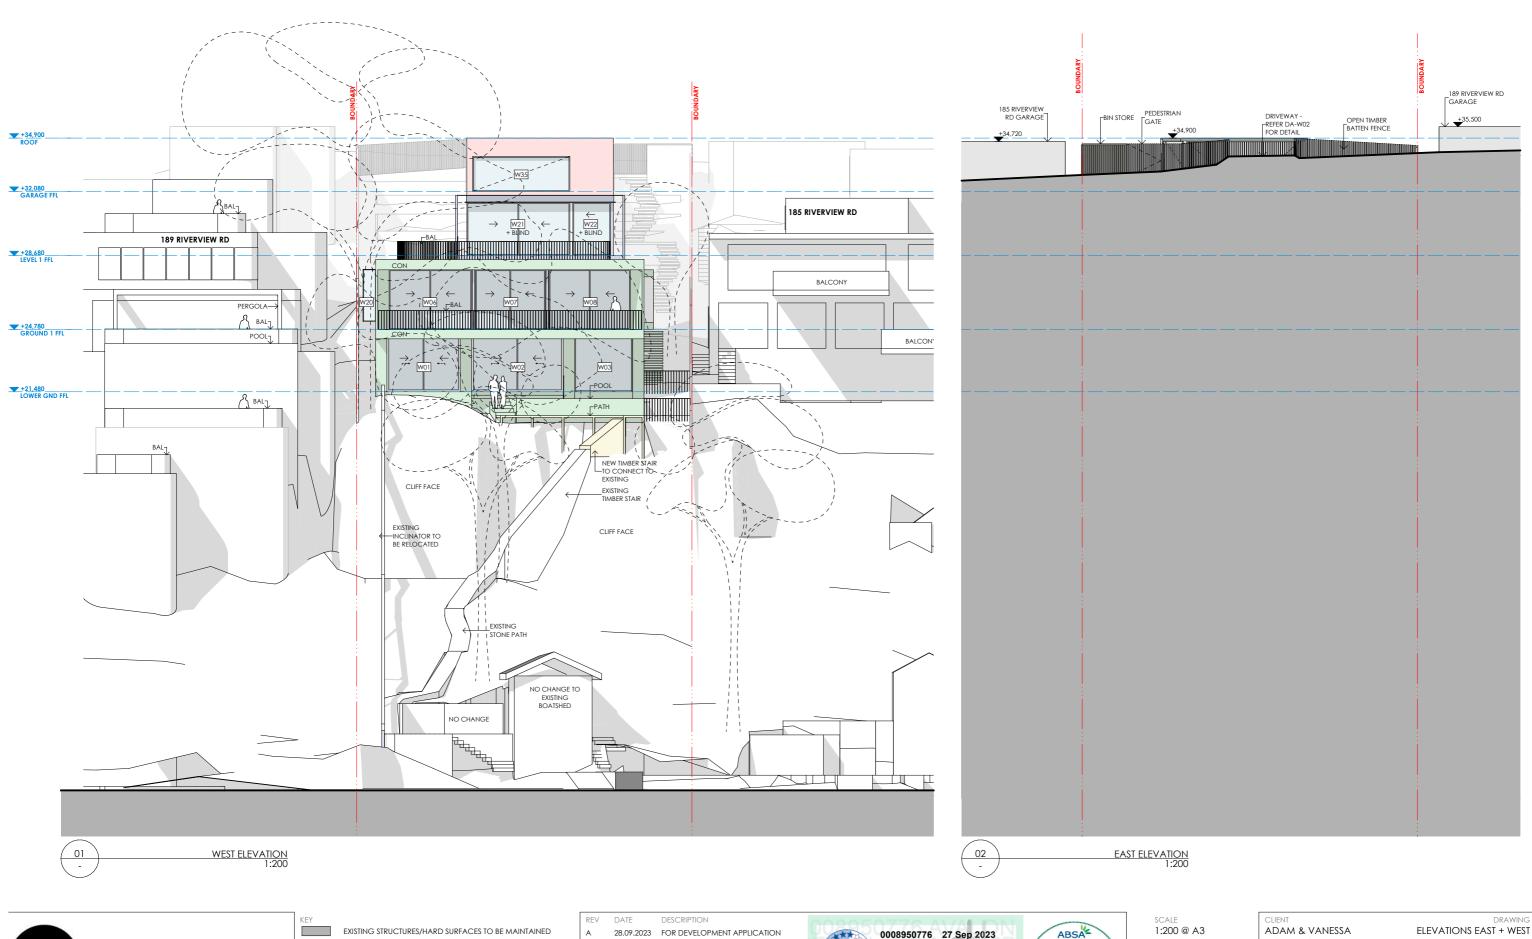





studio 32, 61 marlborough st surry hills 2010 sydney australia † +612 9331 7433 f +612 9331 7488 www.aba-architects.com.au

EXISTING NEIGHBOURS PROPOSED MASONRY STRUCTURE PROPOSED TIMBER FRAMED STRUCTURE PROPOSED CONCRETE STRUCTURE PROPOSED METAL STRUCTURE PROPOSED GLAZING



**RICHARDS** 28.09.2023 **DA-E03** 187 RIVERVIEW ROAD AVALON BEACH

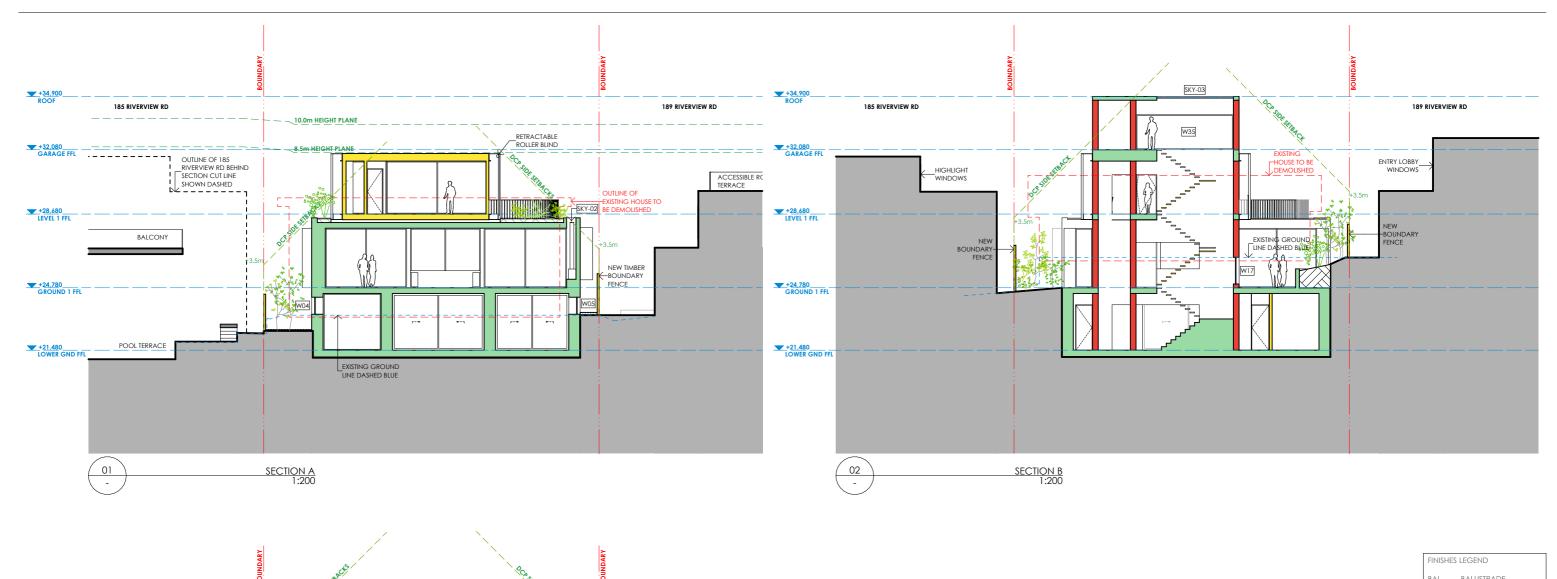

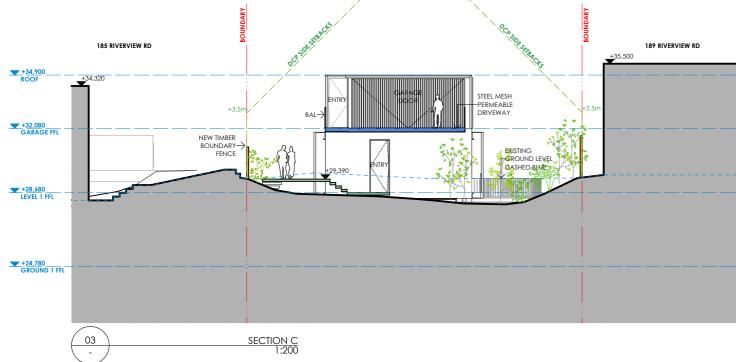

BALUSTRADE CONCRETE DOOR DISTRIBUTION BOARD D00 DOWN PIPE METAL COLUMN EXISTING FIBRE CEMENT SHEET FLOOR TILE FLOOR WASTE GRATED DRAIN GUTTER HOT WATER UNIT MASONRY PAVING HWU PAV PLANTER BED PHOTOVOLTAIC PANEL PLASTERBOARD WALL PW RWO RAIN WATER OUTLET METAL SHEET ROOF STEEL BEAM STEEL COLUMN SC SCR SHW SCREEN SHOWER SKYLIGHT STORM WATER PIT SKY SWP TIMBER
TIMBER DECKING WM W00 WC MASONRY WALL WINDOW



REV DATE DESCRIPTION
A 28.09.2023 FOR DEVELOPMENT APPLICATION




SCALE 1:200 @ A3


n Period 31/03/2023-31/03/2




SECTIONS A+B+C

REV.
A

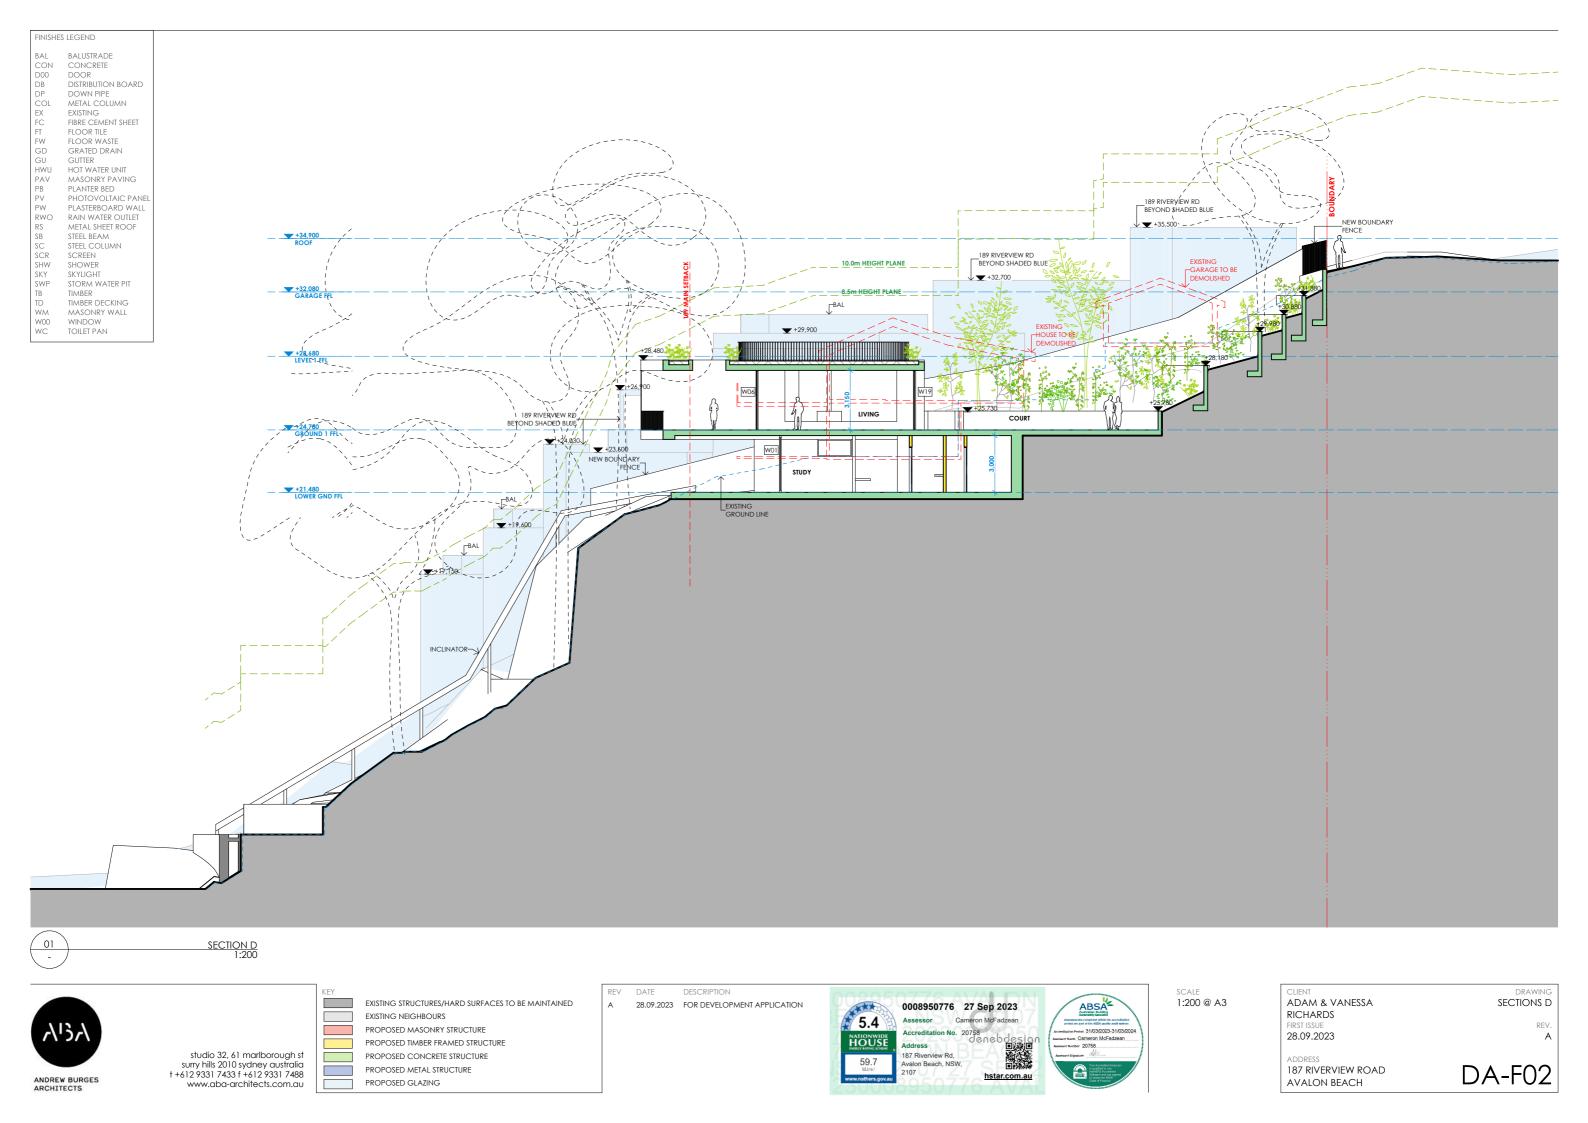

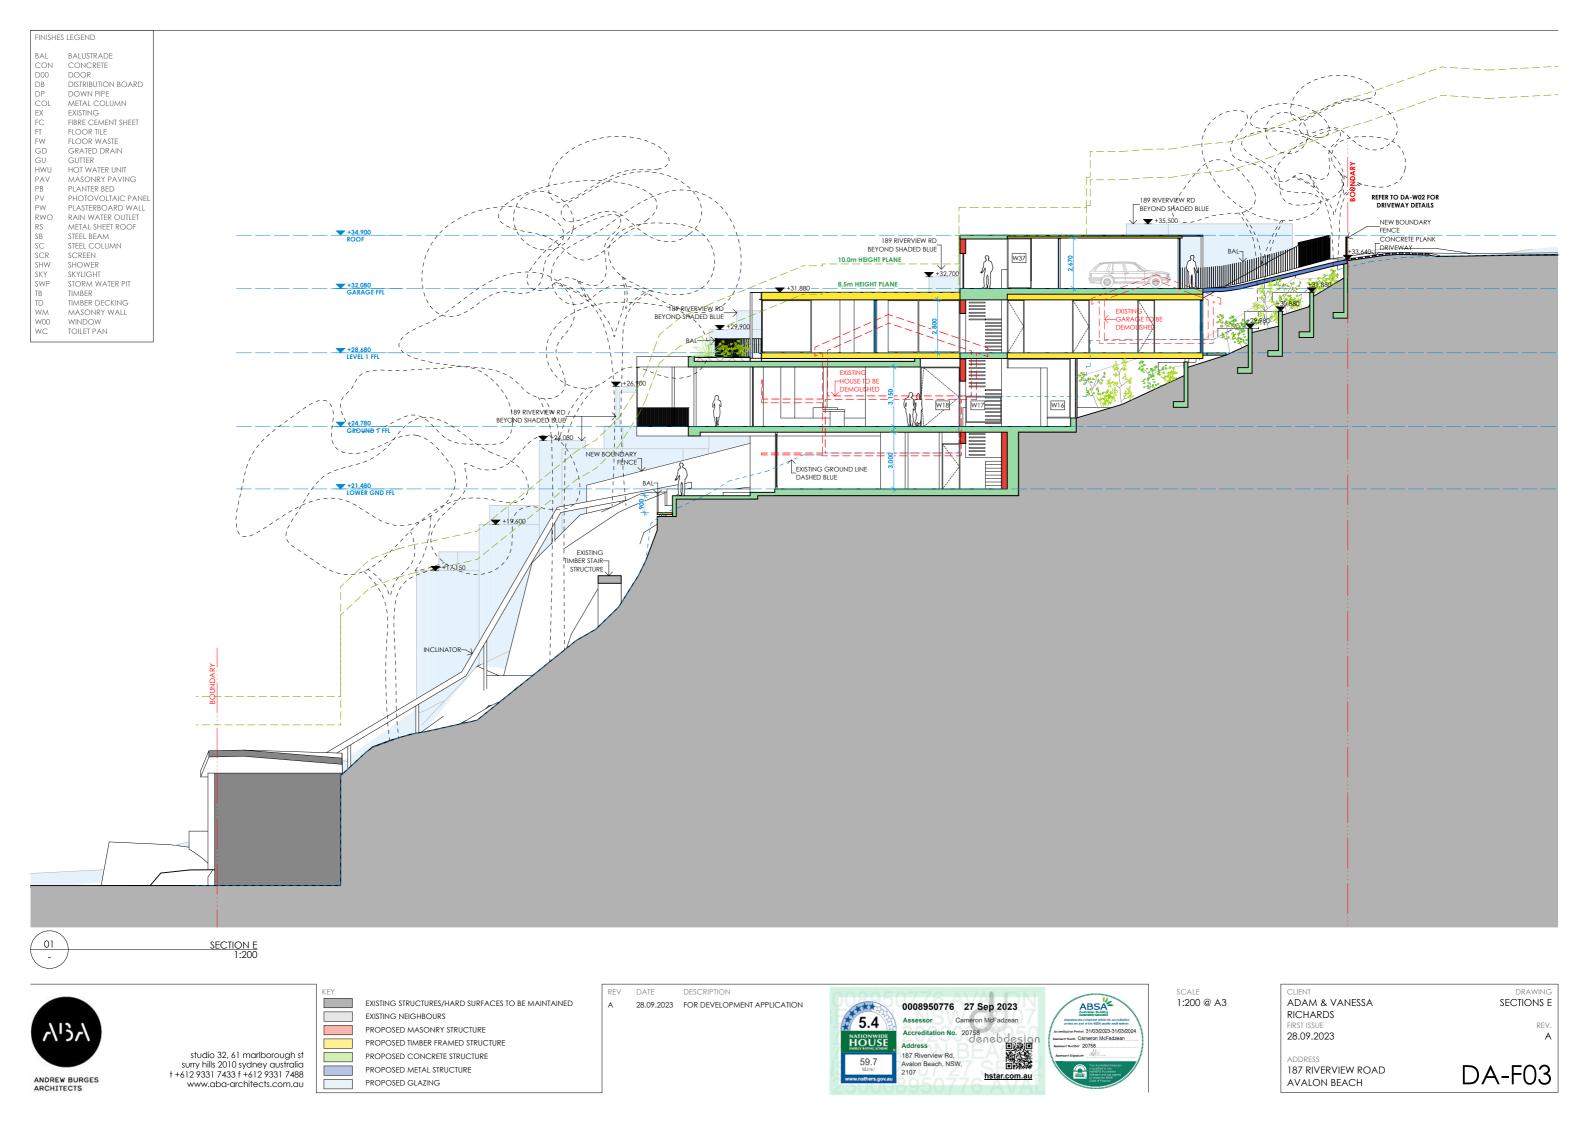

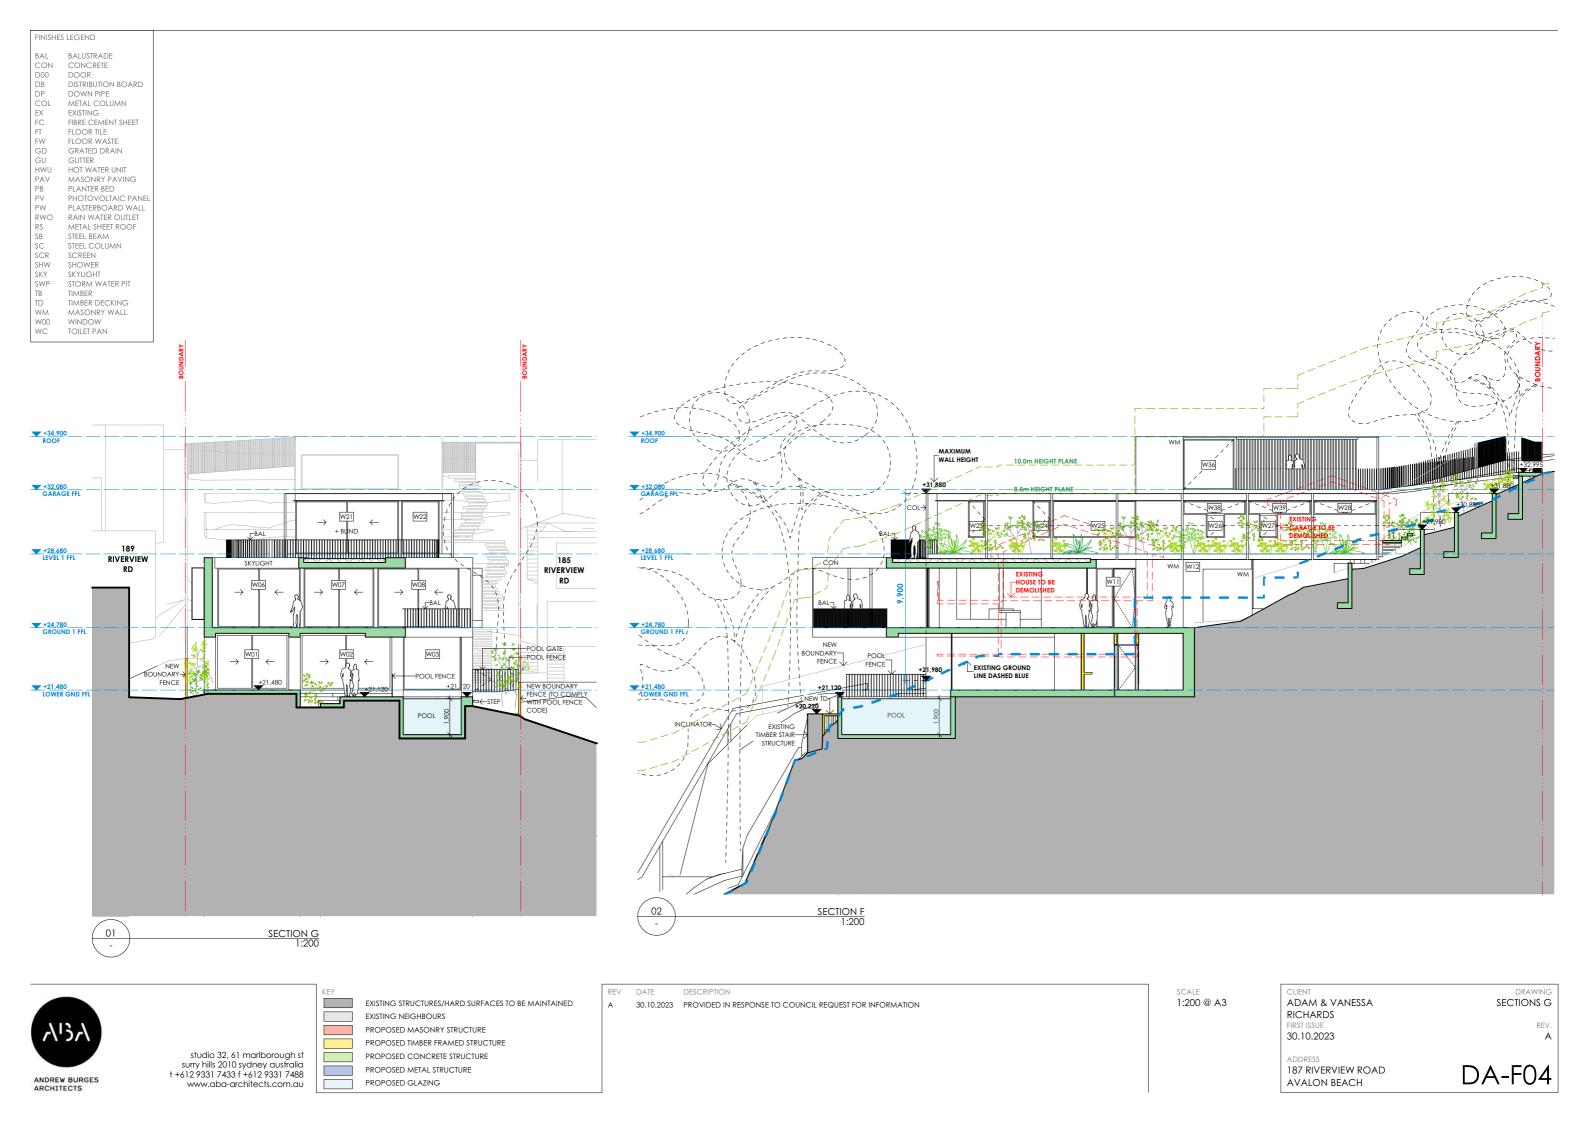



FC: FIBRE CEMENT SHEET CLADDING EQUITONE 'SOFT GREY' OR EQUIVALENT



CON: CONCRETE OFF-FORM CONCRETE WITH TEXTURED FINISH



WM: WALL MASONRY RENDERED MASONRY WALL

MESH DRIVE

RS



PAV: CRAZY PAVING LIMESTONE CRAZY PAVING



**ROOF GARDEN** REFER LANDSCAPE PLANS FOR DETAIL



MESH DRIVEWAY EXPANDED GAL STEEL MESH ON STEEL STRUCTURE



CONCRETE STEPS REFER LANDSCAPE PLANS FOR DETAIL



studio 32, 61 marlborough st surry hills 2010 sydney australia t +612 9331 7433 f +612 9331 7488 www.aba-architects.com.au

DESCRIPTION

28.09.2023 FOR DEVELOPMENT APPLICATION

CLIENT ADAM & VANESSA **RICHARDS** 28.09.2023

scale NTS

+ FINISHES ADDRESS 187 RIVERVIEW ROAD DA-M01 AVALON BEACH

DRAWING SCHEDULE OF MATERIALS





PERSPECTIVE VIEW 01



PERSPECTIVE VIEW 03

PERSPECTIVE VIEW 02



DESCRIPTION

A 28.09.2023 FOR DEVELOPMENT APPLICATION

scale NTS


CLIENT ADAM & VANESSA RICHARDS


28.09.2023

DRAWING
3D PERSPECTIVES

DA-P01

ADDRESS 187 RIVERVIEW ROAD AVALON BEACH

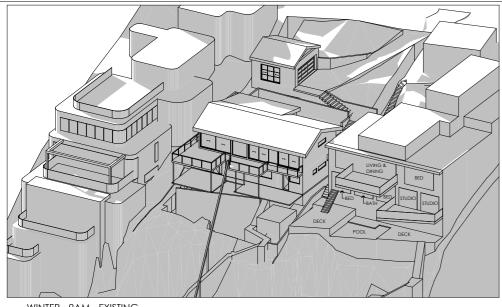

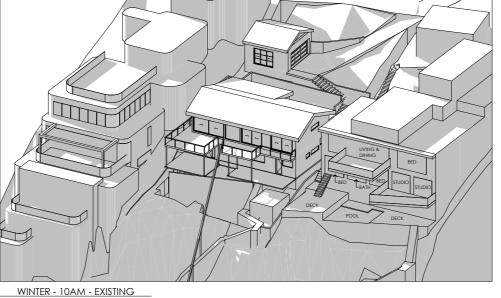



WINTER - 9AM - EXISTING



WINTER - 2PM - EXISTING

WINTER - 12PM - EXISTING



WINTER - 3PM - EXISTING



DESCRIPTION

WINTER - 1PM - EXISTING

A 28.09.2023 FOR DEVELOPMENT APPLICATION

I hereby certify the shadow diagrams on this page are a true and accurate representation.

Andrew Burges

scale NTS

Director, Andrew Burges Architects NSW Registered Architect #6918




CLIENT ADAM & VANESSA RICHARDS 28.09.2023


DRAWING SHADOW DIAGRAM EXISTING - WINTER - VIEW

ADDRESS 187 RIVERVIEW ROAD


DA-S01 AVALON BEACH

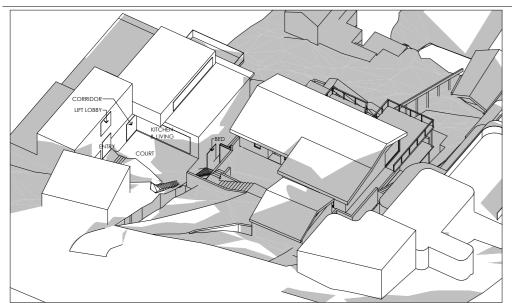

WINTER - 9AM - EXISTING - VIEW 2

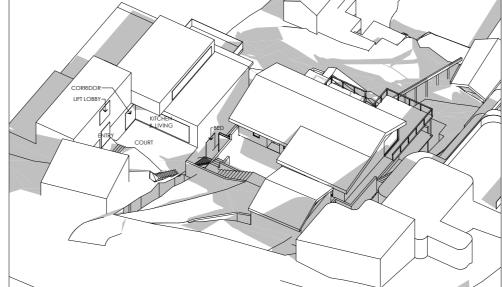

WINTER - 10AM - EXISTING - VIEW 2

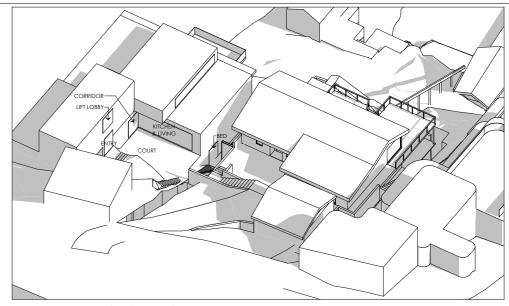

WINTER - 11AM - EXISTING - VIEW 2



WINTER - 21ST JUNE - 9AM (DRONE PHOTO TAKEN AT THAT TIME)



WINTER - 21ST JUNE - 10AM (DRONE PHOTO TAKEN AT THAT TIME)



WINTER - 21ST JUNE - 11AM (DRONE PHOTO TAKEN AT THAT TIME)

scale NTS



DESCRIPTION

A 28.09.2023 FOR DEVELOPMENT APPLICATION



I hereby certify the shadow diagrams on this page are a true and accurate representation.


Andrew Burges

Director, Andrew Burges Architects NSW Registered Architect #6918

CLIENT ADAM & VANESSA RICHARDS 28.09.2023

SHADOW DIAGRAM EXISTING - WINTER - VIEW 2 (WITH PHOTOS)


ADDRESS 187 RIVERVIEW ROAD AVALON BEACH

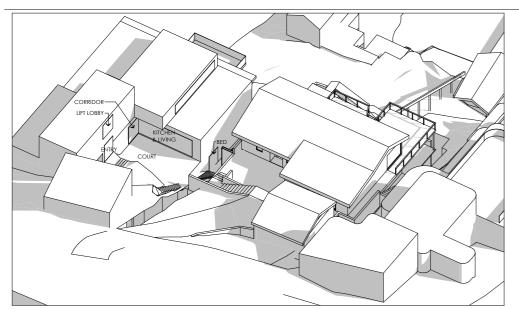

WINTER - 12PM - EXISTING - VIEW 2




WINTER - 21ST JUNE - 12PM (DRONE PHOTO TAKEN AT THAT TIME)

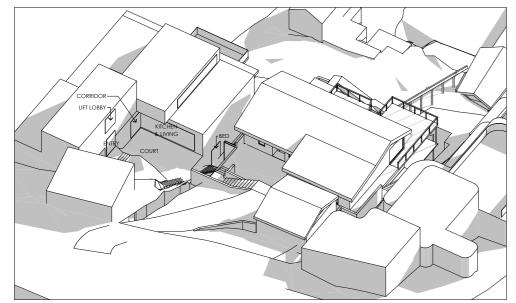

WINTER - 3PM - EXISTING - VIEW 2




studio 32, 61 marlborough st surry hills 2010 sydney australia t +612 9331 7433 f +612 9331 7488 www.aba-architects.com.au

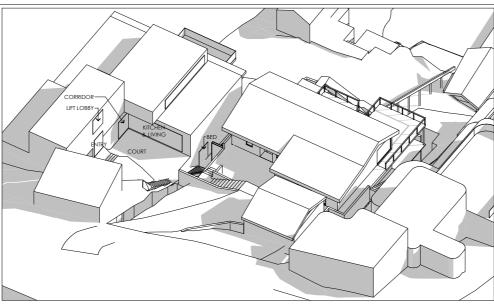

WINTER - 1PM - EXISTING - VIEW 2



WINTER - 21ST JUNE - 1PM (DRONE PHOTO TAKEN AT THAT TIME)

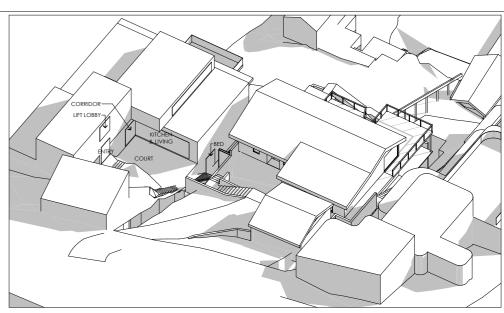

WINTER - 2PM - EXISTING - VIEW 2

NO CORRESPONDING PHOTO

### Certification:

I hereby certify the shadow diagrams on this page are a true and accurate representation.

# Andrew Burges

Director, Andrew Burges Architects NSW Registered Architect #6918



ADAM & VANESSA RICHARDS FIRST ISSUE 28.09.2023 SHADOW DIAGRAM EXISTING - WINTER - VIEW 2 (WITH PHOTOS)<sup>R</sup>(V) A


**DA-S03** 


DDRESS **87 RIVFRVIF**V

187 RIVERVIEW ROAD AVALON BEACH

A 28.09.2023 FOR DEVELOPMENT APPLICATION


scale NTS

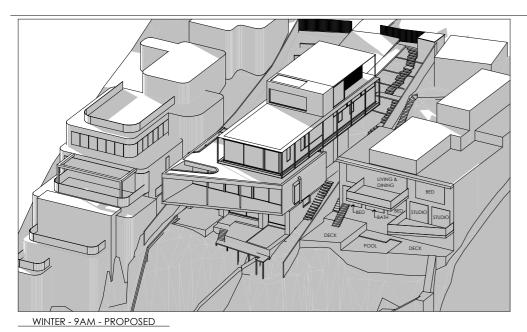

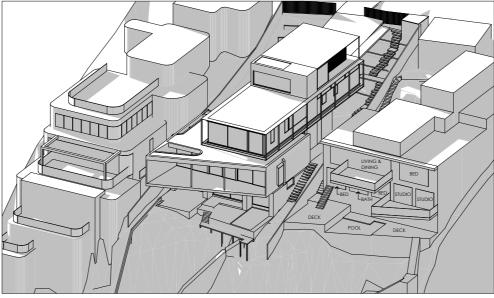

WINTER - 10AM - PROPOSED

WINTER -11AM - PROPOSED

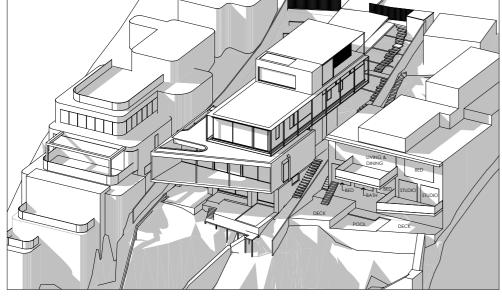

WINTER - 12PM - PROPOSED



WINTER - 1PM - PROPOSED



WINTER - 2PM - PROPOSED

scale NTS



WINTER - 3PM - PROPOSED



DESCRIPTION

A 28.09.2023 FOR DEVELOPMENT APPLICATION

I hereby certify the shadow diagrams on this page are a true and accurate representation.

Andrew Burges

Director, Andrew Burges Architects NSW Registered Architect #6918




CLIENT ADAM & VANESSA RICHARDS 28.09.2023


DRAWING SHADOW DIAGRAM PROPOSED - WINTER -VIEWY.


ADDRESS 187 RIVERVIEW ROAD AVALON BEACH

**DA-S04** 

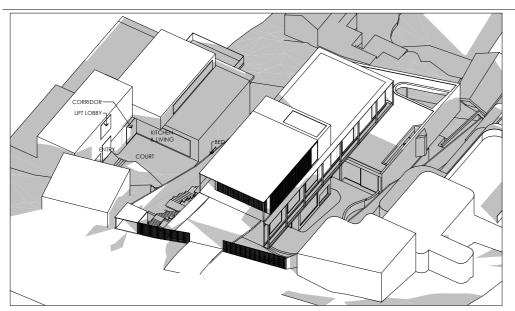



WINTER - 9AM - PROPOSED - VIEW 2

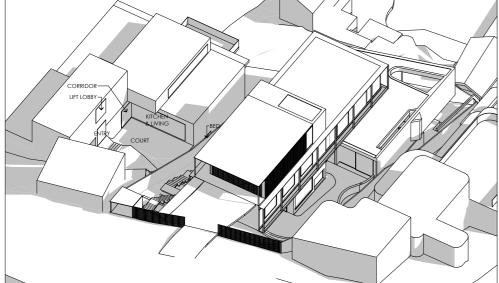

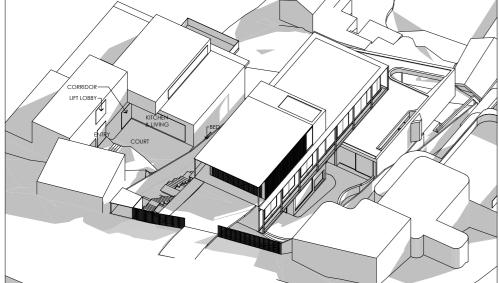


WINTER - 3PM - PROPOSED - VIEW 2

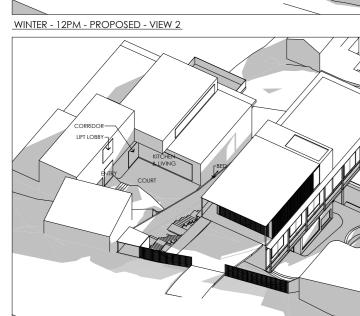


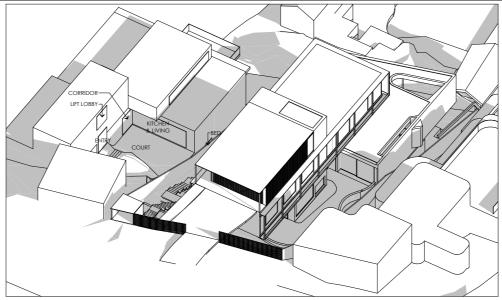

WINTER - 10AM - PROPOSED - VIEW 2

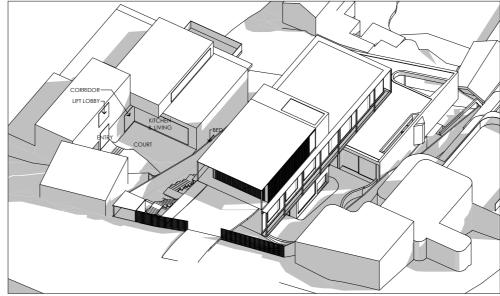

WINTER - 1PM - PROPOSED - VIEW 2

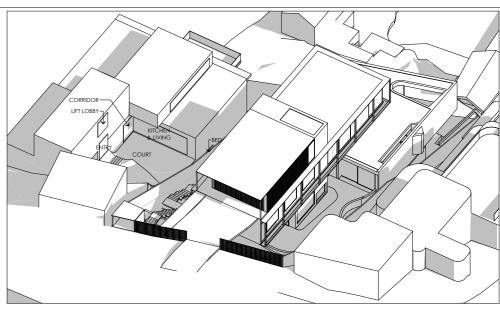

WINTER - 11AM - PROPOSED - VIEW 2



WINTER - 2PM - PROPOSED - VIEW 2

scale NTS

# Certification:

I hereby certify the shadow diagrams on this page are a true and accurate representation.

# Andrew Burges

Director, Andrew Burges Architects NSW Registered Architect #6918



CLIENT ADAM & VANESSA **RICHARDS** 28.09.2023

DRAWING SHADOW DIAGRAM PROPOSED - WINTER -VIE₩2

187 RIVERVIEW ROAD

**DA-S05** AVALON BEACH

DESCRIPTION

A 28.09.2023 FOR DEVELOPMENT APPLICATION

