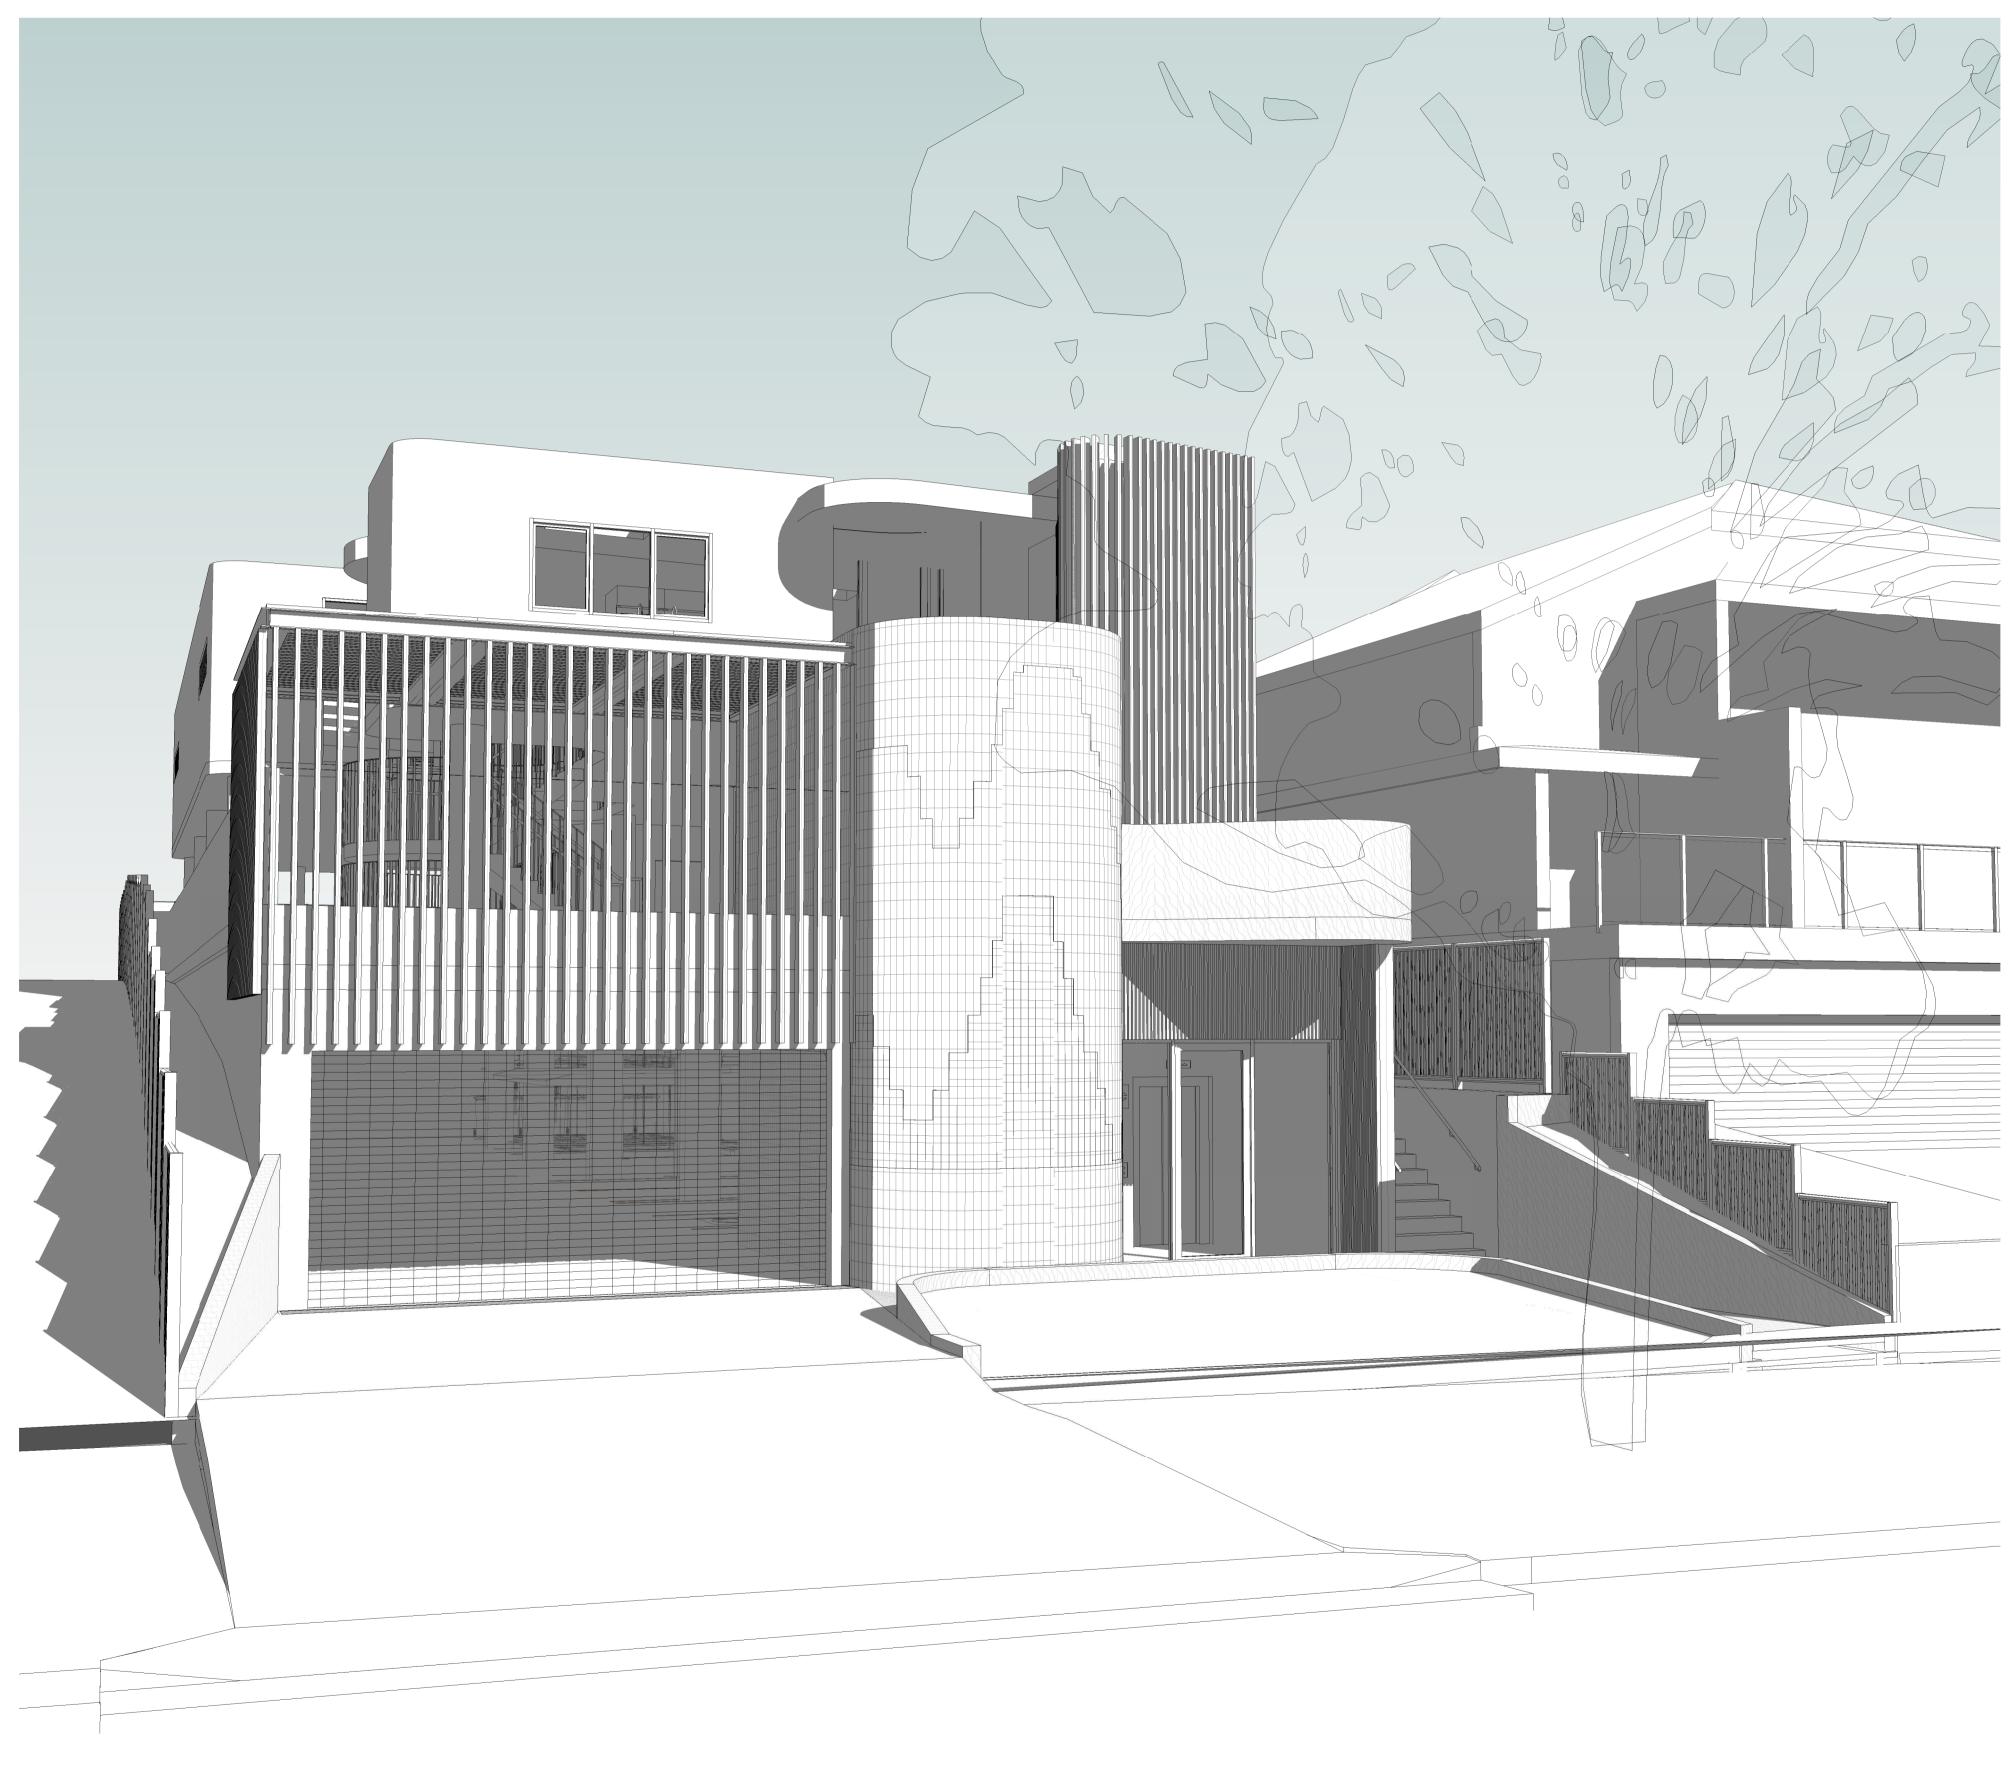
# CHILDCARE CENTRE

11 Lewis Street Balgowlah Heights NSW 2093





Development Application			
Rev	Description	Date	
А	Issue for Development Application	17.12.2020	

LEVEL 4, 111-117 DEVONSHIRE STREET, SURRY HILLS, NSW 2010 T.02 9318 8400 F.02 9318 8480 STEPHEN J. NORDON Registration No. NSW - 4704 GRAHAM P. JAGO Registration No. NSW - 4926

#### **NOT For Construction**

TITLE

		DA Drawings	
Sheet No.	Rev	Title	Date
DA.100	A	Proposed Lower Ground	17.12.2020
DA.200	A	Proposed Sections	17.12.2020
DA.101	A	Proposed Ground and Level 1 Plans	17.12.2020
DA.060	Α	GFA	17.12.2020
DA.040	Α	Demolition Plan	17.12.2020
DA.300	Α	Proposed Elevations	17.12.2020
DA.190	A	Proposed Roof Plan	17.12.2020
DA.070	Α	Tree Protection Plan	17.12.2020
DA.080	A	Prevailing Building Line Plan and Elevation	17.12.2020
DA.065	A	8.5mtr Height Blanket	17.12.2020
DA.066	A	Driveway Section	17.12.2020
DA.000	A	Cover Page	17.12.2020
DA.010	A	Site Analysis Plan	17.12.2020
DA.030	A	Cut and Fill Plan	17.12.2020
DA.020	A	Site Plan	17.12.2020
DA.035	A	Shadows 21st June	17.12.2020
DA.901	A	Proposed Finishes - Sheet 2	17.12.2020
DA.900	A	Proposed Finishes - Sheet 1	17.12.2020
DA.902	A	3D Views	17.12.2020
DA.061	A	Unencumbered Area Plans	17.12.2020
DA.036	A	Shadows 21 June Balgowlah Heights Public School	17.12.2020
DA.301	A	Proposed Elevations	17.12.2020

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	DATE	December 2020
Cover Page		A1 @
		DA.000 A





Neighbourhood Context Plan 1 : 1250





# **Development Application**

0m

Date 17.12.2020

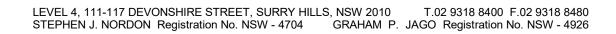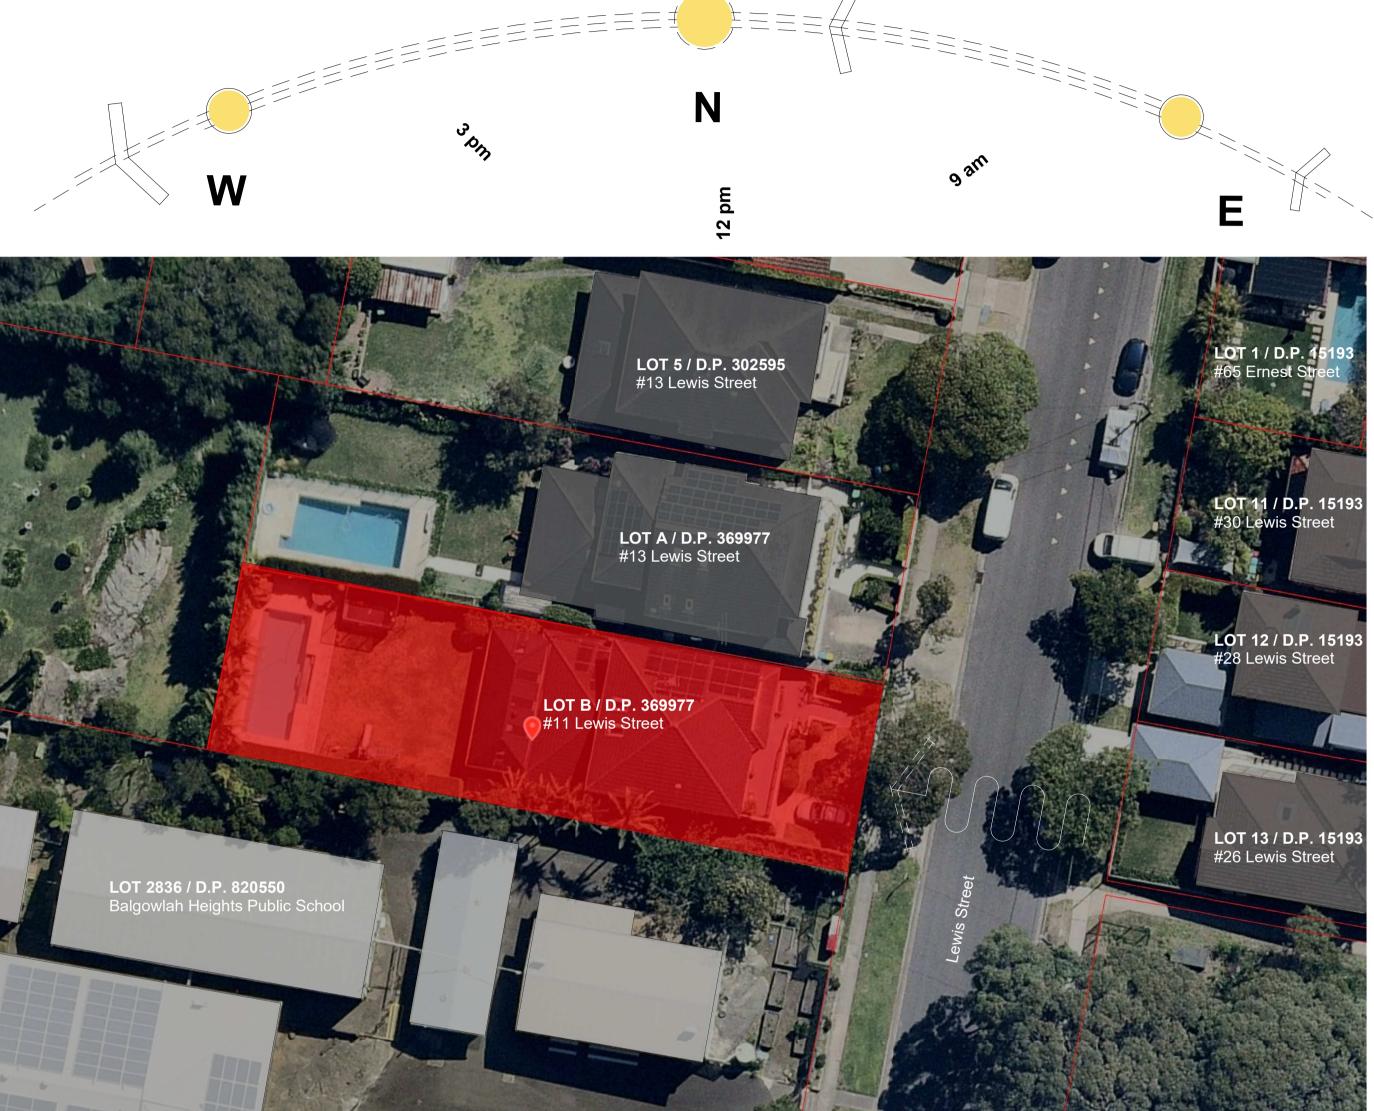Rev	Description
Α	Issue for Development Application









7	Local Context Plan
4	1 : 300

#### **NOT For Construction**

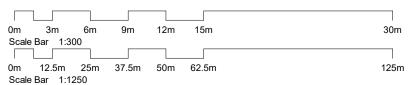

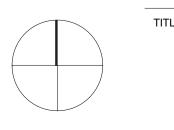

TITLE

General Legend:				
	Proposed Site			
	Public Open Space			
	R2. Low Density Residential			
	SP2. Infrastructure			
	Existing Building (1 storey)			
	Existing Building (1-2 storeys)			

#### General Notes:

Architectural Drawings To Be Read In Conjunction With All Other Design Consultants Detailed Drawings, Reports And Specifications.

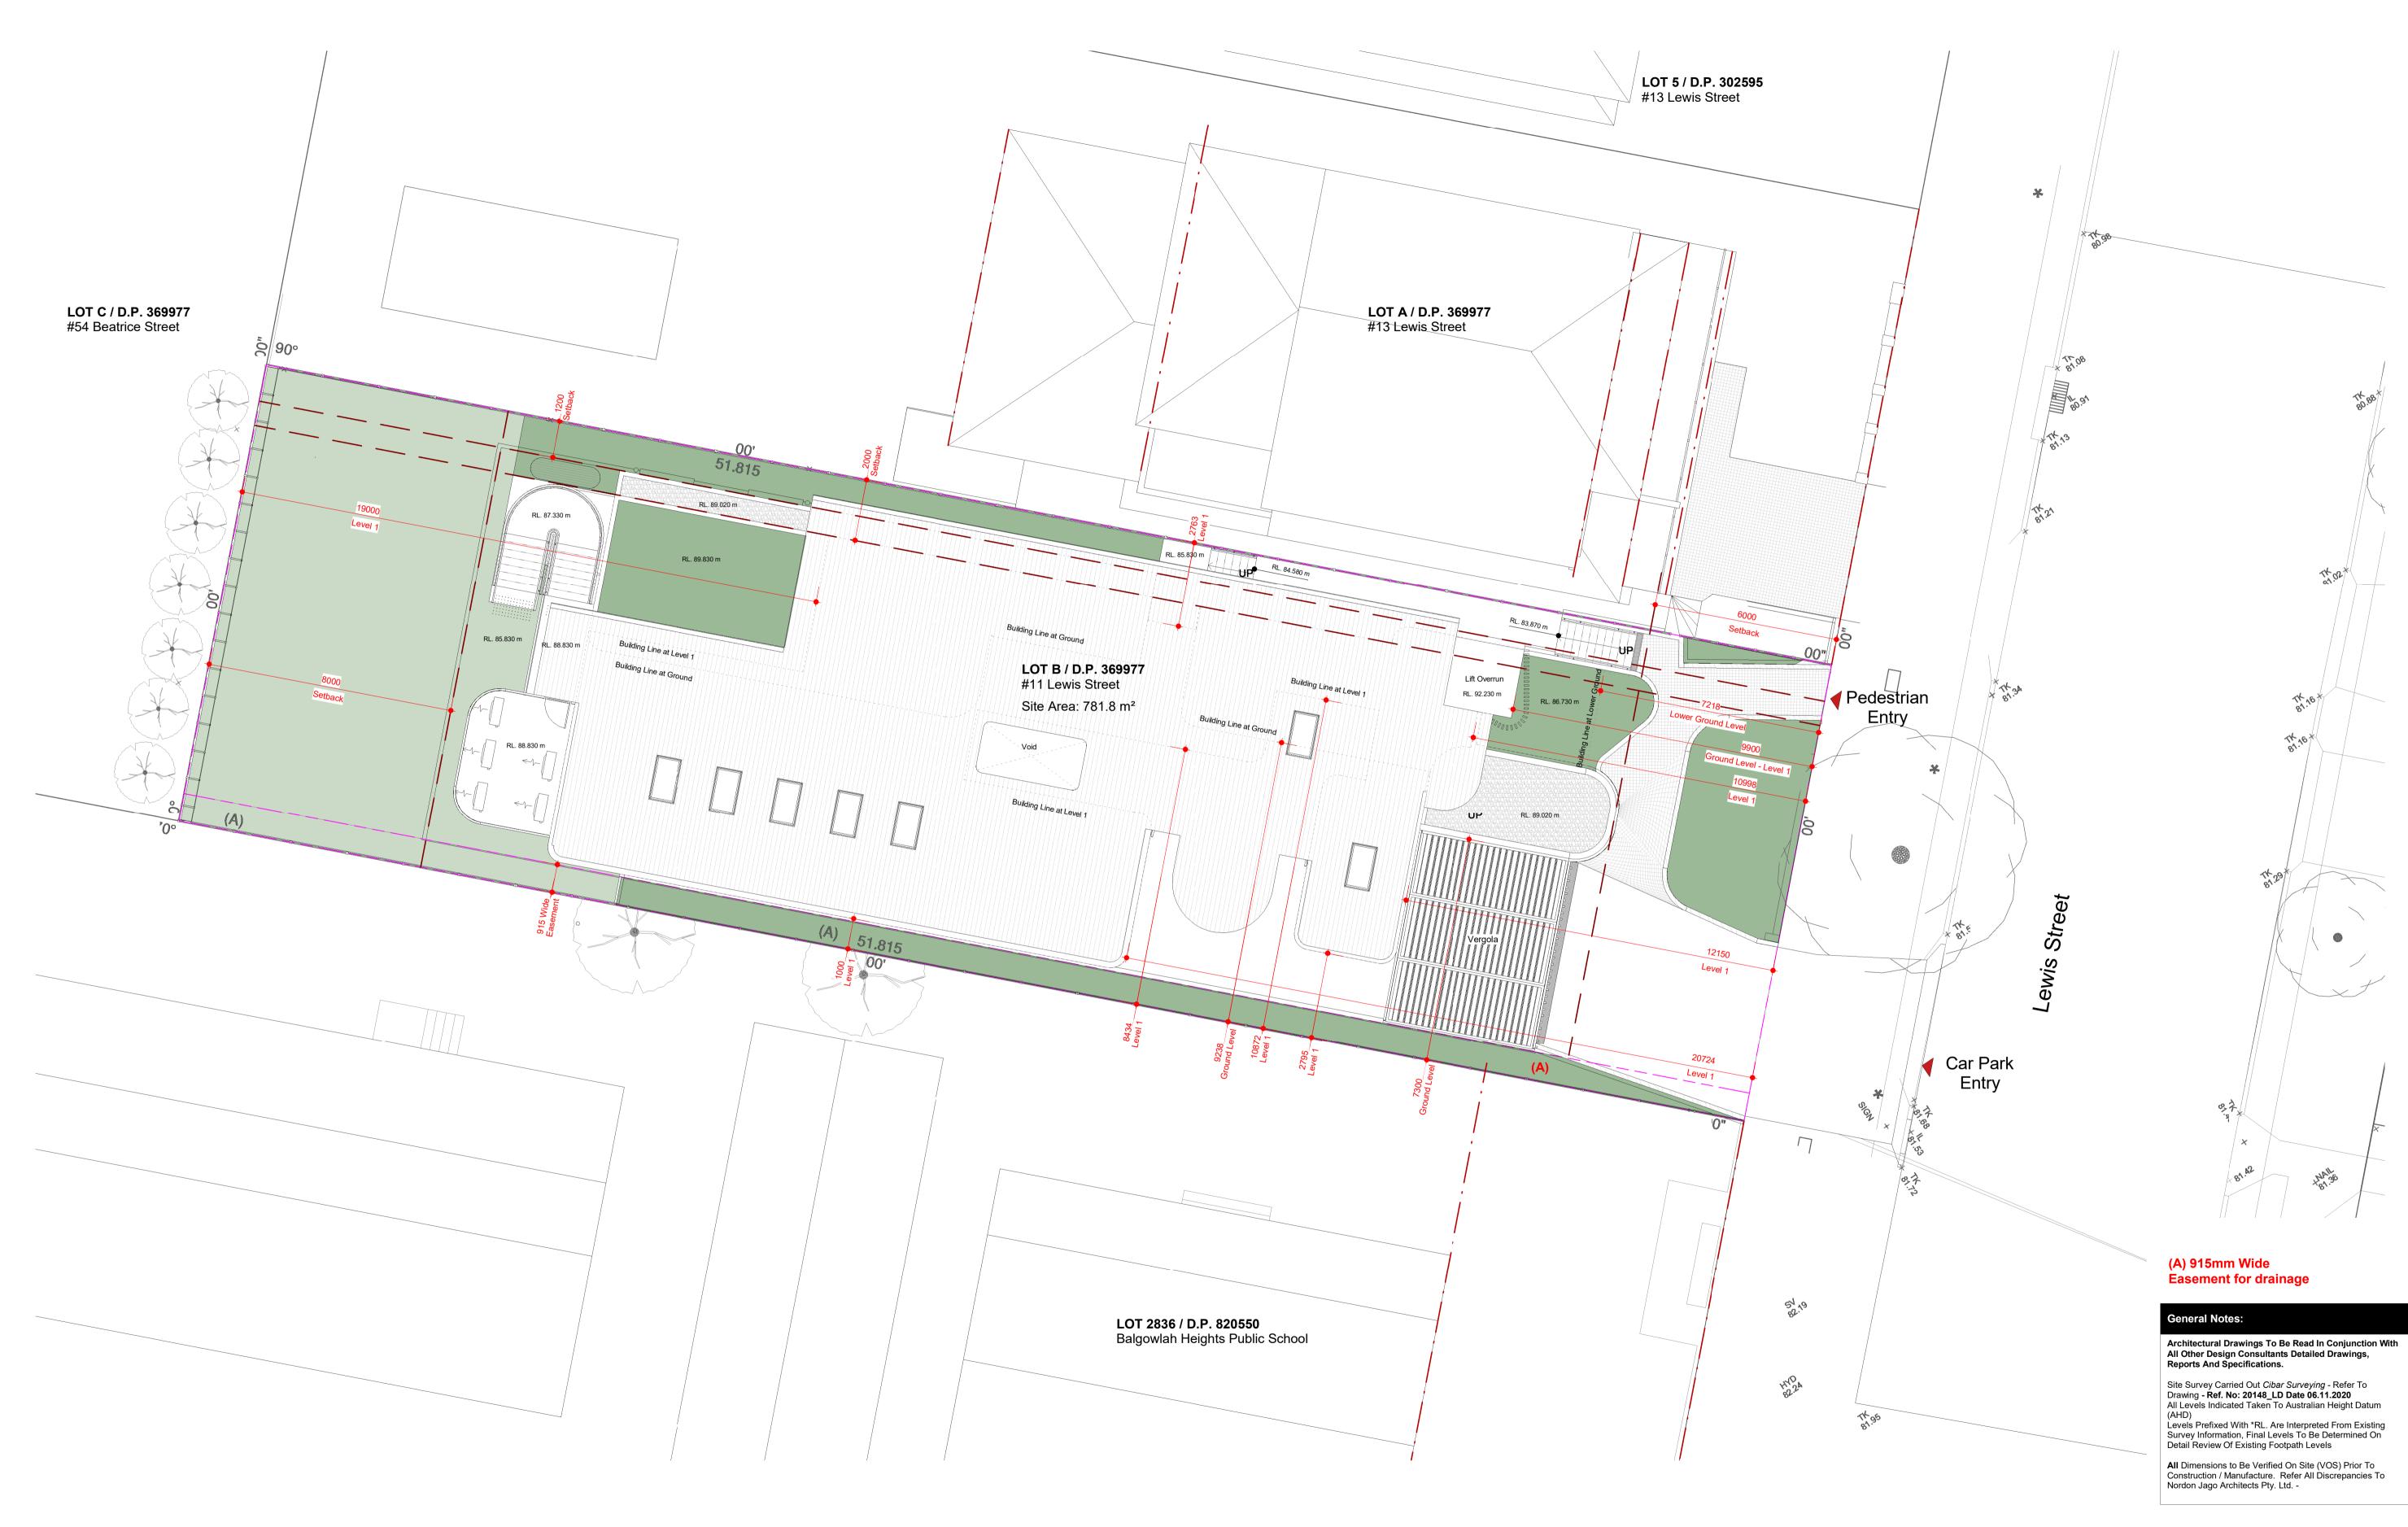
Site Survey Carried Out *Cibar Surveying* - Refer To Drawing - **Ref. No: 20148\_LD Date 06.11.2020** All Levels Indicated Taken To Australian Height Datum (AHD) (AHD) Levels Prefixed With \*RL. Are Interpreted From Existing Survey Information, Final Levels To Be Determined On Detail Review Of Existing Footpath Levels

**All** Dimensions to Be Verified On Site (VOS) Prior To Construction / Manufacture. Refer All Discrepancies To Nordon Jago Architects Pty. Ltd. -

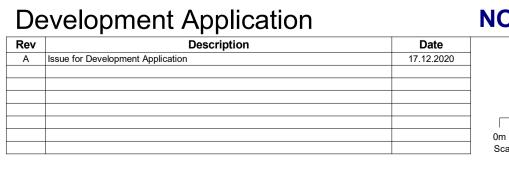
#### DA Applicant : George Antoniou Site Address : Lot B DP 369977 11 Lewis Street Balgowlah Heights NSW 2093

Olic Analysis Fian	DWG No.		
Site Analysis Plan	SCALE	A1 @ As indicated	
		December 2020	
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DA.010 A








# **NOT For Construction**
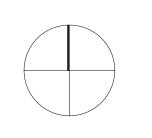
#### DA Applicant : George Antoniou Site Address : Lot B DP 369977 11 Lewis Street Balgowlah Heights NSW 2093



TITLE


0m 1m 2m 3m 4m 5m 10 Scale Bar 1:100

	-		
D:\NJA Local Files\BVR00120 Lewis St\BVR00120 DA 201114 GT Local.rvt	JOB No.		BVR00120
		Decer	nber 2020
Site Plan	SCALE	A1 @	1 : 100
	DWG No.		
		DA.02	20 A





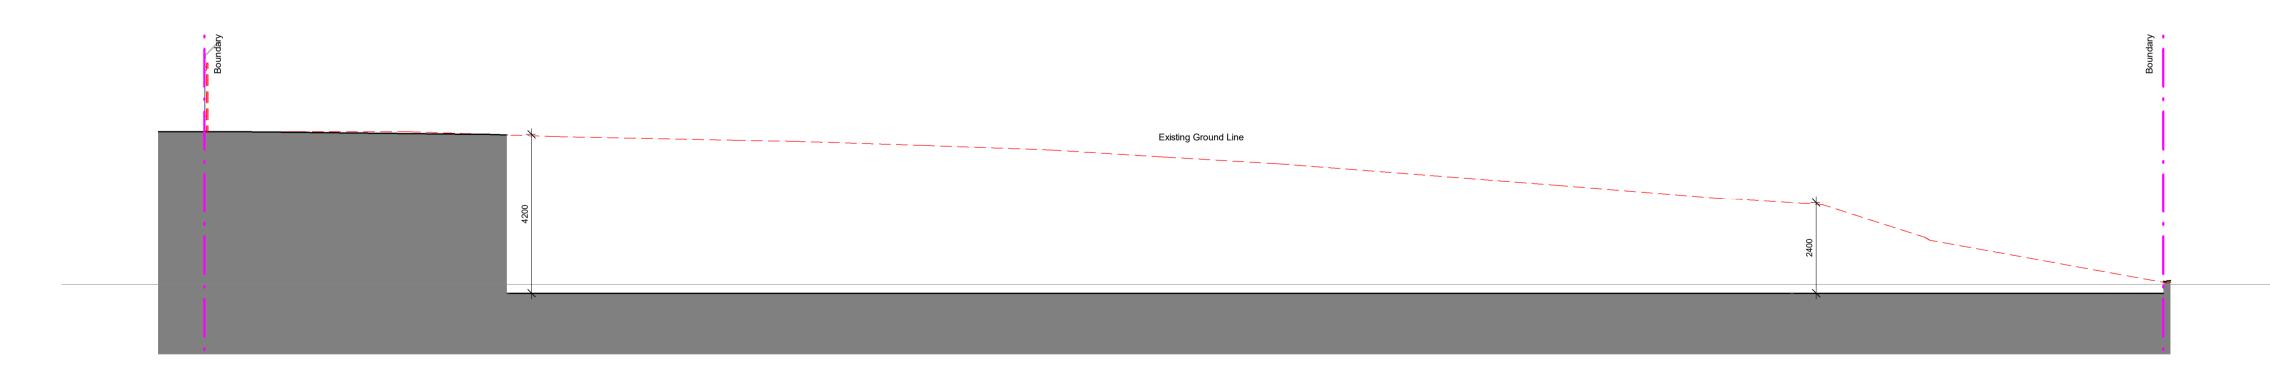**1** 030.SP.Cut and Fill Plan








# Rev Description A Issue for Development Application **Date** 17.12.2020 0m 1m 2m 3m 4m 5m Scale Bar 1:100

LEVEL 4, 111-117 DEVONSHIRE STREET, SURRY HILLS, NSW 2010 T.02 9318 8400 F.02 9318 8480 STEPHEN J. NORDON Registration No. NSW - 4704 GRAHAM P. JAGO Registration No. NSW - 4926

#### **NOT For Construction**

10m
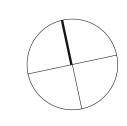
#### DA Applicant : George Antoniou Site Address : Lot B DP 369977 11 Lewis Street Balgowlah Heights NSW 2093



TITLE

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Mark	Location	Area	Cut	Fill	Net cut/fill
01	Lower Ground	579.68 m <sup>2</sup>	1730.82 m <sup>3</sup>	0.00 m³	-1730.82 m³
					-1730.82 m <sup>3</sup>

#### Lewis Street

Lower Ground - RL 81760

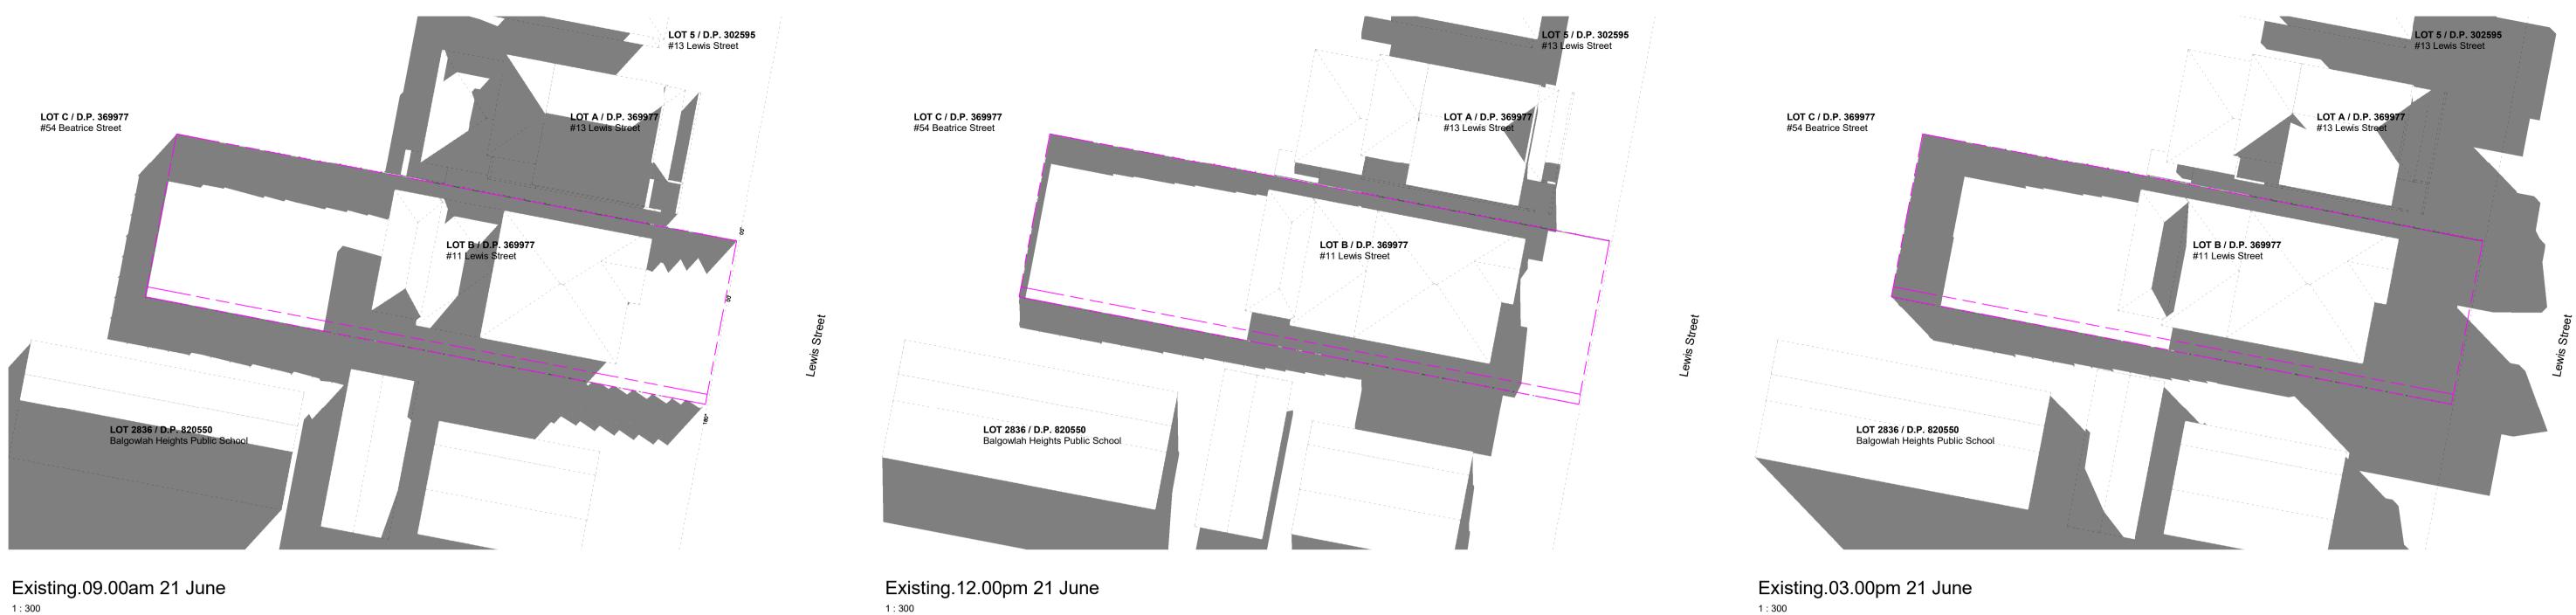
#### General Notes:

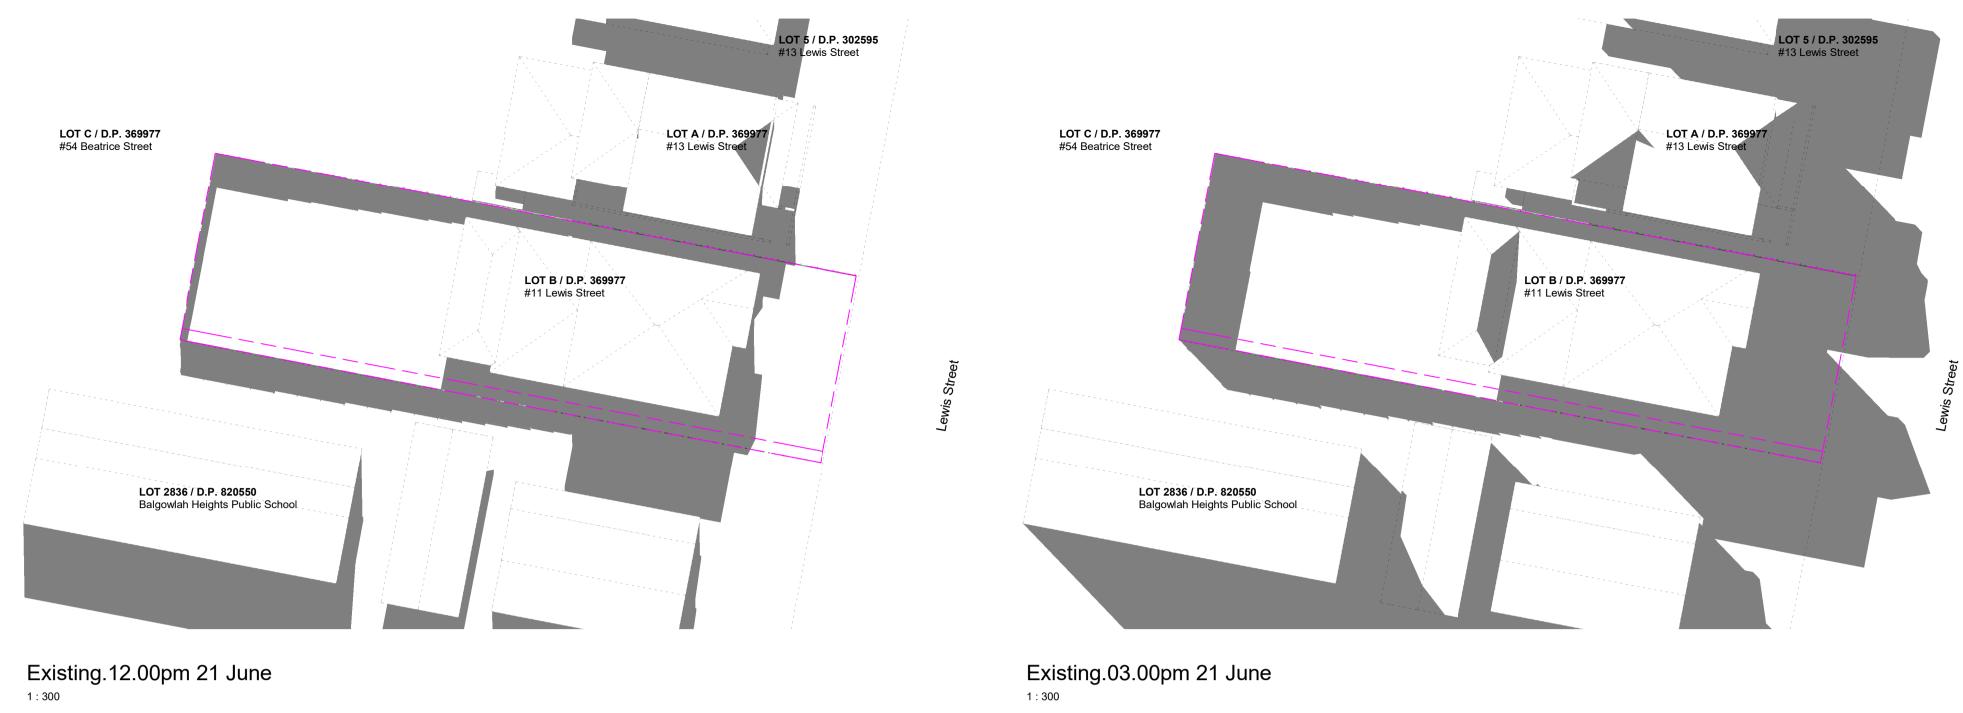
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Site Survey Carried Out *Cibar Surveying* - Refer To Drawing - **Ref. No: 20148\_LD Date 06.11.2020** All Levels Indicated Taken To Australian Height Datum (AHD) Levels Prefixed With \*RL. Are Interpreted From Existing Survey Information, Final Levels To Be Determined On Detail Review Of Existing Footpath Levels

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Cut and Fill Plan		December 2020
		A1 @ 1 : 100
	DWG No.	
		DA.030 A








Proposed.09.00am 21 June 1:300

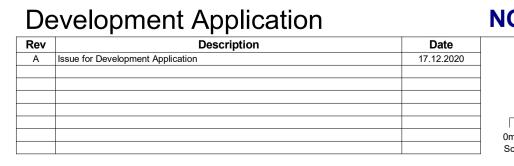Proposed.12.00pm 21 June 1:300






0m 1m 2m 3m 4m 5m Scale Bar 1:100

Proposed.03.00pm 21 June 1:300

# **NOT For Construction**
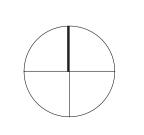
# DA Applicant : George Antoniou Site Address : Lot B DP 369977 11 Lewis Street Balgowlah Heights NSW 2093




-----TITLE

Shadows	Legend:	
	Propsed Shadow	
	Existing Shadow	
	Existing Fence Shadow	
	Improvement from Proposed Development	
Shadow Diag	grams prepared by Nordon Jago Architects	
General Notes:		
Architectural Drawings To Be Read In Conjunction With All Other Design Consultants Detailed Drawings, Reports And Specifications.		
	Carried Out Cibar Surveying - Refer To	
(AHD) Levels Prefix	ef. No: 20148_LD Date 06.11.2020 dicated Taken To Australian Height Datum xed With *RL. Are Interpreted From Existing	
(AHD) Levels Prefix Survey Infor	dicated Taken To Australian Height Datum	

	DWG No.	
Shadows 21st June	SCALE	A1 @ As indicated
		December 2020
D:\NJA Local Files\BVR00120 Lewis St\BVR00120 DA 201114 GT Local.rvt	JOB No.	BVR00120




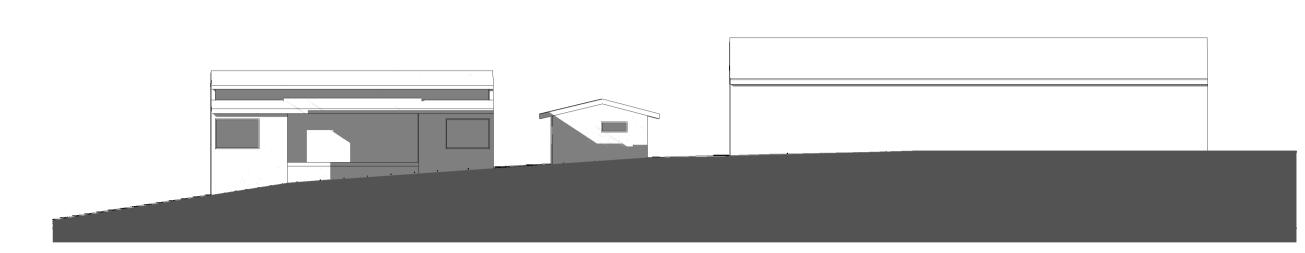

Existing.09.00am 21 June



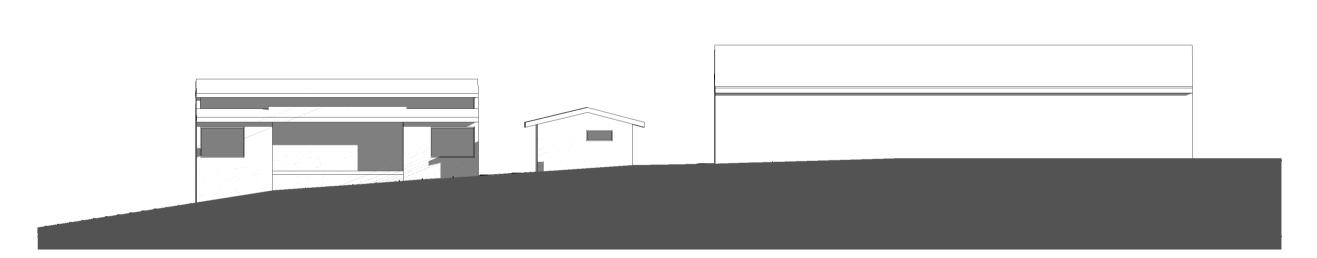Existing.12.00pm 21 June




Existing.03.00pm 21 June




De	evelopment Application	
Rev Description		


Rev	Description	Date
А	Issue for Development Application	17.12.2020

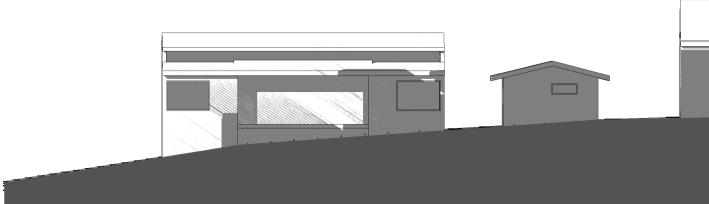


Proposed.09.00am 21 June

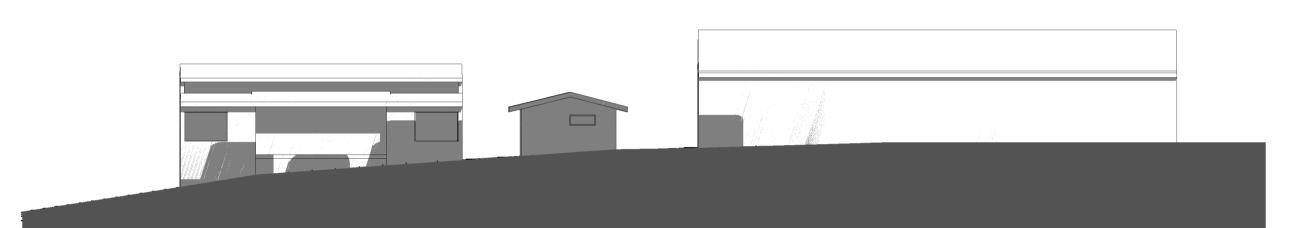

Proposed.12.00Pm 21 June

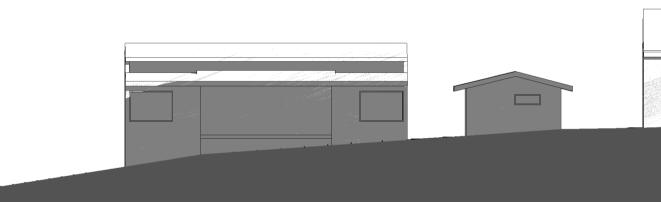


Proposed.03.00pm 21 June

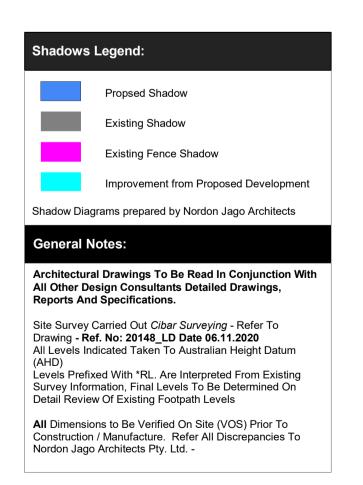

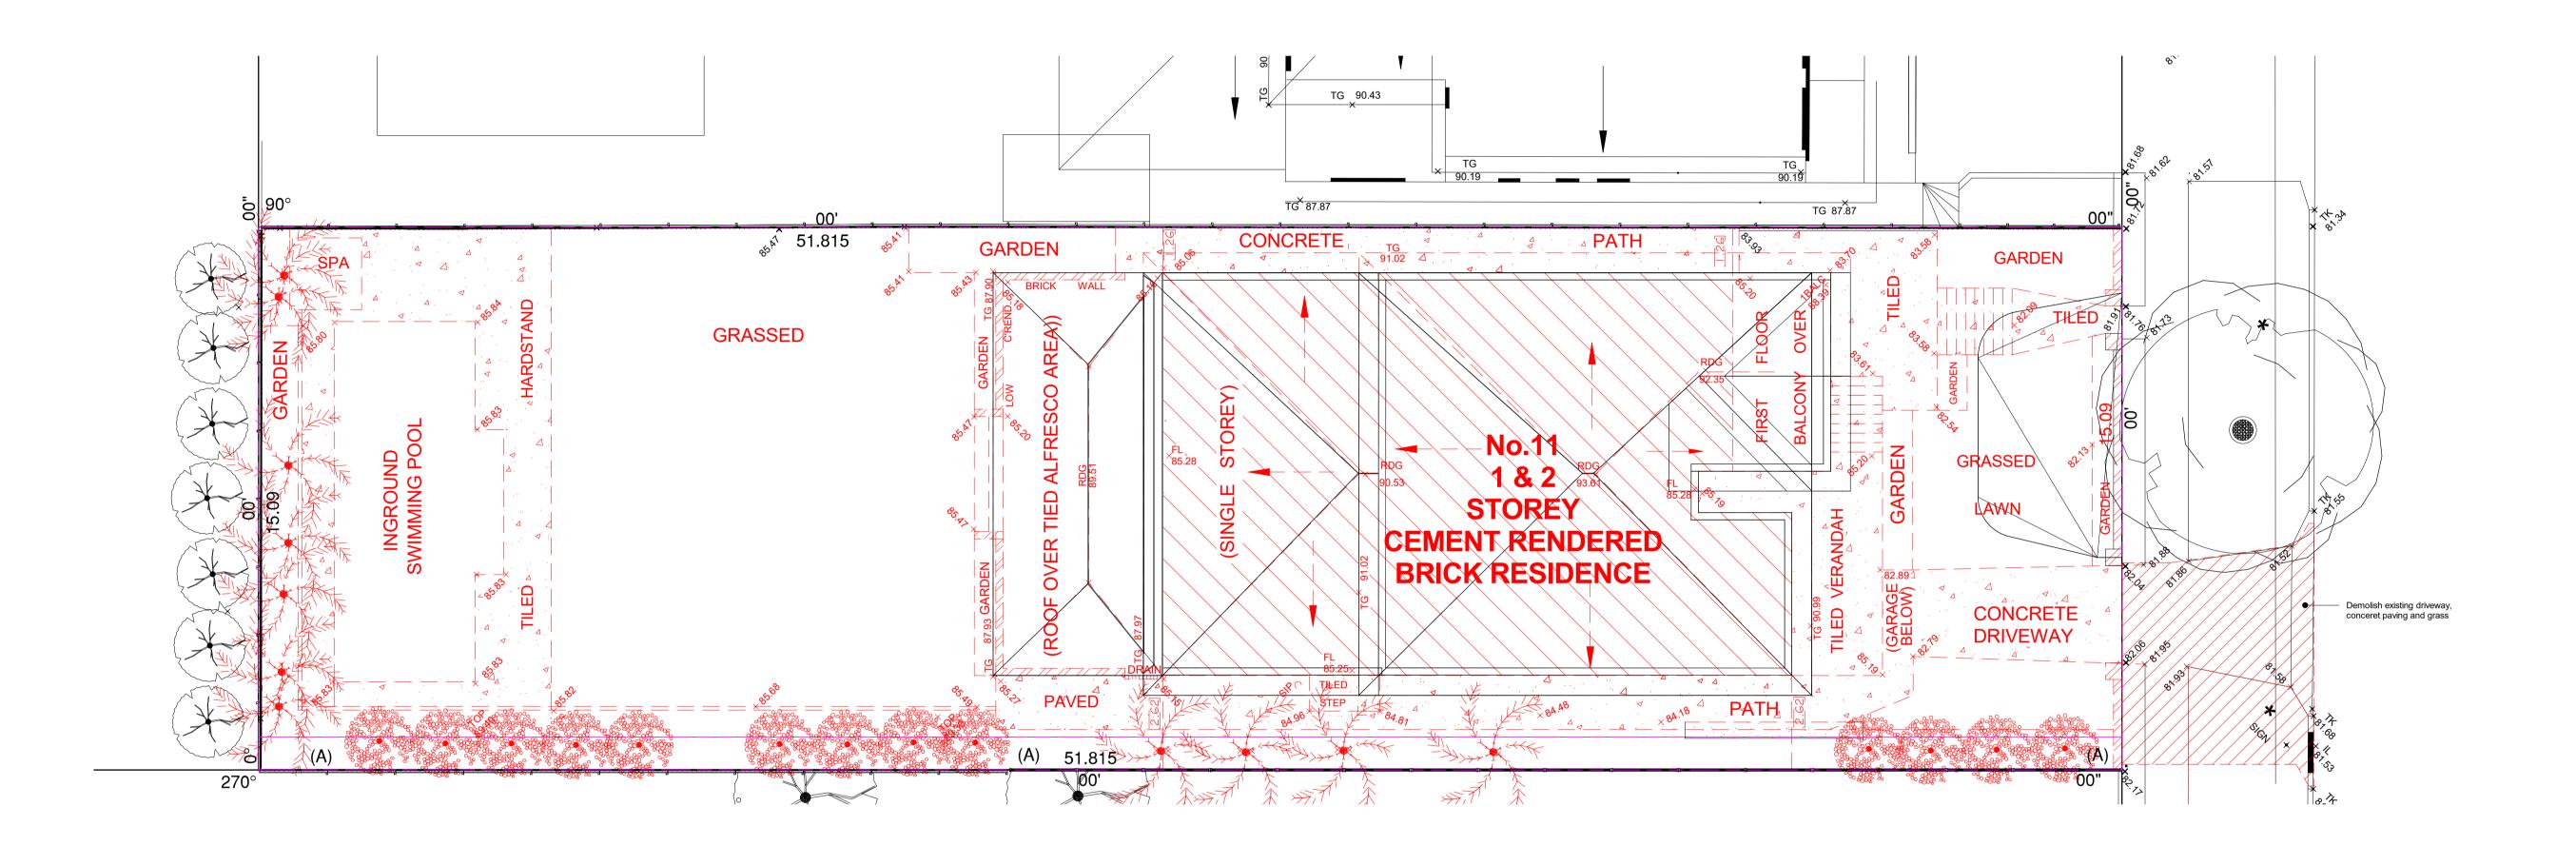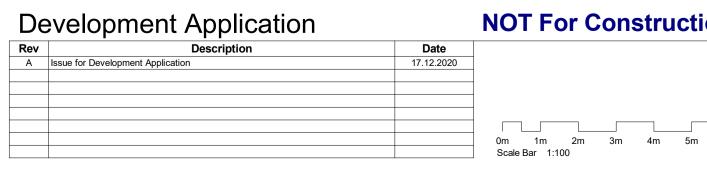
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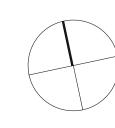








#### **NOT For Construction**



TITLE

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#### General Notes:

Architectural Drawings To Be Read In Conjunction With All Other Design Consultants Detailed Drawings, Reports And Specifications.

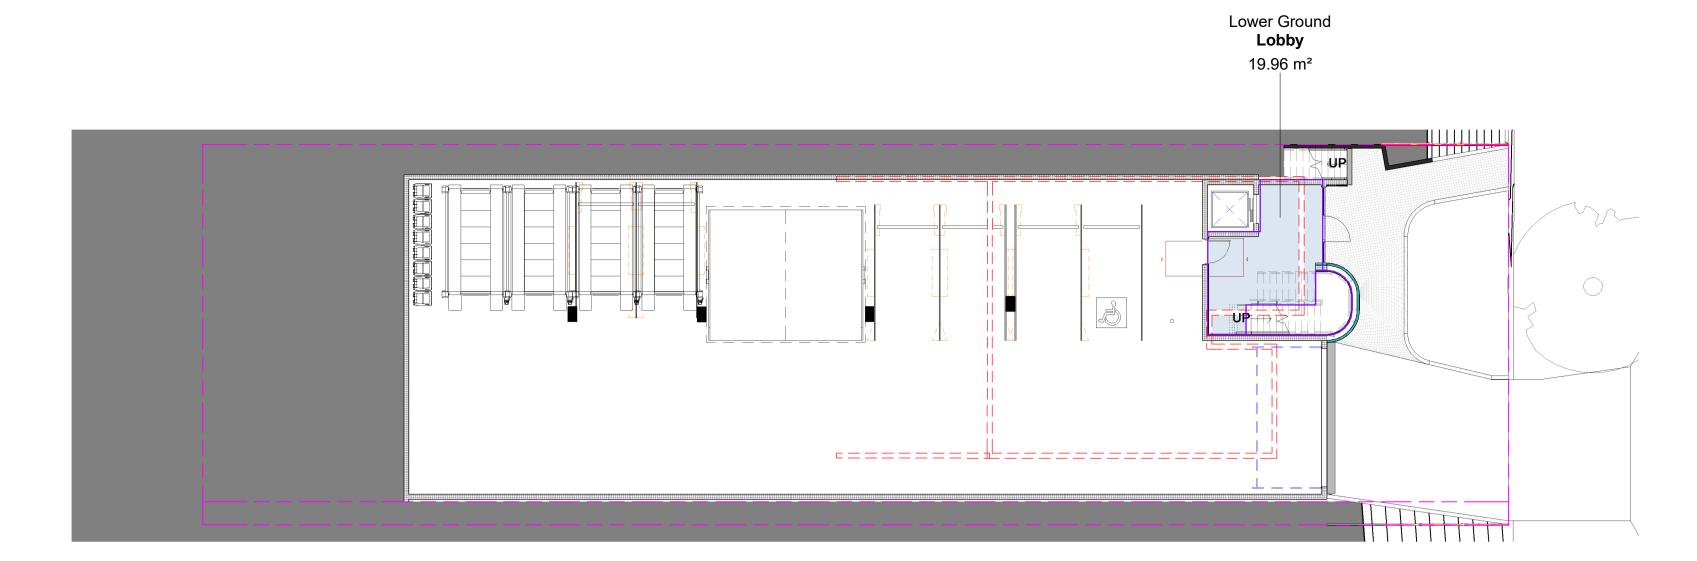
Site Survey Carried Out *Cibar Surveying* - Refer To Drawing - **Ref. No: 20148\_LD Date 06.11.2020** All Levels Indicated Taken To Australian Height Datum (AHD) (AHD) Levels Prefixed With \*RL. Are Interpreted From Existing Survey Information, Final Levels To Be Determined On Detail Review Of Existing Footpath Levels

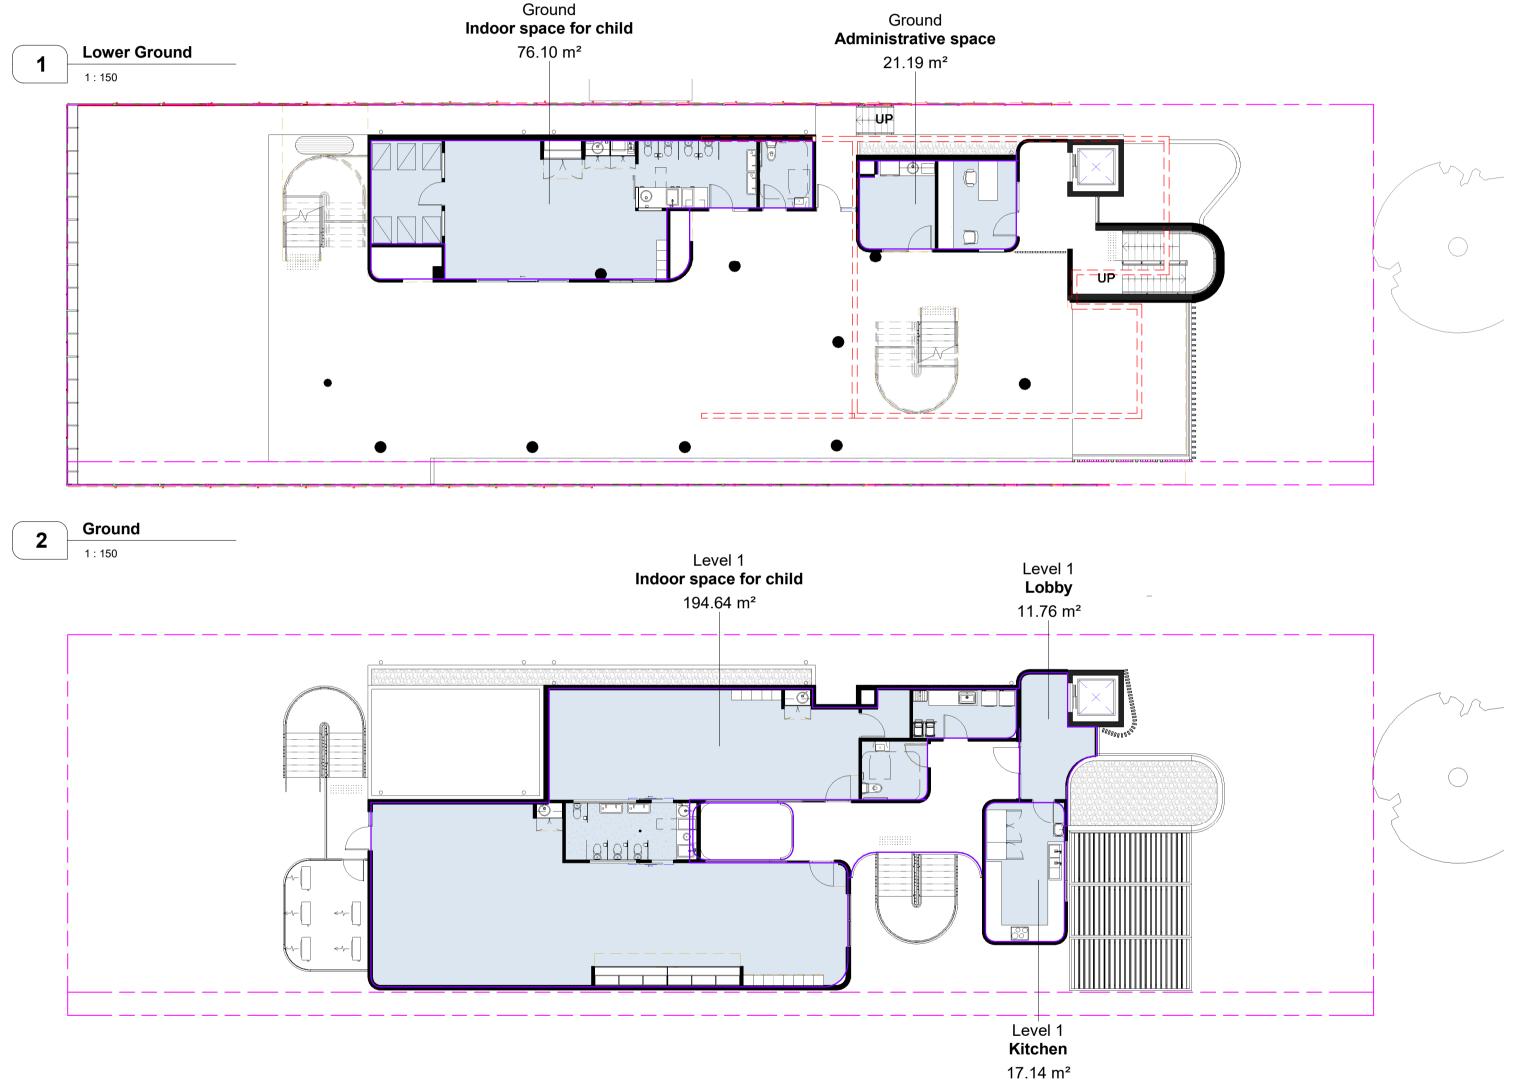
**All** Dimensions to Be Verified On Site (VOS) Prior To Construction / Manufacture. Refer All Discrepancies To Nordon Jago Architects Pty. Ltd. -

#### DA Applicant : George Antoniou Site Address : Lot B DP 369977 11 Lewis Street Balgowlah Heights NSW 2093

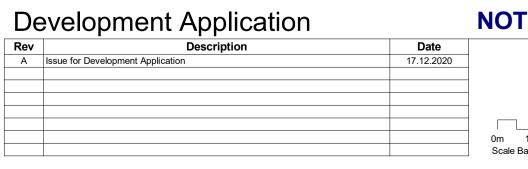
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-	DATE	December 2020	
	SCALE	A1 @	1 : 100
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DA.040 A










# **NOT For Construction**

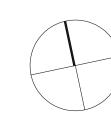

TITLE

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0m 1.5m 3m 4.5m 6m 7.5m Scale Bar 1:150

Area Schedule (Gross Building)				
Level	Name	Area		
Lower Ground	Lobby	19.96		
Ground	Administrative space	21.19		
Ground	Indoor space for child	76.10		
Level 1	Indoor space for child	194.64		
Level 1	Kitchen	17.14		
Level 1	Lobby	11.76		
Grand total: 6		340.79		

#### COMPLIANCE CALCULATION

11 Lewis Street Balgowlah Heights NSW 2093

Planning Instruments

Northern Beaches Council Manly LEP 2013 (Written Instrument + Maps)

SITE AREA

- Site Area : **781.8** m<sup>2</sup>
- Permissible GFA 0.45:1 **351.81m<sup>2</sup>** • Proposed GFA 0.43.5:1 340.79m<sup>2</sup>

LANDSCAPE/SITE COVERAGE CALCULATION

- 1. Open Space Area OS3
- Total Open Space 55% :
- Total Landscape Area 35% • Above ground landscape Area 40%

429.99m<sup>2</sup> 150.49m<sup>2</sup> 312.72m<sup>2</sup>

#### Site Coverage:

Means the proportion of a site area covered by buildings. However, the following are not included for the purpose of calculating site coverage: (a) any basement, (b) any part of an awning that is outside the outer walls of a building and that adjoins the street frontage or other site

boundary, (c) any eaves,

(d) unenclosed balconies, decks, pergolas and the like.

#### General Notes:

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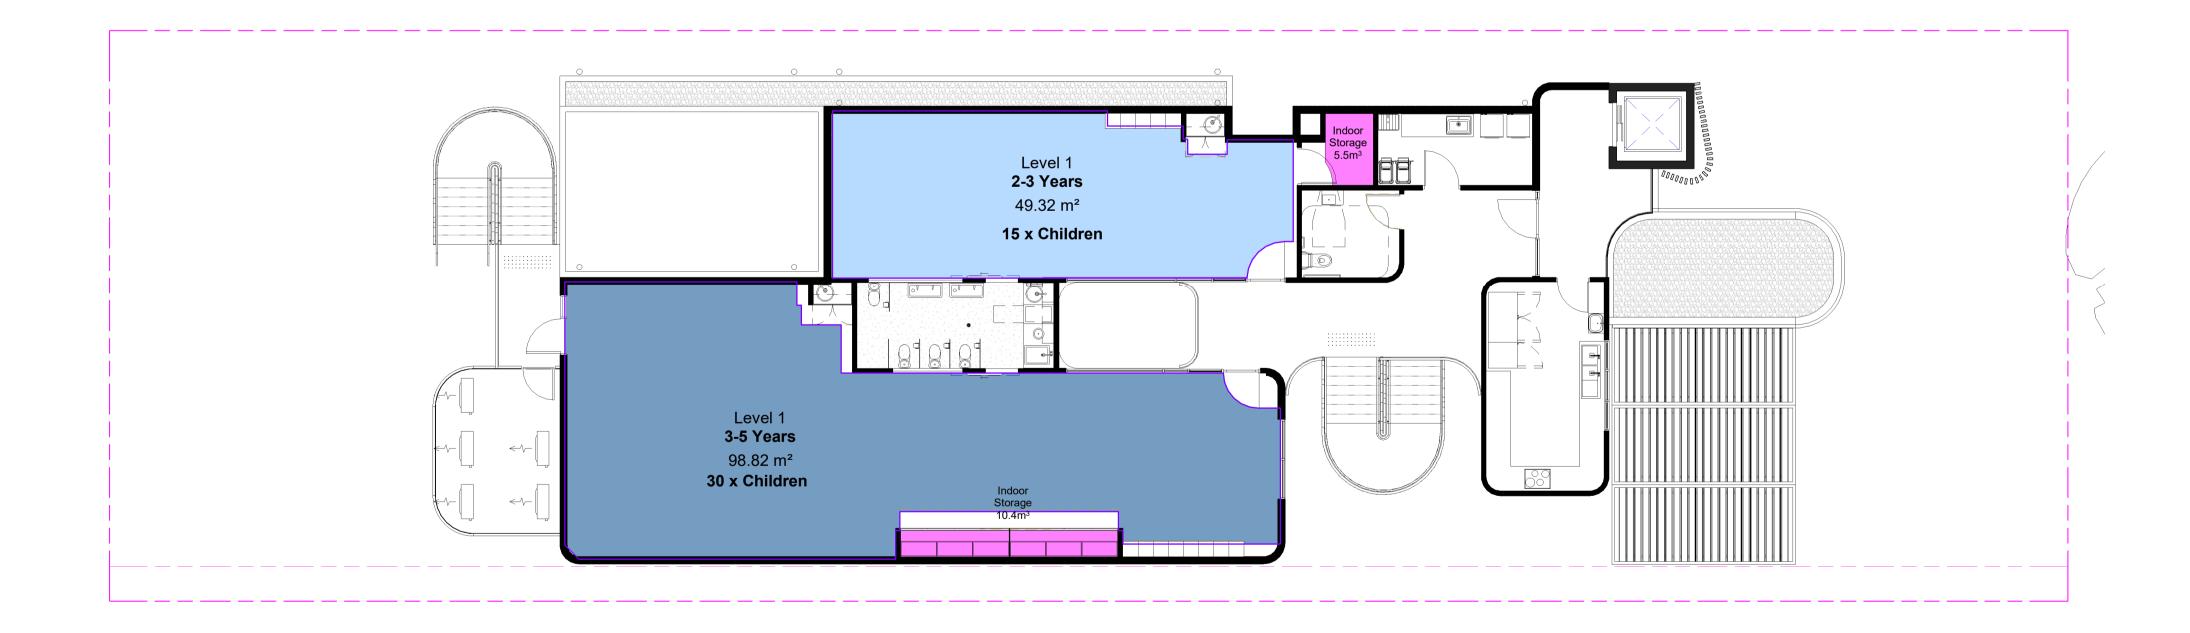
Detail Review Of Existing Footpath Levels All Dimensions to Be Verified On Site (VOS) Prior To

Construction / Manufacture. Refer All Discrepancies To Nordon Jago Architects Pty. Ltd. -

		DA.060 A
	DWG No.	
GFA	SCALE	A1 @ As indicated
	DATE	December 2020
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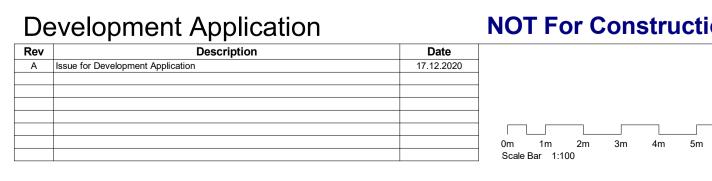






2 Proposed Level 1 1:100






LEVEL 4, 111-117 DEVONSHIRE STREET, SURRY HILLS, NSW 2010 T.02 9318 8400 F.02 9318 8480 STEPHEN J. NORDON Registration No. NSW - 4704 GRAHAM P. JAGO Registration No. NSW - 4926

# **NOT For Construction**

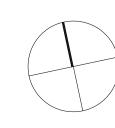10m

# DA Applicant : George Antoniou Site Address : Lot B DP 369977 11 Lewis Street Balgowlah Heights NSW 2093

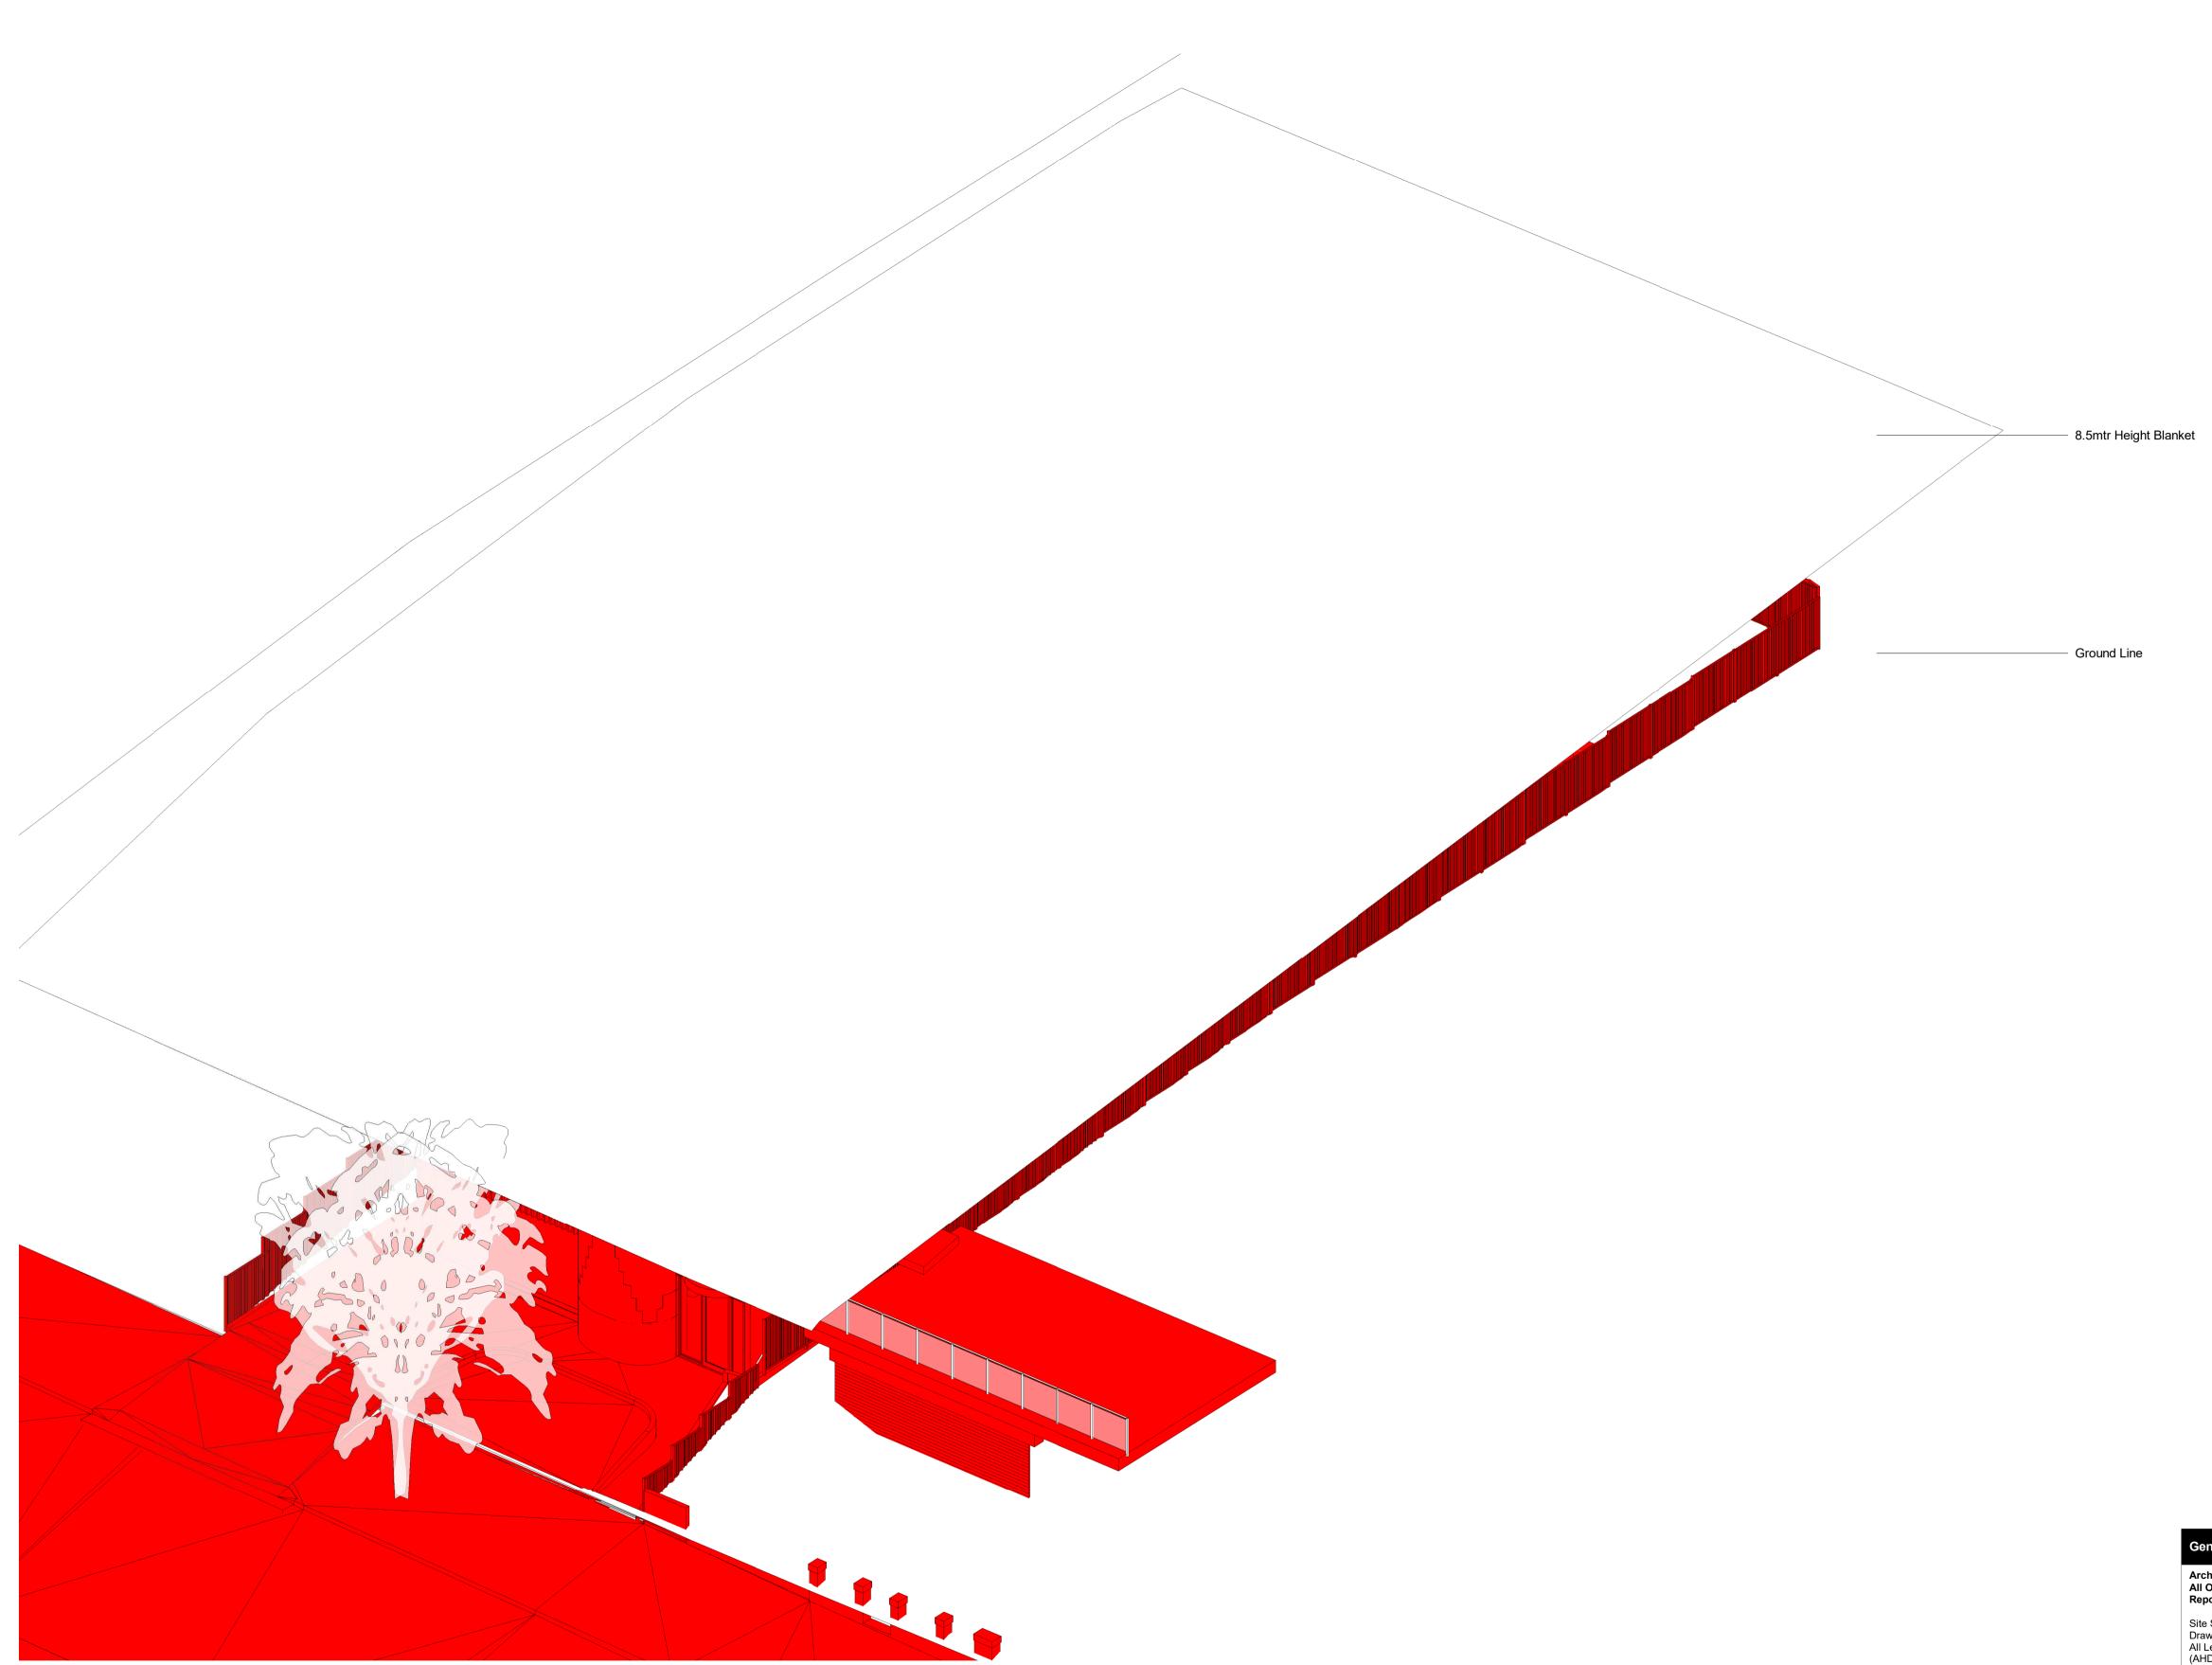


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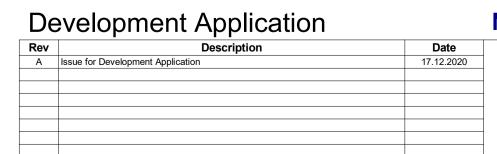
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Jnencur	nbered	Ext	ernal	Area
Level	Name		Ar	ea
Ground	0-5 Years Out	door	401.35	
Grand total	: 1		401.35	
Unencur	nherec	l Int	ernal	Area
Level	Name			rea
round	0-2 Years		39.64	]
evel 1 evel 1	2-3 Years 3-5 Years		49.32 98.82	
Grand total	: 3		187.78	3
Childcare				
Ground Floor				
Room 1 Room 2 Room 3	0 - 2 Yo 2 - 3 Yo 3 - 5 Yo	ears	15 :	x Children x Children x Children
Total	3-510	ears	30 .	x Children
			57 :	x Children
Indoor Spaces	$3.25m^2 =$	185.24	5 m² Require	ed
Proposed Indo		Total	187.78m² (	Comply
Outdoor Space		399 m	<sup>2</sup> Required	
Branaged Outd	loor Aroo	Total	401.35m <sup>2</sup>	Comply
Proposed Outd		TOLAI	401.35111-	Comply
Indoor and Ou Indoor: A minimum of 3 space* per chil is to be provided.	3.25m² of unen			
Outdoor: A minimum of t that				
is exclusively for * Unencumbered				
passage ways cot rooms, toile or any other fac for sleeping, st	or thoroughfare at or shower are cility such as c	es, door eas loca upboard:	swing areas ted within th	s, kitchen, e building
Indoor Storage				
57 Children X (	).2m <sup>3</sup> =	11.4 m	<sup>3</sup> Required	
Proposed Indo	or Storage	Total	18.6m³ Coi	mply
Outdoor Storag	je 📃			
57 Children X (	).3m <sup>3</sup> =	17.1 m	n <sup>3</sup> Required	
Proposed Outd	oor Storage	Total	18.8m³ C	omply
General No				
Architectural All Other Desi Reports And S	gn Consultan	ts Detail		
Site Survey Ca Drawing - Ref. All Levels Indic (AHD) Levels Prefixed Survey Informa Detail Review	<b>No: 20148_LE</b> cated Taken To d With *RL. Are ation, Final Lev	Date 0 Austral Interpre	6. <b>11.2020</b> ian Height D eted From E se Determine	atum xisting
All Dimensions Construction / Nordon Jago A	s to Be Verified Manufacture. I	l On Site Refer All	(VOS) Prio	

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	DATE	Decem	ber 2020
Unencumbered Area Plans	SCALE	A1 @	1 : 100
Unencumbered Area Plans			
		DA.06	1 A







**NOT For Construction** 

-TITLE

#### General Notes:

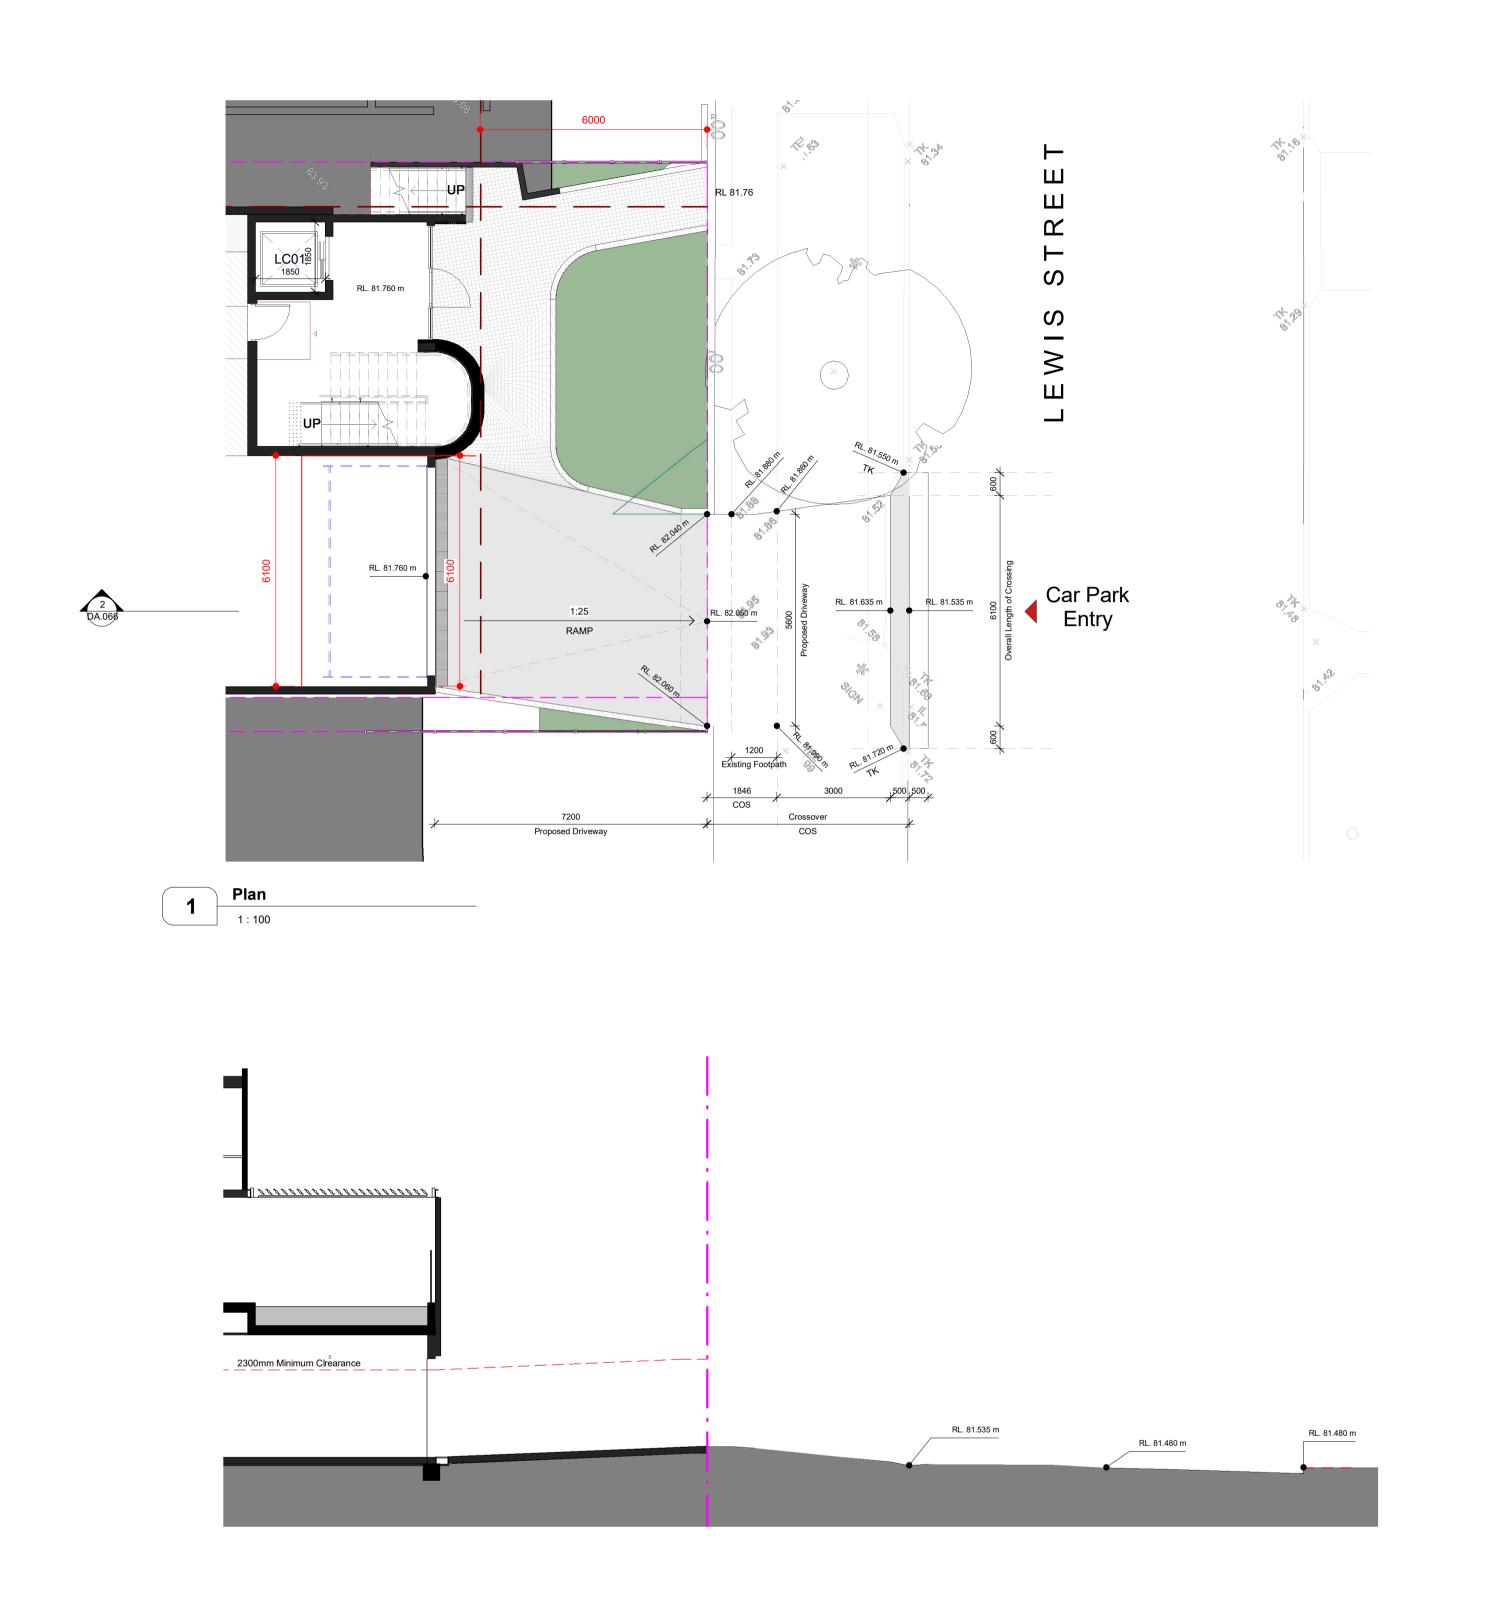
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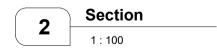
Site Survey Carried Out *Cibar Surveying* - Refer To Drawing - **Ref. No: 20148\_LD Date 06.11.2020** All Levels Indicated Taken To Australian Height Datum (AHD) Levels Prefixed With \*RL. Are Interpreted From Existing Survey Information, Final Levels To Be Determined On Detail Review Of Existing Footpath Levels

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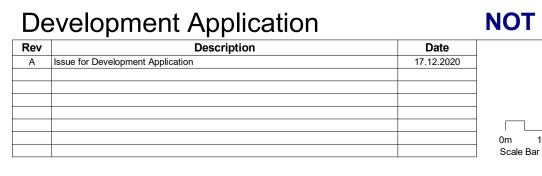
			<b>—</b> •
olonia rieigni Blanket	DWG No.		
8.5mtr Height Blanket	SCALE	A1 @	1 : 100
	DATE	Decemb	ber 2020
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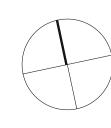






#### **NOT For Construction**

0m 1m 2m 3m 4m 5m Scale Bar 1:100 10m



TITLE

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#### General Notes:

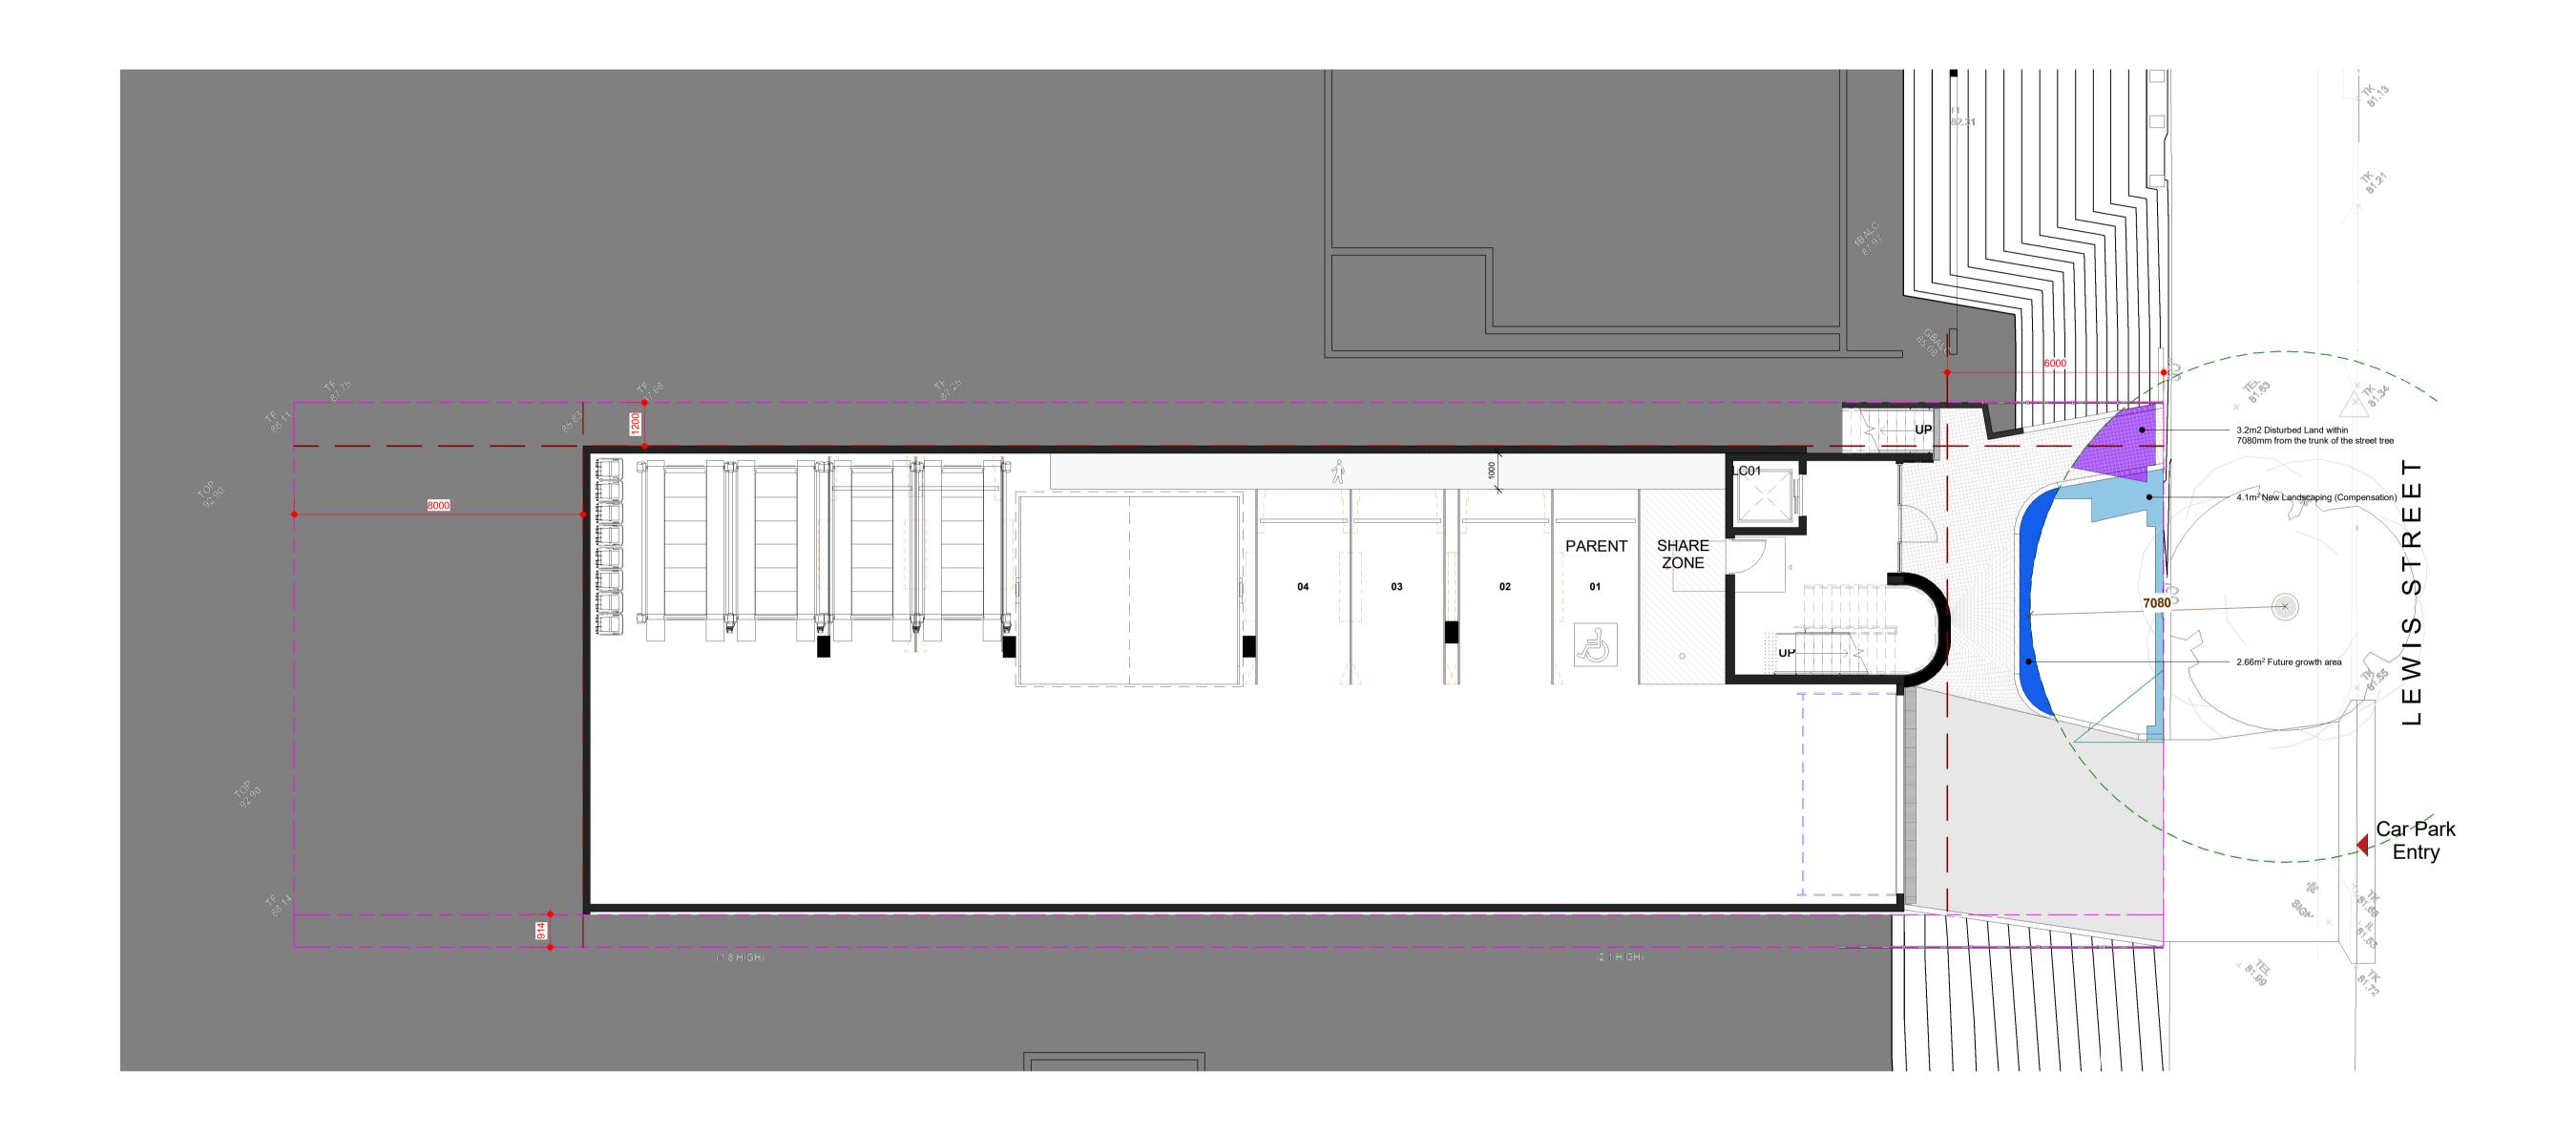
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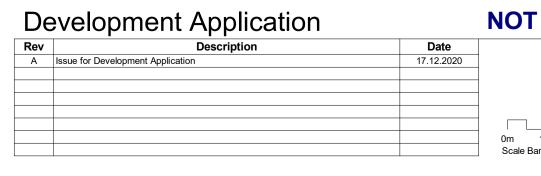
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D:\NJA Local Files\BVR00120 Lewis St\BVR00120 DA 201114 GT Local.rvt	JOB No.	E	BVR00120	
	DATE	December 2020		
Driveway Section	SCALE	A1 @	1 : 100	
D:\NJA Local Files\BVR00120 Lewis St\BVR00120 DA 201114 GT Local.rvt	DWG No.			










#### **NOT For Construction**

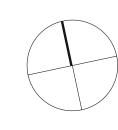

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0m 1m 2m 3m 4m 5m Scale Bar 1:100 10m

#### General Notes:

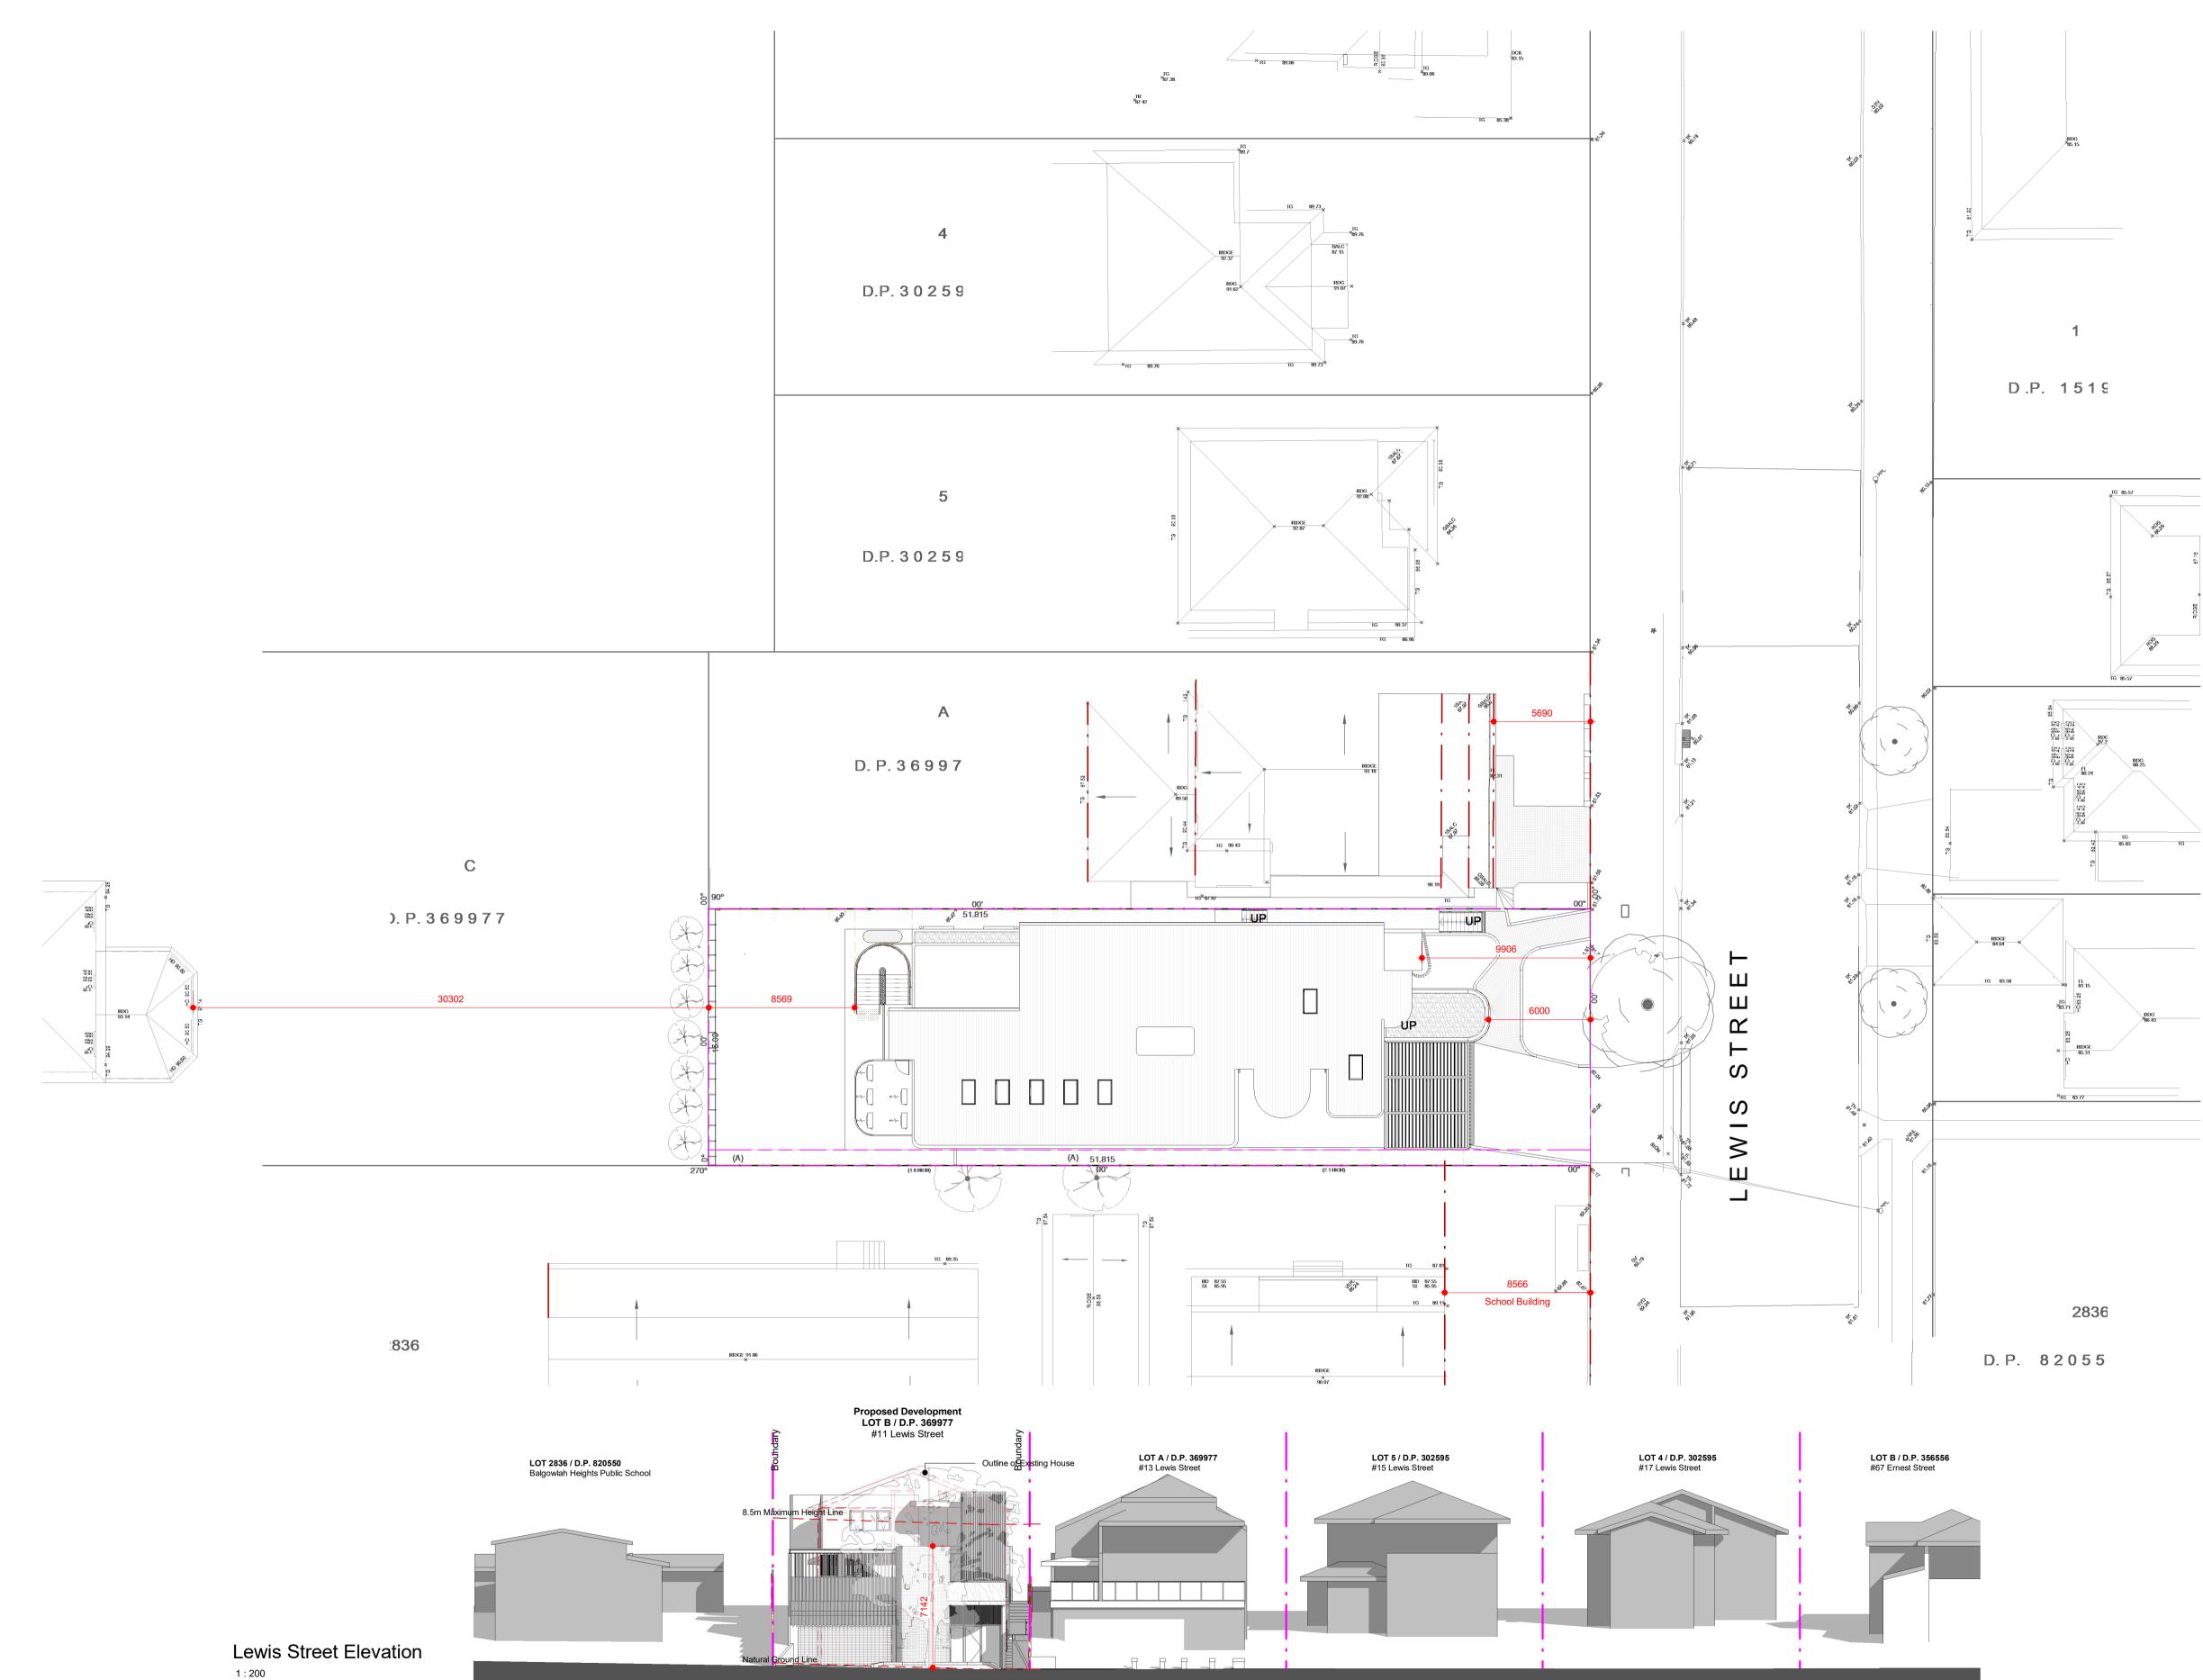
Architectural Drawings To Be Read In Conjunction With All Other Design Consultants Detailed Drawings, Reports And Specifications.

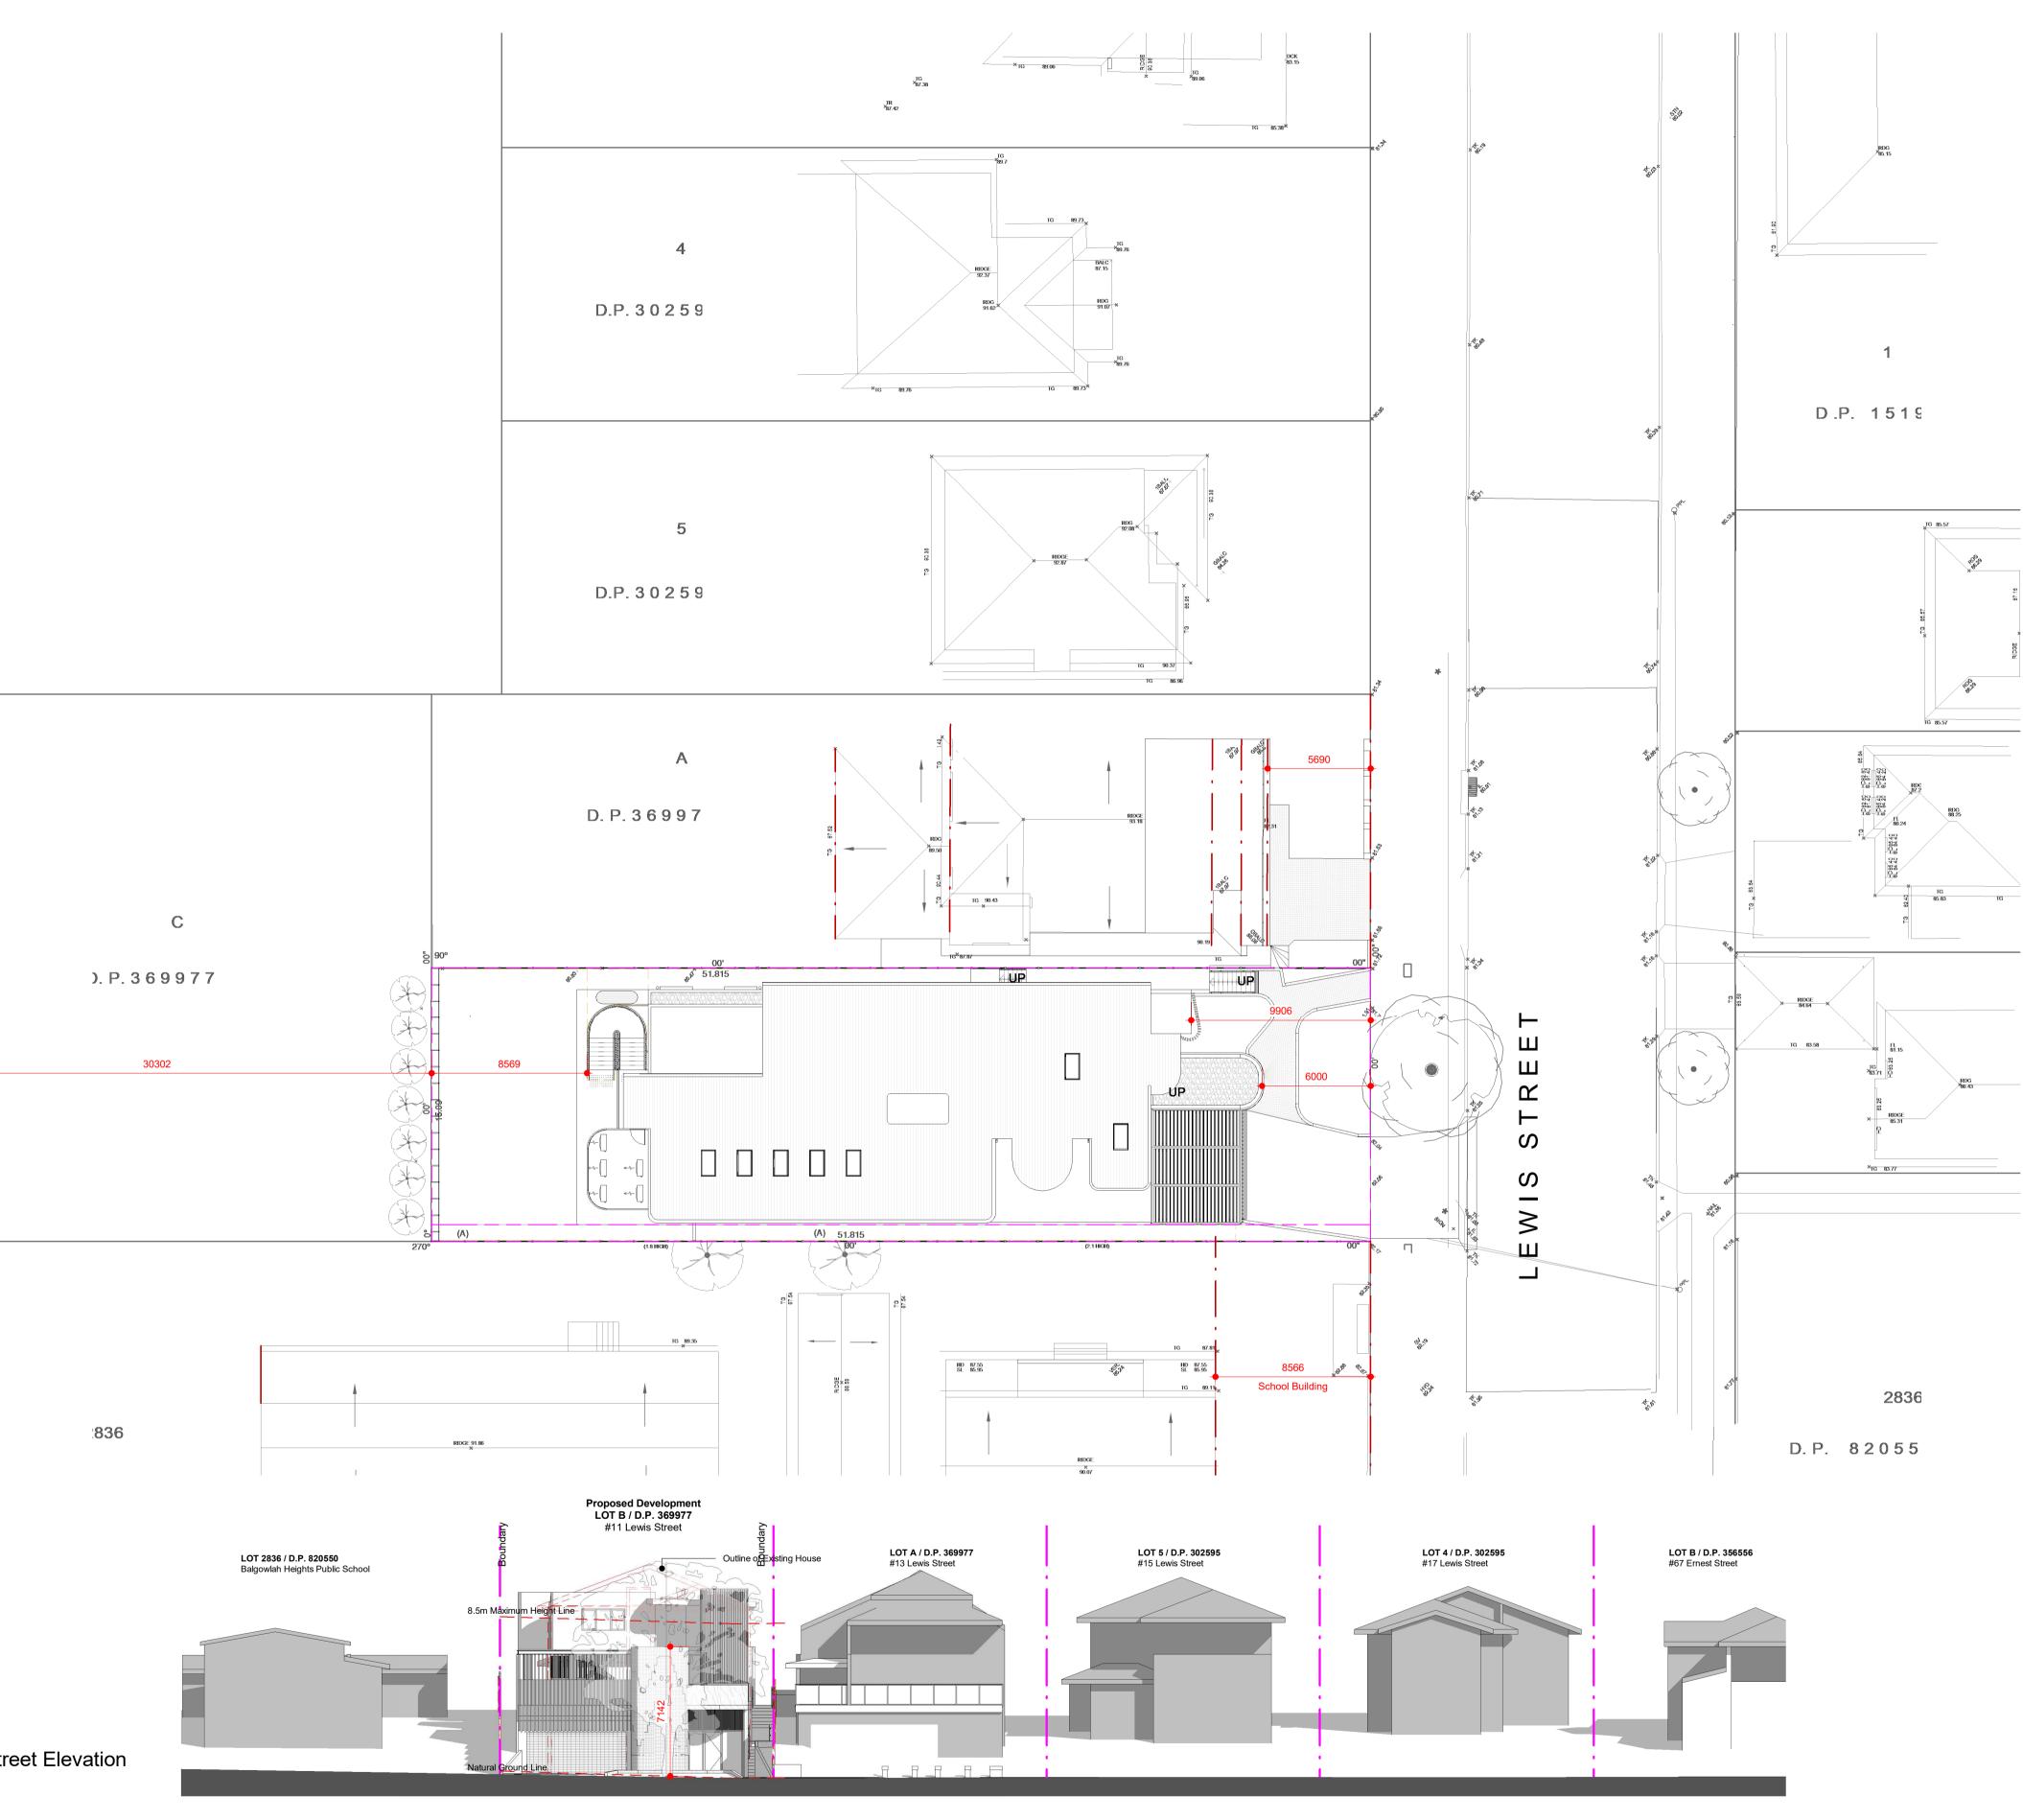
Site Survey Carried Out *Cibar Surveying* - Refer To Drawing - **Ref. No: 20148\_LD Date 06.11.2020** All Levels Indicated Taken To Australian Height Datum (AHD) Levels Prefixed With \*RL. Are Interpreted From Existing Survey Information, Final Levels To Be Determined On Detail Review Of Existing Footpath Levels

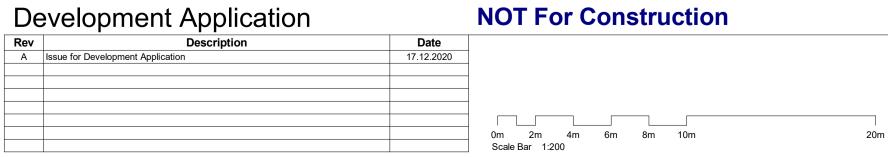
**All** Dimensions to Be Verified On Site (VOS) Prior To Construction / Manufacture. Refer All Discrepancies To Nordon Jago Architects Pty. Ltd. -

Tree Protection Plan	WG No.		
	CALE	A1 @	1 : 100
	ATE	Decem	ber 2020
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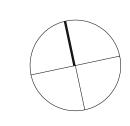






NORDON · JAGO A R C H I T E C T S

### DA Applicant : George Antoniou Site Address : Lot B DP 369977 11 Lewis Street Balgowlah Heights NSW 2093



Prevailing

TITLE

eneral Notes:	
rchitectural Drawings To Be Read In Conjunc I Other Design Consultants Detailed Drawing eports And Specifications.	
te Survey Carried Out <i>Cibar Surveying</i> - Refer T rawing - <b>Ref. No: 20148_LD Date 06.11.2020</b> I Levels Indicated Taken To Australian Height D. HD) evels Prefixed With *RL. Are Interpreted From Ex urvey Information, Final Levels To Be Determine etail Review Of Existing Footpath Levels I Dimensions to Be Verified On Site (VOS) Prior postruction / Manufacture. Refer All Discrepanci ordon Jago Architects Pty. Ltd	atum isting d On To

D:\NJA Local Files\BVR00120 Lewis St\BVR00120 DA 201114 GT Local.rvt	JOB No.	BVR00120
	DATE	December 2020
Building Line Plan and Elevation	SCALE	A1 @ As indicated
Dulluling Line Flatt and Lievation		



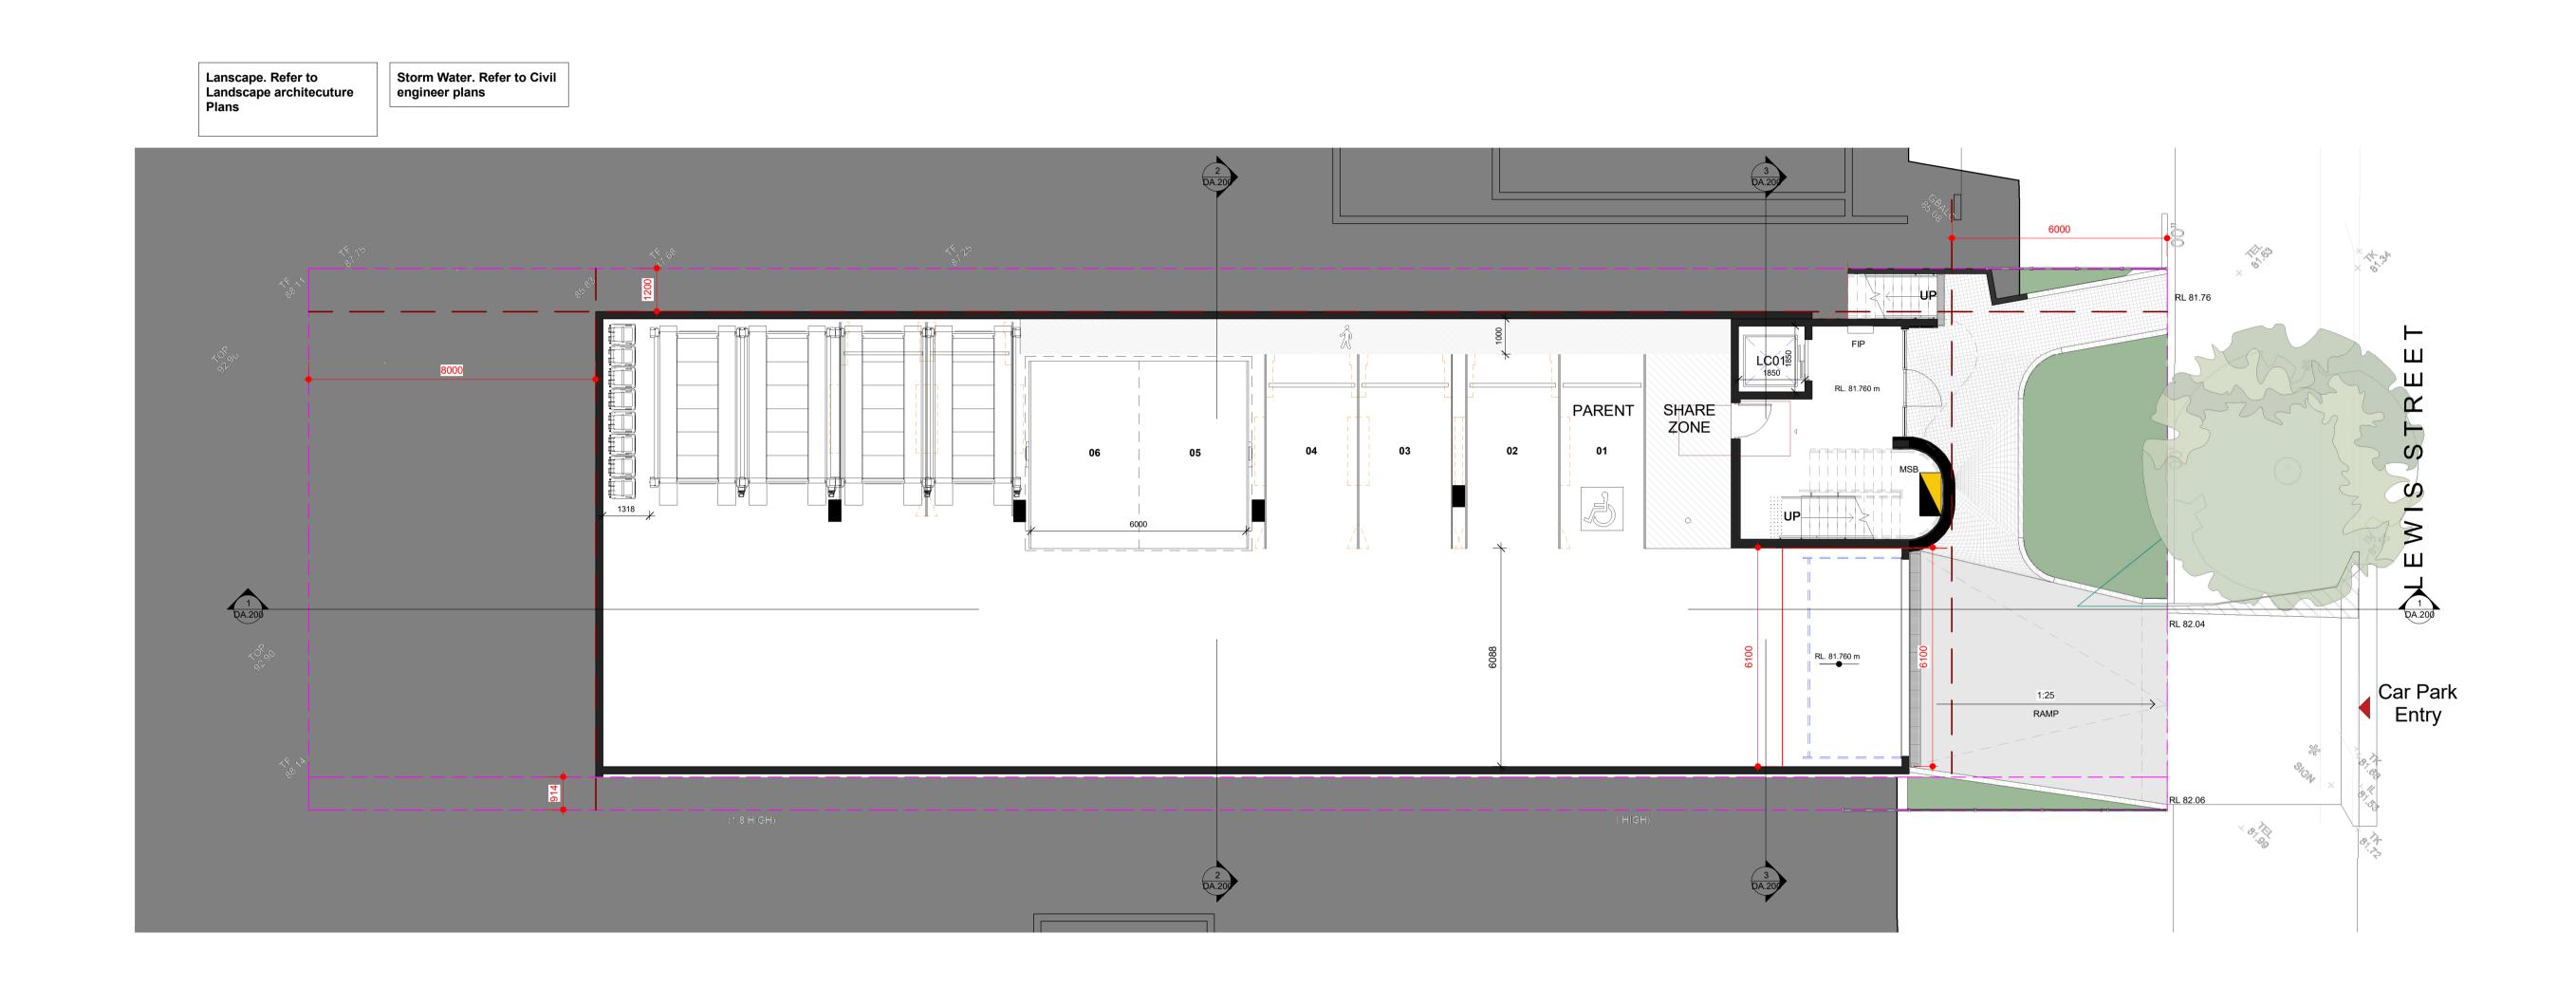


# Rev Description A Issue for Development Application **Date** 17.12.2020






LEVEL 4, 111-117 DEVONSHIRE STREET, SURRY HILLS, NSW 2010 T.02 9318 8400 F.02 9318 8480 STEPHEN J. NORDON Registration No. NSW - 4704 GRAHAM P. JAGO Registration No. NSW - 4926




#### **NOT For Construction**

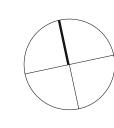

TITLE

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#### General Notes:

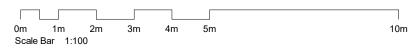
Architectural Drawings To Be Read In Conjunction With All Other Design Consultants Detailed Drawings, Reports And Specifications.

Site Survey Carried Out *Cibar Surveying* - Refer To Drawing - **Ref. No: 20148\_LD Date 06.11.2020** All Levels Indicated Taken To Australian Height Datum (AHD) Levels Prefixed With \*RL. Are Interpreted From Existing Survey Information, Final Levels To Be Determined On Detail Review Of Existing Footpath Levels


**All** Dimensions to Be Verified On Site (VOS) Prior To Construction / Manufacture. Refer All Discrepancies To Nordon Jago Architects Pty. Ltd. -

<u> </u>		
D:\NJA Local Files\BVR00120 Lewis St\BVR00120 DA 201114 GT Local.rvt	JOB No.	BVR00120
	DATE	December 2020
Proposed Lower Ground	SCALE	A1 @ 1 : 100
	DWG No.	



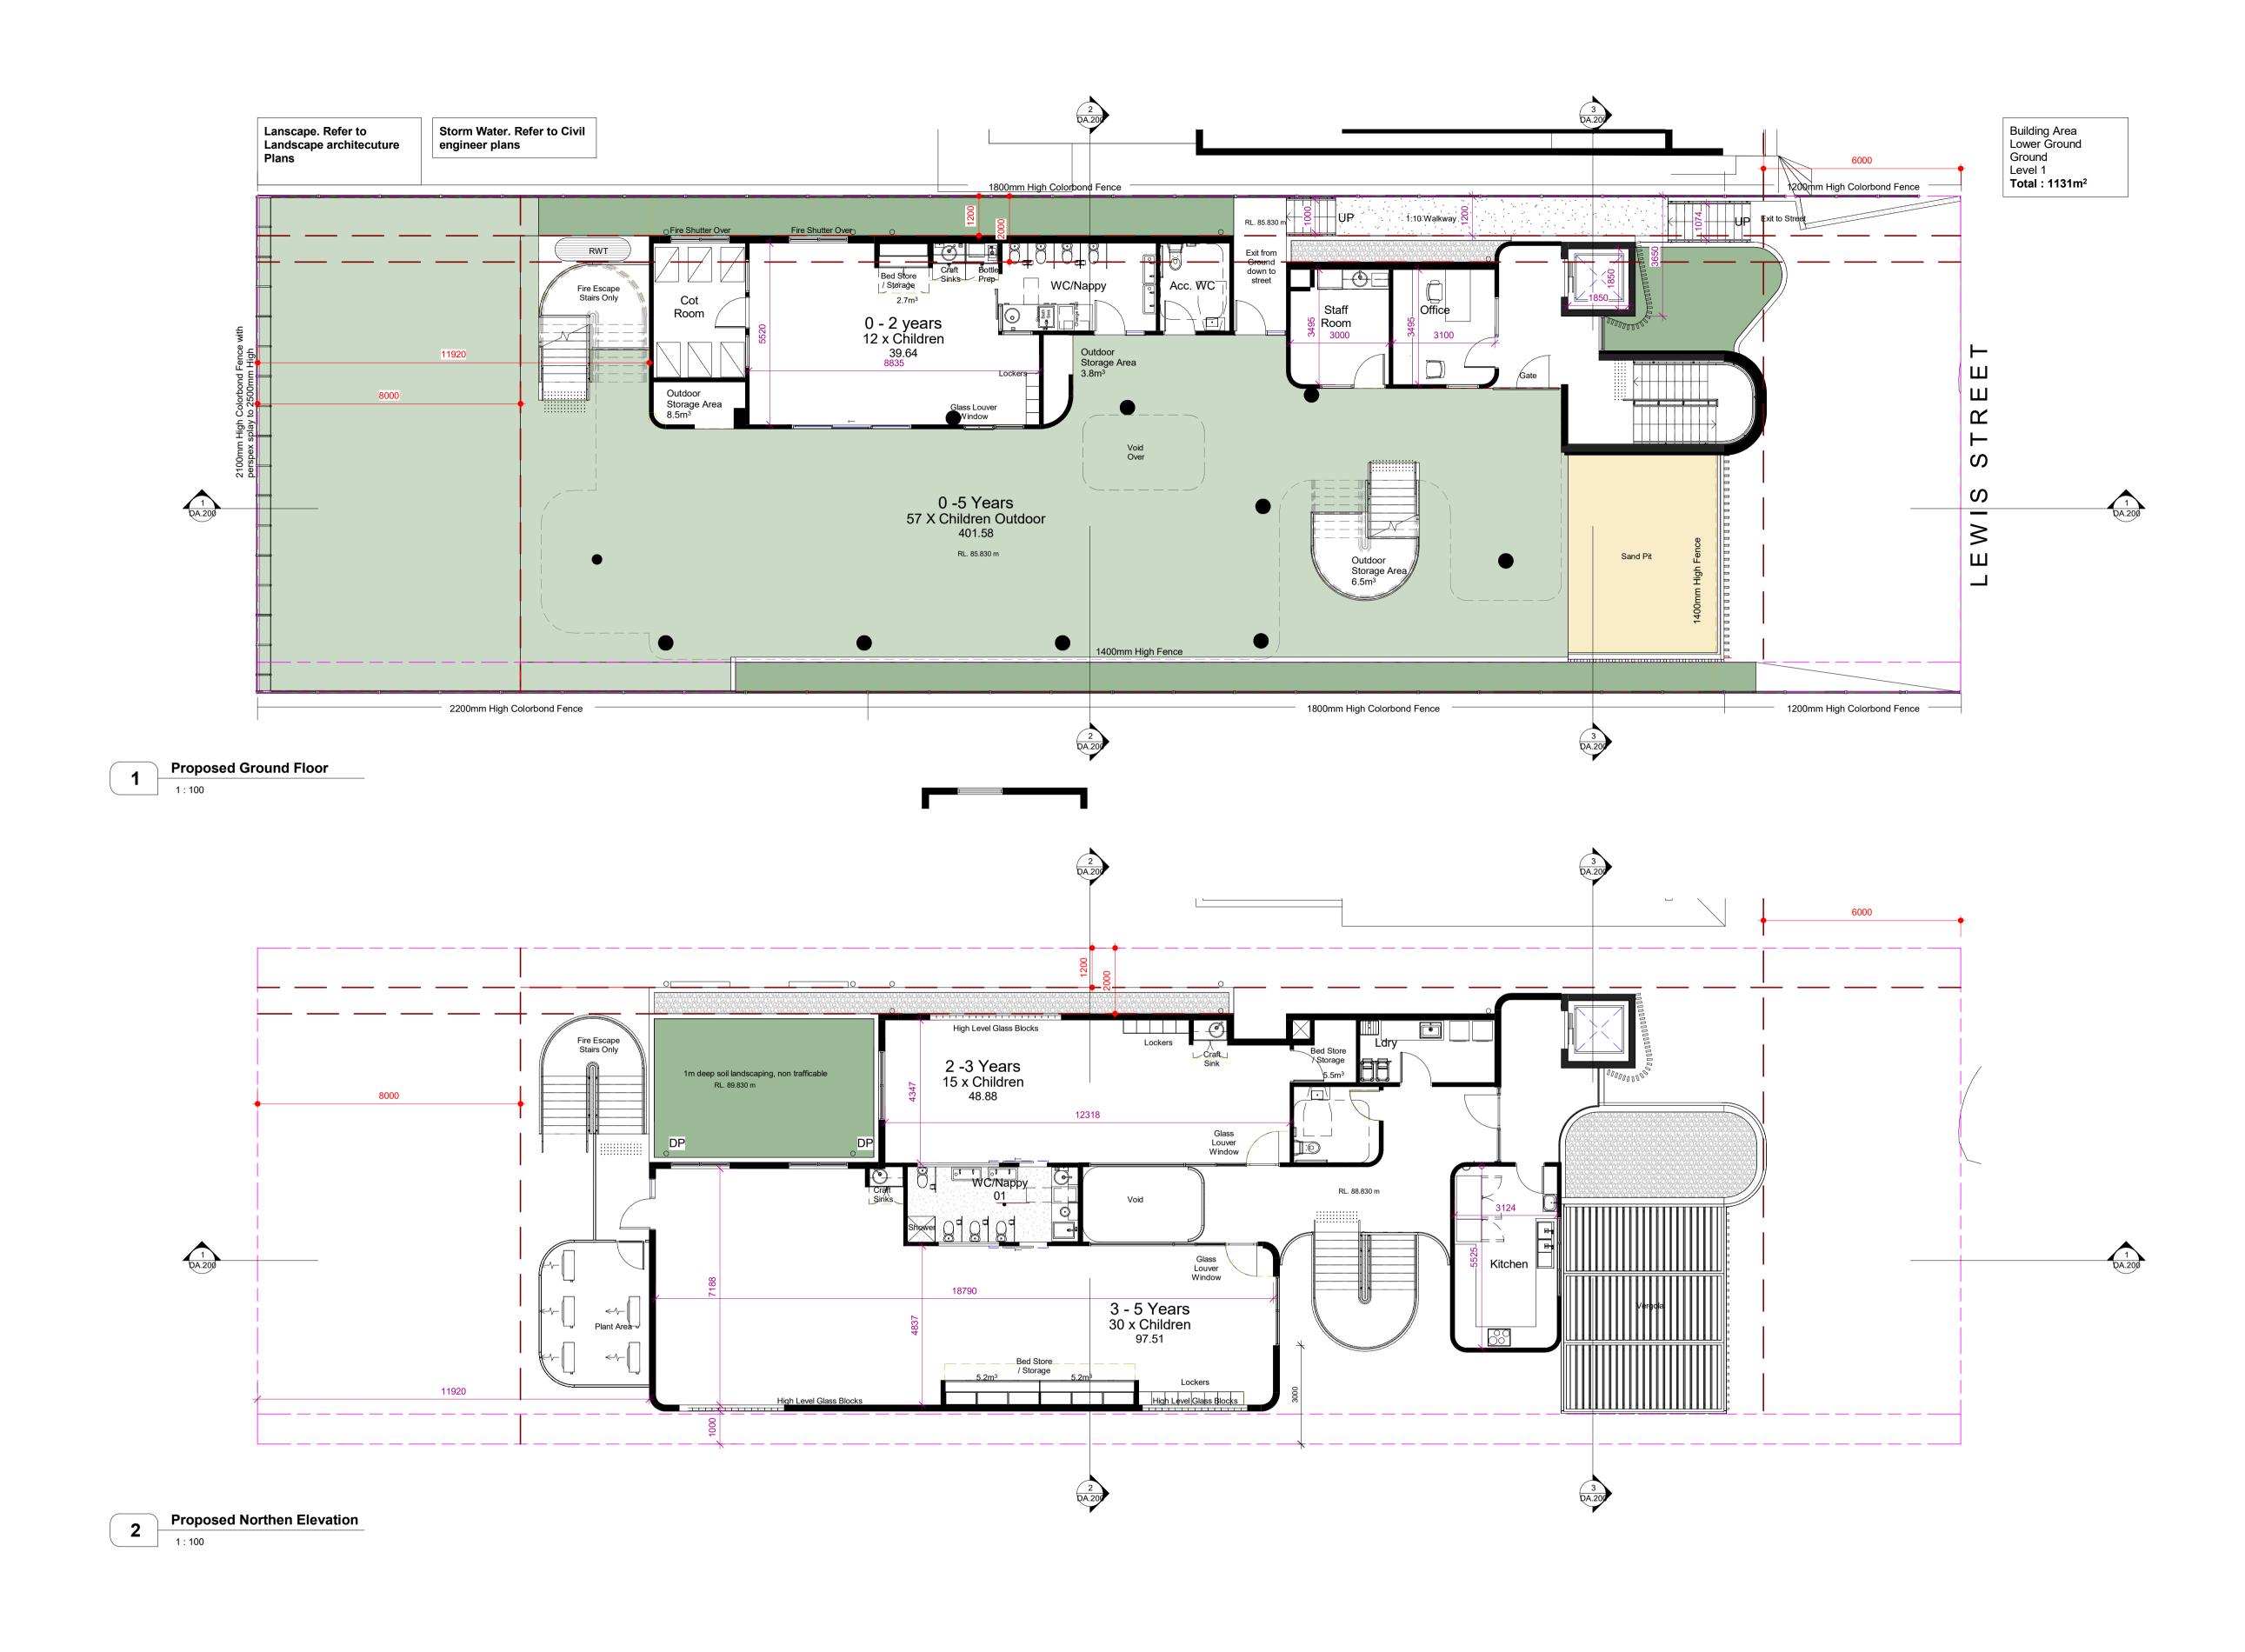

NORDON - JAGO

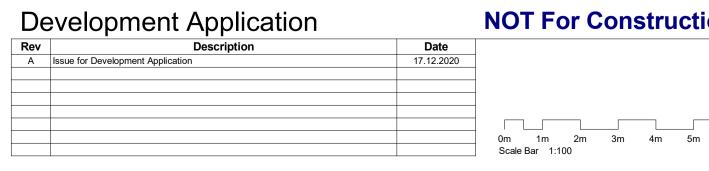


LEVEL 4, 111-117 DEVONSHIRE STREET, SURRY HILLS, NSW 2010 T.02 9318 8400 F.02 9318 8480 STEPHEN J. NORDON Registration No. NSW - 4704 GRAHAM P. JAGO Registration No. NSW - 4926

#### **NOT For Construction**

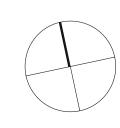10m

#### DA Applicant : George Antoniou Site Address : Lot B DP 369977 11 Lewis Street Balgowlah Heights NSW 2093



TITLE

-


#### **General Notes:**
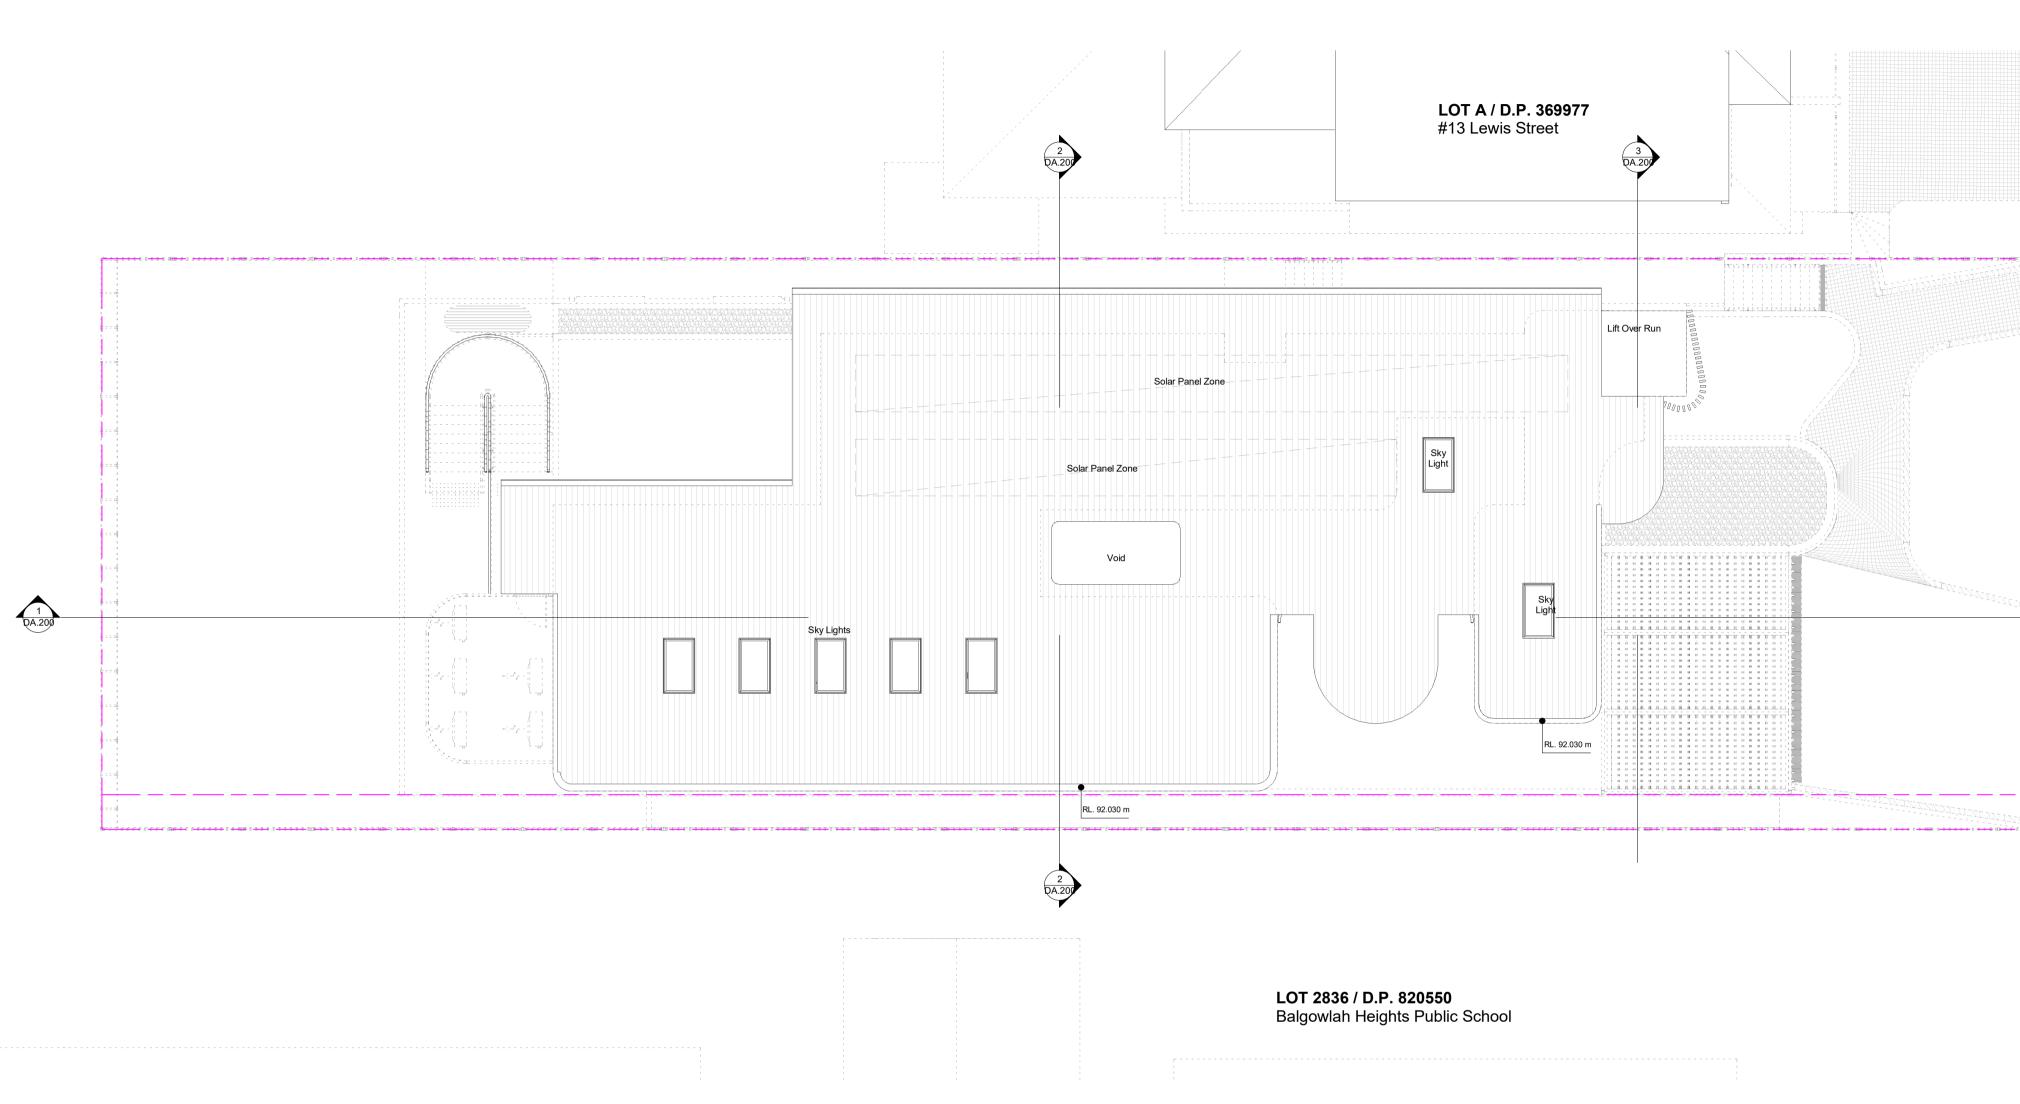
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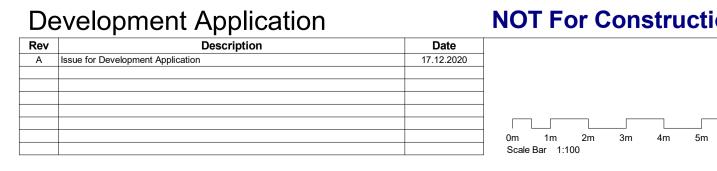
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D:\NJA Local Files\BVR00120 Lewis St\BVR00120 DA 201114 GT Local.rvt	JOB No.	В	VR00120
	DATE	December 2020	
Proposed Ground and Level 1 Plans	SCALE	A1 @	1 : 100
	DWG No.		
		DA.10	1 A









#### **NOT For Construction**

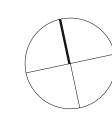10m



TITLE

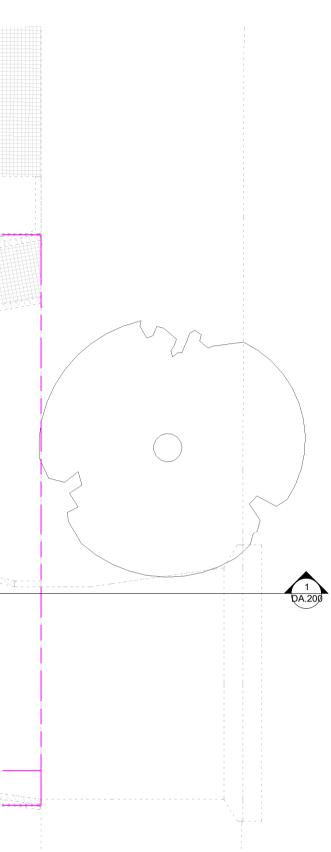\_\_\_\_\_



#### General Notes:

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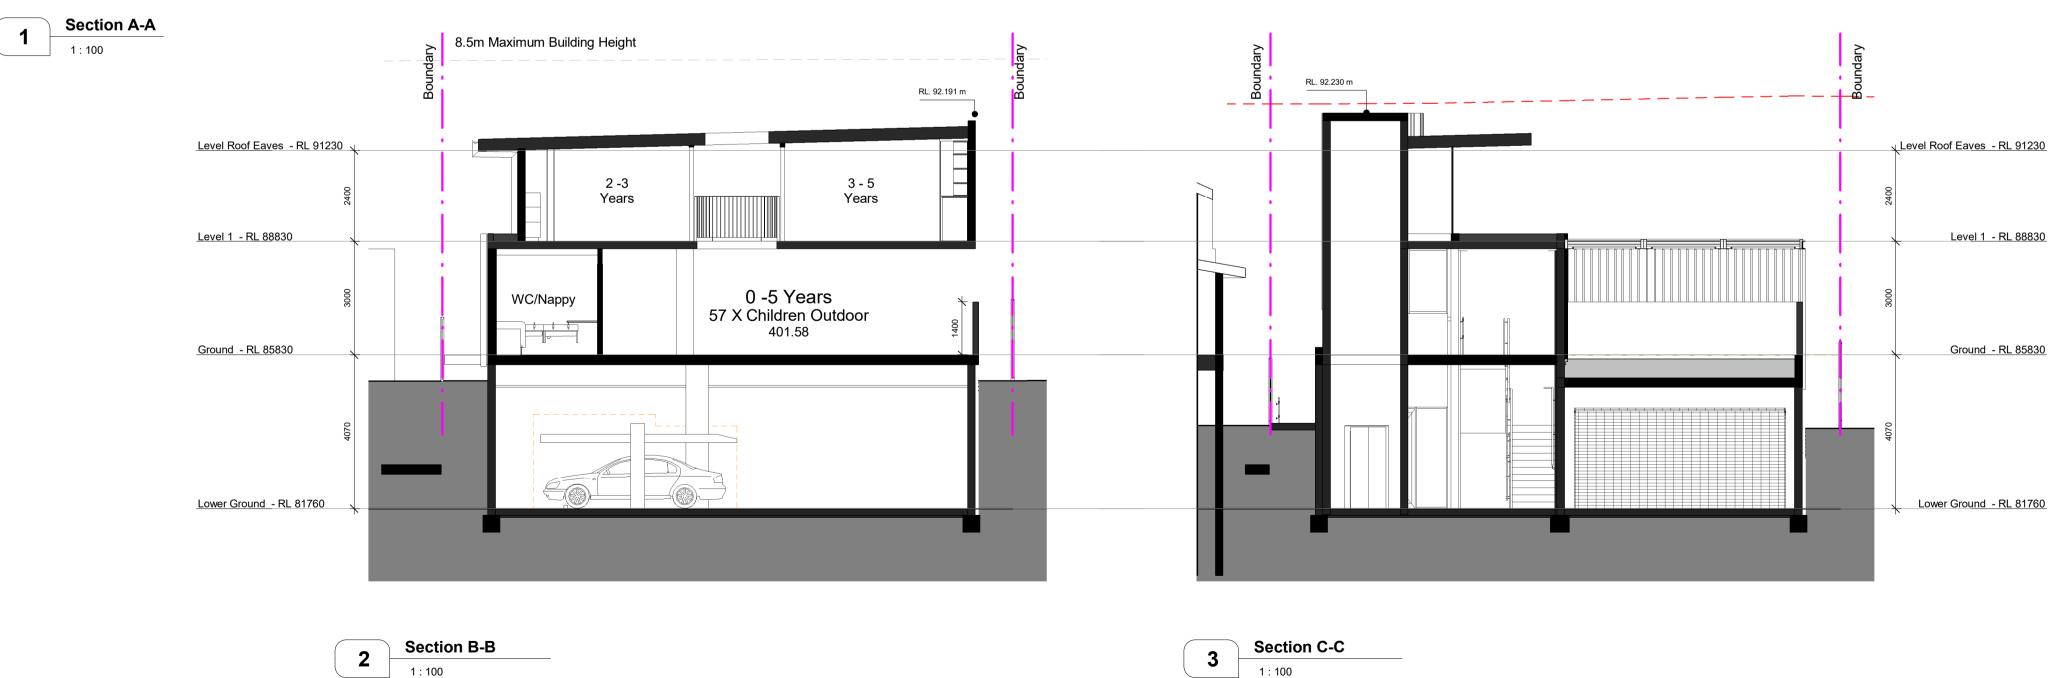
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#### DA Applicant : George Antoniou Site Address : Lot B DP 369977 11 Lewis Street Balgowlah Heights NSW 2093


			-
Proposed Root Plan	DWG No.		
	SCALE	A1 @ 1	: 100
	DATE	December	2020
D:\NJA Local Files\BVR00120 Lewis St\BVR00120 DA 201114 GT Local.rvt	JOB No.	BVR	00120

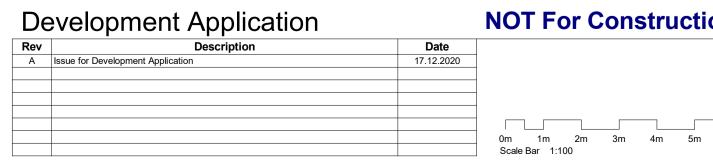DA.190 A










1 : 100

10m

# **NOT For Construction**

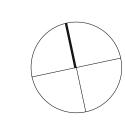

TITLE

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#### General Notes:


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D:\NJA Local Files\BVR00120 Lewis St\BVR00120 DA 201114 GT Local.rvt	JOB No.		BVR00120
	DATE	Decer	mber 2020
Proposed Sections	SCALE	A1 @	1 : 100
	DWG No.		







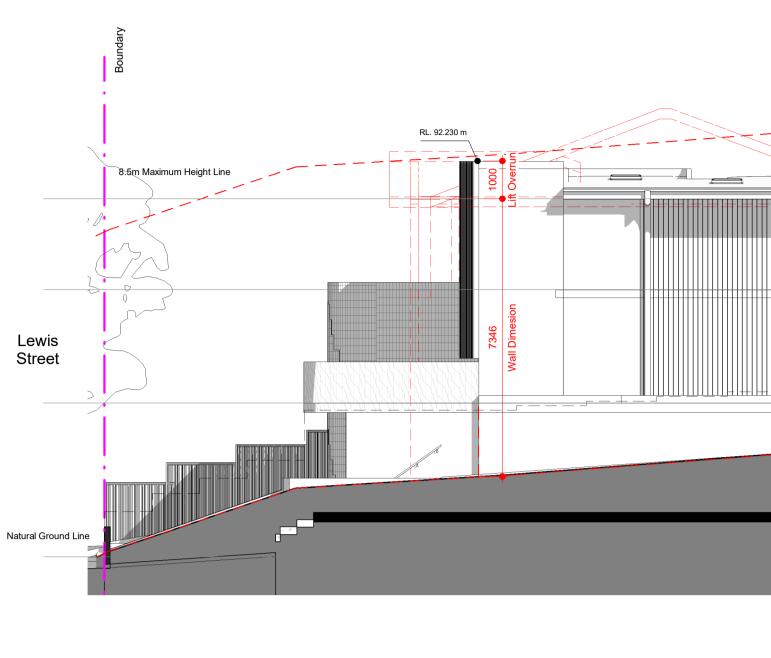

Proposed Southern Elevation

Proposed Northen Elevation



#### **Development Application** Rev

Rev	Description	Date
А	Issue for Development Application	17.12.2020

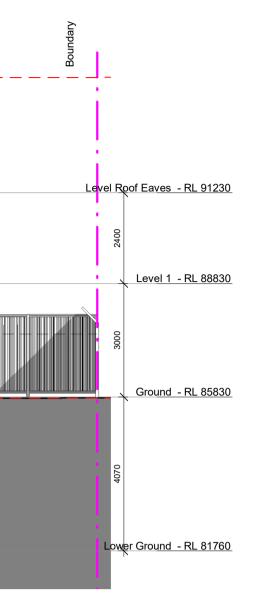
LEVEL 4, 111-117 DEVONSHIRE STREET, SURRY HILLS, NSW 2010 T.02 9318 8400 F.02 9318 8480 STEPHEN J. NORDON Registration No. NSW - 4704 GRAHAM P. JAGO Registration No. NSW - 4926

Glass Block Glazing	

# **NOT For Construction**

#### DA Applicant : George Antoniou Site Address : Lot B DP 369977 11 Lewis Street Balgowlah Heights NSW 2093

0m 1m 2m 3m 4m 5m Scale Bar 1:100 10m TITLE



#### General Notes:

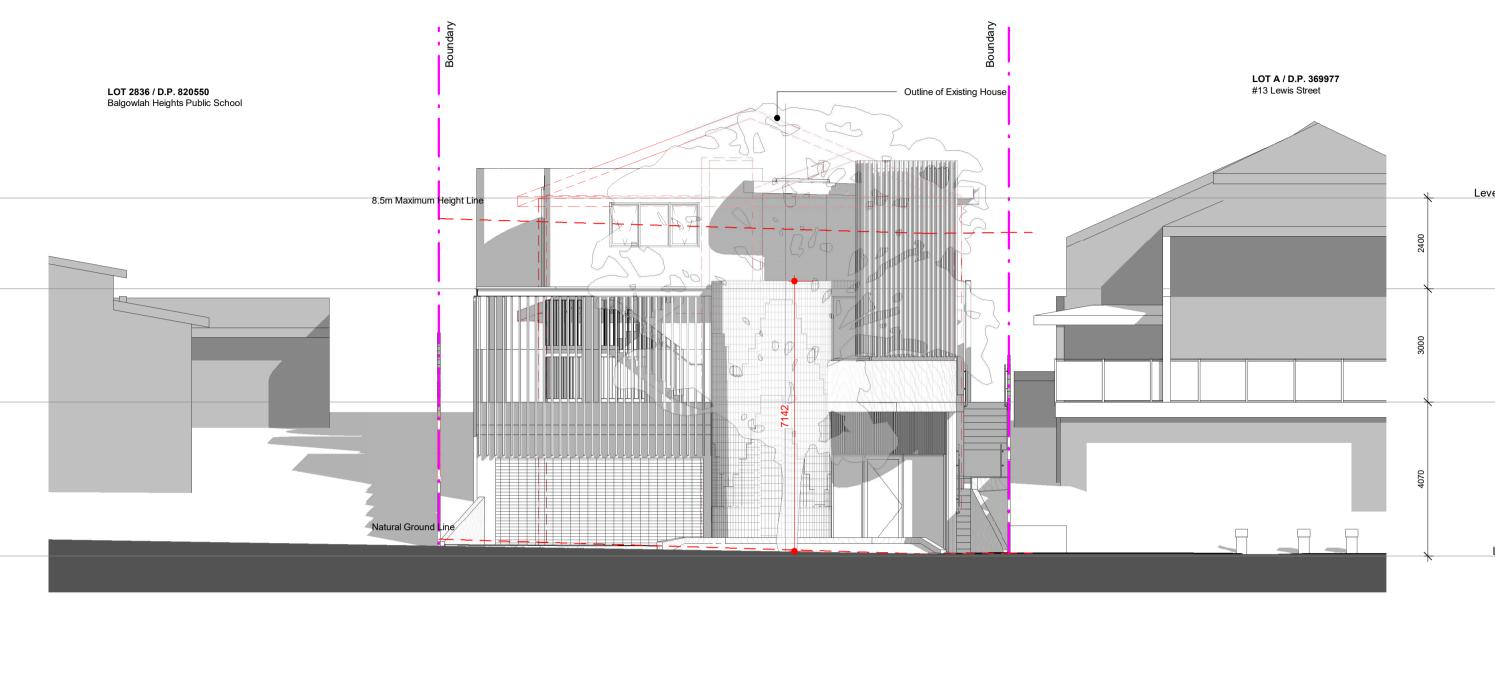
Architectural Drawings To Be Read In Conjunction With All Other Design Consultants Detailed Drawings, Reports And Specifications.


Site Survey Carried Out *Cibar Surveying* - Refer To Drawing - **Ref. No: 20148\_LD Date 06.11.2020** All Levels Indicated Taken To Australian Height Datum (AHD) Levels Prefixed With \*RL. Are Interpreted From Existing Survey Information, Final Levels To Be Determined On Detail Review Of Existing Footpath Levels


**All** Dimensions to Be Verified On Site (VOS) Prior To Construction / Manufacture. Refer All Discrepancies To Nordon Jago Architects Pty. Ltd. -


D:\NJA Local Files\BVR00120 Lewis St\BVR00120 DA 201114 GT Local.rvt	JOB No.	BVR	00120
	DATE	December	2020
Proposed Elevations	SCALE	A1 @ 1	: 100
	DWG No.		
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#### **Development Application**

Rev	Description	Date
А	Issue for Development Application	17.12.2020

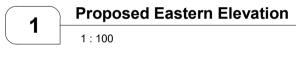LEVEL 4, 111-117 DEVONSHIRE STREET, SURRY HILLS, NSW 2010 T.02 9318 8400 F.02 9318 8480 STEPHEN J. NORDON Registration No. NSW - 4704 GRAHAM P. JAGO Registration No. NSW - 4926

#### **NOT For Construction**
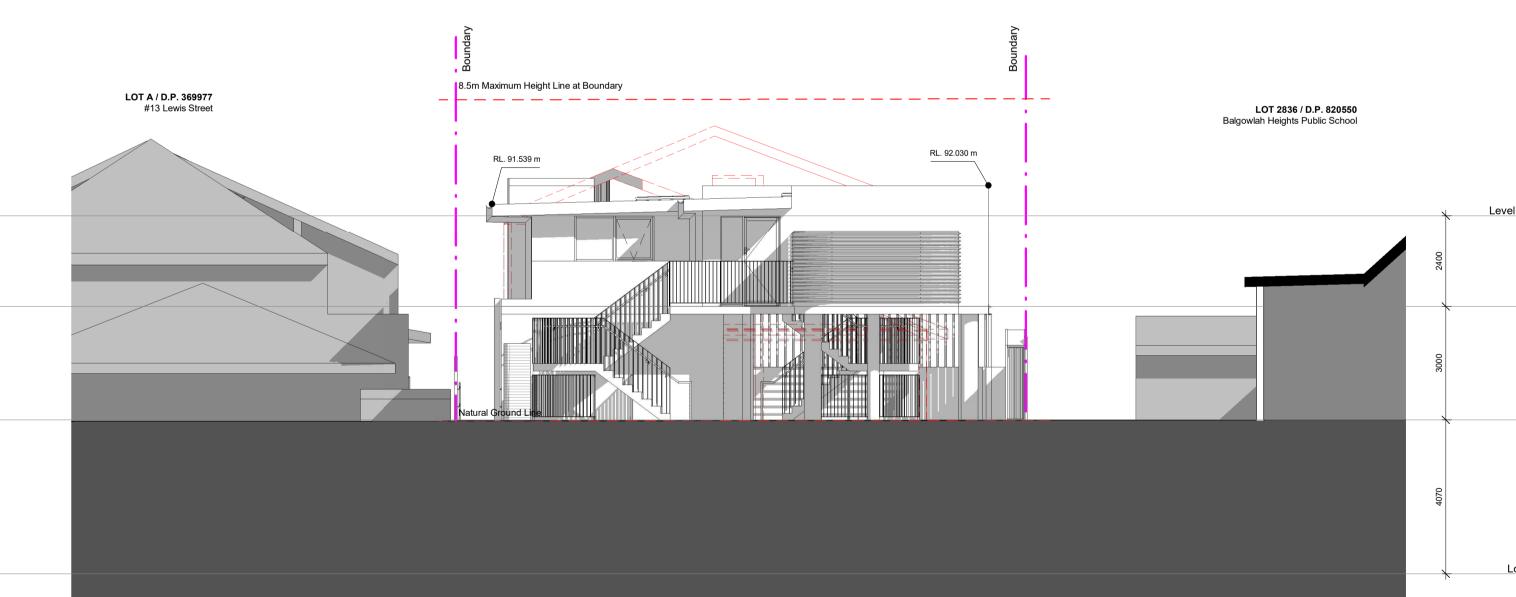
#### DA Applicant : George Antoniou Site Address : Lot B DP 369977 11 Lewis Street Balgowlah Heights NSW 2093

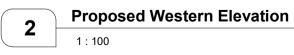0m 1m 2m 3m 4m 5m Scale Bar 1:100 10m \_\_\_\_\_ TITLE Level Roof Eaves - RL 91230

Level 1 - RL 88830

Ground - RL 85830

Lower Ground - RL 81760

Level Roof Eaves - RL 91230

Level 1 - RL 88830

Ground - RL 85830

Lower Ground - RL 81760

#### General Notes:

Architectural Drawings To Be Read In Conjunction With All Other Design Consultants Detailed Drawings, Reports And Specifications.

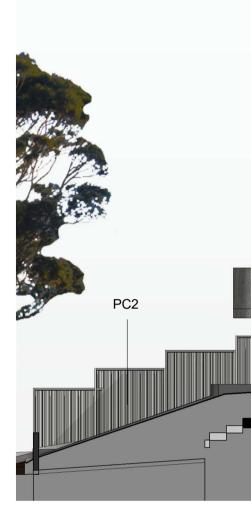
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D:\NJA Local Files\BVR00120 Lewis St\BVR00120 DA 201114 GT Local.rvt	JOB No.	BVR00120
	DATE	December 2020
Proposed Elevations	SCALE	A1 @ 1 : 100
	DWG No.	








Proposed Eastern Elevation 

2 Proposed Northen Elevation 1:100

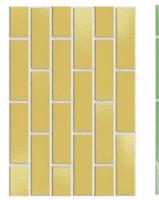MATERIAL PALETTE



FB1 :PGH : Corium Brick System

215 x 65 mm

7787E

Mortar col. white



FB2 :PGH :

215 x 65 mm

8104E

Mortar col. white

Corium Brick System




FB3 :PGH : **Corium Brick System** 215 x 65 mm Mortar col. white 41020E




WC1 :Wall Cladding James Hardie - Axon 133mm

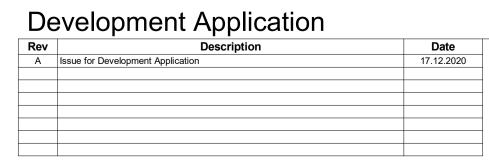
TC1 : Covet : Ever Art Wood Kabebari 50x100mm Colour : Pain





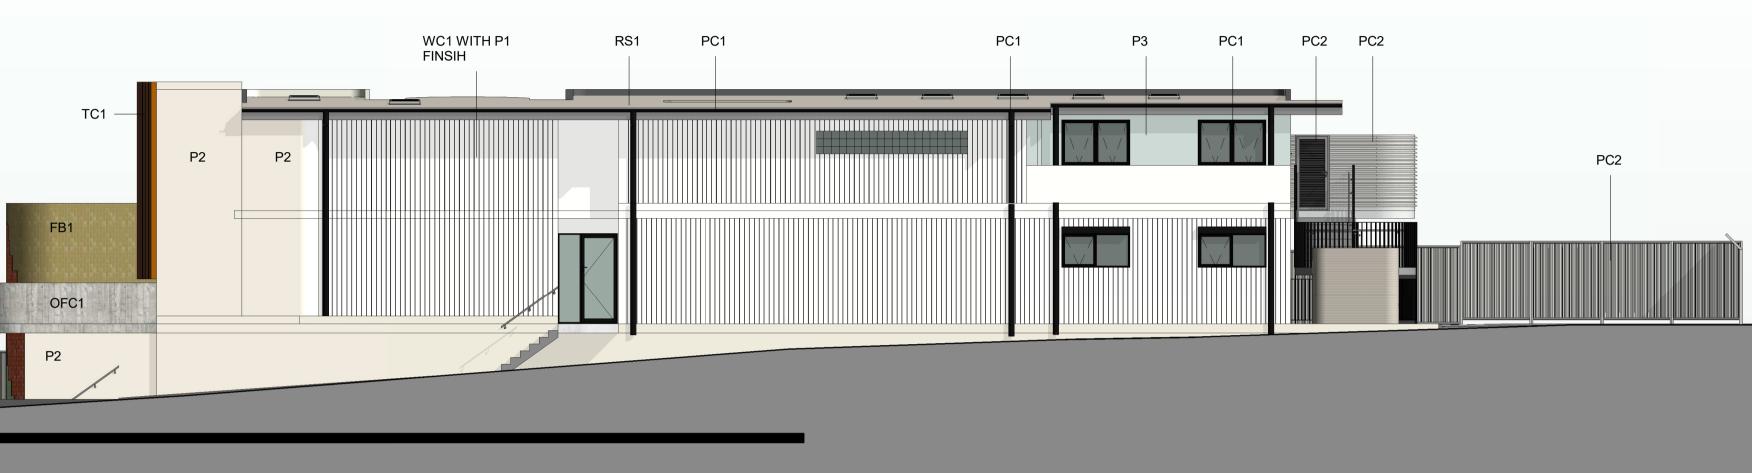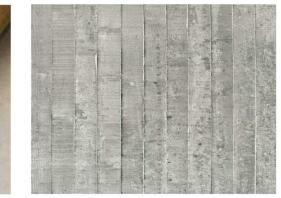LEVEL 4, 111-117 DEVONSHIRE STREET, SURRY HILLS, NSW 2010 T.02 9318 8400 F.02 9318 8480 STEPHEN J. NORDON Registration No. NSW - 4704 GRAHAM P. JAGO Registration No. NSW - 4926








**OFC1** : Off Form concrete with timber grain

RS1 : Lysaght Kliplok Colorbond Dune



PC1 : Prefinished Glazed Windows and Doors / Down Pipe/ Roller Door Frame Dulux Zeus Black PC2 : Prefinished Louvers, Colorbond fence, Vergola and PFC frames:

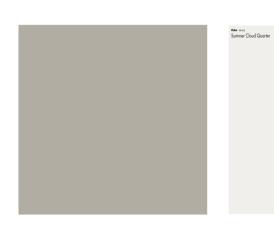Dulux Shale Grey



PC3 : Prefinished Roof Flashings

Dulux Colorbond Dune

**NOT For Construction** 

#### DA Applicant : George Antoniou Site Address : Lot B DP 369977 11 Lewis Street Balgowlah Heights NSW 2093

0m 1m 2m 3m 4m 5m 10m Scale Bar 1:100

-----TITLE



P1 : Paint finish to WC1 and acrylic render to FC: Dulux Summer Cloud Quarter



P2 :Paint finish to Concrete walls acrylic render to FC : Dulux Natural White



P3 : Paint finish to acrylic render to Dulux Roland

#### General Notes:

Architectural Drawings To Be Read In Conjunction With All Other Design Consultants Detailed Drawings, Reports And Specifications.

Site Survey Carried Out *Cibar Surveying* - Refer To Drawing - **Ref. No: 20148\_LD Date 06.11.2020** All Levels Indicated Taken To Australian Height Datum (AHD) (AHD) Levels Prefixed With \*RL. Are Interpreted From Existing Survey Information, Final Levels To Be Determined On Detail Review Of Existing Footpath Levels **All** Dimensions to Be Verified On Site (VOS) Prior To Construction / Manufacture. Refer All Discrepancies To Nordon Jago Architects Pty. Ltd. -

D:\NJA Local Files\BVR00120 Lewis St\BVR00120 DA 201114 GT Local.rvt	JOB No.	BVR00120
	DATE	December 2020
Proposed Finishes - Sheet 1	SCALE	A1 @ As indicated
	DWG No.	
		DA.900 A



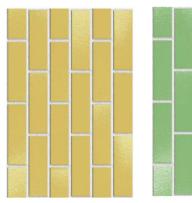


2 Proposed Southern Elevation

MATERIAL PALETTE

1 : 100

1 |-



Proposed Western Elevation

FB2 :PGH :


8104E

215 x 65 mm

Mortar col. white

**Corium Brick System** 

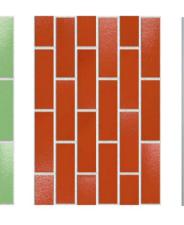FB1 :PGH : Corium Brick System 215 x 65 mm Mortar col. white 7787E



FB3 :PGH : Corium Brick System 215 x 65 mm Mortar col. white 41020E




WC1 :Wall Cladding James Hardie - Axon 133mm



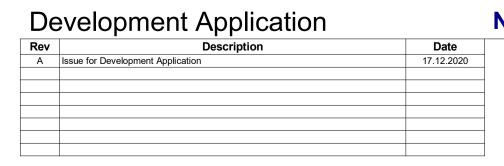TC1 : Covet : Ever Art Wood Kabebari 50x100mm Colour : Pain






LEVEL 4, 111-117 DEVONSHIRE STREET, SURRY HILLS, NSW 2010 T.02 9318 8400 F.02 9318 8480 STEPHEN J. NORDON Registration No. NSW - 4704 GRAHAM P. JAGO Registration No. NSW - 4926



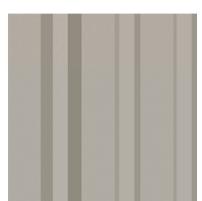OFC1 : Off Form concrete with timber grain



**RS1** : Lysaght Kliplok Colorbond Dune



PC1 : Prefinished Glazed Windows and Doors / Down Pipe/ Roller Door Frame Dulux Zeus Black



PC2 : Prefinished Louvers, Colorbond fence, Vergola and PFC frames: Dulux Shale Grey

PC3 : Prefinished Roof Flashings Dulux Colorbond Dune


#### **NOT For Construction**
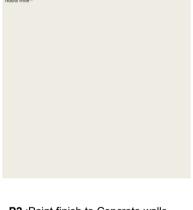
#### DA Applicant : George Antoniou Site Address : Lot B DP 369977 11 Lewis Street Balgowlah Heights NSW 2093

-----TITLE Summer Cloud Quarter

P1 : Paint finish to WC1 and acrylic render to FC: Dulux Summer Cloud Quarter

#### Natural White<sup>TM</sup>



P2 :Paint finish to Concrete walls acrylic render to FC : Dulux Natural White

P3 : Paint finish to acrylic render to Dulux Roland


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D:\NJA Local Files\BVR00120 Lewis St\BVR00120 DA 201114 GT Local.rvt	JOB No.	BVR00120
	DATE	December 2020
Proposed Finishes - Sheet 2	SCALE	A1 @ As indicated
roposed rimsnes cheerz	DWG No.	
		DA.901 A





evelopment Application					
Description	Date				
Issue for Development Application	17.12.2020				
	Description				



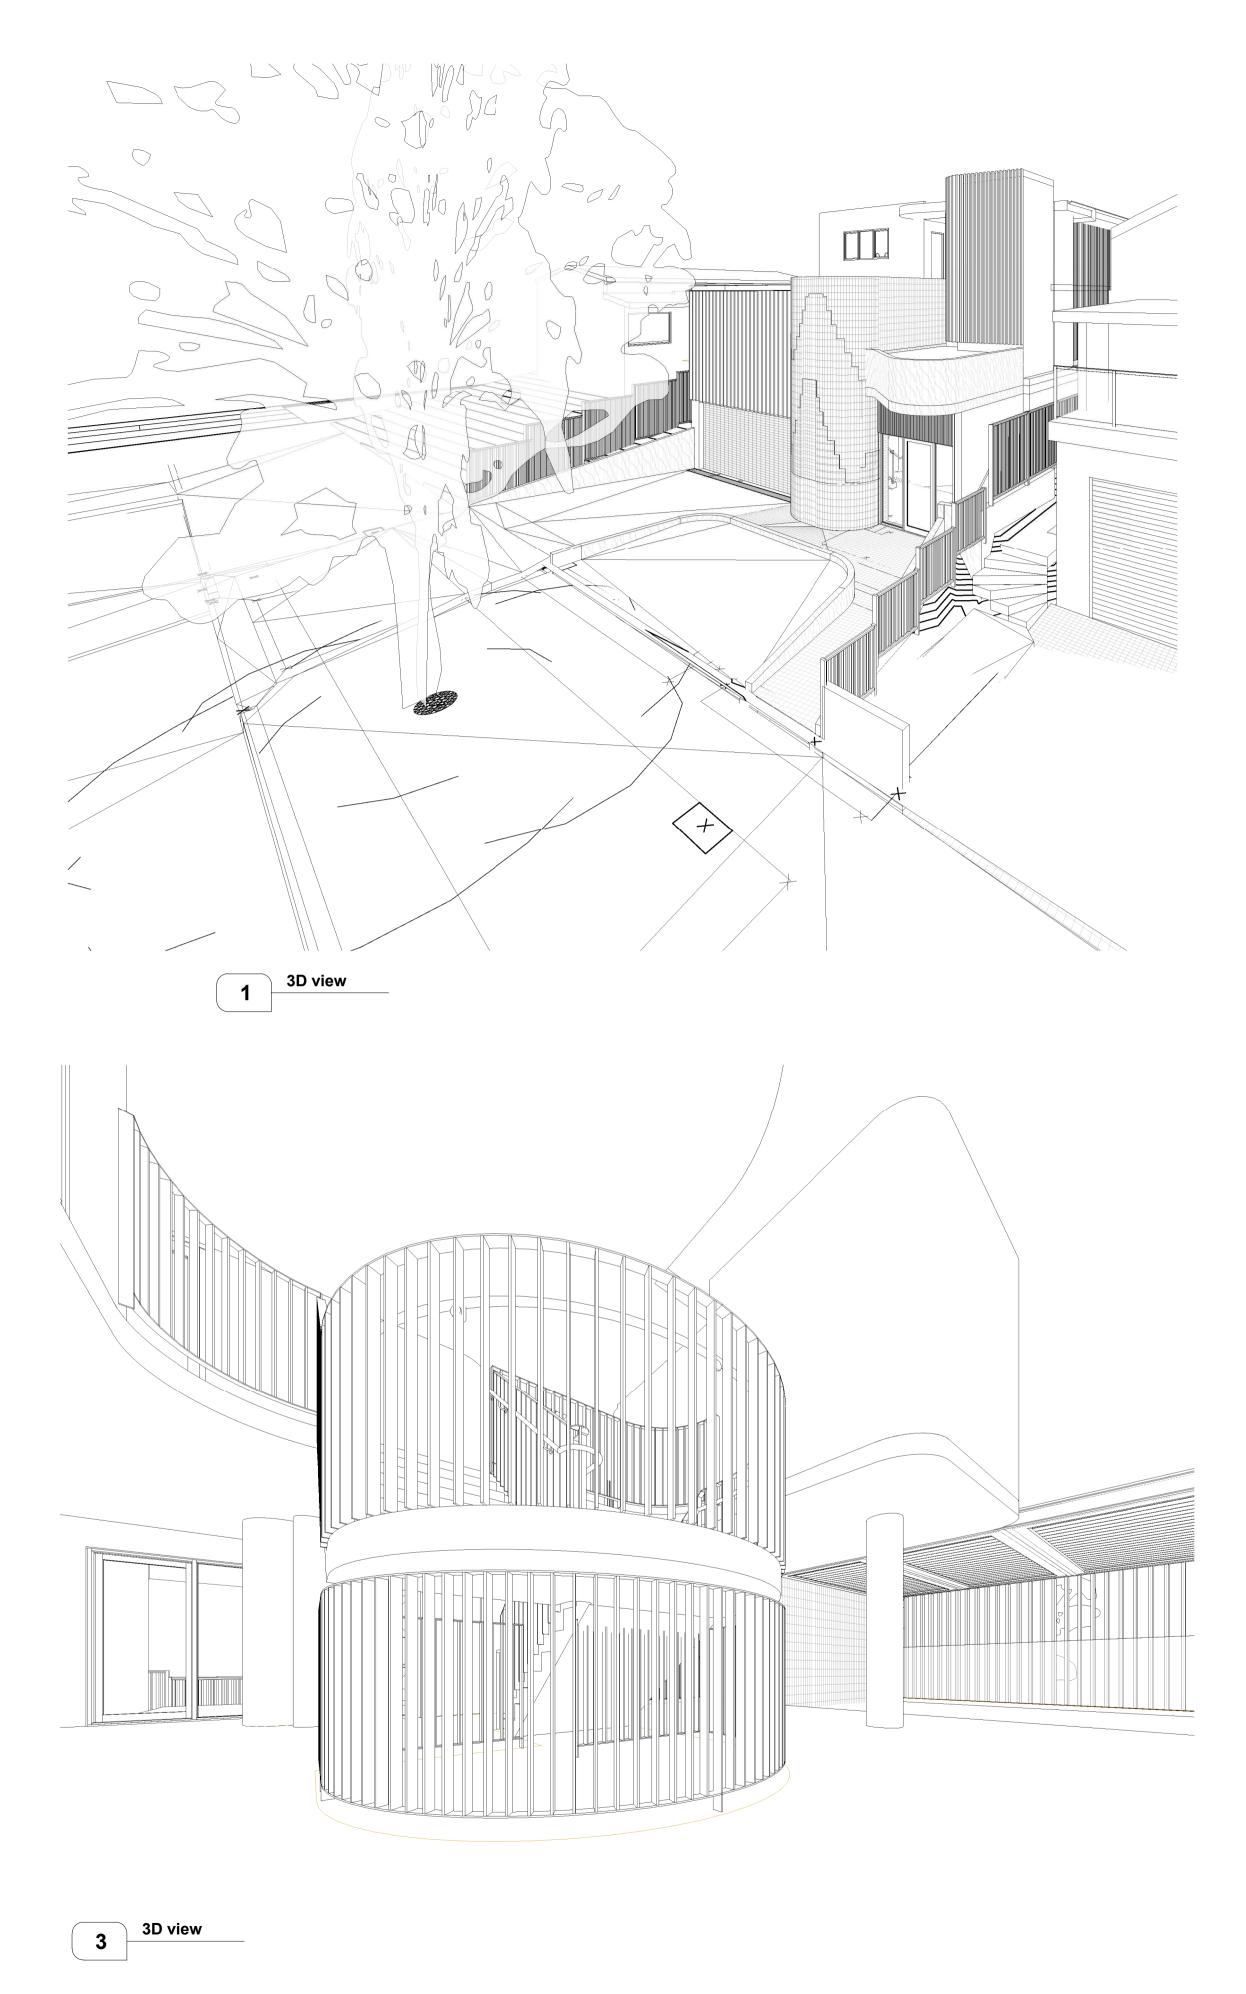

**NOT For Construction** 

-----TITLE

#### General Notes:

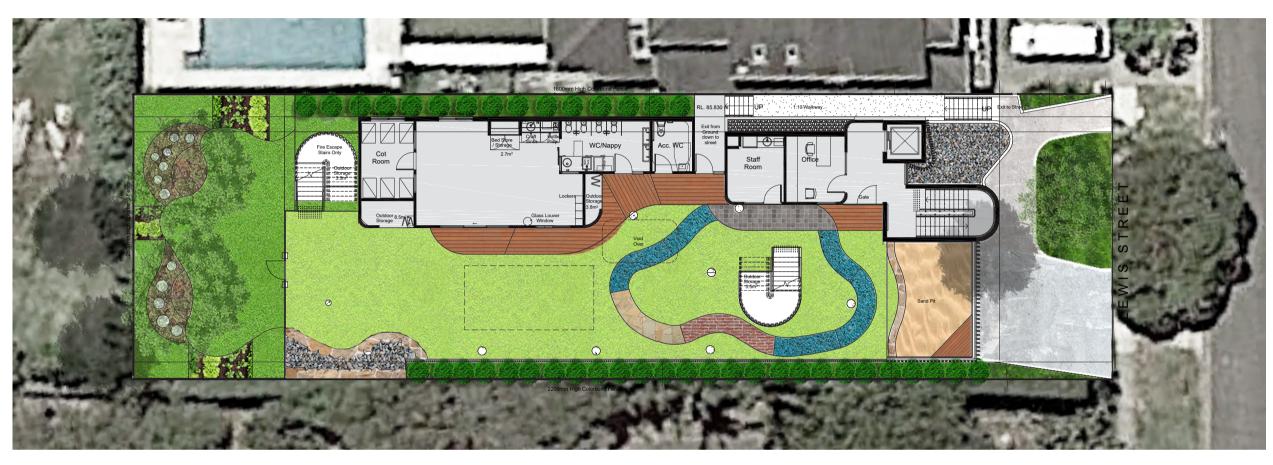
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D:\NJA Local Files\BVR00120 Lewis St\BVR00120 DA 201114 GT Local.rvt	JOB No.	В	VR00120
	DATE	Decem	ber 2020
3D Views	SCALE	A1 @	1 : 100
	DWG No.		
		DA.90	2 A

# 11 LEWIS STREET BALGOWLAH HEIGHTS LANDSCAPE CONCEPT PLAN DEVELOPMENT APPLICATION



SITE PLAN 00 1:200

#### GENERAL NOTES

INITIAL PREPARATION: SHALL MEAN ALL PRELIMINARIES AND ALL PREPARATION WORKS AS NECESSARY. COMMENCEMENT OF WORK BY LANDSCAPE CONTRACTOR (HEREIN AFTER REFERRED TO AS 'CONTRACTOR') SHALL BE DEEMED AS PROOF OF CONTRACTOR'S ACCEPTANCE OF EXISTING CONDITION OF SITE. NO WORK SHALL BE CARRIED OUT UNTIL ALL UNDERGROUND SERVICES HAVE BEEN IDENTIFIED AND ACCURATELY LOCATED AND PEGGED BY CONTRACTOR. IT IS THE RESPONSIBILITY OF THE CONTRACTOR TO DETERMINE SERVICE LOCATIONS PRIOR TO COMMENCEMENT OF WORK. ANY DAMAGE REMAINS THE RESPONSIBILITY OF THE CONTRACTOR.

DO NOT SCALE FROM DRAWINGS. USE FIGURED DIMENSIONS ONLY, VERIFY ALL DIMENSIONS ONSITE BEFORE THE COMMENCEMENT OF ANY WORKS

ALL WORK ON THIS SITE SHALL COMPLY WITH APPROPRIATE AND CURRENT AUSTRALIAN STANDARDS AND BCA. CONTRACTOR SHALL BE RESPONSIBLE FOR REMOVAL FROM SITE OF ALL RUBBISH AND DEBRIS ENCOUNTERED IN AREAS TO BE LANDSCAPED.

USE HARDWOOD TIMBER ONLY & TREATED FOR DURABILITY CLASS 1, H4 FOR IN GROUND USE, H3 OTHERWISE. ALL HARDWOOD PLAY EQUIPMENT AND HARDWOOD SURFACES TO BE SANDED BACK, TO ENSURE NO SPLINTERS OR SHARP EDGES FOR A SMOOTH FINISH. TIMBER MUST HAVE MINIMUM FOUR COATS, EQUAL TO SIKKENS SADOLINE CLEAR HARDWOOD OIL

CONTRACTOR SHALL BE RESPONSIBLE FOR WATERPROOFING AND DRAINAGE OF ALL LANDSCAPE AREAS. A 40MM DEPTH DRAINAGE LAYER OF DRAINCELL ® SHALL BE PLACED ON BASE OF ALL ON-STRUCTURE PLANTED AREAS WITH GEOTEXTILE FILTRATION LAYER AS SPECIFIED. THE GEOTEXTILE SHALL BE PROTECTED BY A 100MM LAYER OF COARSE SAND AS SPECIFIED.

IMPORTED TOPSOIL AS SPECIFIED SHALL BE SPREAD TO THE SITE AS FOLLOWS: - ON STRUCTURE PLANTING BEDS & RAISED PLANTERS 3 PLANTER BOX MIX AS SPECIFIED MOUNDED HIGHER WHERE POSSIBLE.

A FULLY AUTOMATIC DRIPLINE IRRIGATION SYSTEM SHALL BE INSTALLED TO ALL PLANTER BOXES AND PLANTING BEDS. IRRIGATION SHALL CONFORM TO AS3500 AND ACT WATER REGULATIONS AS SPECIFIED

AUSTRALIAN STANDARDS

ALL MATERIALS WORKMANSHIP SHALL BE IN ACCORDANCE WITH THE RELEVANT STANDARDS OF THE STANDARDS ASSOCIATION OF AUS.

ALL CIVIL, STRUCTURAL, AND HYDRAULIC WORK ASSOCIATED TO THIS PROJECT SHALL BE TO CONSULTING ENGINEERS DETAILS. DRAINAGE DETAILS AND WATER PLAY FEATURE DETAILS SHALL BE SUBJECT TO THE HYDRAULIC ENGINEERS SPECIFICATIONS

NO RESPONSIBILITY WILL BE TAKEN BY GREENSCAPE DESIGN + ASSOCIATES FOR ANY VARIATIONS IN DESIGN, CONSTRUCTION METHOD, MATERIAL SPECIFIED AND GENERAL SPECIFICATIONS WITHOUT PERMISSION FROM THE PROJECT ENGINEER OR LANDSCAPE ARCHITECT.

WRITTEN DIMENSIONS SHALL TAKE PRECEDENT OVER SCALED MEASUREMENTS, ALL DIMENSIONS SHALL BE VERIFIED BY CONTRACTOR ON SITE AND INITIAL SET OUT APPROVED BY LANDSCAPE ARCHITECT IN WRITING PRIOR TO COMMENCEMENT OF WORK, IF IN DOUBT CONTACT LANDSCAPE ARCHITECT.

EXACT LOCATION OF SITE BOUNDARIES TO BE CONFIRMED ON SITE PRIOR TO COMMENCEMENT OF WORK

#### DRAWING REGISTER

Dwg no.	Drawing Title	Size	Scale	Revision
DA_00 DA_01 DA_02 DA_03 DA_04	Site Context & Cover Page Landscape Master Plan Landscape Deep Soil Plan Landscape Detail Sheet Precedent Image & Plant Pallete	A1 A1 A1 A1 A3	AS NOTED 1:100 1:100 AS NOTED N/A	A A A A
—	-			

or	Descri	ption				Date	True North	Project: NEW CHILE
A	DEVEL	OPMENT APPLICATI	ON			16.12.2020		11 LEWIS STREET
								Drawing Name:
								COVER F
			1	1				DRAWING
ob Numbe LA 2012		Drawing Number: DA 00	Issue A		DM	DB		DIVANING

DCARE CENTRE T BALGOWLAH HEIGHTS

PAGE AND SITE CONTEXT NOT FOR CONSTRUCTION

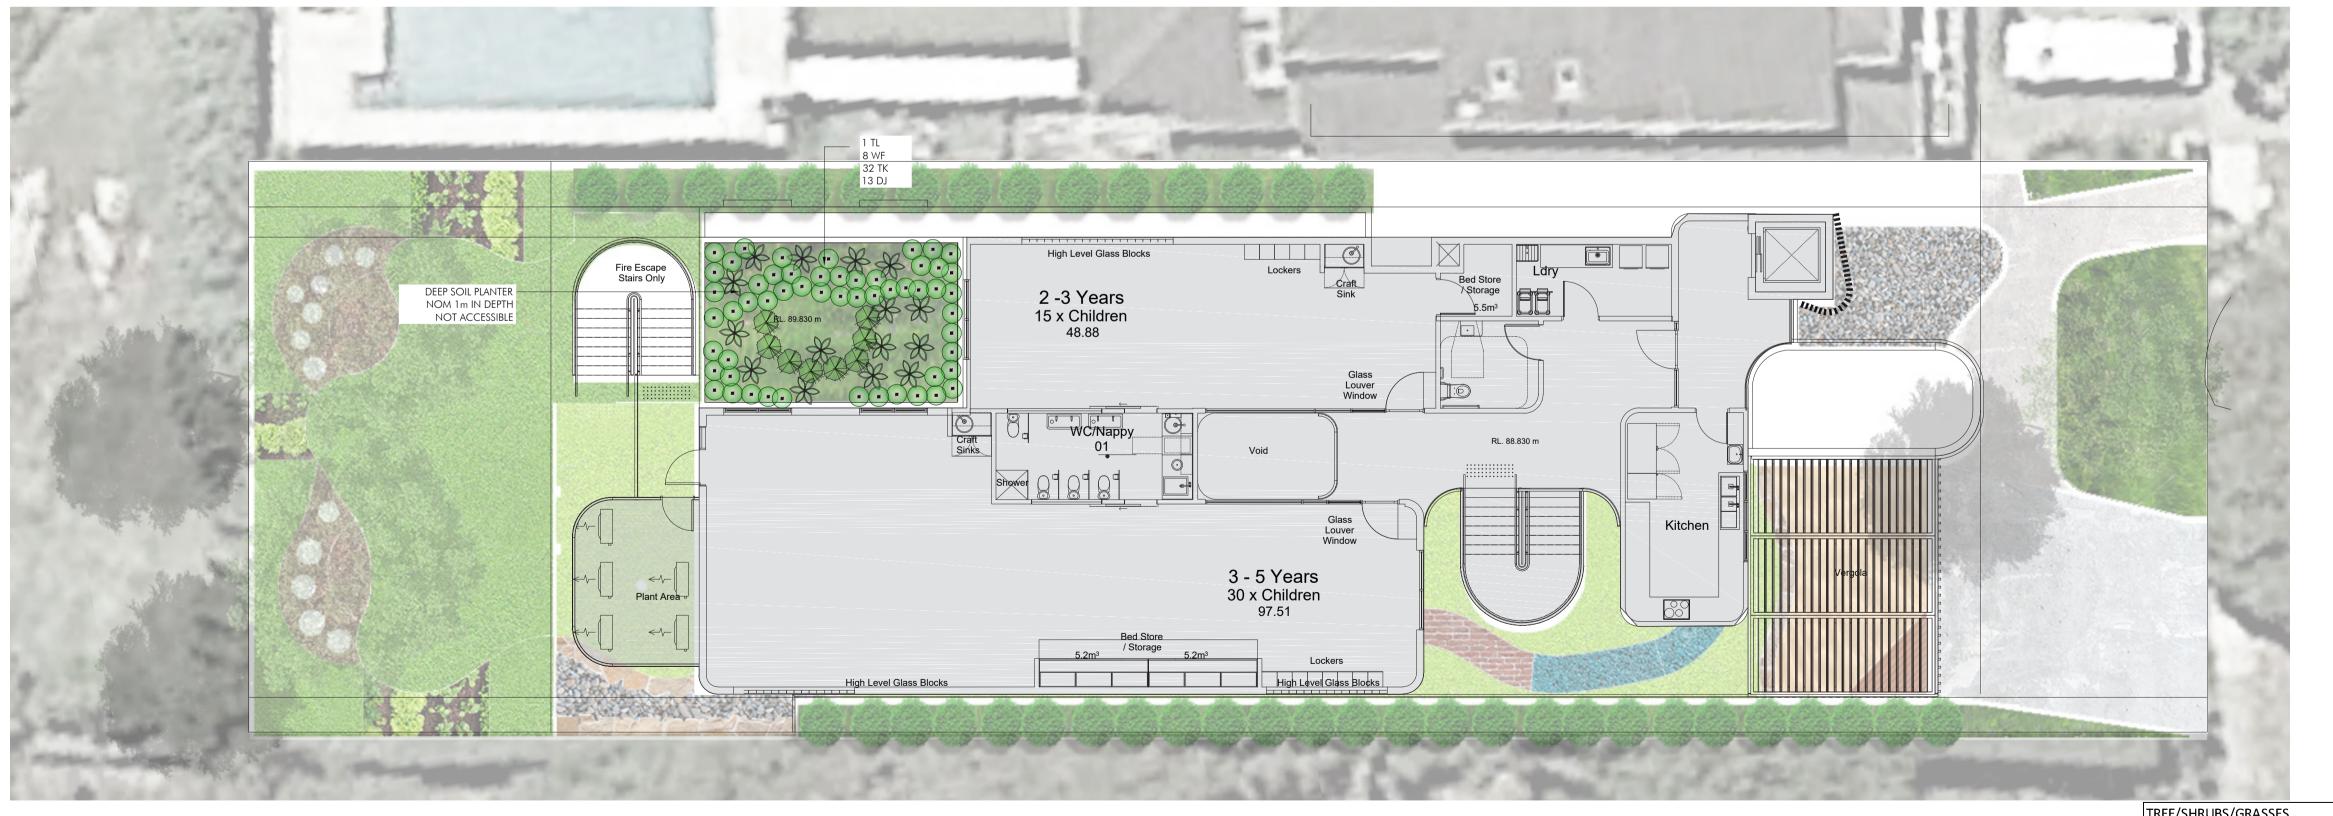




22/686 NEW SOUTH HEAD ROAD, ROSE BAY 2029

e. info@greenscapedesign.com.au







TREE/SHRUBS/GRASSES										
CODE	BOTANICALNAME	COMMON NAME	PLANT NUMBERS	POT SIZE	PLANT CTS.	SIZE (WxH)				
AS	ACMENA SMITHII VAR MINOR	LILLY PILLY	41	420 MM	AS SHOWN	2X2				
DJ	DIANELLA CAERULLEA 'LITTLE JESS'.jpg	BLECHNUM	13	140MM	AS SHOWN	0.75X0.75				
ТК	LOMANDRA LONGIFOLIA TANIKA	MAT RUSH	116	140MM	AS SHOWN	0.5X0.5				
TL	TRISTANIOPSIS LAURINA	WATER GUM	2	45 LTR	AS SHOWN	4X12				
WF	WESTRINGIA FRUTICOSA	COASTAL ROSEMARY	23	200MM	AS SHOWN	1X1				
VH	VIOLA HEDERACEA	NATIVE VIOLET	AS REQUIRED	76 MM	AS SHOWN	N/A				

For	Descr	iption				Dat	e	True North
DA	DEVE	LOPMENT APPLICATI	ON			16.	12.2020	
Job Nur LA 20	mber: )1201	Drawing Number: DA 01	lssue A	Date	DM	DB		

Drawing Name: Landscape Plans DRAWING NOT FOR CONSTRUCTION



1.8 metre high fence 2.2 metre high fence

2.5 metre high fence

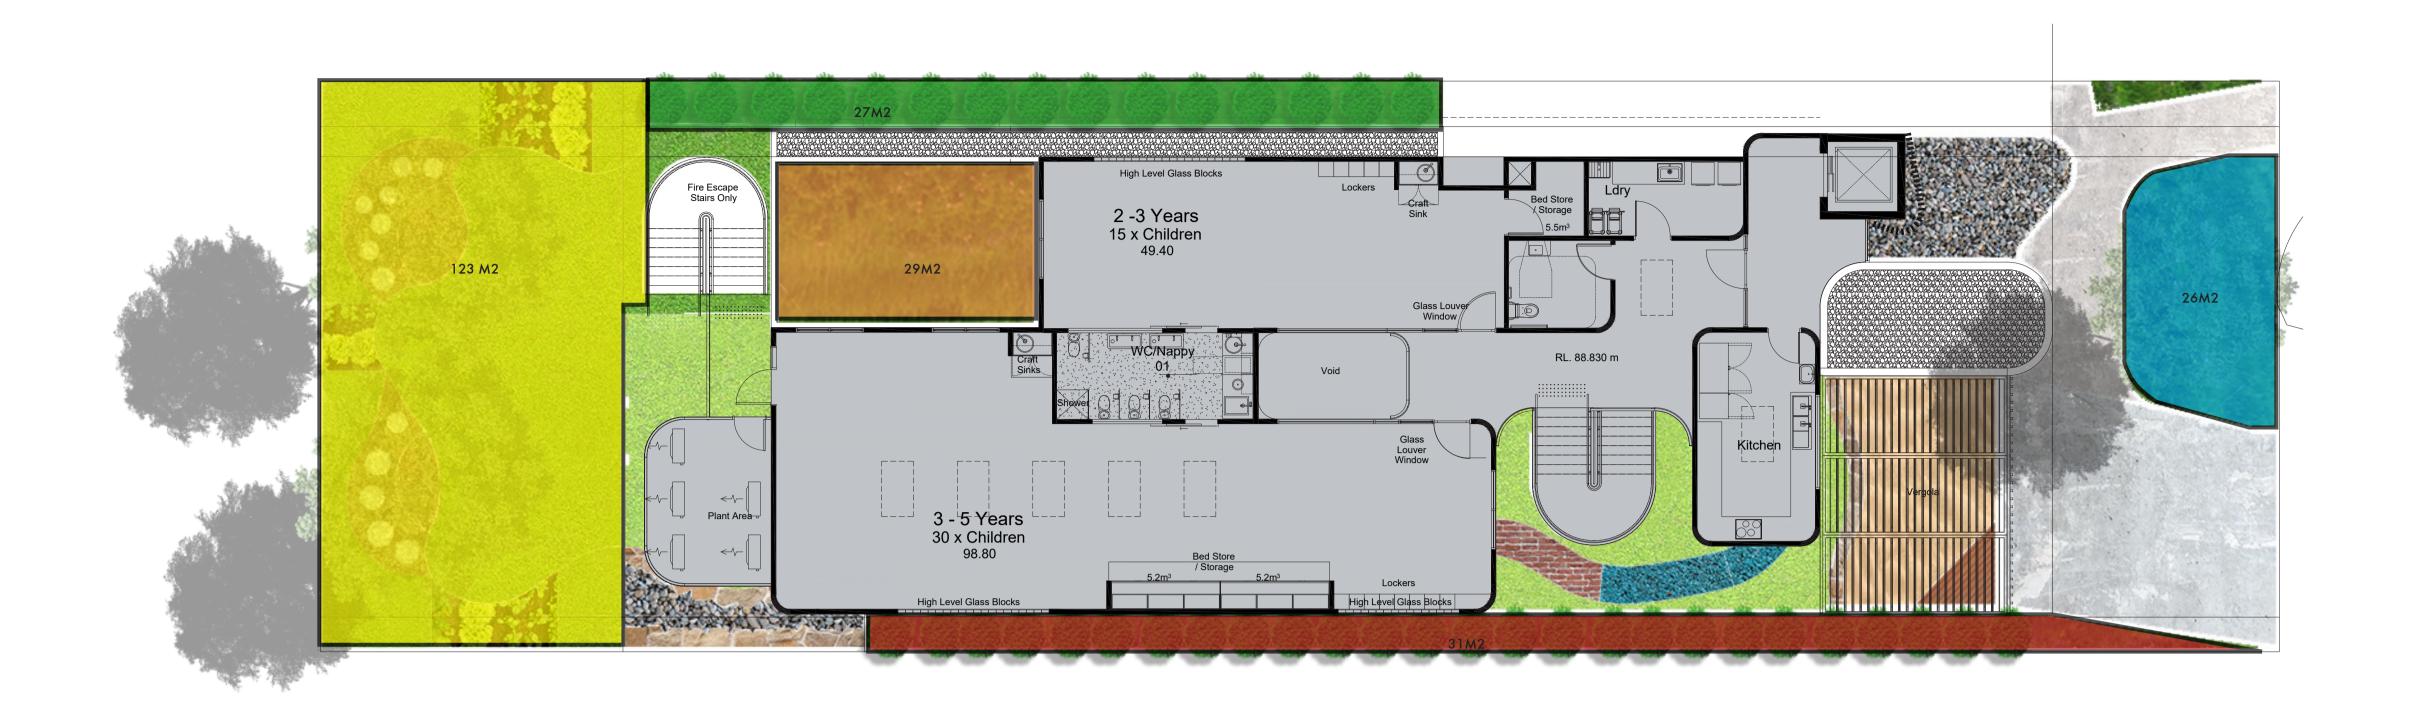
1 FENCE TYPE AND TREE NUMBER PLAN

Project: PROPOSED NEW CHILDCARE CENTRE 11 LEWIS STREET BALGOWLAH HEIGHTS



GREENSCAPE Landscape Architecture + Design

22/686 NEW SOUTH HEAD ROAD, ROSE BAY 2029



LANDSCAPE DEEP SOIL PLAN 1:100

For	Descri	ption			Date	True North	Project:
DA	DEVEI	OPMENT APPLICATIO	NC		16.12.2020		PROPO: 11 LEWIS ST
							Drawing Name:
							Landsco
Job Numbe		Drawing Number:	Issue				DRAWIN
LA 2012	201	DA 02	A	DM	DB		



OSED NEW CHILDCARE CENTRE street balgowlah heights


cape Deepsoil Plans ING NOT FOR CONSTRUCTION





22/686 NEW SOUTH HEAD ROAD, ROSE BAY 2029

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SETTLEMENT) OF APPROVED FREE DRAINING ORGANIC TOPSOIL MIX. ALLOW FOR SUPPLY, INSTALLATION AND THOROUGH CULTIVATION (INTO 225MM DEPTH OF SITE SOIL BENEATH) OF 75MM DEPTH OF IF NECESSARY (TO LANDSCAPE ARCHITECT'S APPROVAL) TO ALL GENERAL GARDEN AREAS. INITIAL PREPARATION: SHALL MEAN ALL PRELIMINARIES AND ALL PREPARATION WORKS AS NO WORK SHALL BE CARRIED OUT ON GARDEN AREAS WHILST SOIL IS WET, TO AVOID COMPACTION OF THESE AREAS. ALL BRICKS, PIECES OF TIMBER AND OTHER DEBRIS SHALL BE RAKED UP FROM PROPOSED LAWN AND GARDEN AREAS AND TRANSFERRED TO SEPARATE STOCKPILE, TO BE REMOVED FROM SITE BY CONTRACTOR AT APPROVED INTERVALS. PREPARED SOIL SHALL BE ALLOWED TO CURE PRIOR TO INSTALLING PLANTS. ENSURE THAT ALL GARDEN AREAS DRAIN SATISFACTORILY. IF DRAINAGE PROBLEMS EXIST CONTRACTOR SHALL ADVISE LANDSCAPE ARCHITECT IN WRITING AND WAIT FOR FURTHER INSTRUCTIONS. COMPLETE SOIL PREPARATION SHALL BE TO APPROVAL OF LANDSCAPE ARCHITECT. **IRRIGATION:** SHALL MEAN COMPLETE SUPPLY AND INSTALLATION OF APPROVED DRIP IRRIGATION SYSTEM TO ALL GARDEN AREAS. COMPLETED SYSTEM SHALL BE TO APPROVAL OF LANDSCAPE ARCHITECT AND SHALL COMPLY WITH ALL CURRENT AUTHORITY REQUIREMENTS. DRIP IRRIGATION SYSTEM SHALL ADEQUATELY COVER ALL GARDEN AREAS AND SHALL BE APPROPRIATE TO AND SUITABLE FOR PLANTS SPECIFIED. IRRIGATION SYSTEM SHALL BE CONNECTED TO MAINS WATER. IRRIGATION SYSTEM TO BE CONTROLLED BY AUTOMATIC SOLENOID VALVES. WITH CONTROLLER TO BE LOCATED IN APPROVED LOCATION. AUTOMATIC RAIN SENSOR SHALL BE PROVIDED TO PREVENT WATERING TO AREAS DURING PERIODS OF RAIN OR EXCESS SOIL MOISTURE. POWER SUPPLY SHALL BE PROVIDED TO AN APPROVED LOCATION BY OTHERS AND SHALL CONSIST OF A GPO WITH AN APPROVED LOCKING DEVICE TO PREVENT ACCIDENTAL DISCONNECTION OF POWER TO CONTROLLER ENSURE THAT ALL CONNECTING PIPE WORK IS ADEQUATELY COVERED WITH PLASTIC AND TAPE DURING INSTALLATION, TO ENSURE THAT NO SOIL OR OTHER MATERIAL CAN ENTER AND BLOCK PIPES. CONTRACTOR SHALL ENSURE THAT ALL GARDEN AREAS AS INDICATED ABOVE ARE SATISFACTORILY IRRIGATED, ENSURING THAT SOIL IS KEPT MOIST, NOT WET, TO APPROVAL OF LANDSCAPE ARCHITECT. CONTRACTOR SHALL CHECK PRESSURE OF WATER SUPPLY ON SITE AND ENSURE THAT THIS IS TAKEN INTO ACCOUNT FOR BOTH TENDER AND FINAL DESIGN/INSTALLATION. TWELVE MONTHS WARRANTY ON IRRIGATION SYSTEM SHALL BE PROVIDED BY CONTRACTOR, COVERING BOTH MATERIALS AND LABOUR. CONTRACTOR SHALL FULLY DETAIL AND SUBMIT TOGETHER WITH TENDER AN OUTLINE OF PROPOSED SYSTEM AND EQUIPMENT. PAVING: GENERAL: LAY ALL (i) RANDOM DIAMOND CUT SANDSTONE PAVING (SEALED) WITH ROUNDED EDGES ON NOM 20MM MORTAR BED OVER R. Conc SLAB TO NOMINATED RL IN LOCATIONS AS SHOWN ON LANDSCAPE PLAN. TOP OF FINISHED SURFACE OF PAVING SHALL BE EVEN. LAYING: LAY PAVING TO APPROVED GRADES AND WITH NOM. 1:80 FALLS TO ENSURE THAT SURFACE SHEDS WATER. AND KEEP SURFACES CLEAN AS PAVING IS LAID. REFER TO TYPICAL DETAILS FOR PAVING TYPES PLANTING, FERTILISING AND STAKING: SHALL MEAN ALL PLANTING AND FERTILISING WORKS AS NECESSARY, PLANTS SHALL BE AS DETAILED ON LANDSCAPE PLAN AND IN SCHEDULE. NO SUBSTITUTES FOR SPECIES OR CULTIVARS NAMED IN SCHEDULE SHALL BE ACCEPTED WITHOUT PRIOR CONSULTATION WITH LANDSCAPE ARCHITECT. PLANTS SHALL BE WELL GROWN, HEALTHY, NOT SOFT OR FORCED, NOR ROOT-BOUND. PLANT DEVELOPMENT SHALL BE OF REASONABLE SIZE, PROPORTIONATE TO SIZE OF CONTAINER AND HABIT OF PLANT, AND IN VIGOROUS GROWTH. ALL PLANTS SHALL BE WATERED IMMEDIATELY PRIOR TO PLANTING AND PLANT SET-OUT APPROVED BY LANDSCAPE ARCHITECT PRIOR TO PLANTING. PLANTING HOLES SHALL BE DUG TO DEPTH AND SLIGHTLY LARGER THAN WIDTH OF PLANT ROOT BALL WHICH THEY ARE TO RECEIVE. BASE OF PLANTING HOLE SHALL BE LOOSENED TO A DEPTH OF 75mm AND SURFACE DRESSING OF SLOW RELEASE FERTILIZER (EQUAL TO 'OSMOCOTE' OR 'NUTRICOTE' 8-9 MONTH RELEASE FORMULATION, LOW PHOSPHOROUS AS APPROPRIATE), ADDED TO HOLE TO MANUFACTURER'S RECOMMENDATIONS AND WORKED INTO LOOSENED SOIL AT BASE OF HOLE. HOLE SHALL BE FILLED WITH WATER, ALLOWED TO DRAIN, AND THEN PLANT INSTALLED INTO HOLE. ROOT BALL SHALL THEN BE BACK-FILLED WITH SURROUNDING TOPSOIL MIX (AS ELSEWHERE SPECIFIED AND ON COMPLETION OF PLANTING BASE OF EACH STEM SHALL FINISH LEVEL WITH TOP SURFACE OF SOIL. DISH SHALL BE FORMED IN SOIL AROUND BASE OF EACH PLANT TO AID IN WATER COLLECTION AND ABSORPTION. TREES TO BE STAKED SHALL BE STAKED AS INDICATED ON PLANT SCHEDULE. STAKES SHALL BE 38 x 38 x 1800mm LONG APPROVED HARDWOOD STAKES, POINTED AT ONE END. STAKES SHALL BE DRIVEN INTO GROUND A MINIMUM OF ONE THIRD OF THEIR LENGTH OR UNTIL FIRM, AVOIDING DAMAGE TO ROOT SYSTEM OF ADJACENT TREE. NOMINAL 50MM WIDE HESSIAN TIES SHALL BE FIXED IN FIGURE OF EIGHT PATTERN TO LOOSELY SECURE TREES TO STAKES AT POSITIONS ALONG TRUNK, SO AS TO PREVENT DAMAGE TO TREE AND TO GENERALLY STABILISE.

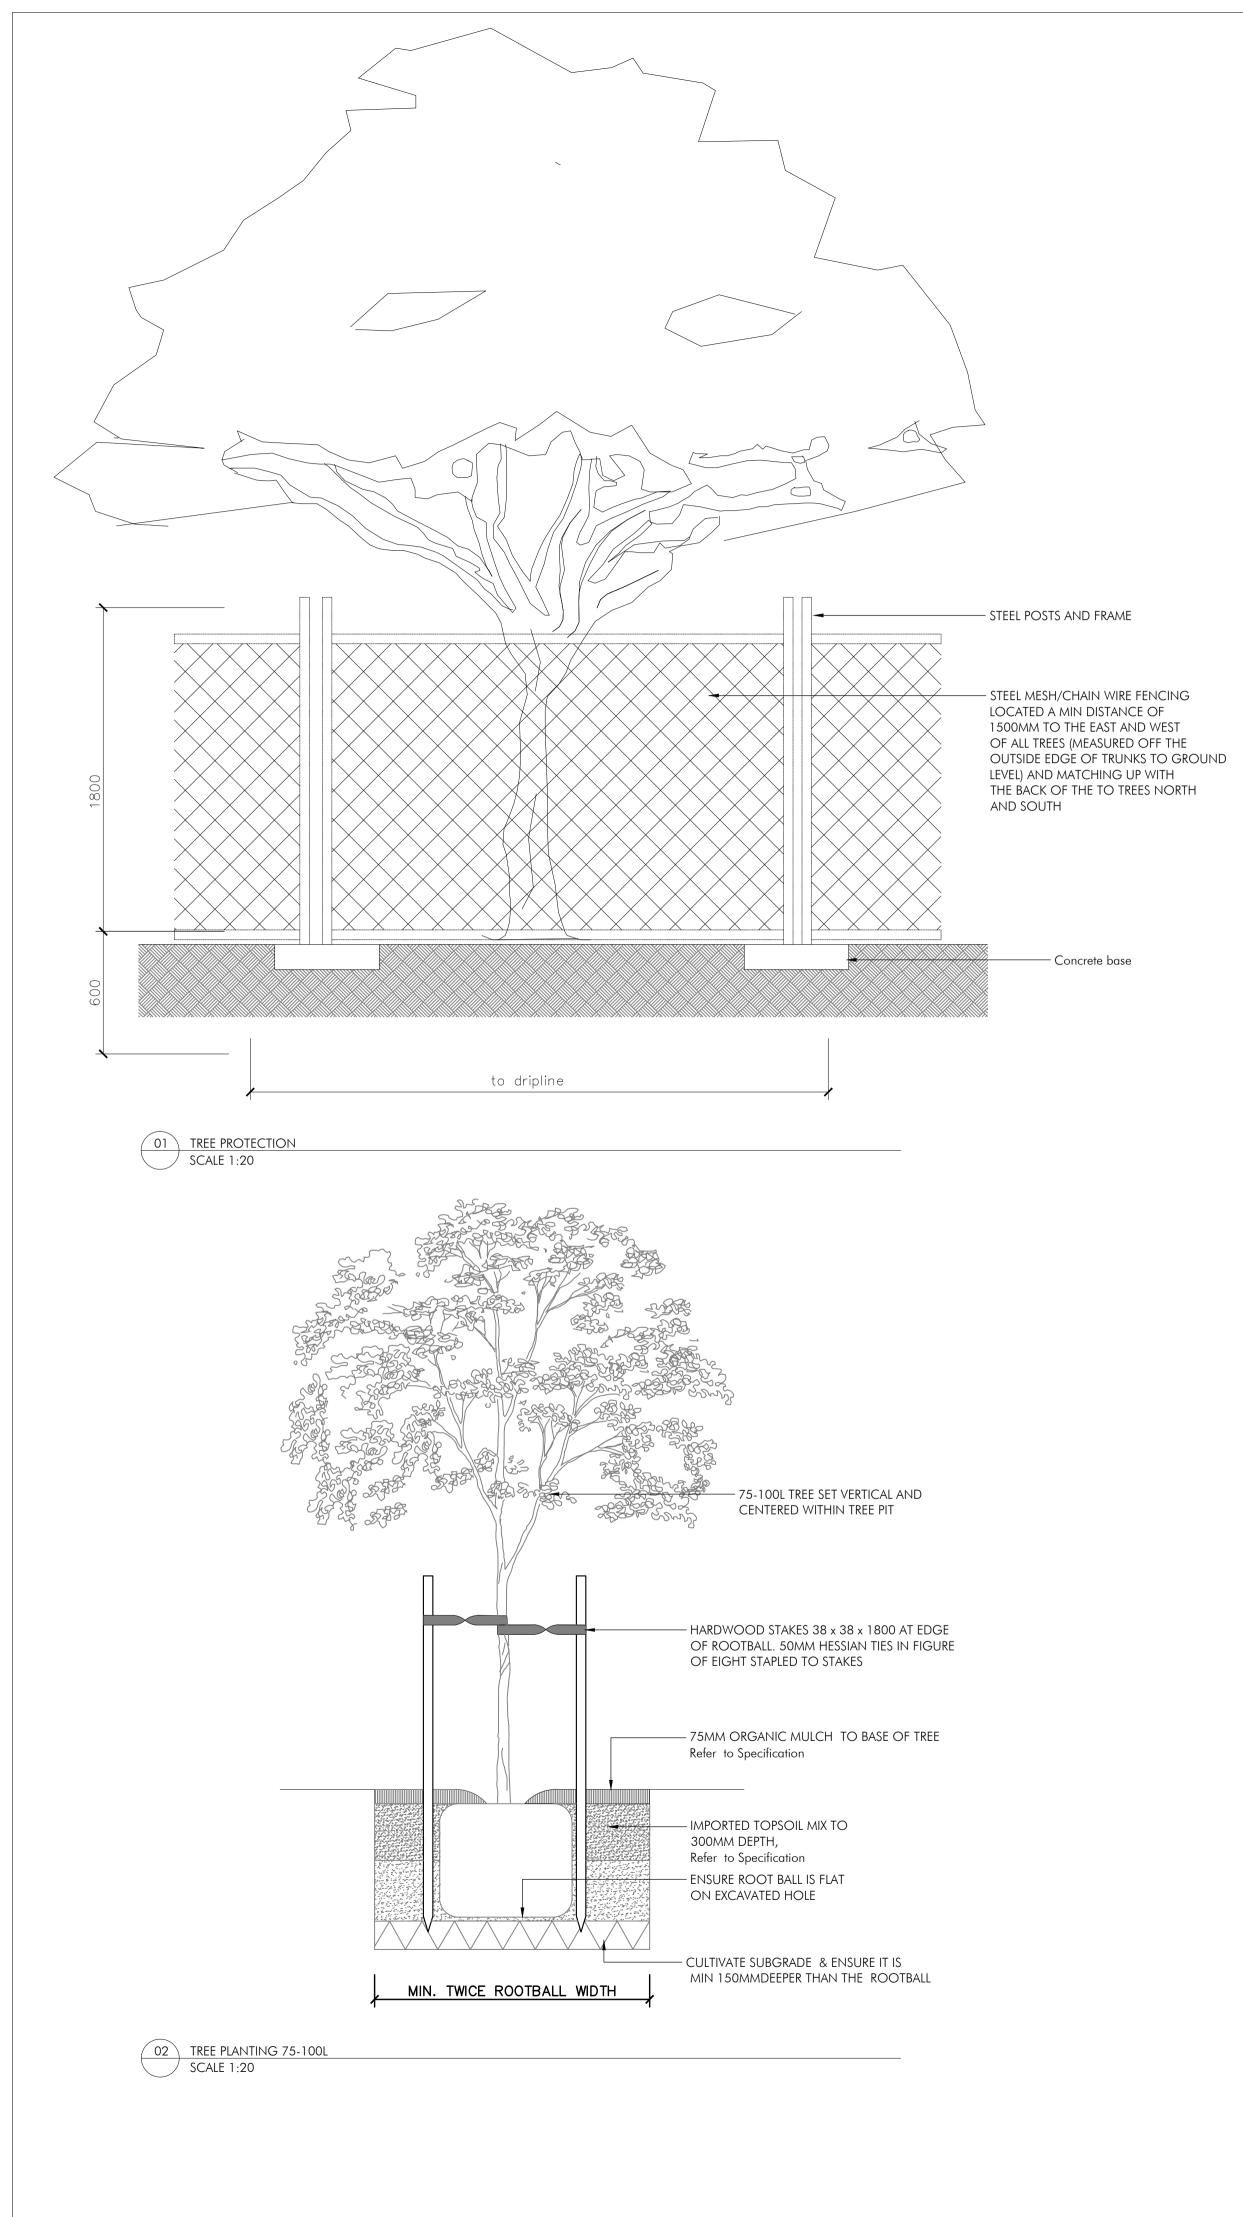LANDSCAPE SPECIFICATION NECESSARY. COMMENCEMENT OF WORK BY LANDSCAPE CONTRACTOR SHALL BE DEEMED AS PROOF OF CONTRACTOR'S ACCEPTANCE OF EXISTING CONDITION OF SITE. NO WORK SHALL BE CARRIED OUT UNTIL ALL UNDERGROUND SERVICES HAVE BEEN IDENTIFIED AND ACCURATELY LOCATED AND PEGGED BY CONTRACTOR. ALL WORK ON THIS SITE SHALL COMPLY WITH APPROPRIATE AND CURRENT AUSTRALIAN STANDARDS AND BCA. CONTRACTOR SHALL BE RESPONSIBLE FOR REMOVAL FROM SITE OF ALL RUBBISH AND DEBRIS ENCOUNTERED IN AREAS TO BE LANDSCAPED. 1.0 EARTHWORKS SHALL MEAN: EXCAVATION AND EARTHWORKS AS NECESSARY CONTRACTOR SHALL UNDERTAKE WORKS AS NECESSARY TO ACHIEVE LEVELS AND GRADES THAT ALLOW FOR ADDITION OF MATERIALS AS DETAILED TO BRING WORKS TO PROPOSED FINISHED LEVELS. CONTRACTOR SHALL ENSURE THAT FINISHED LEVELS OF GARDEN BEDS REMAIN BELOW DAMP PROOF COURSE ON BUILDINGS AND THAT FINISHED SOIL LEVELS IN GARDEN AREAS FINISH 30mm (AFTER ALLOWING FOR SETTLEMENT) BELOW LEVEL OF ADJACENT PATHWAYS, RETAINING WALLS, KERBS OR OTHER CONTAINING EDGE. 2.0 MASONRY WALLING HYDRASPLIT SANDSTONE WALL FOR RAISED SANDPITS GENERAL THIS ITEM INCLUDES COMPLETE CONSTRUCTION OF APPROVED STRUCTURALLY RETAINING WALLS. ALL WALLS TO HEIGHTS, DETAILS AND LOCATIONS AS INDICATED ON LANDSCAPE PLAN (DRAWING NO. WD 01, INSPECTIONS PROVIDE MINIMUM 48 HOURS NOTICE TO LANDSCAPE ARCHITECT FOR THE FOLLOWING INSPECTION(S) BY LANDSCAPE ARCHITECT: - SETOUT OF EXACT LOCATION OF ALL WALLING SPECIFIED HEREIN, PRIOR TO PROCEEDING FURTHER; - ALL WATERPROOFING AND DRAINAGE PRIOR TO BACKFILLING OF WALL - PRIOR TO INSTALLATION OF ALL SANDSTONE MATERIALS AND WORKMANSHIP ERECT ALL WALLING PERFECTLY VERTICAL AND TRUE TO LINE. WALLING SHALL BE STRUCTURALLY SOUND, AND TO LEVELS/HEIGHTS AS INDICATED ON PLAN. ALL WORKMANSHIP AND MATERIALS SHALL BE IN ACCORDANCE WITH CURRENT AUSTRALIAN STANDARD. WATERPROOFING OF MASONRY WALLS (WHERE RETAINING) IS A MOST IMPORTANT ITEM AND SHALL BE CARRIED OUT TO HIGHEST STANDARD POSSIBLE. WATERPROOF MASONRY WALLS (WHERE RETAINING) PRIOR TO INSTALLATION OF DRAINAGE LAYER (SPECIFIED HEREUNDER). CONSTRUCTION WALL HEIGHT AND THICKNESS: WALLING SHALL BE CONSTRUCTED TO HEIGHTS AS INDICATED ON PLAN AND REINFORCEMENT: PLACE AND FIX REINFORCEMENT AS SPECIFIED DURING CONSTRUCTION OF WALLING. MORTAR JOINTS: PROVIDE NOM. 10MM FLUSH MORTAR JOINTS BETWEEN MASONRY UNITS ON BOTH INTERNAL AND EXTERNAL FACES, PROVIDING OPEN PERPENDS TO BASE COURSE FOR DRAINAGE PURPOSES CONSTRUCTION JOINTS: INSTALL AND ALLOW FOR ALL VERTICAL CONTROL/EXPANSION JOINTS IN WALLS AS REQUIRED. ENSURE THAT JOINTS IN WALLS, ESPECIALLY IN JUNCTION AREAS, ARE SEALED WITH APPROVED COMPOUND DRAINAGE & DAMP PROOF COURSE: WATERPROOF REAR OF ALL REINFORCED MASONRY RETAINING WALLS & BOUNDARY WALL PRIOR TO INCORPORATION OF DRAINAGE LAYER TO REAR OF WALL. FOR DRAINAGE PURPOSES, INSTALL 30-40MM THICK, GEOFABRIC-WRAPPED ATLANTIS WALL PANEL DRAINAGE SYSTEM (OR EQUAL), TO REAR OF REINFORCED CONCRETE BLOCK WALLS (WHERE RETAINING). INSTALL 75MM DIAMETER AGRICULTURAL DRAINAGE PIPE (OR EQUAL) TO BOTTOM OF DRAINAGE PANELS AND CONNECT SUCH TO STORMWATER DISPOSAL SYSTEM. INSTALL COARSE AGGREGATE IN NOM. 150MM WIDE LAYER TO EXTEND UP BACK OF RETAINING WALLS, FINISHING NOM. 150MM ABOVE CONCRETE FOOTING. INSTALL WALL DRAINAGE SYSTEM TO APPROVAL OF LANDSCAPE ARCHITECT AND TO SUPPLIER'S SPECIFICATIONS. WATERPROOF RENDER: RENDER MIX SHALL BE APPROVED CEMENT RENDER MIX, APPLIED TO INTERNAL FACE OF WALLS. ADD APPROVED WATERPROOFING COMPOUND (TO MANUFACTURER'S SPECIFICATION) TO RENDER MIX USED ON INTERNAL FACE OF WALLS. STORE, HANDLE AND INSTALL RENDER PRODUCTS AND COMPOUNDS TO MANUFACTURER'S SPECIFICATIONS AND RECOMMENDATIONS. RENDER SHALL COMPLY

- 75MM DEPTH MULCH IN GARDEN

300MM MINIMUM SOIL MIX,

AS SPECIFIED

ENSURE ORGANICS

100MM BLUE METAL

REFER TO PLANS FOR

SURFACES & EDGING

**Refer Specification** 

HOT TIPPED GAL EDGE 2 X 15 mm

NOM.16mm x 400mm GALL STEEL ROD

SPOT WELD TO EDGE AT 800mm CENTRES

WITH BULLNOSE TOP (6.5MM)

- 75mm PLANTING BED MULCH

225mm TOPSOIL TYPE A

Refer to Specification

- TOPSOIL TYPE B

**Refer Specification** 

LESS THAN 5%

WITH APPROPRIATE AUSTRALIAN STANDARD. APPLY APPROVED CEMENT RENDER IN NOM. 12-15MM THICK

SINGLE COAT BY WOOD-FLOATING. FINISHED SURFACE SHALL BE EVEN, FREE FROM DEFECTS AND TRUE TO REQUIRED SURFACE (REFER TO DETAIL ON DRAWING NO.WD02). SANDSTONE CAPPING: WALLS SHALL BE FACED AND CAPPED WITH ROCK FACE SANDSTONE. SANDSTONE E . CAPPING MATERIAL SHALL BE 270MM WIDE X 75MM THICK. ROCKFACE SANDSTONE SHALL BE 'MT WHITE

WHITE' AS AVAILABLE FROM GOSFORD QUARRIES, OR APPROVED EQUIVALENT. SANDSTONE FACING SHALL BE LAID IN RANDOM PATTERN BOND WITH JOINTING TO BE TIGHT BUTTED WITH CONCEALED GROUTING. SANDSTONE WORKS SHALL BE LEFT CLEAN AND FREE FROM , STAINS OR BLEMISHES ON COMPLETION

PROVISIONS: ENSURE THAT ALL REQUIRED OPENINGS, HOLES, CASINGS, GROOVES ETC. TO ACCOMMODATE VARIOUS SERVICES ARE PLANNED FOR DURING CONSTRUCTION, IN ORDER TO AVOID BREAKING OR CUTTING OF COMPLETED WORK WHEREVER POSSIBLE

3.0 SOIL PREPARATION TO GARDEN AREAS

SHALL MEAN PREPARATION OF ALL GARDEN AREAS PLUS INSTALLATION OF TOPSOIL MIX AND SOIL CONDITIONER AS NECESSARY. CONSOLIDATED DEPTH (THAT IS, AS NECESSARY TO ALLOW FOR FUTURE

75MM DEPTH PINE BARK MULCH

200MM WIDE FULLY-FILLED REINFORCED CONCRETE BLOCK RETAINING WALL.

WATERPROOF BAGGING FINISH TO REAR OF CONCRETE BLOCK WALL AND BOUNDARY WALLS SPECIFIED

NOM. 30MM THICK DRAINAGE CELL LAYER INSTALLED TO MANUFACTURERS SPECIFICATIONS FREE DRAINING ORGANIC SOIL MIX AS

SPECIFIED

75MM DIAMETER AGRICULTURAL DRAINAGE LINE WRAPPED IN FILTER SOCK AND SURROUNDED BY NOM. 10MM DRAINAGE AGGREGATE ENCLOSED BY GEOTEXTILE FILTER FABRIC. CONNECT AG. LINE INTO MAIN STORMWATER DISPOSAL SYSTEM

> 06 TYPICAL PLANTER DETAIL / SCALE 1:10

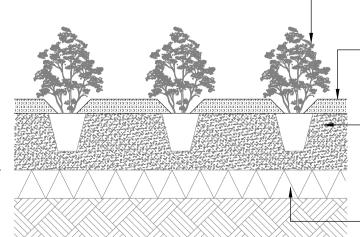
GROUNDCOVER Refer Specification 75mm DEPTH MULCH REFER SPECIFICATION TRUNK WITH TOPSOIL MIXTURE &

DISHED AROUND BASE OF BACKFILL & CONSOLIDATE

PROPOSED SHRUB OR

FERTILISE TO MIN. 300mm Refer Specification

BREAKUP & CULTIVATE SUBGRADE TO 150mm DEPTH



(05) SHRUB OR GROUNDCOVER IN PLANTING BED SCALE 1:20

> Description Date True North PROPOSED NEW CHILDCARE CENTRE DEVELOPMENT APPLICATION 16.12.2020 11 LEWIS STREET BALGOWLAH HEIGHTS Drawing Name: Detail Sheet DRAWING NOT FOR CONSTRUCTION Job Number:Drawing Number:IssueLA 201201DA 03A DM DB

GARDEN BED SIDE

SCALE 1:10 at A1, 1:20 at A3

TURF SIDE

TYPICAL MILD STEEL EDGE


SCALE 1:10 at A1, 1:20 at A3

TYPICAL FIBRE GLASS TROUGH/PLANTER BOX DETAIL

7.0 MULCHING: SHALL MEAN COMPLETE SUPPLY AND INSTALLATION OF a. NOM. 75mm DEPTH OF APPROVED 25MM GARDEN MULCH SUITABLE FOR CHILDCARE CENTRES FROM AUSTRALIAN NATIVE LANDSCAPES PH: 9450 1444), TO ALL GARDEN AREAS FOLLOWING COMPLETION OF PLANTING . COVE MULCH DOWN TO FINISH FLUSH WITH CONTAINING EDGES AND REDUCE TO 25mm THICK AROUND BASE OF STEM OF EACH PLANT.

COMPLETION: PRIOR TO COMPLETION, CONTRACTOR SHALL MAKE GOOD ANY DAMAGED AREAS. 8.0 CONTRACTOR SHALL LEAVE AREAS OVER WHICH CONTRACTOR HAS WORKED IN TIDY CONDITION AND TO ATISFACTION OF LANDSCAPE ARCHITECT. CONTRACTOR SHALL BE RESPONSIBLE FOR REMOVAL FROM SITE OF ALL UNWANTED MATERIAL AND DEBRIS RESULTING FROM THIS WORK.

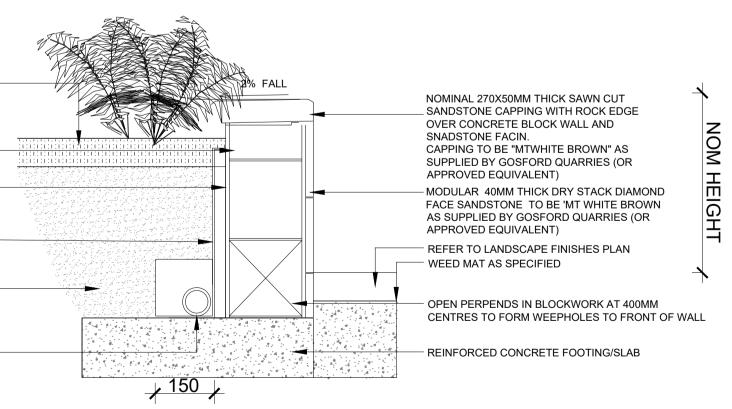\_\_\_\_MAINTENANCE: CONTRACTOR SHALL MAINTAIN SITE FOR A PERIOD OF 12 MONTHS- REFER TO MAINTENANCE SCHEDULE





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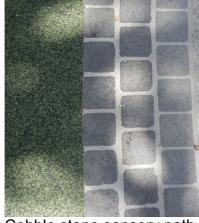
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Timber Deck transition zone & soft fall mounds





Timber log seats with cushion cover Cobble stone sensory path Yarningcircle





# PLANTING PALETTE -Guide only, please refer to planting schedule

PREPARED BY : GREENSCAPE DESIGN

DATE : 16.12.2020 JOB NO :201201 ISSUE : A

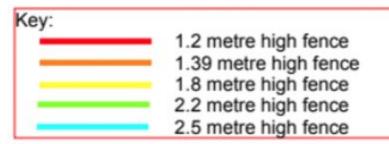
PRECEDENT IMAGES

11 LEWIS STREET, BALGOWLAH HEIGHTS NSW









# Fence Heights and Tree Locations



#### DUST CONTROL:

• NOTE: DURING EXCAVATION, DEMOLITION AND CONSTRUCTION, ADEQUATE MEASURES SHALL BE TAKEN TO PREVENT DUST FROM AFFECTING THE AMENITY OF THE NEIGHBORHOOD.

THE FOLLOWING MEASURES MUST BE ADOPTED:

1. PHYSICAL BARRIERS SHALL BE ERECTED AT RIGHT ANGLES TO PREVENT WIND DIRECTION OR SHALL BE PLACED AROUND OR OVER DUST SOURCES TO PREVENT WIND OR ACTIVITY FROM GENERATING DUST.

2. EARTHWORKS AND SCHEDULING ACTIVITIES SHALL BE MANAGED TO COINCIDE WITH THE NEXT STAGE OF DEVELOPMENT TO MINIMISE THE AMOUNT OF TIME THE SITE IS LEFT TO CUT OR EXPOSED.

 ALL MATERIALS SHALL BE STORED OR STOCKPILED AT THE BEST LOCATIONS.
THE GROUND SURFACE SHOULD BE DAMPENED SLIGHTLY T₀ PREVENT DUST FROM BECOMING AIRBORNE BUT SHOULD NOT BE WET TO THE EXTENT THAT RUN-OFF OCCURS.

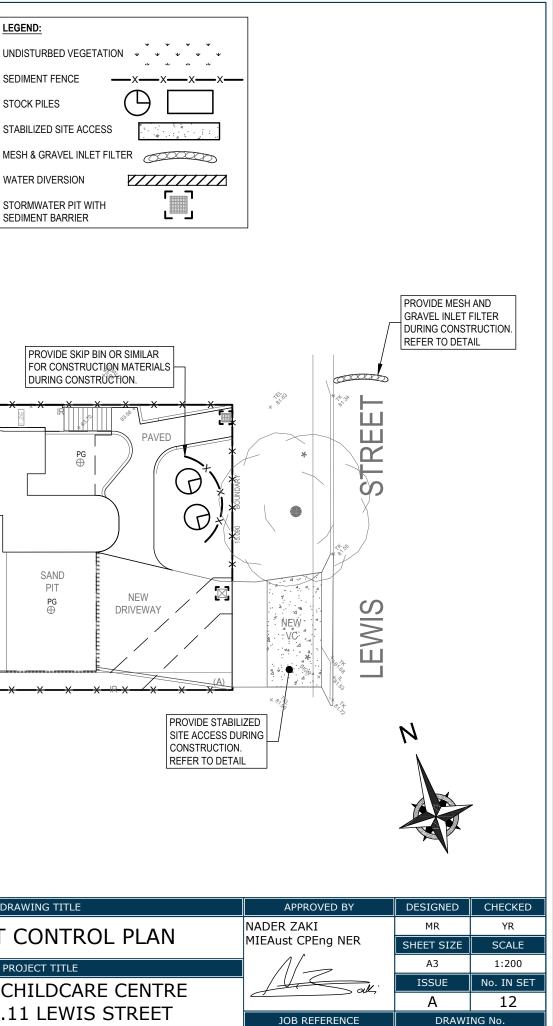
5. ALL VEHICLES CARRYING SOIL OR RUBBLE TO OR FROM THE SITE SHALL AT ALL TIMES BE COVERED TO PREVENT THE ESCAPE OF DUST.

6. ALL EQUIPMENT WHEELS SHALL BE WASHED BEFORE EXISTING THE SITE USING MANUAL OR

- AUTOMATED SPRAYERS AND DRIVE THROUGH WASHING BAYS.
- 7. GATES SHALL BE CLOSED BETWEEN VEHICLE MOVEMENTS SHALL BE FITTED WITH SHADE CLOTH.
- 8. CLEANING OF FOOTPATHS AND ROADWAYS SHALL CARRIED OUT DAILY.
- 9. ALL BUILDERS REFUSE, SPOIL AND/OR MATERIAL UNSUITABLE FOR USE IN LANDSCAPE AREAS SHALL BE REMOVED FROM SITE ON COMPLETION OF THE BUILDING WORKS.


#### NOTES:

- 1. ALL EROSION AND SEDIMENT CONTROL MEASURES TO BE INSPECTED AND MAINTAINED DAILY BY SITE MANAGER IN ACCORDANCE WITH COUNCIL REQUIREMENTS.
- 2. ALL STOCKPILES TO BE CLEAR FROM DRAINS, GUTTERS AND FOOTPATHS.
- 3. DRAINAGE IS TO BE CONNECTED TO STORMWATER SYSTEM AS SOON AS
- POSSIBLE. 4. ROADS AND FOOTPATH TO BE SWEPT DAILY AS REQUIRED BY COUNCIL.
- IF YOU DO NOT COMPLY WITH COUNCIL REQUIREMENTS & DOCUMENTATION, YOU MAY BE LIABLE TO PROSECUTION FROM GOVERNMENT AUTHORITIES.




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		DECOUDTION	DATE		DRAWING TITLE
REVISION	DRAWN	DESCRIPTION	DATE		
A	MR	ISSUED FOR DA	17.12.2020		SEDIMENT CONTROL PLAN
					PROJECT TITLE
					PROPOSED CHILDCARE CENTRE
					LOT B, No.11 LEWIS STREET
				F admin@nucivilengineering.com au	
				W www.nycivilengineering.com.au	BALGOWLAH HEIGHTS
	REVISION A				A     MR     ISSUED FOR DA     17.12.2020

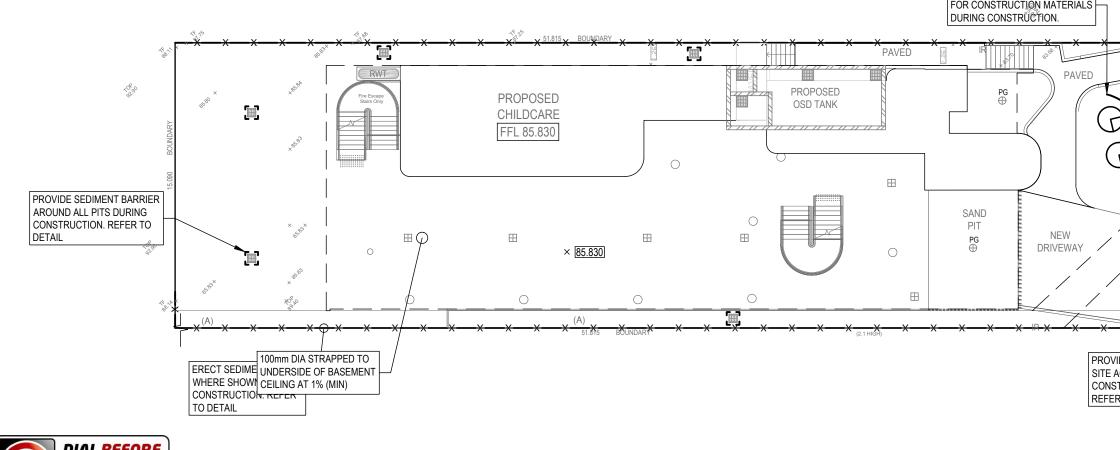

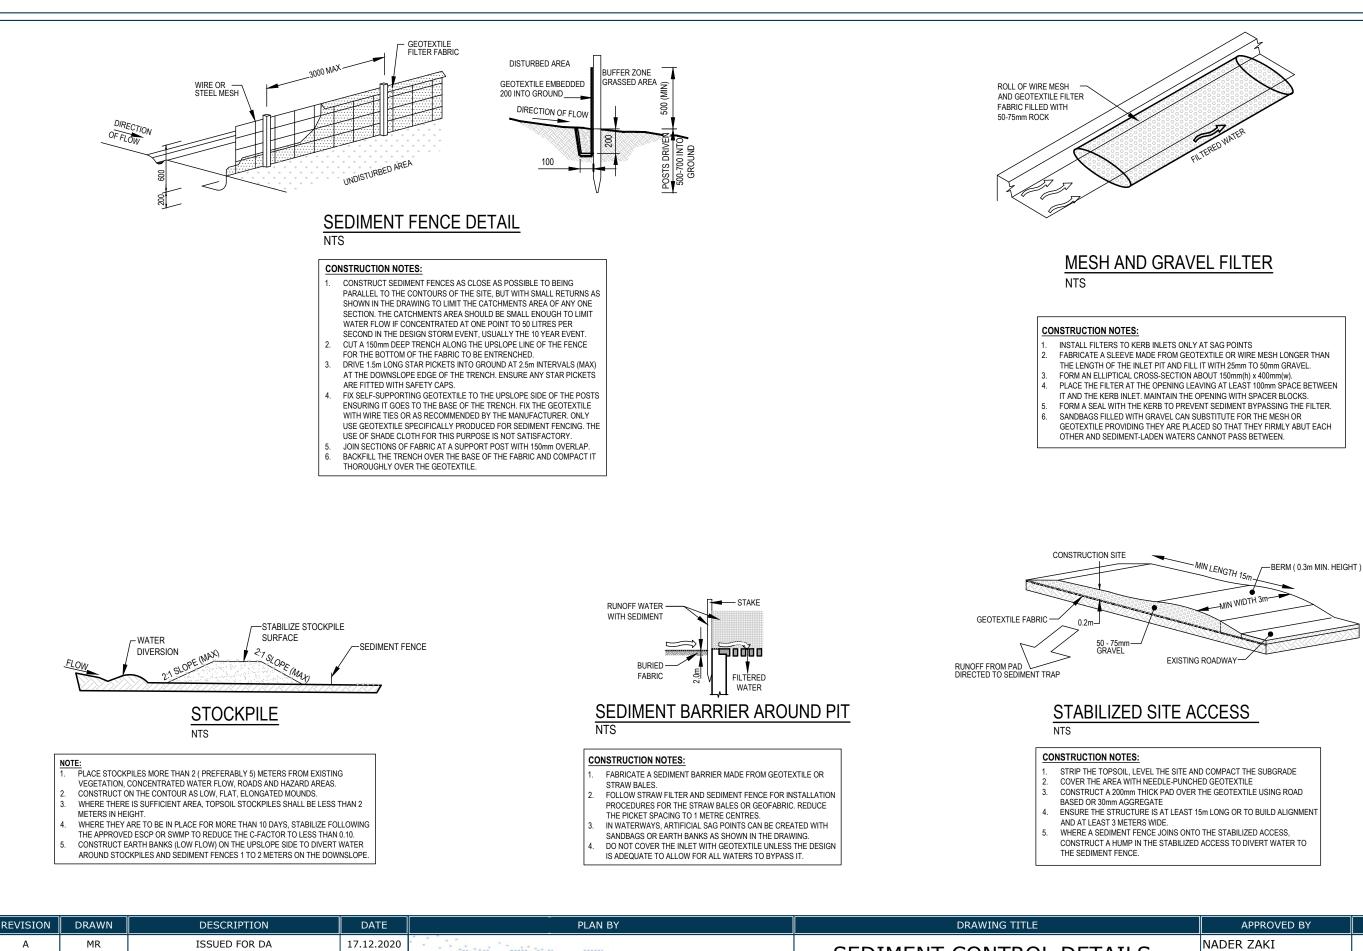REVISION	DRAWN	DESCRIPTION	DATE	PLAN BY	DRAWING TITLE	APPROVED BY	DESIGNED	CHECKED
A	MR	ISSUED FOR DA	17.12.2020			NADER ZAKI MIEAust CPEng NER	MR SHEET SIZE	YR SCALE
					PROJECT TITLE PROPOSED CHILDCARE CENTRE	atk;	A3 ISSUE A	AS NOTED No. IN SET 12
			T 0416 334 977 E admin@nycivilengineering.com.au W www.nycivilengineering.com.au		LOT B, No.11 LEWIS STREET BALGOWLAH HEIGHTS	JOB REFERENCE E200246	DRAWII	