

# **ACTION PLANS**

# 37 RADIO AVENUE, BALGOWLAH HEIGHTS 2093

m: 0426 957 518


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# **DEVELOPMENT APPLICATION**


ITEM DETAILS	DEVELOPMENT APPLICATION						
ADDRESS	37 RADIO AVENUE, BALGOWLAH HEIGHTS	S, NSW, 2093					
LOT & DP/SP	LOT 14 DP 13468	LOT 14 DP 13468					
COUNCIL	NORTHERN BEACHS COUNCIL (MANLY)						
SITE AREA	505.4m²						
FRONTAGE	14.325m						
CONTROLS	PERMISSIBLE / REQUIRED	EXISTING	PROPOSED				
CONTROLS	m / m² / %	m / m² / %	m / m² / %				
<u>LEP</u>							
LAND ZONING	R2	R2	R2				
MINIMUM LOT SIZE	500m²	505.4m²	UNCHANGED				
FLOOR SPACE RATIO	0:45 : 1 (227.43m²)	0.37 : 1 (185.04m²)	0.50 : 1 (254.62m²)				
MAXIMUM BUILDING HEIGHT	8.5m	7.563m	7.758m				
DCP							
RESIDENTIAL OPEN SPACE	AREA OS3						
TOTAL OPEN SPACE (TOS)	55% (277.97m²)	53% (266.45m²)	49% (244.57m²)				
LANDSCAPE AREA	35% OF TOS (55%) : 97.29m <sup>2</sup>	88% (233.58m²)	64% (156.52m²)				
OPEN SPACE ABOVE GROUND	MAX. 25% OF TOS : 69.49m²	8.57m <sup>2</sup>	28.71m <sup>2</sup>				
PRINCIPAL PRIVATE OPEN SPACE	18m²	132.63m²	129.61m²				
FRONT SETBACK	PREVALING BULDING LINE: 6m	7.64m	UNCHANGED				
REAR SETBACK	8.0m	8.269m	8.198m				
SIDE SETBACKS	1/3 WALL HEIGHT	N:1.014m S:0.971m	UNCHANGED UNCHANGED				
CAR PARKING SPACES	Required: 1	1	UNCHANGED				

SHEET NUMBER	SHEET NAME	DATE PUBLISHED
DA00	COVER	11/02/2021
DA01	SITE ANALYSIS	11/02/2021
DA02	SITE / ROOF / SEDIMENT EROSION / WASTE MANAGEMENT / STORMWATER CONCEPT PLAN	11/02/2021
DA03	EXISTING GARAGE FLOOR LEVEL	11/02/2021
DA04	EXISTING GROUND FLOOR PLAN	11/02/2021
DA05	EXISTING FIRST FLOOR PLAN	11/02/2021
DA06	PROPOSED GARAGE FLOOR LEVEL	11/02/2021
DA07	PROPOSED GROUND FLOOR PLAN	11/02/2021
DA08	PROPOSED FIRST FLOOR PLAN	11/02/2021
DA09	NORTH / EAST ELEVATION	11/02/2021
DA10	SOUTH / WEST ELEVATION	11/02/2021
DA11	LONG / CROSS SECTION	11/02/2021
DA12	CROSS SECTION 2 & POOL LONG SECTION	11/02/2021
DA13	FLOOR SPACE RATIO CALCULATIONS	11/02/2021
DA14	SITE CALCULATIONS	11/02/2021
DA15	WINTER SOLSTICE 9 AM	11/02/2021
DA16	WINTER SOLSTICE 12 PM	11/02/2021
DA17	WINTER SOLSTICE 3 PM	11/02/2021
DA18	DRIVEWAY PLAN & LONG SECTION	11/02/2021
DA19	SAMPLE BOARD	11/02/2021
DA20	BASIX COMMITMENTS	11/02/2021



### NCC & AS COMPLIANCES SPECIFICATIONS

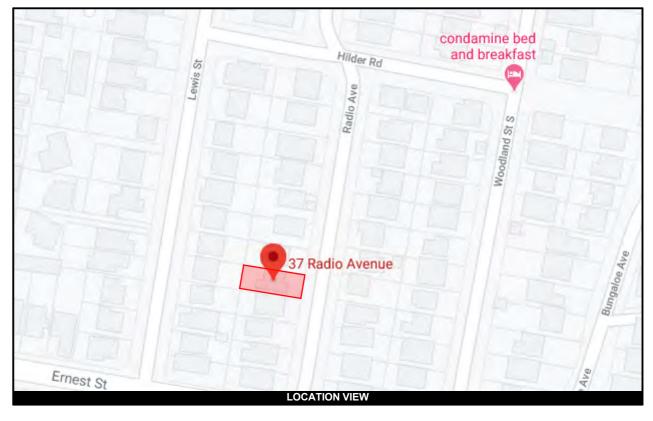- Earthworks part 3.1.1 of NCC
- Earth retaining structures part 3.1.2 of NCC
- Drainage part 3.1.3 of NCC
- Termite-risk management part 3.1.4 of NCC
- Footings & slab part 3.2 of NCC including as 2870-2011
- Masonry part 3.3 of ncc including as 3700:2018
- Framing part 3.4 of NCC
- Sub floor ventilation part 3.4.1 of NCC
- Roof cladding and wall-cladding part 3.5 of NCC
- Glazing part 3.6 of NCC including as 1288
- Fire safety part 3.7 of NCC
- Fire separation of external walls part 3.7.2 of NCC
- Fire protection of separating walls and floors- part 3.7.3 of NCC
- Smoke alarms part 3.7.5 of NCC
- Wet areas and external waterproofing part 3.8.1 of NCC
- Room heights part 3.8.2 of NCC
- Facilities part 3.8.3 of NCC
- Light part 3.8.4 of NCC
- Ventilation part 3.8.5 of NCC
- Sound insulation part 3.8.6 of NCC
- Stairway and ramp construction part 3.9.1 of NCC
- Barriers and handrails part 3.9.2 of NCC
- Swimming pools part 3.10.1 of NCC
- Demolition works AS 2601-2001 the demolition of structures.
- Waterproofing of wet areas to comply with AS 3740-2010
- All plumbing & drainage work to comply with AS 3500:2018
- All plasterboard work to comply with AS 2588:2018
- All structural steel work to comply with AS 4100-1992 & AS 1554
- All concrete work to comply with AS 3600:2018
- All roof sheeting work to comply with AS 1562.1-2018
- All skylights to comply with AS 4285-2019
- All ceramic tiling to comply with AS 3958.1-2007 & 3958.2-1992
- All glazing assemblies to comply with AS 2047-2014 & 1288
- All timber retaining walls are to comply with AS 1720.1-2010,
- AS 1720.2-2006, AS 1720.4-2006, AS 1170.1-2002 & AS 1170.4-2007
- All retaining walls are to comply with 3700:2018 & AS 3600:2018

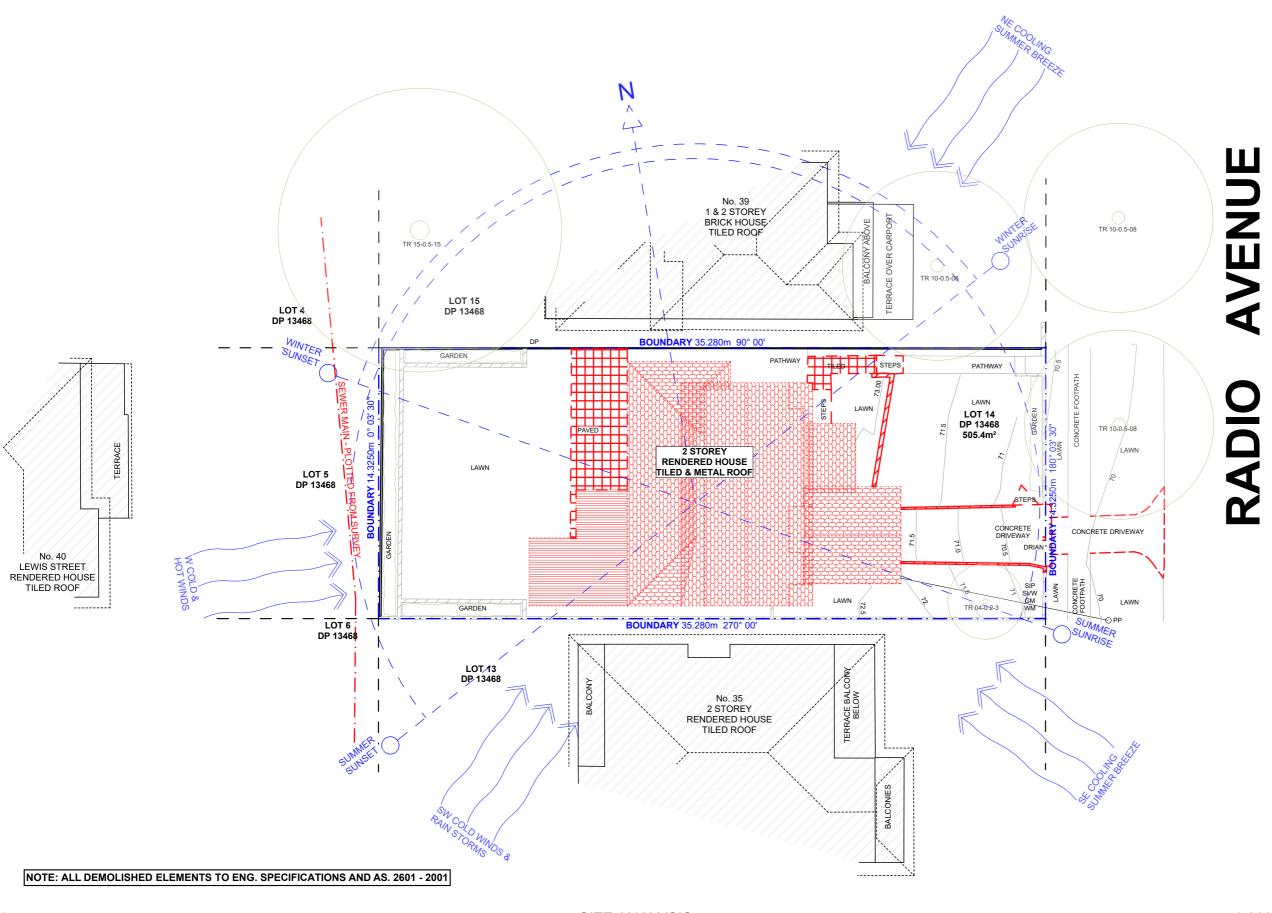







SITE ANALYSIS 1:200



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REV. DATE

COMMENTS

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DRWN NOTES

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**EXISTING** PROPOSED -- DEMOLISHED CLIENT

BRIDGET & PHIL HOLMEWOOD


PROJECT ADDRESS 37 RADIO AVENUE, BALGOWLAH HEIGHTS 2093

DRAWING NO. **DA01** 

DATE Thursday, 11 February 2021 DRAWING NAME SITE ANALYSIS

**SCALE** 1:200 @A3



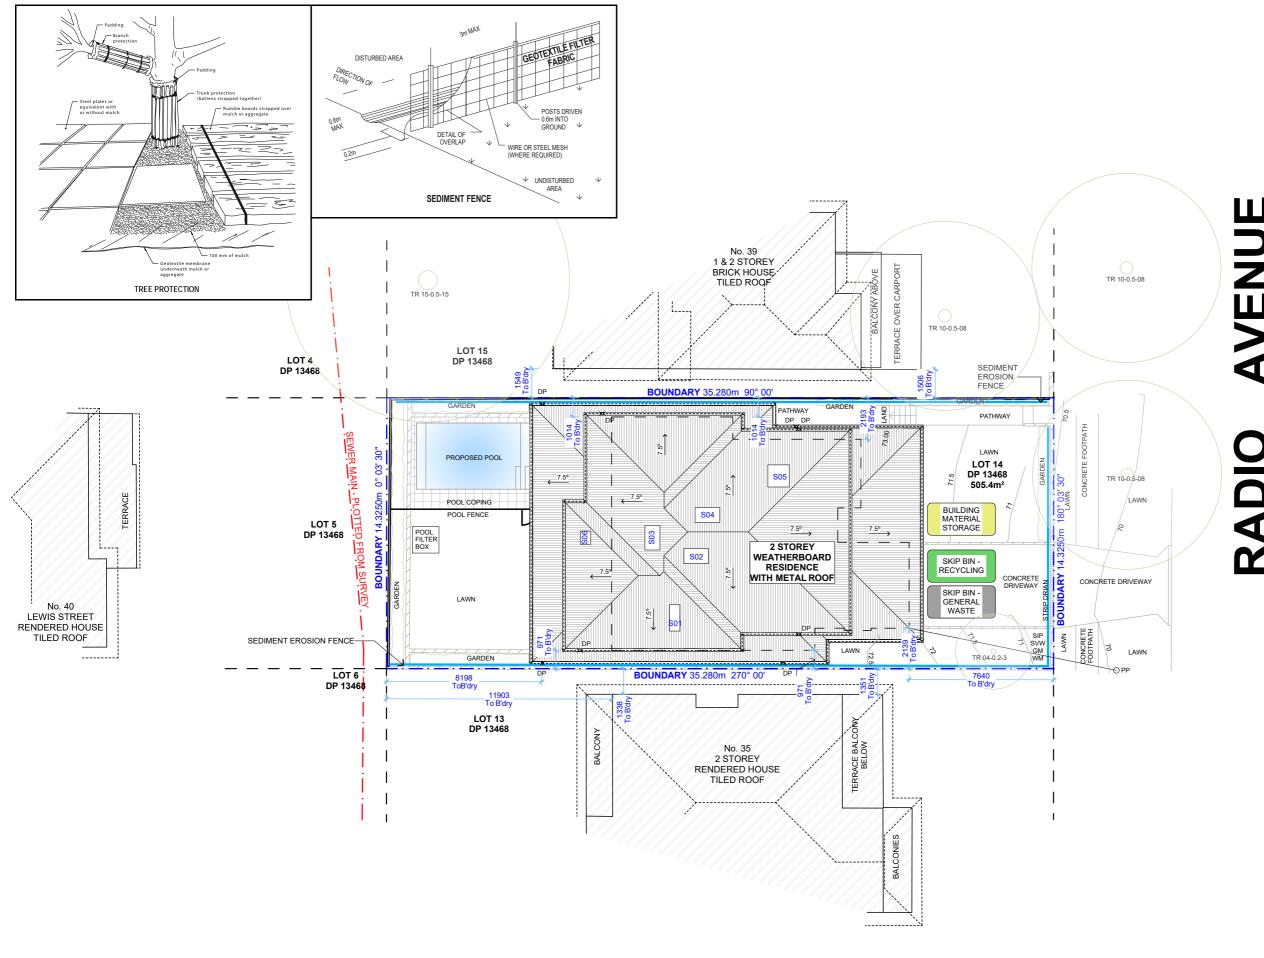

#### **NOTES REGARDING BOUNDARY**

THE INFORMATION SHOWN ON THIS PLAN IS FOR DESIGN PURPOSES ONLY. THE POSITION OF BOUNDARY LINES HAVE BEEN ESTABLISHED BY A SURVEY TO MEET THE IDENTIFICATION REQUIREMENTS FOR COUNCIL AND NOT FOR REGISTRATION WITH THE LAND REGISTRATION SERVICES NSW NOR MAY THIS PLAN BE USED FOR ANY OTHER PURPOSE. SUBSEQUENT REGISTERED OR OTHER SURVEYS MAY AFFECT THE DEFINED BOUNDARY POSITIONS IN THIS AREA. ANY DIFFERENCES OF THIS NATURE ARE BEYOND THE PURPOSES OF THIS PLAN. THIS PLAN IS FOR THE ABOVE STATED PURPOSES ONLY. RESTRICTIONS ON THE TITLE HAVE NOT BEEN INVESTIGATED. IF FURTHER DEVELOPMENT IS CONTEMPLATED OR CONSTRUCTION INTENDED THEN IT IS IMPORTANT THAT A SURVEY SET OUT IS CARRIED OUT.

#### **DUST CONTROL:**

TO REDUCE DUST GENERATED BY WIND ACTION, THE REMOVAL OF THE TOP SOIL IS TO BE MINIMISED. TO PREVENT DUST GENERATION, WATERING DOWN OF THE SITE, ESPECIALLY DURING THE MOVEMENT OF MACHINERY IS REQUIRED. WHERE EXCAVATING INTO ROCK, KEEP THE SURFACE MOIST TO MINIMISE DUST. CONSTRUCT A GRAVEL ENTRY/EXIT POINT USING BLUE METAL AND RESTRICT ALL VEHICLE MOVEMENTS WITHIN THE SITE TO A MINIMUM. ENSURE WIND BREAKS, SUCH AS EXISTING FENCES ARE MAINTAINED DURING THE CONSTRUCTION PHASE UNTIL NEW LANDSCAPING IS PROVIDED OR REINSTATED. PREVENT DUST BY COVERING STOCKPILES

### **SEDIMENT NOTE:**

. ALL EROSION AND SEDIMENT CONTROL MEASURES TO BE INSPECTED AND MAINTAINED DAILY BY THE SITE MANAGER.

. MINIMISE DISTURBED AREAS, REMOVE EXCESS SOIL FROM EXCAVATEDAREA AS SOON AS POSSIBLE. . ALL MATERIAL STOCKPILE TO BE CLEAR FROM DRAINS, GUTTERS AND FOOTPATHS, OR WITHIN SEDIMENT FENCE AREA

. DRAINAGE TO BE CONNECTED TO STORMWATER AS SOON AS POSSIBLE. IF STORED ON SITE, IT MUST BE FILTERED BEFORE RELEASING INTO STORMWATER SYSTEM OR WATERWAYS

5. ROADS AND FOOTPATHS TO BE SWEPT DAILY.

### STOCKPILES:

ALL STOCKPILES ARE TO BE KEPT ON-SITE WHERE POSSIBLE. ANY MATERIALS PLACED ON THE FOOTPATHS OR NATURE STRIPS REQUIRE COUNCIL'S PERMISSION.

ALL STOCKPILES ARE TO BE PLACED AWAY FROM THE DRAINAGE LINES AND STREET GUTTERS. IT IS BEST TO LOCATE THESE ON THE HIGHEST PART OF THE SITE IF POSSIBLE. PLACE WATERPROOF COVERING OVER STOCKPILES.

IF REQUIRED PROVIDE DIVERSION DRAIN & BANK AROUND STOCKPILES.

#### **GUTTER PROTECTION:**

PROVIDE PROTECTION TO DOWNHILL GRATE IN GUTTER BY MEANS OF SAND BAGS OR BLUE METAL WRAPPED IN GEOTEXTILE FABRIC. WHEN SOIL OR SAND BUILDS UP AROUND THIS SEDIMENT BARRIER, THE MATERIAL SHOULD BE RELOCATED BACK TO THE SITE FOR DISPOSAL.

NOTE: ALL PROPOSED STORMWATER TO CONNECT WITH EXISTING

SITE / STORMWATER CONCEPT / WASTE MANAGEMENT / SEDIMENT EROSION PLAN

1:200



**ACTION PLANS** 

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COMMENTS

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					commencement of works.	

DRWN NOTES



CLIENT

2093

**BRIDGET & PHIL** HOLMEWOOD

PROJECT ADDRESS 37 RADIO AVENUE.

BALGOWLAH HEIGHTS

### DRAWING NO.

**DA02** 

# DATE

Thursday, 11 February


## DRAWING NAME

SITE / ROOF / SEDIMENT EROSION / WASTE MANAGEMENT / STORMWATER CONCEPT PLAN

#### **SCALE**

1:200 @A3



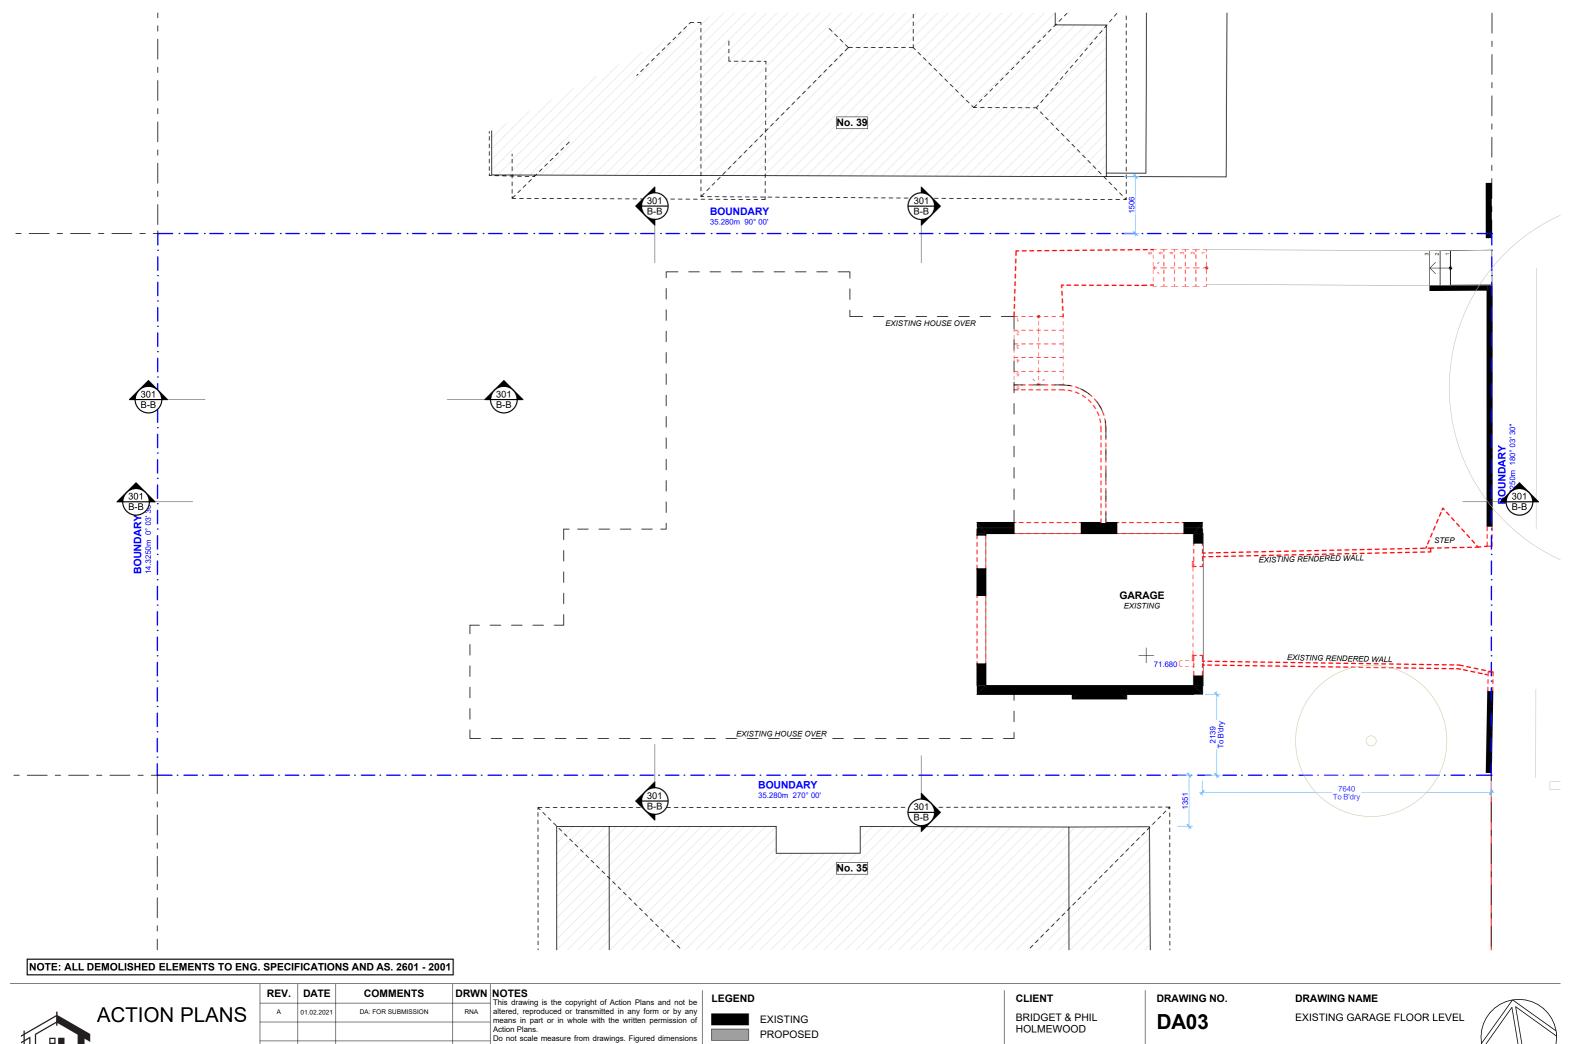

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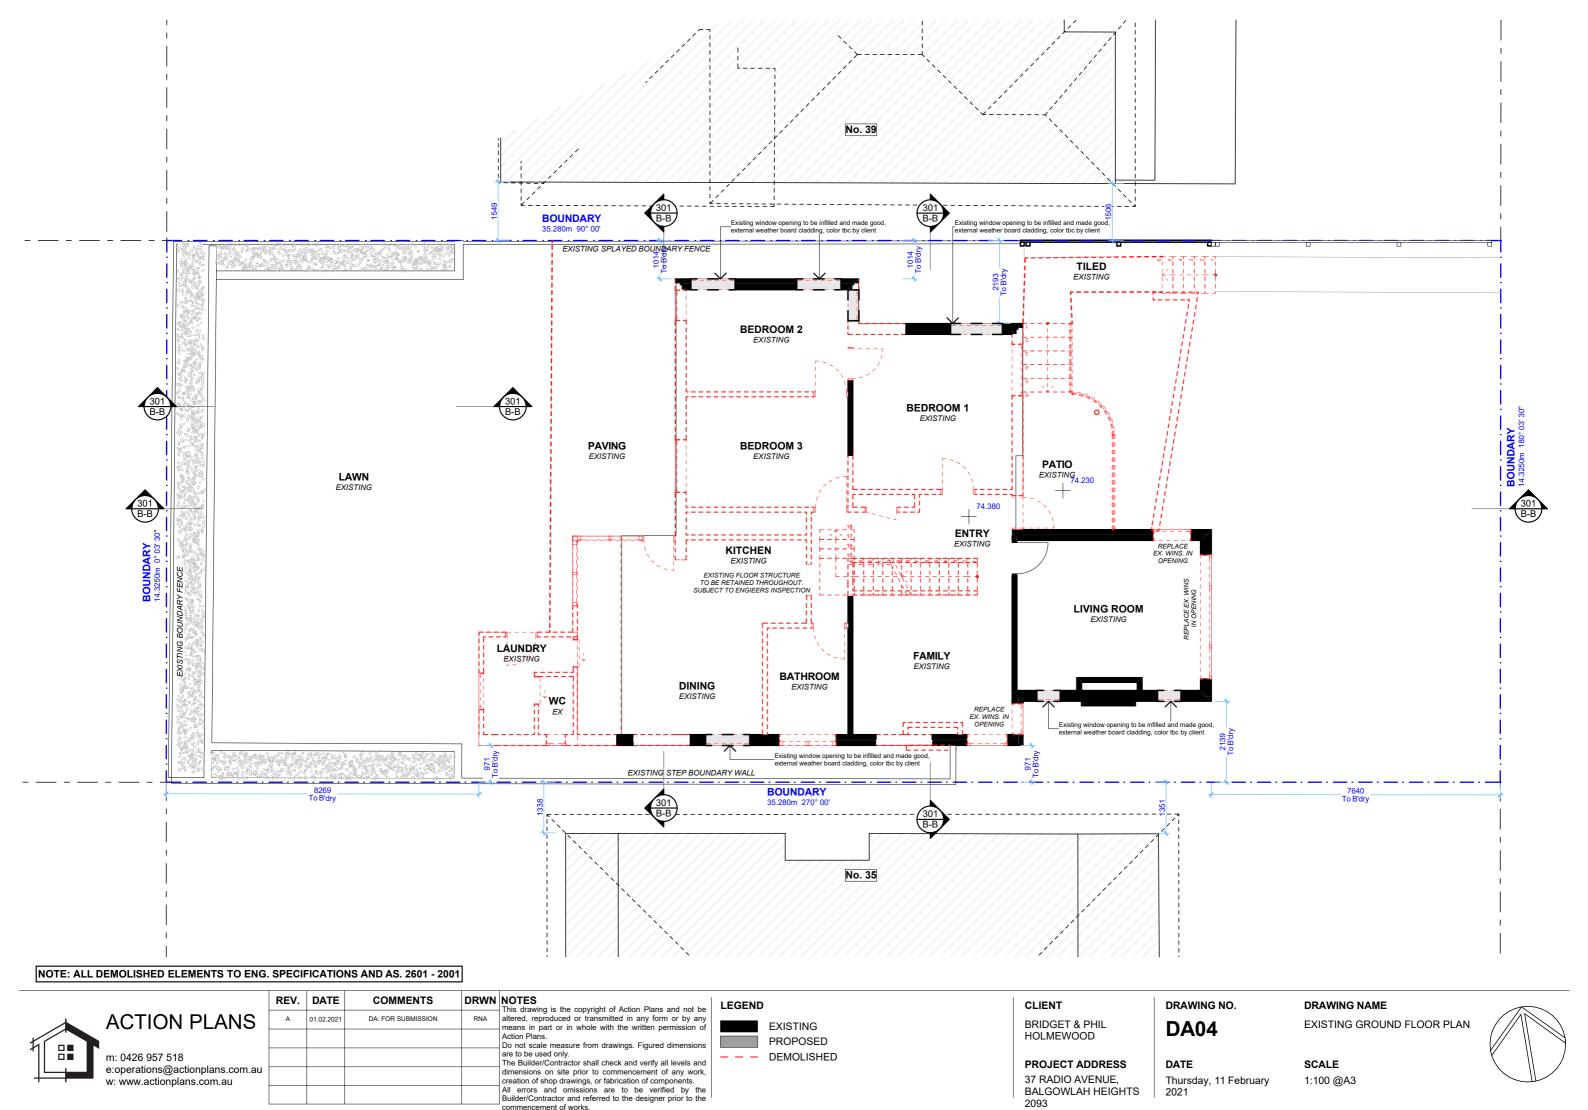
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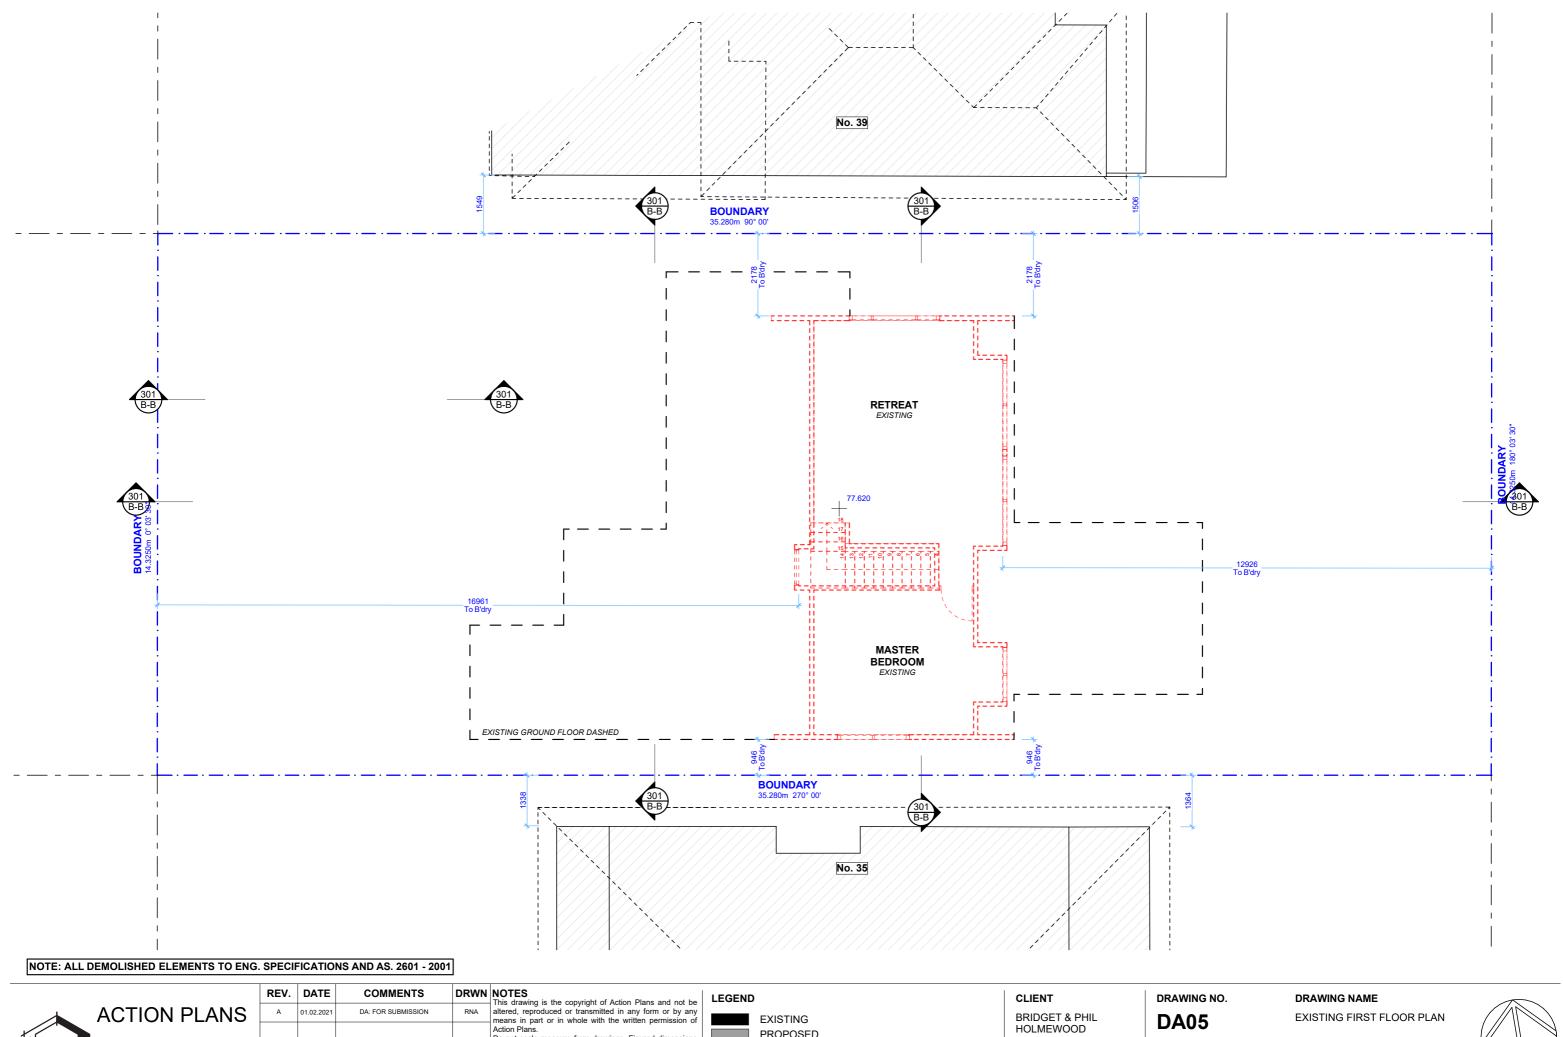
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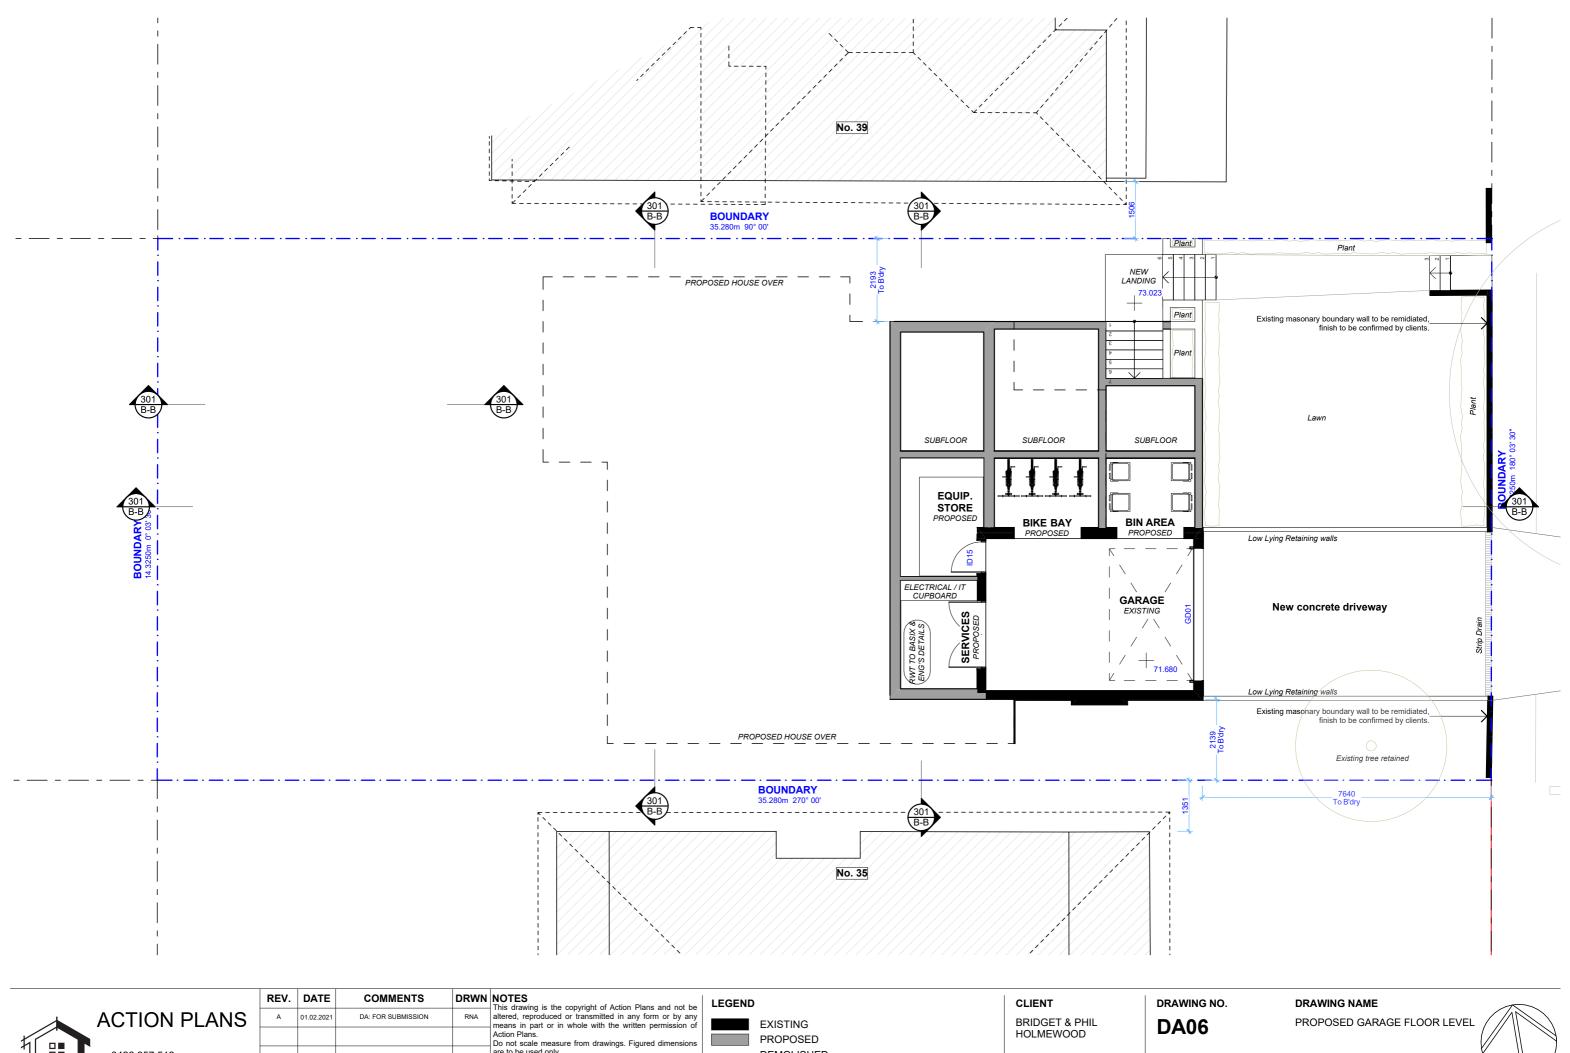
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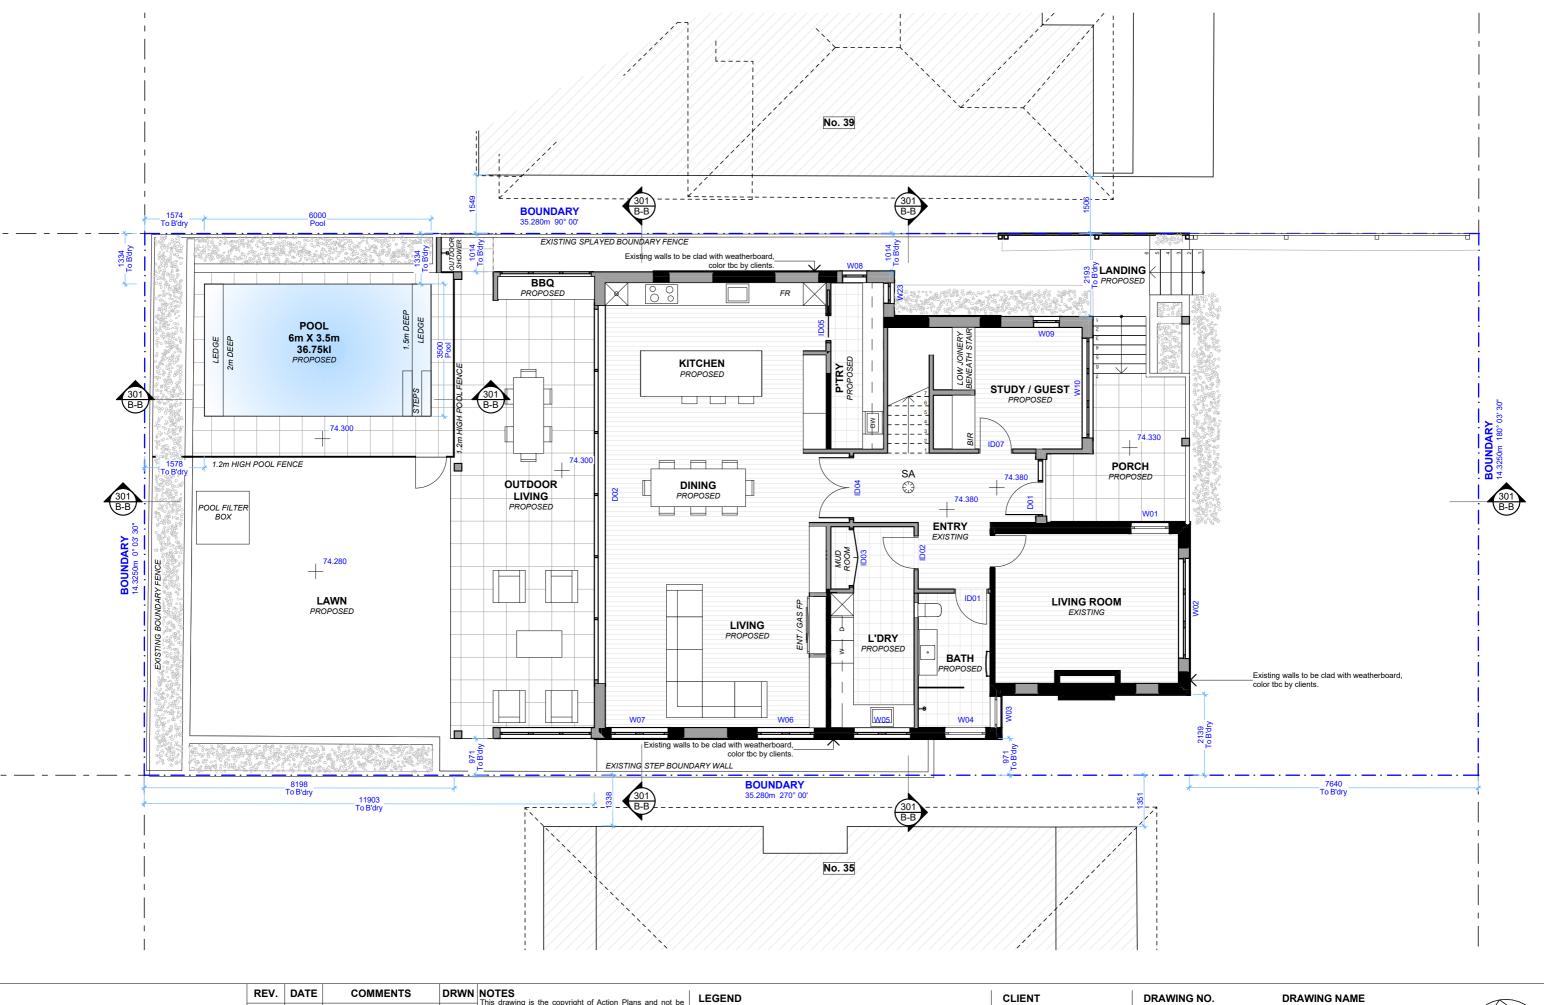
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PROJECT ADDRESS 37 RADIO AVENUE, BALGOWLAH HEIGHTS 2093 7.4WING NO.

2021

DA07

DATE SCALE
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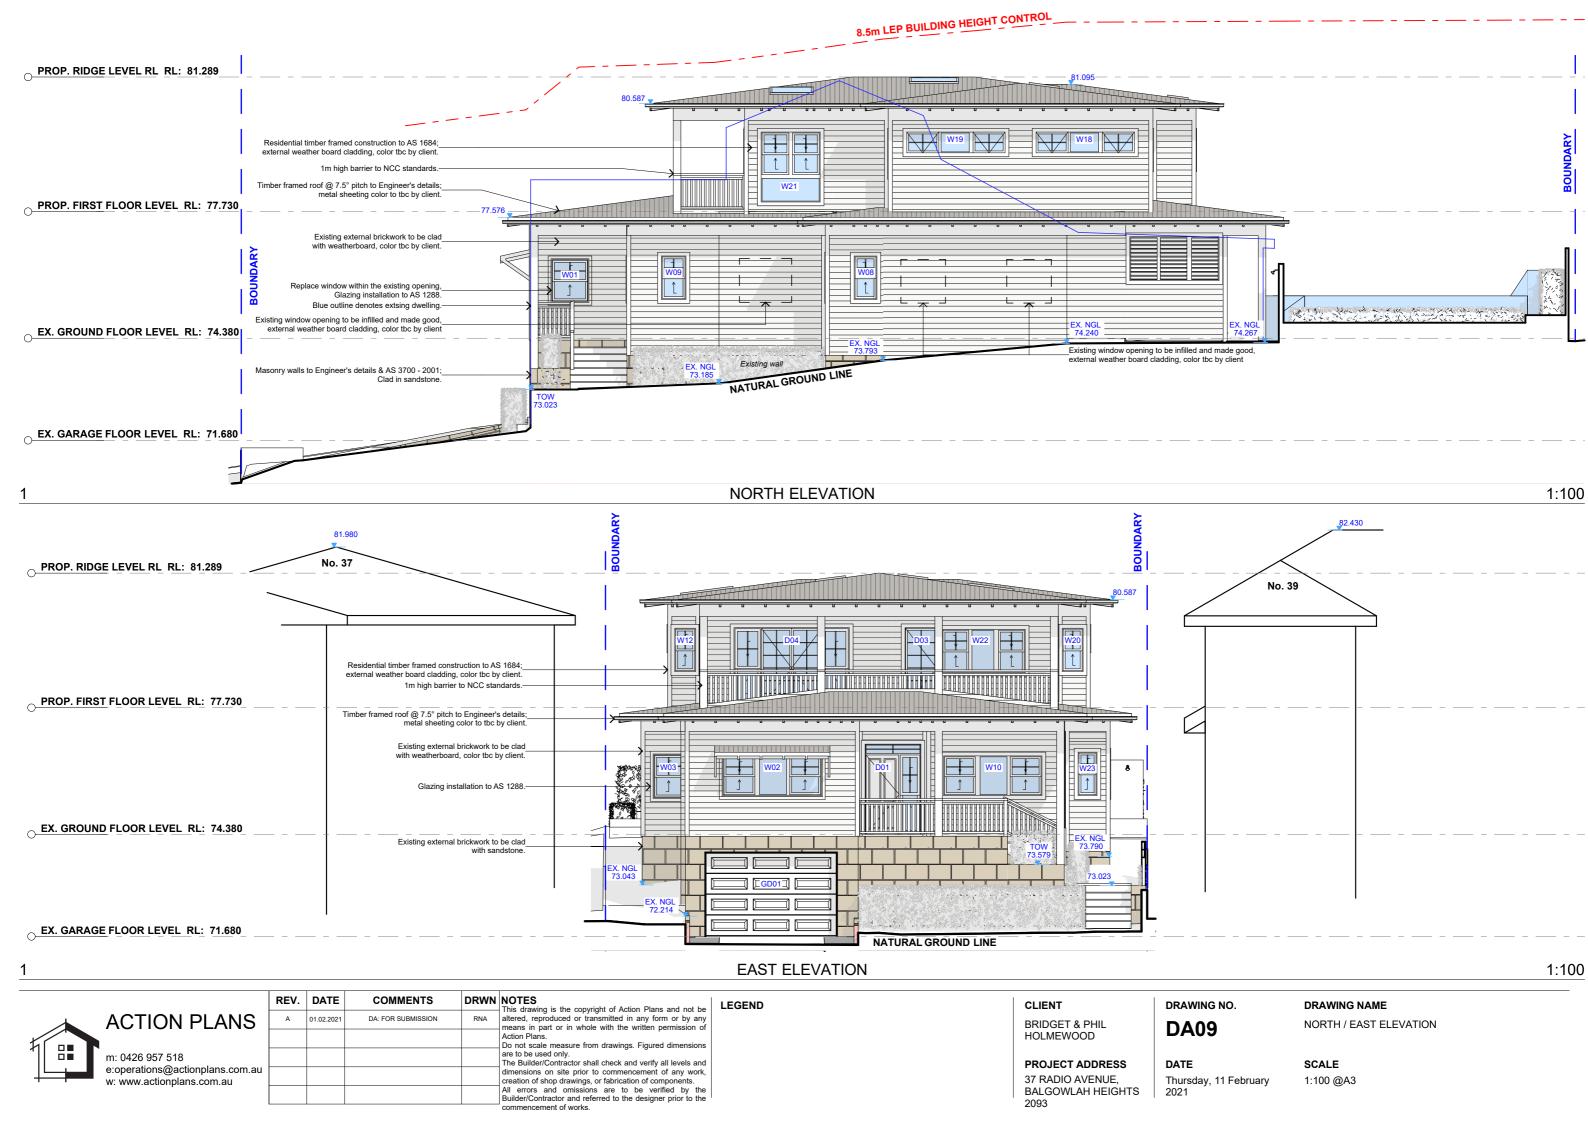
PROJECT ADDRESS 37 RADIO AVENUE, BALGOWLAH HEIGHTS 2093


**DA08** 


DATE Thursday, 11 February 2021 PROPOSED FIRST FLOOR PLAN


SCALE 1:100 @A3






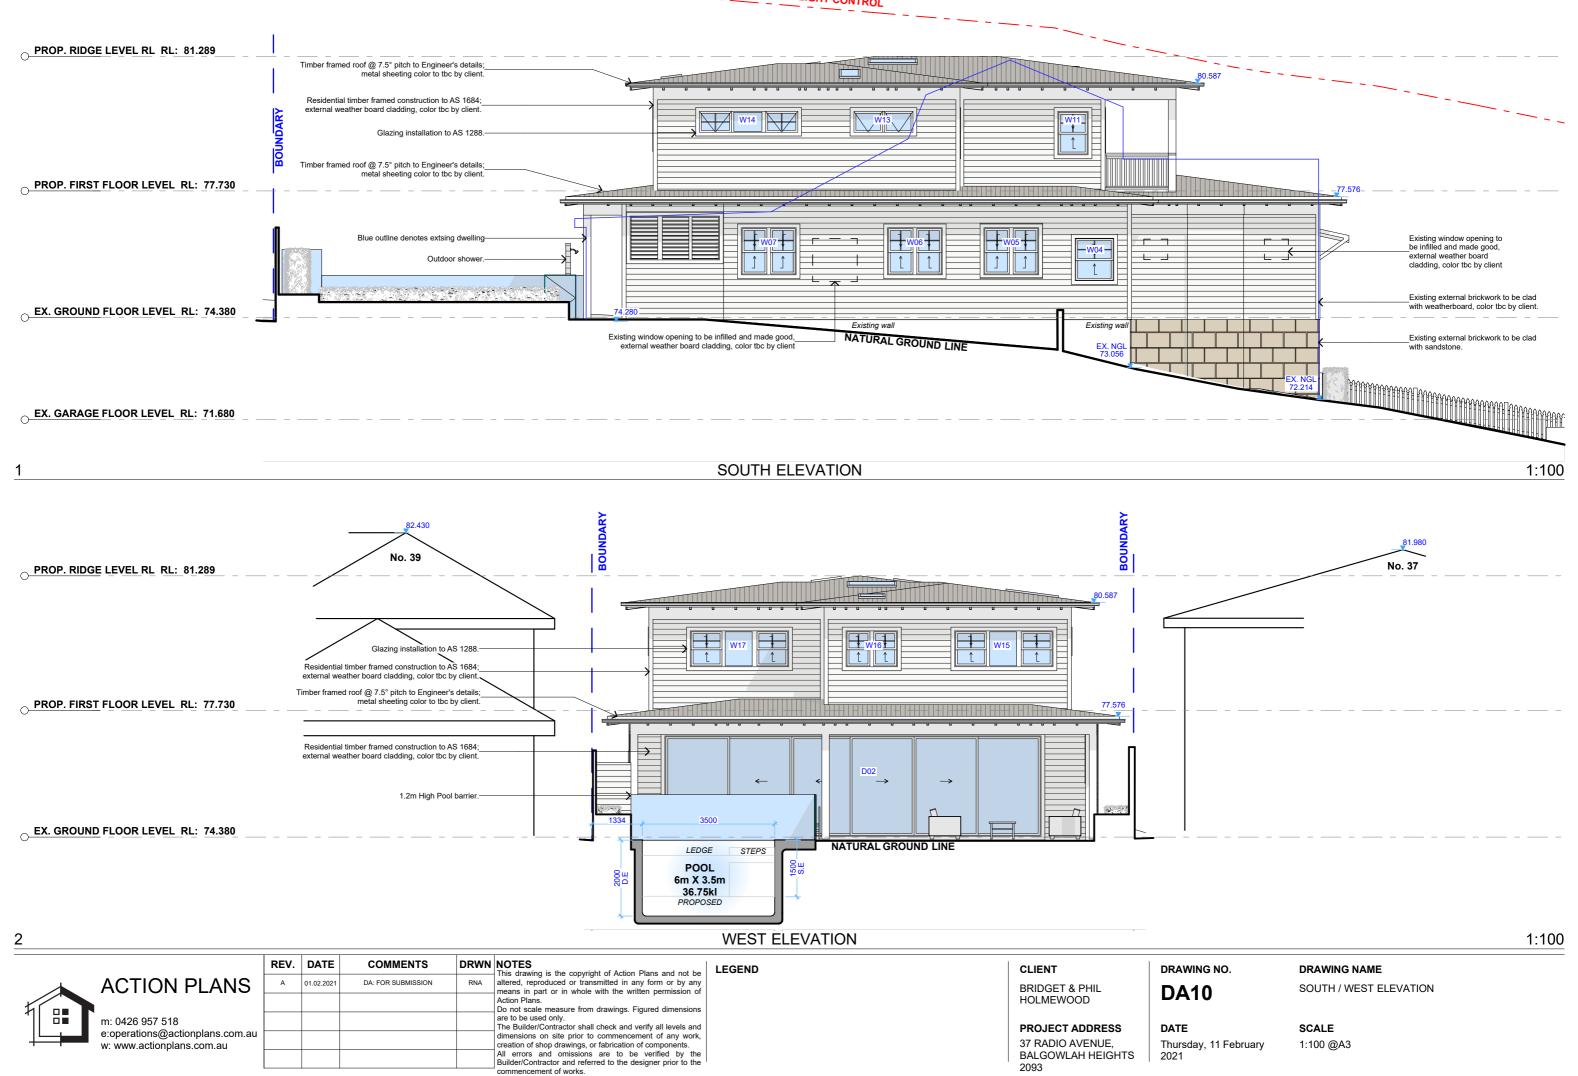

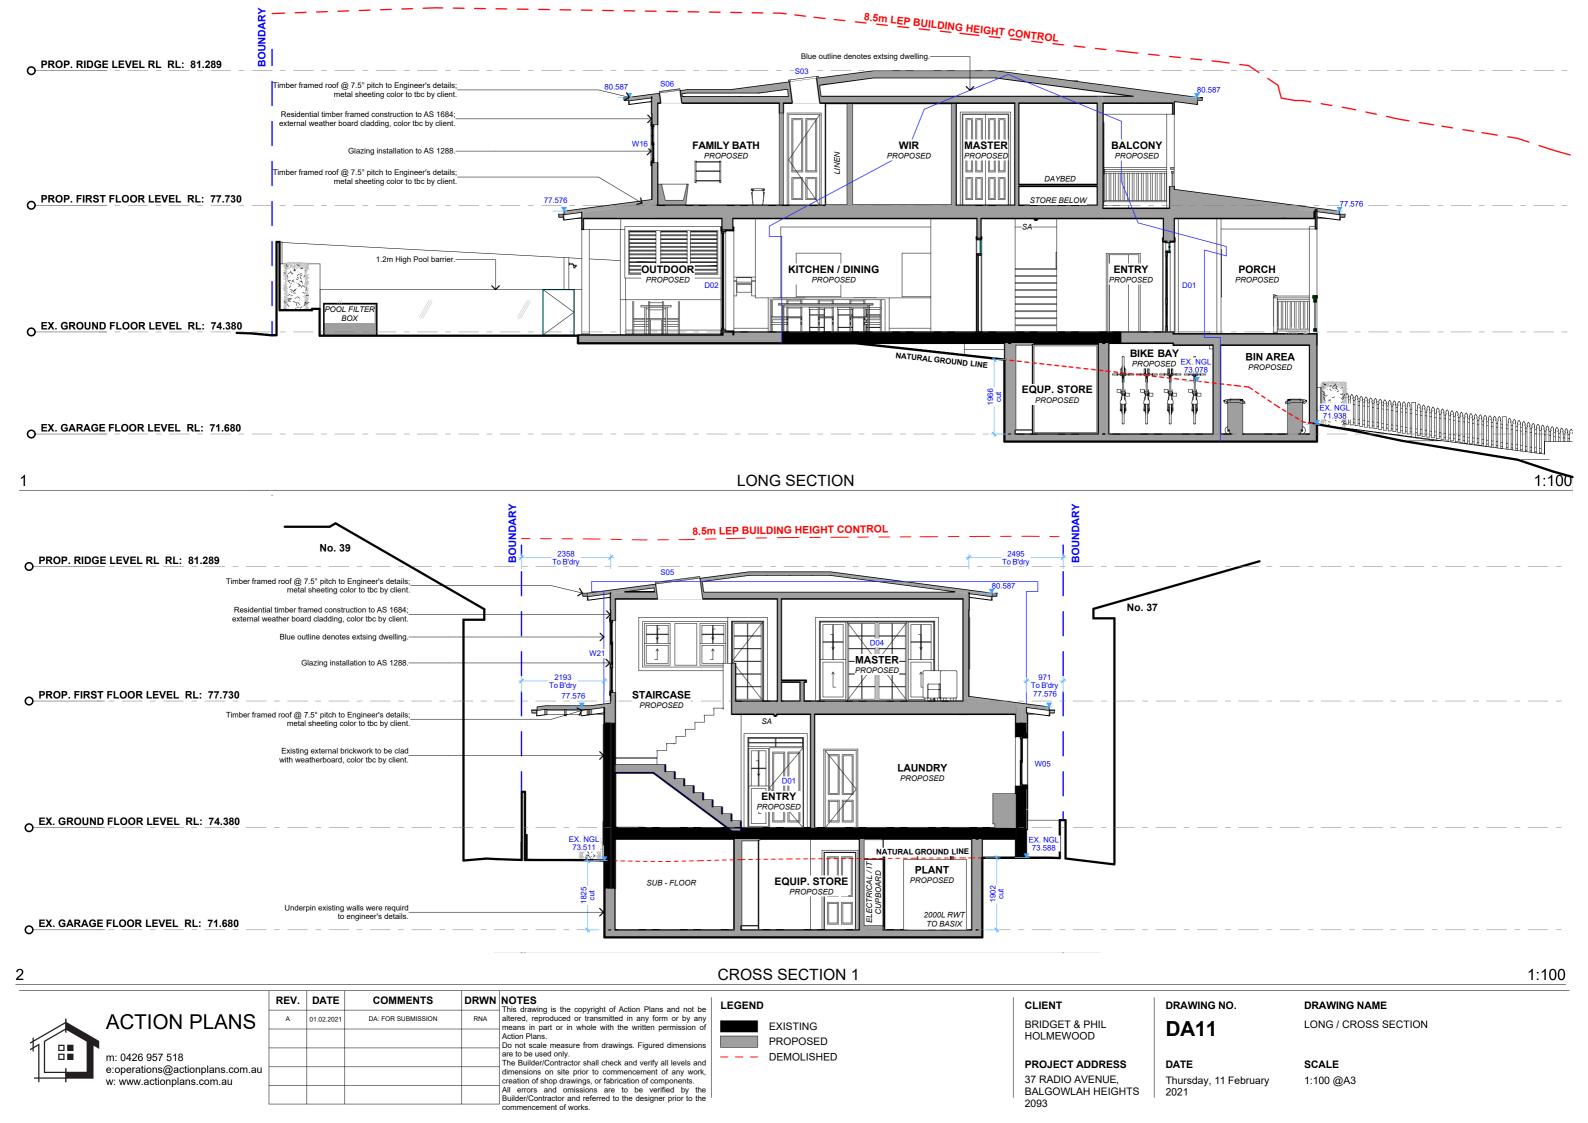

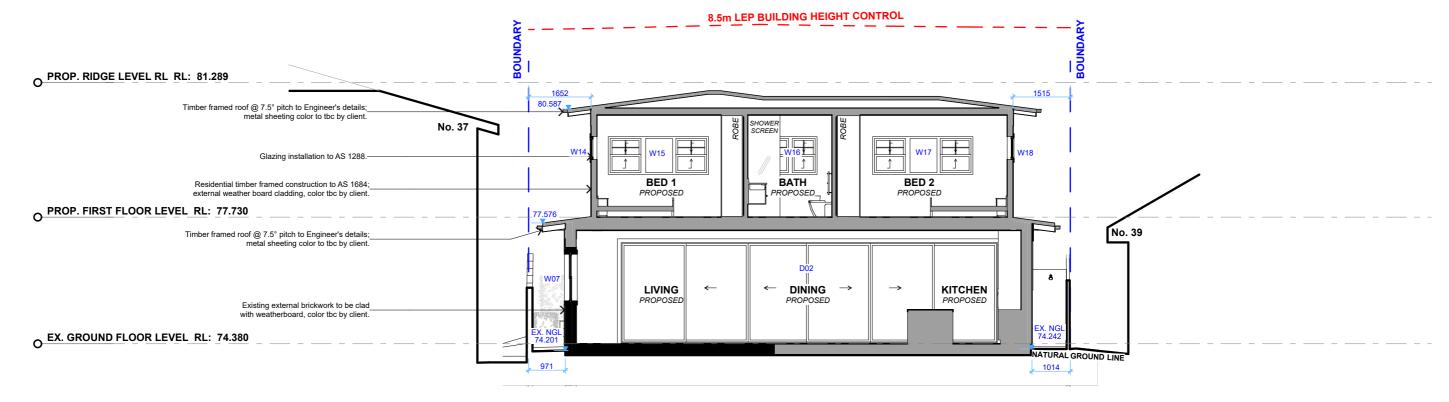

**CROSS SECTION 2** 1:100

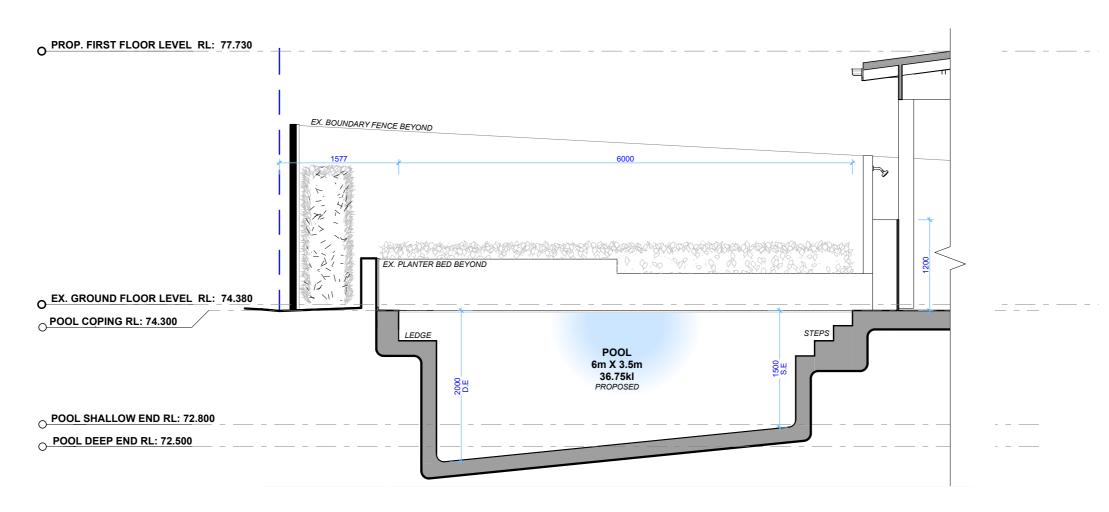

**POOL LONG SECTION** 1:50

**LEGEND** 



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> PROJECT ADDRESS 37 RADIO AVENUE, BALGOWLAH HEIGHTS 2093

DRAWING NO. **DA12** 


2021

Thursday, 11 February

CROSS SECTION 2 & POOL LONG SECTION DATE

SCALE 1:50, 1:100 @A3


DRAWING NAME

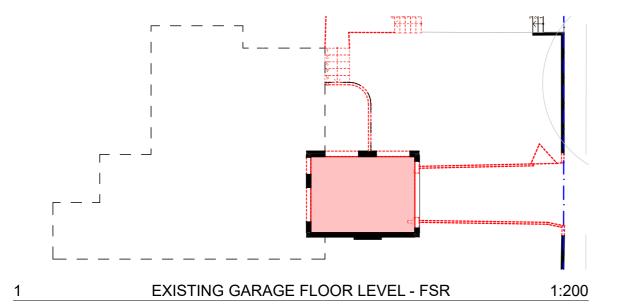


## **CONTROL TABLE** SITE AREA 505.4m<sup>2</sup>

Floor Space Ratio

0.45% (227.43m<sup>2</sup>) Required: (185.04m²) (254.62m²) 0.37% Existing: 50% Proposed:

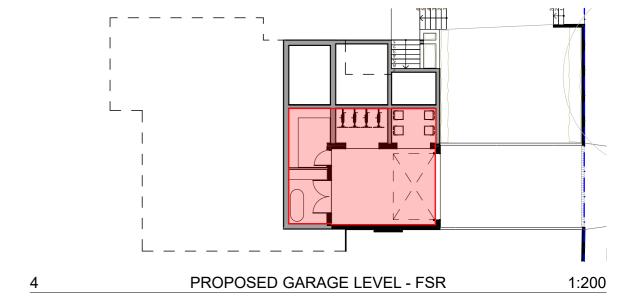



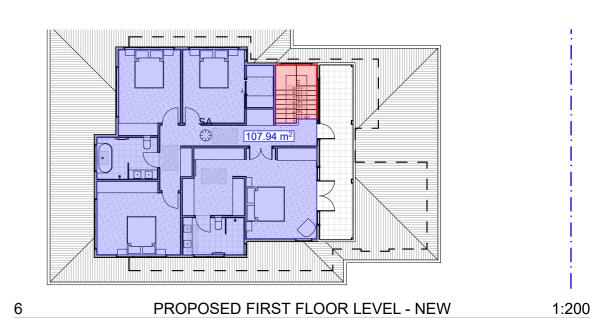

	137.10 m <sup>2</sup>	
2	EXISTING GROUND FLOOR LEVEL - FSR	1:200

EXISTING FIRST FLOOR LEVEL - FSR

REV. DATE COMMENTS DA: FOR SUBMISSION 01.02.2021

LEGEND Do not scale measure norm drawings, inguired uninerasons are to be used only.

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1:200

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NOT INCLUDED IN AREA CALCULATIONS EXISTING AREA CALCULATION PROPOSED AREA CALCULATION

CLIENT

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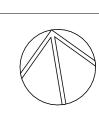
PROJECT ADDRESS 37 RADIO AVENUE. BALGOWLAH HEIGHTS 2093

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**DA13** 

Thursday, 11 February

FLOOR SPACE RATIO CALCULATIONS DATE **SCALE** 



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2021

1:200 @A3

**DRAWING NAME** 



TOTAL OPEN SPACE

SITE AREA: 505.4m<sup>2</sup>

REQ: 55% OF 505.4m² (277.97m²

SITE CALCULATIONS

EX: 53% (266.45m²) PROP: 49% (244.57m²)

LANDSCAPE OPEN SPACE REQ: 35% OF 55% TOS (97.29m²) EX: 88% (233.58m²)

PROP: 64% (156.52m<sup>2</sup>)

PRIVATE OPEN SPACE

REQ: 18m<sup>2</sup> 132.63m<sup>2</sup> PROP: 129.61m<sup>2</sup>

OPEN SPACE ABOVE GROUND

REQ: MAX 25% OF TOS (69.49m²)

EX: 8.57m<sup>2</sup> PROP: 28.71m<sup>2</sup>

PROPOSED SITE CALCULATIONS

1:200



**EXISTING SITE CALCULATIONS** 

1:200

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# LEGEND

TOTAL OPEN SPACE LANDSCAPE OPEN SPACE PRIVATE OPEN SPACE OPEN SPACE ABOVE GROUND

## CLIENT

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# PROJECT ADDRESS

37 RADIO AVENUE, BALGOWLAH HEIGHTS

# **DA14**

DATE

2021

DRAWING NO.


Thursday, 11 February

SCALE




DRAWING NAME SITE CALCULATIONS

1:200 @A3

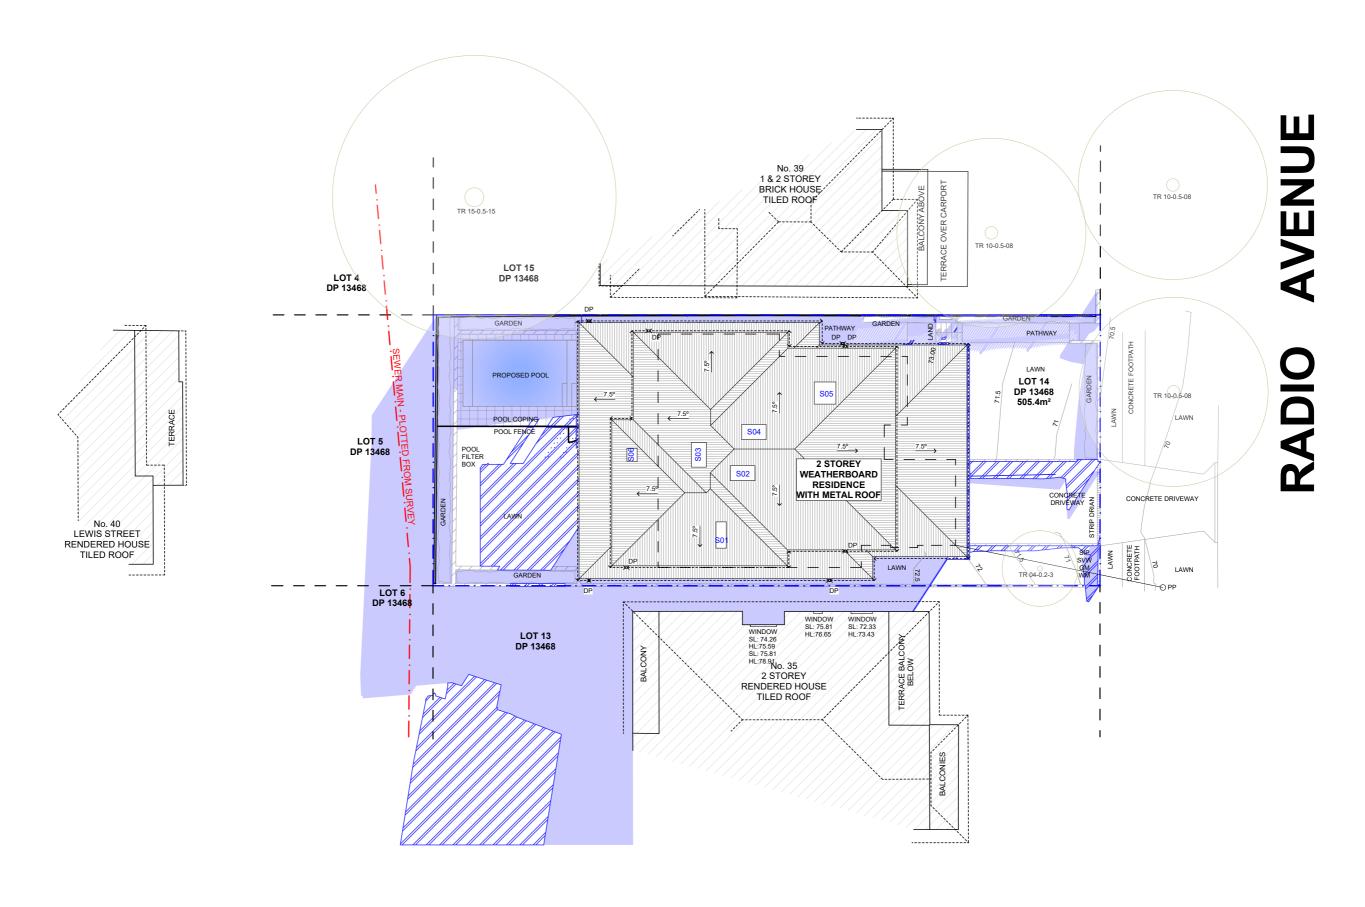



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EXISTING SHADOWS
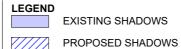
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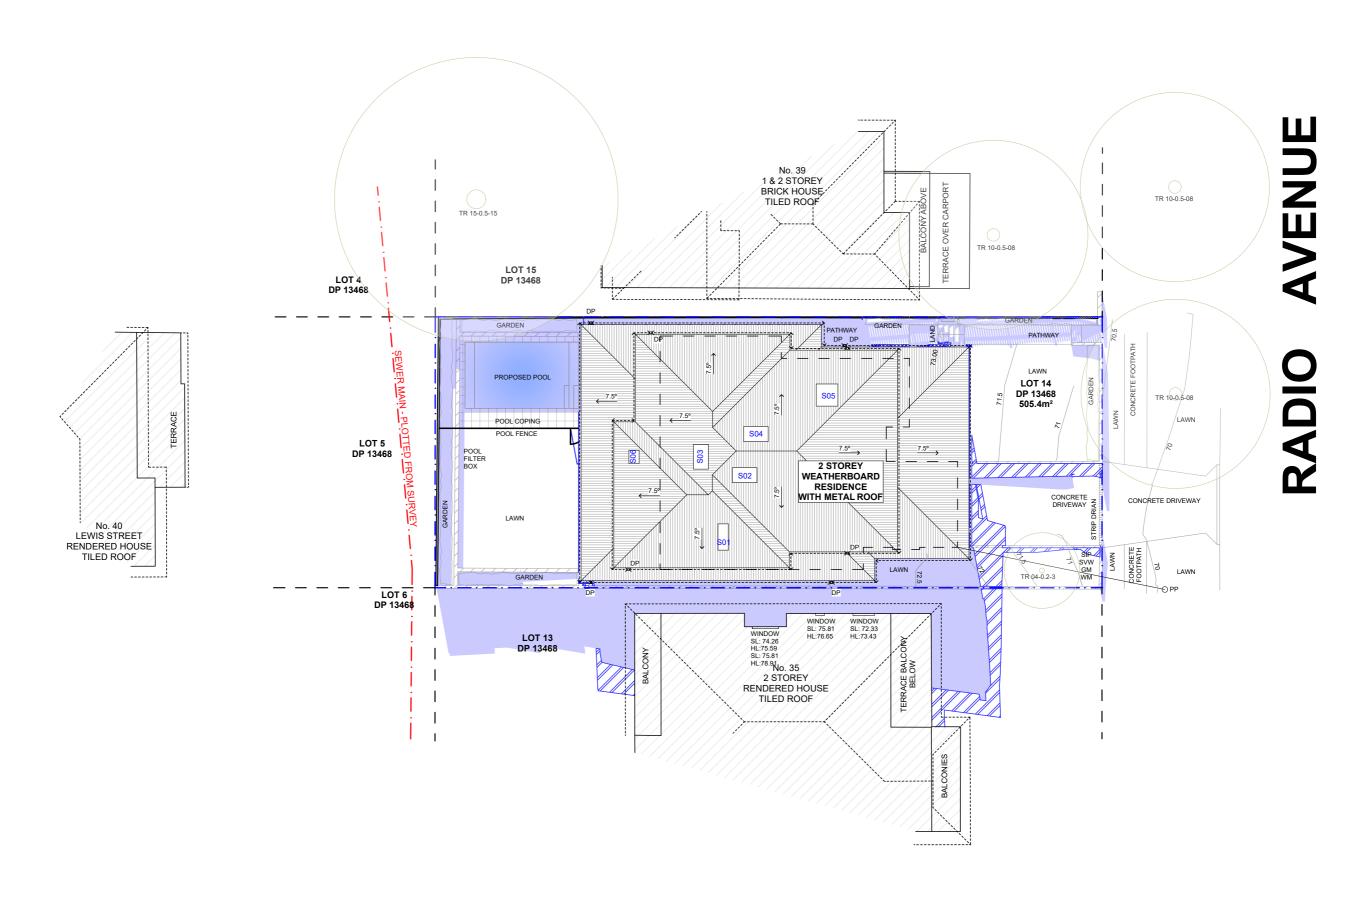
PROJECT ADDRESS 37 RADIO AVENUE, BALGOWLAH HEIGHTS 2093 DRAWING NO.

**DA15** 

1:200 @A3


DATE Thursday, 11 February 2021 DRAWING NAME WINTER SOLSTICE 9 AM SCALE







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BRIDGET & PHIL HOLMEWOOD

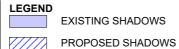PROJECT ADDRESS 37 RADIO AVENUE, BALGOWLAH HEIGHTS 2093

CLIENT


DRAWING NO. **DA16** 

DATE

DRAWING NAME WINTER SOLSTICE 12 PM

SCALE Thursday, 11 February 2021 1:200 @A3



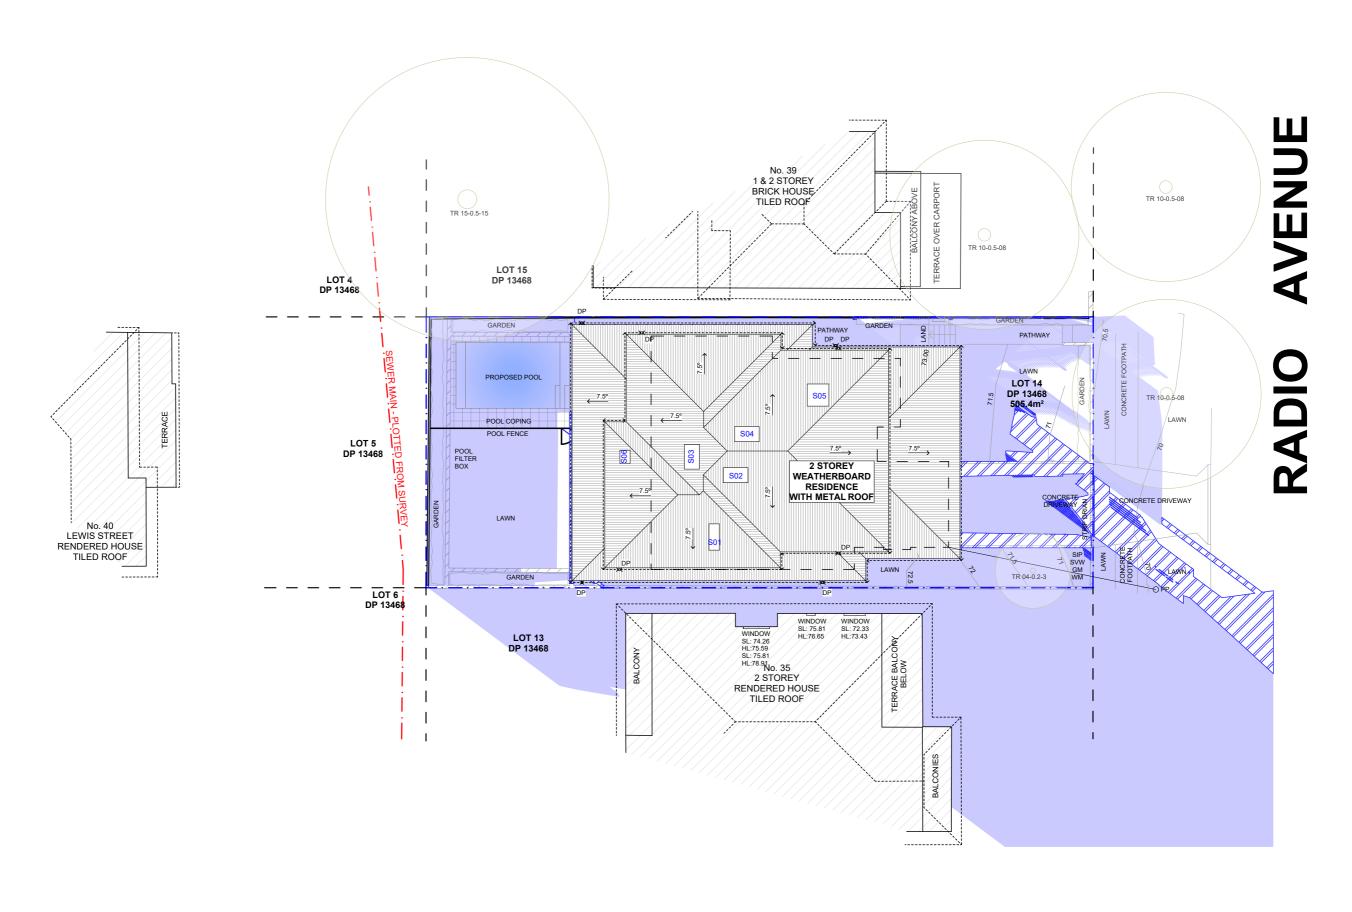



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EXISTING SHADOWS

BRIDGET & PHIL HOLMEWOOD PROPOSED SHADOWS

PROJECT ADDRESS
37 RADIO AVENUE,
BALGOWLAH HEIGHTS
2000

CLIENT

DRAWING NO.

**DA17** 


WINTER SOLSTICE 3 PM DATE

DRAWING NAME








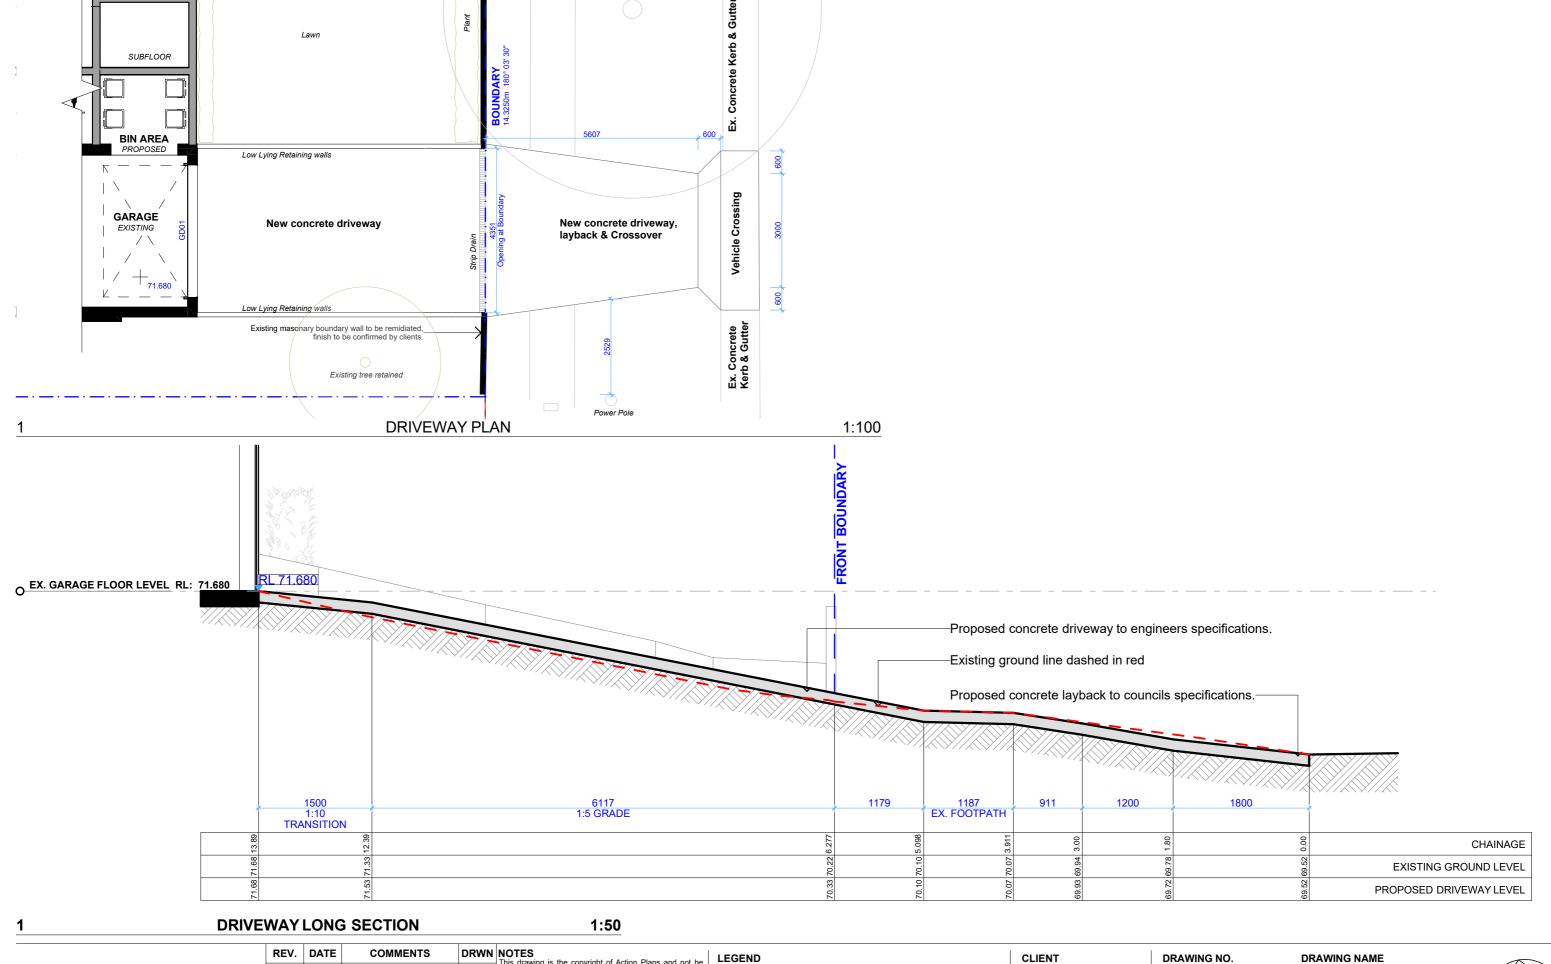



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				dimensions on site prior to commencement of any work, creation of shop drawings, or fabrication of components.
				All errors and omissions are to be verified by the Builder/Contractor and referred to the designer prior to the
				commencement of works.

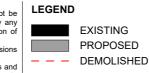

BRIDGET & PHIL HOLMEWOOD

CLIENT

PROJECT ADDRESS 37 RADIO AVENUE, BALGOWLAH HEIGHTS 2093


**DA18** 

Thursday, 11 February

DATE **SCALE** 1:100, 1:50 @A3

DRAWING NAME DRIVEWAY PLAN & LONG SECTION



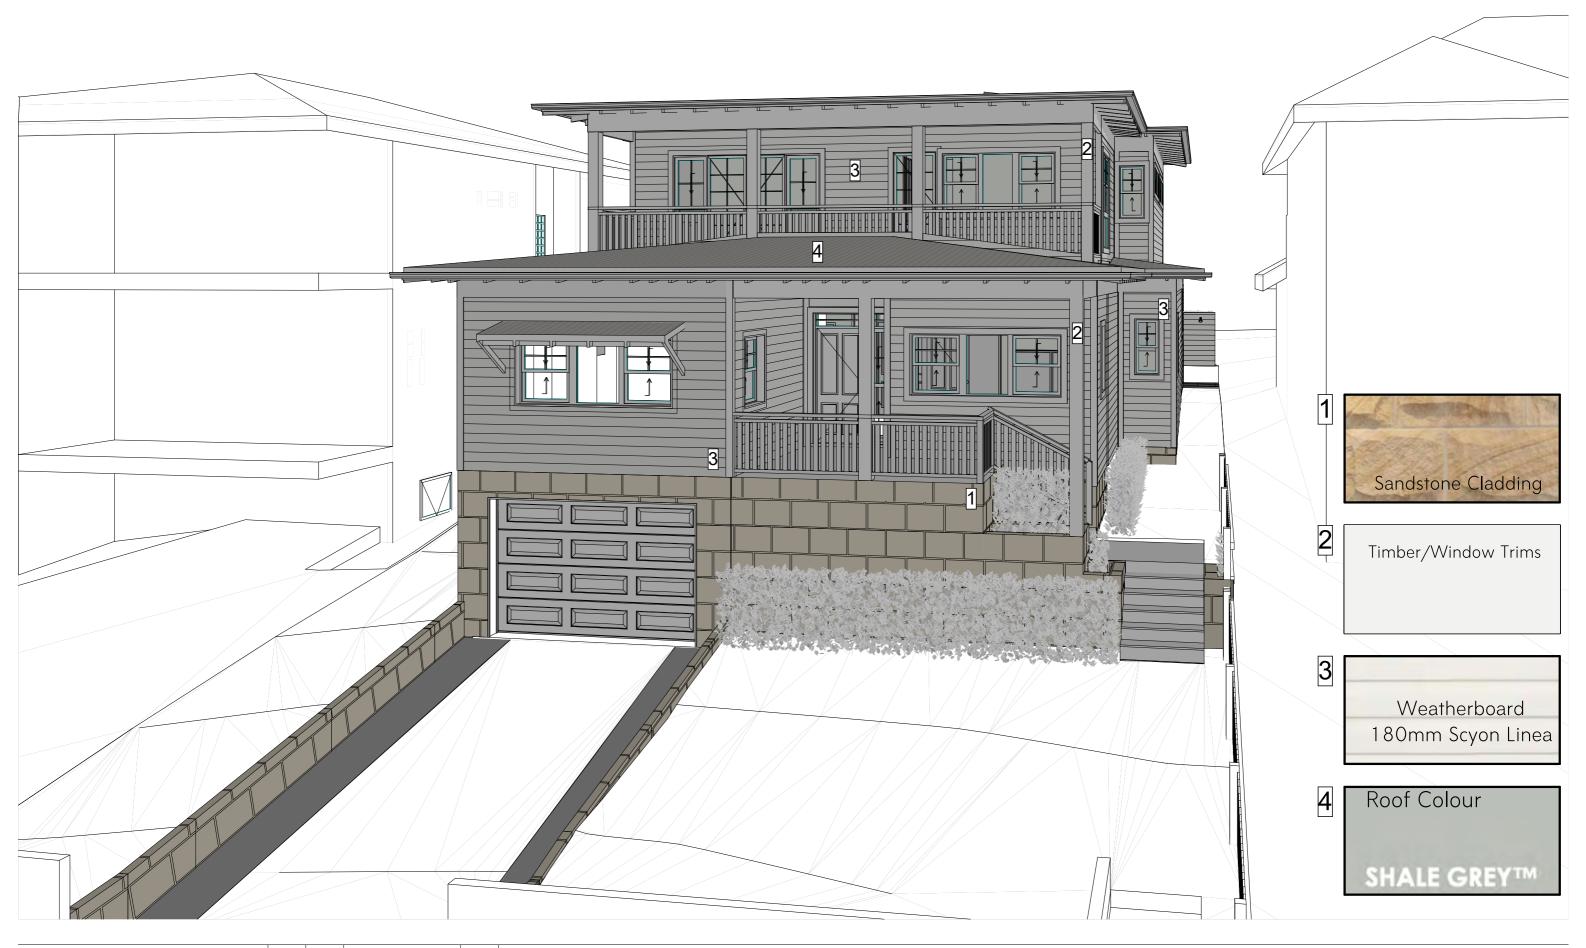



# **ACTION PLANS**

m: 0426 957 518 e:operations@actionplans.com.au w: www.actionplans.com.au

	REV.	DATE	COMMENTS	DRWN	NOTES
ĺ	А	01.02.2021	DA: FOR SUBMISSION	RNA	This drawing is the copyright of Action Plans and not be altered, reproduced or transmitted in any form or by an means in part or in whole with the written permission of
					Action Plans.  Do not scale measure from drawings. Figured dimension:
ı					are to be used only.  The Builder/Contractor shall check and verify all levels and
İ					dimensions on site prior to commencement of any work creation of shop drawings, or fabrication of components.
					All errors and omissions are to be verified by the Builder/Contractor and referred to the designer prior to the
					commencement of works.

## LEGEND

BRIDGET & PHIL HOLMEWOOD

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PROJECT ADDRESS 37 RADIO AVENUE, BALGOWLAH HEIGHTS 2093 DRAWING NO.

**DA19** 

DATE

Thursday, 11 February 2021

DRAWING NAME SAMPLE BOARD

SCALE @A3



Building Sustainability Index www.basix.nsw.gov.au

#### Alterations and Additions

Certificate number: A401989\_02

This certificate confirms that the proposed development will meet the NSW government's requirements for sustainability, if it is built in accordance with the commitments set out below. Terms used in this certificate, or in the commitments, have the meaning given by the document entitled "BASIX Alterations and Additions Definitions" dated 06/10/2017 published by the Department. This document is available at www.basix.nsw.gov.au

Secretary
Date of issue: Monday, 01, February 2021
To be valid, this certificate must be lodged within 3 months of the date of issue.



concrete slab on ground floor. suspended floor with enclosed subfloor: framed (R0.7).

flat ceiling, pitched roof

suspended floor above garage: framed (R0.7). floor above existing dwelling or building. external wall: cavity brick external wall: cavity brick

internal wall shared with garage: single skin masonry (R0.18)

Project name	Copy of 37 Radio Avenue, Balgowlah H_02
Street address	37 Radio Avenue Balgowlah Heights 2093
Local Government Area	Northern Beaches Council
Plan type and number	Deposited Plan 13468
Lot number	14
Section number	
Project type	
Dwelling type	Separate dwelling house
Type of alteration and addition	My renovation work is valued at \$50,000 or mo and includes a pool (and/or spa).

ABN (if applicable): 17118297587

Pool and Spa	Show on DA Plans	Show on CC/CDC Plans & specs	Certifier Check
Rainwater tank			
The applicant must install a rainwater tank of at least 1071 litres on the site. This rainwater tank must meet, and be installed in accordance with, the requirements of all applicable regulatory authorities.	<b>✓</b>	~	<b>✓</b>
The applicant must configure the rainwater tank to collect rainwater runoff from at least 50 square metres of roof area.		<b>✓</b>	✓
The applicant must connect the rainwater tank to a tap located within 10 metres of the edge of the pool.		~	✓
Outdoor swimming pool	•		
The swimming pool must be outdoors.	✓	~	✓
The swimming pool must not have a capacity greater than 35 kilolitres.	✓	<b>✓</b>	✓
The swimming pool must have a pool cover.		<b>✓</b>	✓
The applicant must install a pool pump timer for the swimming pool.		✓	✓
The applicant must install the following heating system for the swimming pool that is part of this development: electric heat pump.		~	✓

Fixtures and systems	Show on DA Plans	Show on CC/CDC Plans & specs	Certifier Check
Lighting			
The applicant must ensure a minimum of 40% of new or altered light fixtures are fitted with fluorescent, compact fluorescent, or light-emitting-diode (LED) lamps.		~	~
Fixtures	•		
The applicant must ensure new or altered showerheads have a flow rate no greater than 9 litres per minute or a 3 star water rating.		<b>✓</b>	✓
The applicant must ensure new or altered toilets have a flow rate no greater than 4 litres per average flush or a minimum 3 star water rating.		~	V
The applicant must ensure new or altered taps have a flow rate no greater than 9 litres per minute or minimum 3 star water rating.		✓	
Construction	Show on DA Plans	Show on CC/CDC Plans & specs	Certifier Check
Insulation requirements			
The applicant must construct the new or altered construction (floor(s), walls, and ceilings/roofs) in accordance with the specifications listed in the table below, except that a) additional insulation is not required where the area of new construction is less than 2m2, b) insulation specified is not required for parts of altered construction where insulation already exists.	<b>✓</b>	<b>✓</b>	<b>✓</b>
	1		

R0.60 (down) (or R1.30 including

ceiling: R3.00 (up), roof: foil/sarking

	requirements						Show on DA Plans	Show on CC/CDC Plans & specs	Certifier Check
Windows	and glazed do	ors				·			
					hading devices, in accordance with r each window and glazed door.	the specifications listed in the table below.	<b>✓</b>	<b>✓</b>	<b>✓</b>
The follow	ing requirements	must also	be satisfic	ed in relation	n to each window and glazed door:			✓	<b>✓</b>
have a U-v	value and a Solar	Heat Gair	n Coefficie	ent (SHGC)		ed glass may either match the description, or, le below. Total system U-values and SHGCs s.		~	~
					f each eave, pergola, verandah, bal than 2400 mm above the sill.	cony or awning must be no more than 500 mm	<b>✓</b>	✓	<b>✓</b>
Pergolas v	with polycarbonate	e roof or s	imilar tran	slucent mate	erial must have a shading coefficien	nt of less than 0.35.		✓	<b>✓</b>
								,	
					e window or glazed door above whi ens must not be more than 50 mm.	ch they are situated, unless the pergola also			~
shades a p		dow. The	spacing b	etween batte	ens must not be more than 50 mm.			~	_
shades a p	perpendicular win	dow. The	spacing b	etween batte equireme	ens must not be more than 50 mm.		_	•	*
window Window Window / no.	perpendicular win	dow. The doors g Area of glass inc. frame	lazing ro Oversha Height	etween batte equireme dowing Distance	ens must not be more than 50 mm.  nts			v	v
window /	perpendicular wind s and glazed of door Orientation	dow. The doors g Area of glass inc. frame (m2)	lazing re Oversha Height (m)	equireme dowing Distance (m)	ens must not be more than 50 mm.  nts  Shading device  eave/verandah/pergola/balcony	Frame and glass type  timber or uPVC, single clear, (or U-value:		*	*
window / no.	perpendicular wings and glazed of door Orientation	dow. The doors g Area of glass inc. frame (m2) 1.15	lazing ro Oversha Height (m)	equireme dowing Distance (m)	ens must not be more than 50 mm.  nts  Shading device  eave/verandah/pergola/balcony =900 mm  eave/verandah/pergola/balcony	Frame and glass type  timber or uPVC, single clear, (or U-value: 5.71, SHGC: 0.66) timber or uPVC, single clear, (or U-value:		*	v
window / no.  W1  W2	perpendicular winders and glazed of door Orientation  N  E	dow. The doors g Area of glass inc. frame (m2) 1.15 2.915	Spacing billazing recovershat (m)	etween battreequireme dowing Distance (m)  0	ens must not be more than 50 mm.  Its  Shading device  eave/verandah/pergola/balcony >=900 mm  eave/verandah/pergola/balcony >=750 mm  eave/verandah/pergola/balcony	Frame and glass type  timber or uPVC, single clear, (or U-value: 5.71, SHGC: 0.66)  timber or uPVC, single clear, (or U-value: 5.71, SHGC: 0.66)  timber or uPVC, single clear, (or U-value: 0.71)		*	v

Glazing red	quirements						Show on DA Plans	Show on CC/CDC Plans & specs	Certifier Check
Window / do	or Orientation	Area of glass inc. frame (m2)	Oversha Height (m)	Distance (m)	Shading device	Frame and glass type			
W6	S	1.94	0	0	eave/verandah/pergola/balcony >=750 mm	timber or uPVC, single clear, (or U-value: 5.71, SHGC: 0.66)			
W7	S	1.94	0	0	eave/verandah/pergola/balcony >=750 mm	timber or uPVC, single clear, (or U-value: 5.71, SHGC: 0.66)			
W8	N	0.78	0	0	eave/verandah/pergola/balcony >=750 mm	timber or uPVC, single clear, (or U-value: 5.71, SHGC: 0.66)			
W9	N	0.84	0	0	eave/verandah/pergola/balcony >=750 mm	timber or uPVC, single clear, (or U-value: 5.71, SHGC: 0.66)			
W10	E	2.95	0	0	eave/verandah/pergola/balcony >=750 mm	timber or uPVC, single clear, (or U-value: 5.71, SHGC: 0.66)			
W11	S	1.02	0	0	eave/verandah/pergola/balcony >=750 mm	timber or uPVC, single clear, (or U-value: 5.71, SHGC: 0.66)			
W12	E	0.72	0	0	eave/verandah/pergola/balcony >=750 mm	timber or uPVC, single clear, (or U-value: 5.71, SHGC: 0.66)			
W13	S	0.97	0	0	eave/verandah/pergola/balcony >=750 mm	timber or uPVC, single clear, (or U-value: 5.71, SHGC: 0.66)			
W14	S	1.59	0	0	eave/verandah/pergola/balcony >=750 mm	timber or uPVC, single clear, (or U-value: 5.71, SHGC: 0.66)			
W15	W	2.65	0	0	eave/verandah/pergola/balcony >=750 mm	timber or uPVC, single clear, (or U-value: 5.71, SHGC: 0.66)			
W16	w	1.41	0	0	eave/verandah/pergola/balcony >=750 mm	timber or uPVC, single clear, (or U-value: 5.71, SHGC: 0.66)			
W17	w	2.65	0	0	eave/verandah/pergola/balcony >=750 mm	timber or uPVC, single clear, (or U-value: 5.71, SHGC: 0.66)			
W18	N	1.59	0	0	eave/verandah/pergola/balcony >=750 mm	timber or uPVC, single clear, (or U-value: 5.71, SHGC: 0.66)			

Glazing requ	irements						Show on DA Plans	Show on CC/CDC Plans & specs	Certifier Check
Window / door no.	Orientation	Area of glass inc. frame (m2)	Oversha Height (m)	Distance (m)	Shading device	Frame and glass type			
W19	N	1.59	0	0	eave/verandah/pergola/balcony >=750 mm	timber or uPVC, single clear, (or U-value: 5.71, SHGC: 0.66)			
W20	E	0.72	0	0	eave/verandah/pergola/balcony >=750 mm	timber or uPVC, single clear, (or U-value: 5.71, SHGC: 0.66)			
W21	N	3.06	0	0	eave/verandah/pergola/balcony >=750 mm	timber or uPVC, single clear, (or U-value: 5.71, SHGC: 0.66)			
W22	E	2.7	0	0	eave/verandah/pergola/balcony >=750 mm	timber or uPVC, single clear, (or U-value: 5.71, SHGC: 0.66)			
D01	E	3.6	0	0	eave/verandah/pergola/balcony >=900 mm	timber or uPVC, single clear, (or U-value: 5.71, SHGC: 0.66)			
D02	W	27	0	0	eave/verandah/pergola/balcony >=900 mm	timber or uPVC, single clear, (or U-value: 5.71, SHGC: 0.66)			
D03	E	1.72	0	0	eave/verandah/pergola/balcony >=900 mm	timber or uPVC, single clear, (or U-value: 5.71, SHGC: 0.66)			
D04	E	6.45	0	0	eave/verandah/pergola/balcony >=900 mm	timber or uPVC, single clear, (or U-value: 5.71, SHGC: 0.66)			
W23	E	0.66	0	0	eave/verandah/pergola/balcony >=750 mm	timber or uPVC, single clear, (or U-value: 5.71, SHGC: 0.66)			
Skylights						<u>.</u>			-
The applicant m	nust install th	e skylight	s in accor	dance with t	he specifications listed in the table l	below.	<b>✓</b>	<b>✓</b>	<b>✓</b>
The following re	equirements	must also	be satisfi	ed in relation	to each skylight:			✓	<b>✓</b>
Each skylight m the table below		atch the de	escription,	, or, have a l	J-value and a Solar Heat Gain Coel	fficient (SHGC) no greater than that listed in		✓	<b>✓</b>

Glazing require	ements			Show on DA Plans	Show on CC/CDC Plans & specs	Certifie Check
Skylights glaz	ing requiremer	nts		_		
Skylight number	Area of glazing inc. frame (m2)	Shading device	Frame and glass type			
S1	1.04	no shading	timber, low-E internal/argon fill/clear external, (or U-value: 2.5, SHGC: 0.456)			
S2	1.04	no shading	timber, low-E internal/argon fill/clear external, (or U-value: 2.5, SHGC: 0.456)			
S3	1.04	no shading	timber, low-E internal/argon fill/clear external, (or U-value: 2.5, SHGC: 0.456)			
S4	1.04	no shading	timber, low-E internal/argon fill/clear external, (or U-value: 2.5, SHGC: 0.456)			
S5	1.35	no shading	timber, low-E internal/argon fill/clear external, (or U-value: 2.5, SHGC: 0.456)			

Logona
In these commitments, "applicant" means the person carrying out the development.

Commitments identified with a "\sqrt^" in the "Show on DA plans" column must be shown on the plans accompanying the development application for the proposed development (if a development application is to be lodged for the proposed development).

Commitments identified with a "\" in the "Show on CC/CDC plans & specs" column must be shown in the plans and specifications accompanying the application for a construction certificate / complying development certificate for the proposed development.

Commitments identified with a " $\sqrt{\phantom{a}}$ " in the "Certifier check" column must be certified by a certifying authority as having been fulfilled, before a final occupation certificate for the development may be issued.



	REV.	DATE	COMMENTS	DRWN
ľ	Α	01.02.2021	DA: FOR SUBMISSION	RNA
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medium (solar absorptance 0.475 - 0.70)

NOTES

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The Builder/Contractor shall check and verify all levels and dimensions on site prior to commencement of any work, creation of shop drawings, or fabrication of components.

All errors and omissions are to be verified by the Builder/Contractor and referred to the designer prior to the commencement of works.

All window & door dimensions, orientation, glazing materials, opening types, frame types are to be confirmed by a suitably qualified person prior to the ordering of any such materials are to take place.

U value takes precedence over glazing type/colour in all cases.

all new glazing must meet the BASIX specified frame and glass type, *QR* meet the ecified U value and SHGC value.

CLIENT

**BRIDGET & PHIL** HOLMEWOOD

PROJECT ADDRESS 37 RADIO AVENUE. BALGOWLAH HEIGHTS 2093

DRAWING NO. **DA20** 

DRAWING NAME BASIX COMMITMENTS

DATE

Thursday, 11 February 2021