

CONJUNCTION WITH THE CONDITIONS OF DEVELOPMEN DA2019/0078

MRS. P SIMSON 17 PLAYFAIR ROAD NORTH CURL CURL STORMWATER DRAINAGE WORKS DEVELOPMENT APPLICATION





LOCALITY PLAN

Cardno **Shaping the Future**

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SCHEDULE OF DRAWINGS

DESCRIPTION DRAWING No. 59918041-DA-000 DRAWING LIST, LOCALITY PLAN AND GENERAL NOTES 59918041-DA-001 STORMWATER PLAN 59918041-DA-002 SITEWORKS PLAN

59918041-DA-003 EROSION AND SEDIMENT CONTROL PLAN 59918041-DA-004 EROSION AND SEDIMENT CONTROL DETAILS

59918041-DA-005 STORMWATER DETAILS 59918041-DA-010 STORMWATER SECTIONS

59918041-DA-011 SITE EARTHWORKS LONGITUDINAL SECTIONS

THE EXISTING SITE CONDITIONS SHOWN ON THE FOLLOWING DRAWINGS HAVE BEEN INVESTIGATED BY VERIS (FORMERLY LAWRENCE GROUP), BEING REGISTERED SURVEYORS. THE INFORMATION IS SHOWN TO PROVIDE A BASIS FOR DESIGN. CARDNO DOES NOT GUARANTEE THE ACCURACY OR COMPLETENESS OF THE SURVEY BASE OR ITS SUITABILITY AS A BASIS FOR CONSTRUCTION DRAWINGS.

SURVEY NOTES

SHOULD DISCREPANCIES BE ENCOUNTERED DURING CONSTRUCTION BETWEEN THE SURVEY DATA AND ACTUAL FIELD DATA, CONTACT THE SUPERINTENDENT.

EXISTING UNDERGROUND **SERVICES NOTES**

THE LOCATIONS OF UNDERGROUND SERVICES SHOWN IN THIS SET OF DRAWINGS HAVE BEEN PLOTTED FROM SURVEY INFORMATION, SURE SEARCH UNDERGROUND SERVICES REPORT (11/01/16) AND SERVICE AUTHORITY INFORMATION. THE SERVICE INFORMATION HAS BEEN PREPARED TO SHOW THE POSITIONS OF ANY KNOWN SERVICES AND MAY NOT BE AS CONSTRUCTED OR ACCURATE. CARDNO CAN NOT GUARANTEE THAT THE SERVICES INFORMATION SHOWN ON THESE DRAWINGS ACCURATELY INDICATES THE PRESENCE OR ABSENCE OF SERVICES OR THEIR LOCATION AND WILL ACCEPT NO LIABILITY FOR INACCURACIES IN THE SERVICES INFORMATION SHOWN FROM ANY CAUSE WHATSOEVER.

CONTRACTORS SHALL TAKE DUE CARE WHEN EXCAVATING ONSITE INCLUDING HAND EXCAVATION WHERE NECESSARY. CONTRACTORS ARE TO CONTACT THE RELEVANT SERVICE AUTHORITY

PRIOR TO COMMENCEMENT OF EXCAVATION WORKS. CONTRACTORS ARE TO UNDERTAKE A SERVICES SEARCH, PRIOR TO COMMENCEMENT OF WORKS ON SITE. SEARCH RESULTS ARE TO BE KEPT ON SITE AT ALL TIMES.

PROPOSED WORKS LEGEND

PROPOSED SITE BOUNDARY _____ **BOX CULVERT**

DRAINAGE EASEMENT BOUNDARY

PRECAST PIPE / CULVERT CONNECTION

PROPOSED RETAINING WALL

PIT NUMBER

EROSION AND SEDIMENT CONTROL NOTES

GENERAL INSTRUCTIONS

1. THE CONTRACTOR SHALL BE SOLELY RESPONSIBLE FOR THE CONTROL OF EROSION AND SEDIMENTATION TO THE SATISFACTION OF COUNCIL, OFFICE OF WATER, SYDNEY WATER AND OFFICE OF ENVIRONMENT AND HERITAGE. TO THIS END, THE EROSION AND SEDIMENTATION CONTROLS SHOWN ON THE DRAWINGS SHALL ONLY BE USED AS A GUIDE BY THE CONTRACTOR, AND SHALL REPRESENT THE MINIMUM REQUIREMENT ONLY

2. THE CONTRACTOR SHALL ENSURE THAT ALL SOIL AND WATER MANAGEMENT WORKS ARE LOCATED AS DOCUMENTED OR AS OTHERWISE DIRECTED BY THE SUPERINTENDENT.

3. ALL WORK SHALL BE GENERALLY CARRIED OUT IN ACCORDANCE WITH a. LOCAL AUTHORITY REQUIREMENTS

b. NSW OFFICE OF ENVIRONMENT & HERITAGE REQUIREMENTS c. NSW GOVERNMENT "MANAGING URBAN STORMWATER, SOILS AND CONSTRUCTION", 4th EDITION, MARCH 2004.

4. MAINTAIN THE EROSION CONTROL DEVICES TO THE SATISFACTION OF THE SUPERINTENDENT AND THE LOCAL AUTHORITY.

5. CONTRACTOR IS TO ENSURE ALL EROSION & SEDIMENT CONTROL DEVICES ARE MAINTAINED IN GOOD WORKING ORDER AND OPERATE EFFECTIVELY. REPAIRS AND OR MAINTENANCE SHALL BE UNDERTAKEN AS REQUIRED, PARTICULARLY FOLLOWING STORM EVENTS.

LAND DISTURBANCE

6. WHERE PRACTICAL, THE SOIL EROSION HAZARD ON THE SITE WILL BE KEPT AS LOW AS POSSIBLE. TO THIS END, WORKS SHOULD BE UNDERTAKEN IN THE FOLLOWING SEQUENCE: a.INSTALL A SEDIMENT FENCE ALONG THE BOUNDARIES AS SHOWN ON

PLAN. REFER DETAIL. **b.INSTALL SEDIMENT TRAPS AS SHOWN ON PLAN.** c.UNDERTAKE SITE DEVELOPMENT WORKS IN ACCORDANCE WITH THE

ENGINEERING PLANS. WHERE POSSIBLE, PHASE DEVELOPMENT SO THAT LAND DISTURBANCE IS CONFINED TO AREAS OF WORKABLE SIZE.

EROSION CONTROL

7. DURING WINDY WEATHER, LARGE, UNPROTECTED AREAS WILL BE KEPT MOIST (NOT WET) BY SPRINKLING WITH WATER TO KEEP DUST UNDER

8. FINAL SITE LANDSCAPING WILL BE UNDERTAKEN AS SOON AS POSSIBLE AND WITHIN 20 WORKING DAYS FROM COMPLETION OF CONSTRUCTION ACTIVITIES.

SEDIMENT CONTROL

9. ANY SAND USED IN THE CONCRETE CURING PROCESS (SPREAD OVER THE SURFACE) WILL BE REMOVED AS SOON AS FEASIBLE AND WITHIN 10 WORKING DAYS FROM PLACEMENT.

10. WATER WILL BE PREVENTED FROM ENTERING THE PERMANENT DRAINAGE SYSTEM UNLESS IT IS RELATIVELY SEDIMENT FREE, I.E. THE CATCHMENT AREA HAS BEEN PERMANENTLY LANDSCAPED AND/OR ANY LIKELY SEDIMENT HAS BEEN FILTERED THROUGH AN APPROVED

11. TEMPORARY SOIL AND WATER MANAGEMENT STRUCTURES WILL BE REMOVED ONLY AFTER THE LANDS THEY ARE PROTECTING ARE REHABILITATED.

OTHER MATTERS

12. ACCEPTABLE RECEPTORS WILL BE PROVIDED FOR CONCRETE AND MORTAR SLURRIES, PAINTS, ACID WASHINGS, LIGHT-WEIGHT WASTE MATERIALS AND LITTER.

13. ANY EXISTING TREES WHICH FORM PART OF THE FINAL LANDSCAPING PLAN WILL BE PROTECTED FROM CONSTRUCTION ACTIVITIES BY: a.PROTECTING THEM WITH BARRIER FENCING OR SIMILAR MATERIALS INSTALLED OUTSIDE THE DRIP LINE

b.ENSURING THAT NOTHING IS NAILED TO THEM c.PROHIBITING PAVING, GRADING, SEDIMENT WASH OR PLACING OF STOCKPILES WITHIN THE DRIP LINE EXCEPT UNDER THE FOLLOWING

(I) ENCROACHMENT ONLY OCCURS ON ONE SIDE AND NO CLOSER TO THE TRUNK THAN EITHER 1.5 METRES OR HALF THE DISTANCE BETWEEN THE OUTER EDGE OF THE DRIP LINE AND THE TRUNK, WHICH EVER IS THE

(II) A DRAINAGE SYSTEM THAT ALLOWS AIR AND WATER TO CIRCULATE THROUGH THE ROOT ZONE (E.G. A GRAVEL BED) IS PLACED UNDER ALL FILL LAYERS OF MORE THAN 300 MILLIMETRES DEPTH (III) CARE IS TAKEN NOT TO CUT ROOTS UNNECESSARILY NOR TO COMPACT

THE SOIL AROUND THEM.

BULK EARTHWORKS NOTES

1. ORIGIN OF LEVELS: REFER SURVEY NOTES

2. STRIP TOPSOIL/ORGANIC MATERIAL FROM CONSTRUCTION AREA AND REMOVE FROM SITE.

3. EXCAVATED MATERIAL TO BE REMOVED FROM SITE 4. COMPACT FILL AREAS AND SUBGRADE TO NOT LESS THAN:

> STANDARD DRY DENSITY (AS 1289 5.1.1.)

UNDER BUILDING SLABS

LANDSCAPED AREAS UNLESS NOTED OTHERWISE 95%

5. FOR NON COHESIVE MATERIAL, COMPACT TO 70% DENSITY INDEX . THE EXPOSED SURFACE SHOULD BE COMPACTED WITH A MINIMUM

OF 8 PASSES OF A 10 TONNE (MINIMUM DEAD WEIGHT) ROLLER.

FOLLOWED BE TEST ROLLING IN THE PRESENCE OF A GEOTECNICAL ENGINEER AND RECTIFIED AS REQUIRED. WHERE SOFT SPOTS ARE IDENTIFIED, THEY SHOULD BE EXCAVATED AND THEN BACKFILLED USING SUITABLE GRANULAR

MATERIAL AND COMPACTED IN 0.25m (LOOSE THICKNESS) IF SOFT MATERIALS EXCEED 0.5m, A BRIDGING LAYER MAY BE

. FREQUENCY OF COMPACTION TESTING SHALL BE NOT LESS THAN :-(A) 1 TEST PER 200m³ OF FILL PLACED PER 250 LAYER OF FILL. (B) 3 TESTS PER VISIT

(C) 1 TEST PER 1000m² OF EXPOSED SUBGRADE TESTING SHALL BE "LEVEL 1" TESTING IN ACCORDANCE WITH AS 3798

8. FILLING TO BE PLACED IN MAXIMUM 250mm - LOOSE LAYERS AND

COMPACTED AS SPECIFIED

9. NO FILLING SHALL TAKE PLACE TO EXPOSED SUBGRADE UNTIL THE AREA HAS BEEN PROOF ROLLED IN THE PRESENCE OF CERTIFYING AUTHORITY AND THE GEOTECHNICAL ENGINEER AND APPROVAL GIVEN IN WRITING THAT FILLING CAN PROCEED.

STORMWATER DRAINAGE NOTES

ALL BOX CULVERTS SHALL COMPLY WITH THE REQUIREMENTS OF AS 1597.1. EACH BATCH OF CULVERT SECTIONS SHALL BE SUBJECTED TO THE PROOF LOADING TEST AS PRESCRIBED IN SECTION 3.2 OF AS1597.1.

CULVERTS SHALL HAVE THE FOLLOWING INFORMATION CLEARLY MARKED TO IDENTIFY MANUFACTURER, BATCH NUMBER, CULVERT DIMENSIONS AND INSPECTION STATUS.

CULVERT UNITS TO BE INSTALLED TO MANUFACTURER'S SPECIFICATIONS USING JOINT TAPE AS APPROPRIATE.

ALL PRECAST CONCRETE STRUCTURES SUCH AS LID SURROUNDS, LINK SLABS SHALL BE MANUFACTURED AND INSTALLED IN ACCORDANCE WITH AS 3600.

CARE IS TO BE TAKEN WITH LEVELS OF STORMWATER LINES. GRADES SHOWN ARE NOT TO BE REDUCED WITHOUT APPROVAL.

6. GRATES AND COVERS SHALL CONFORM TO AS 3996.

AT ALL TIMES DURING CONSTRUCTION OF STORMWATER PITS, ADEQUATE SAFETY PROCEDURES SHALL BE TAKEN TO ENSURE AGAINST THE POSSIBILITY OF PERSONNEL FALLING DOWN PITS.

ALL EXISTING STORMWATER DRAINAGE LINES AND PITS THAT ARE TO REMAIN ARE TO BE INSPECTED AND CLEANED. DURING THIS PROCESS ANY PART OF THE STORMWATER DRAINAGE SYSTEM THAT WARRANTS REPAIR SHALL BE REPORTED TO THE SUPERINTENDENT/ENGINEER FOR FURTHER DIRECTIONS.


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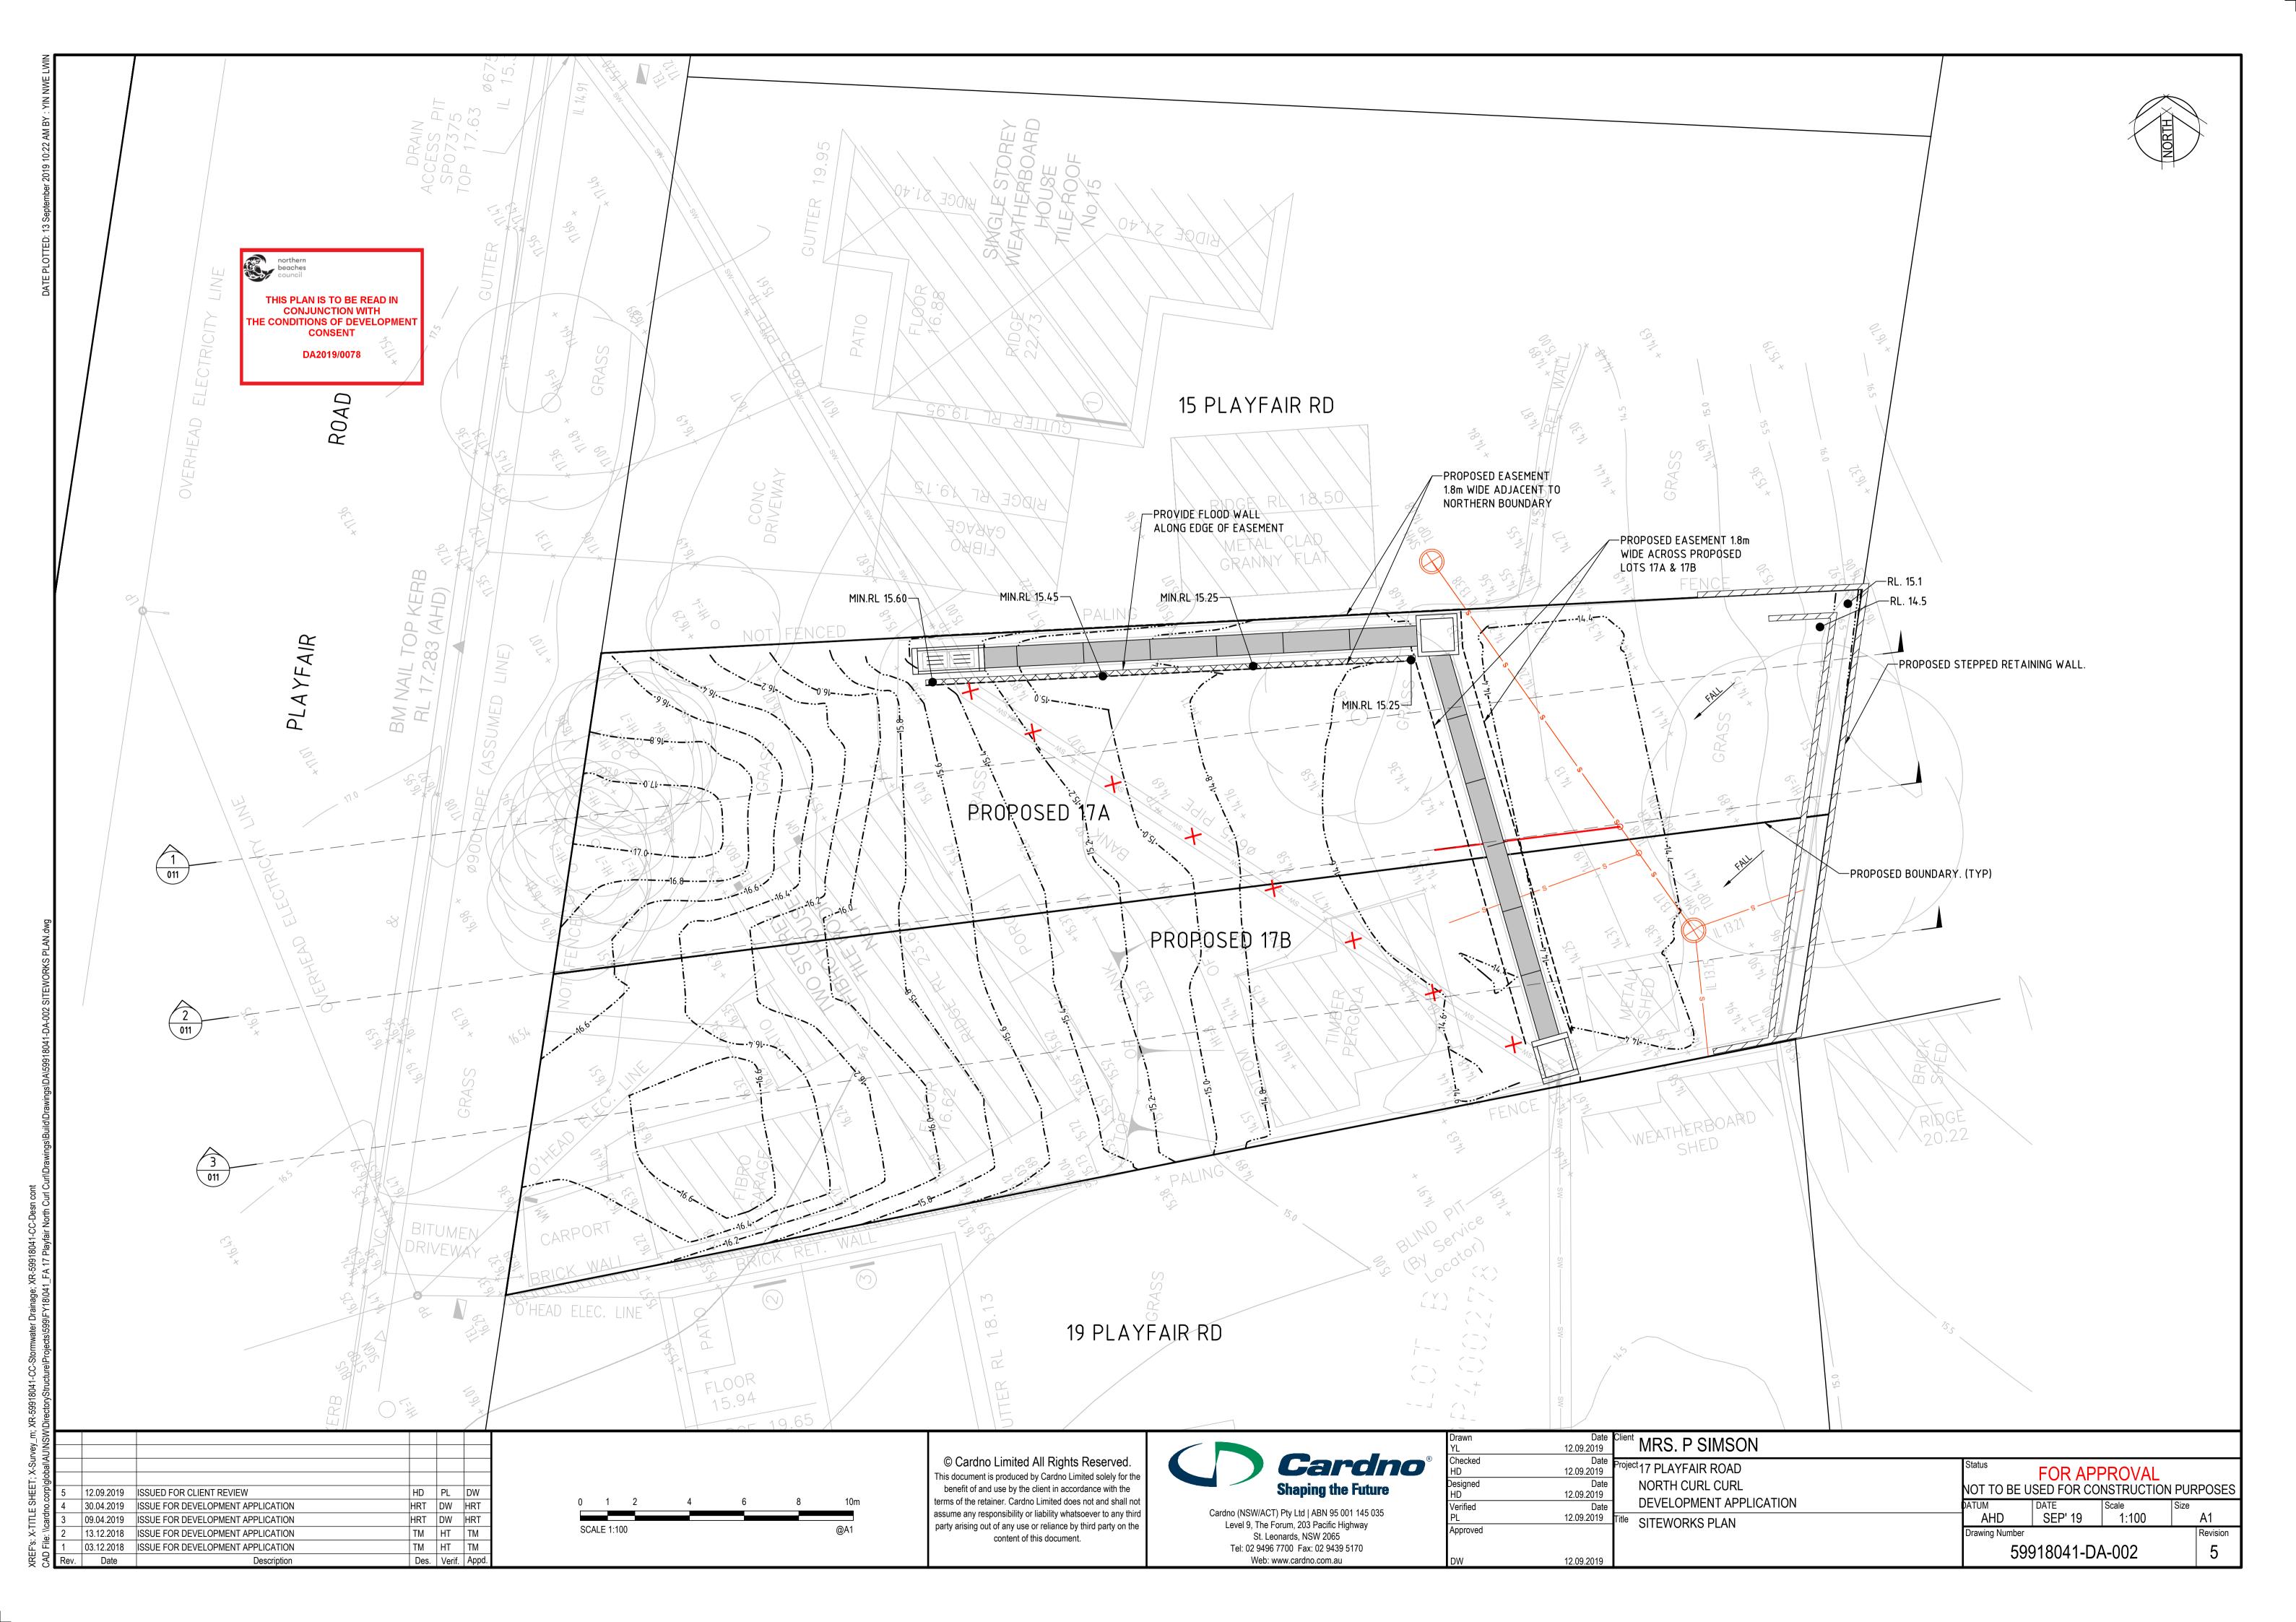
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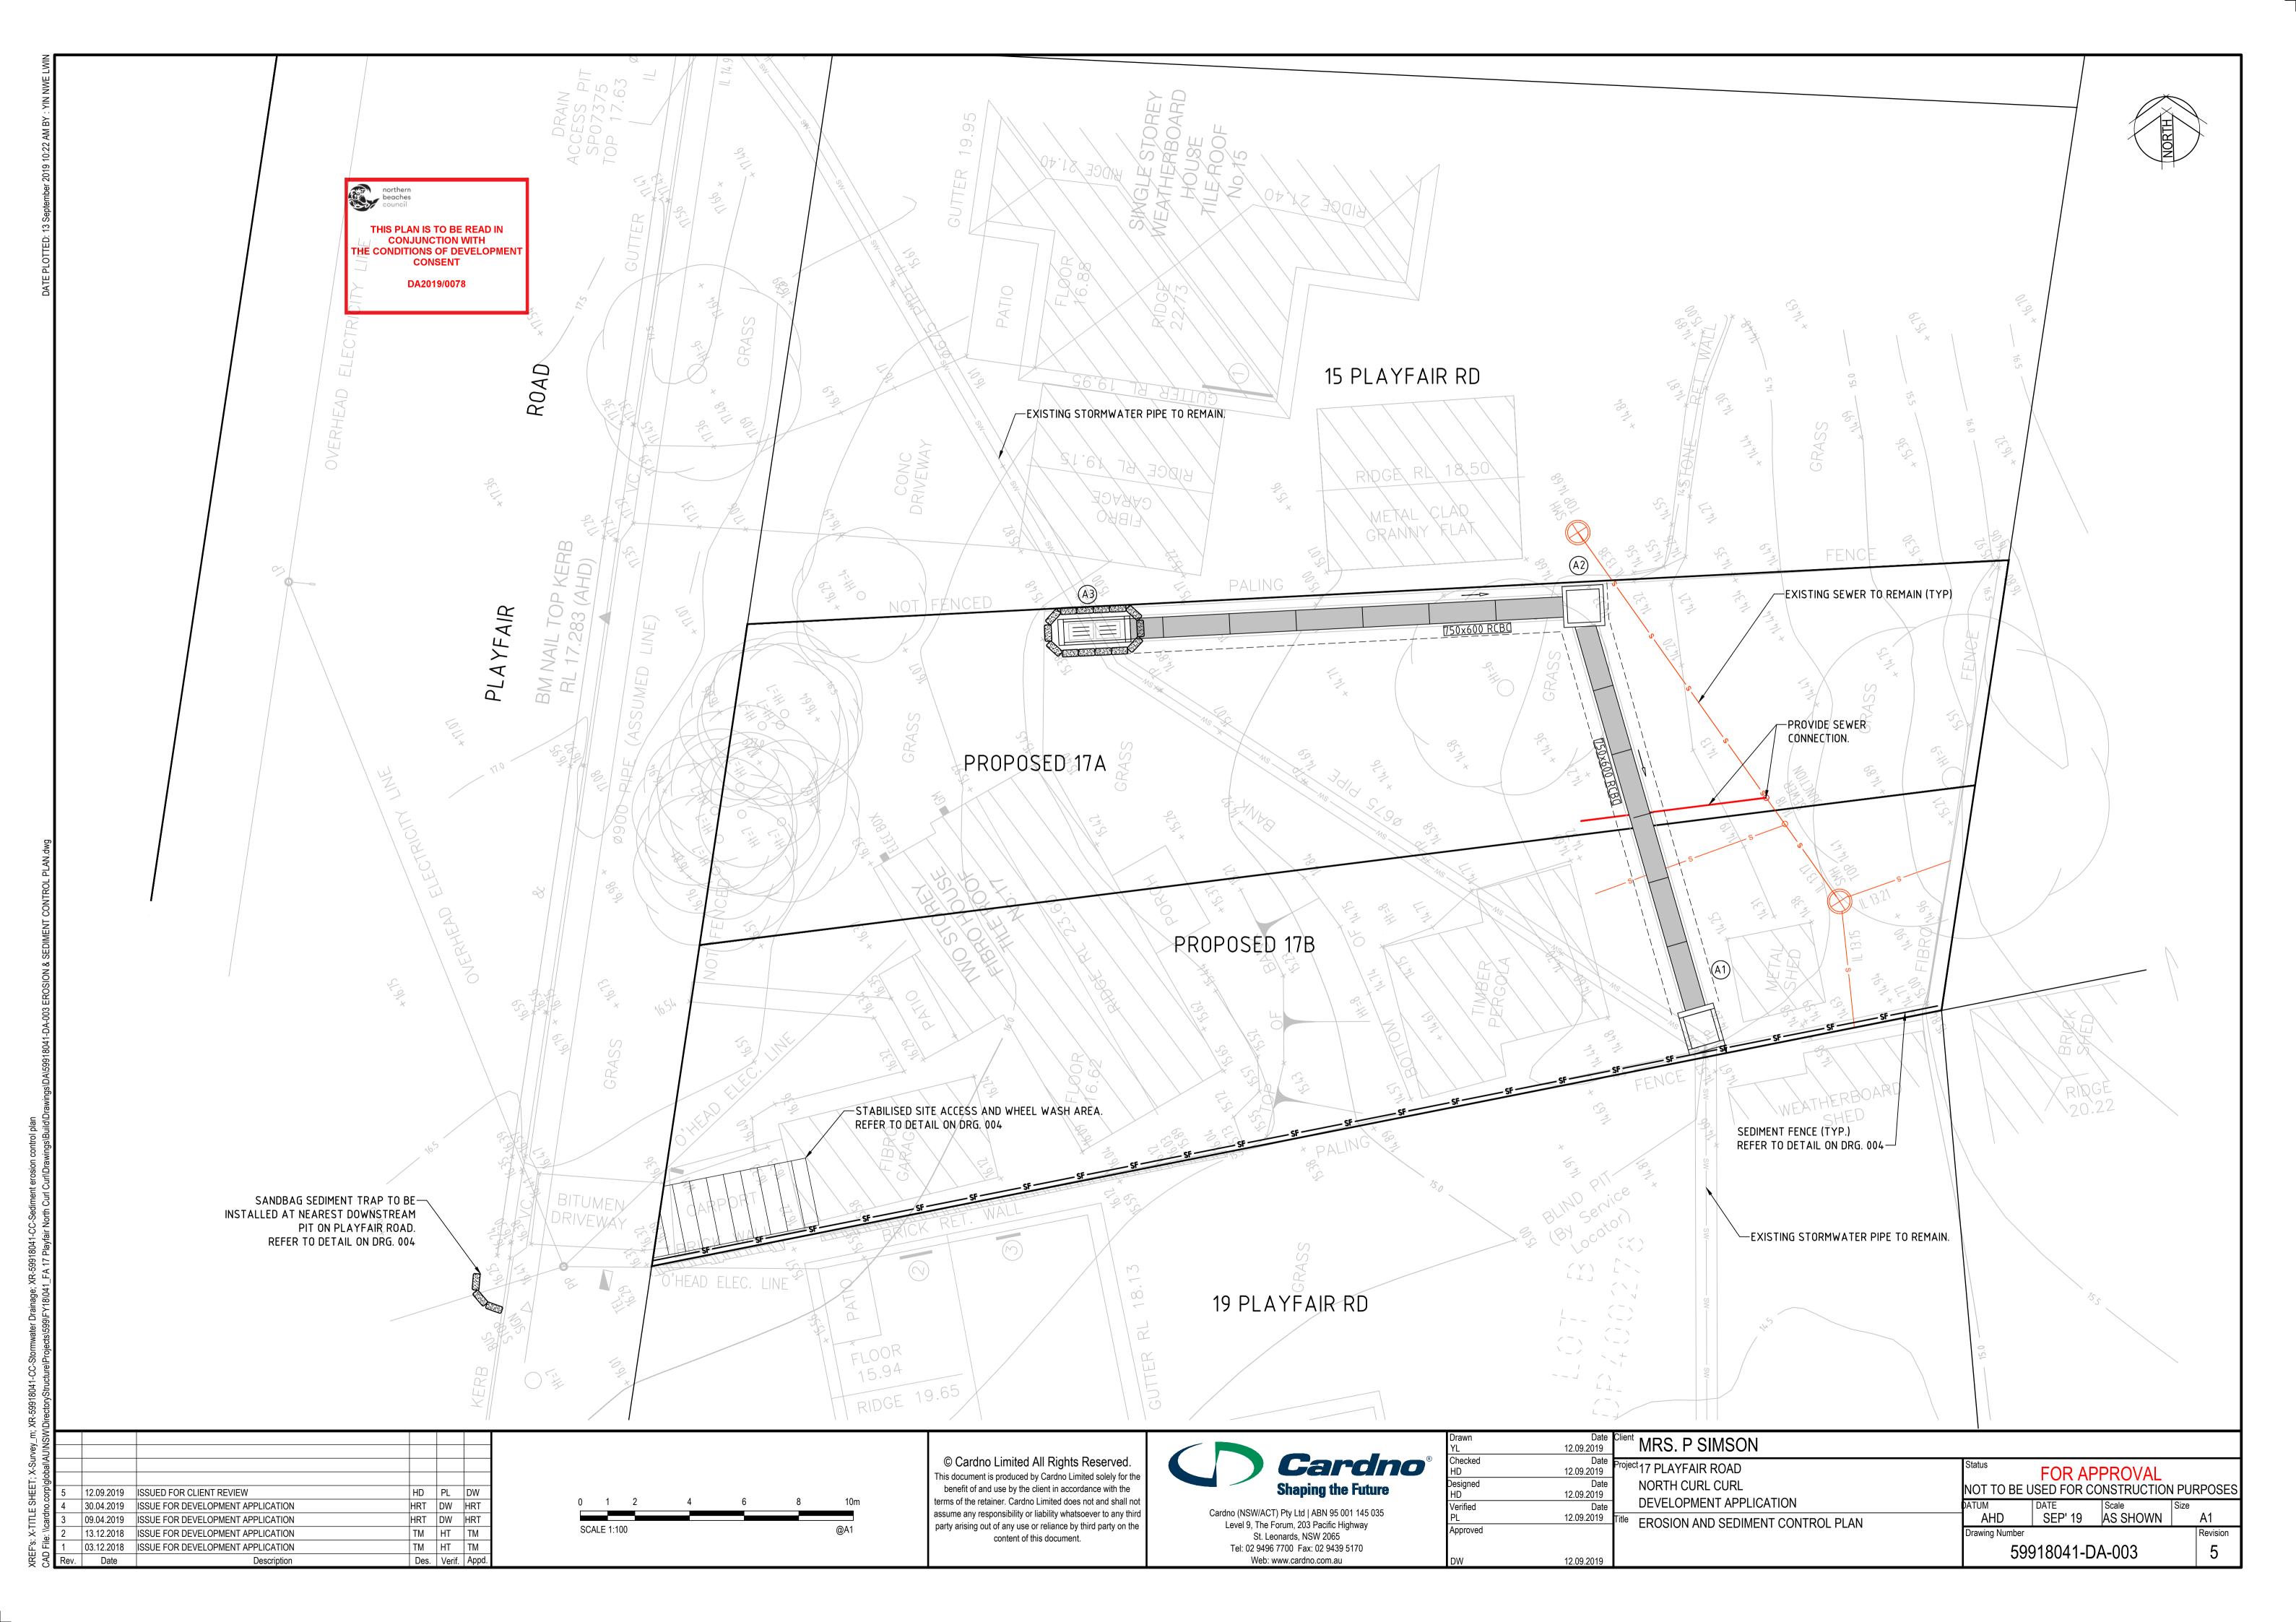
FOR APPROVAL NOT TO BE USED FOR CONSTRUCTION PURPOSES SEP' 19 N.T.S A1


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File:	1	03.12.2018	ISSUE FOR DEVELOPMENT APPLICATION	TM	HT	TM
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20m MAX

1.5m LONG STAR PICKETS AT 3m


MAXIMUM CTS.

DISTURBED AREA

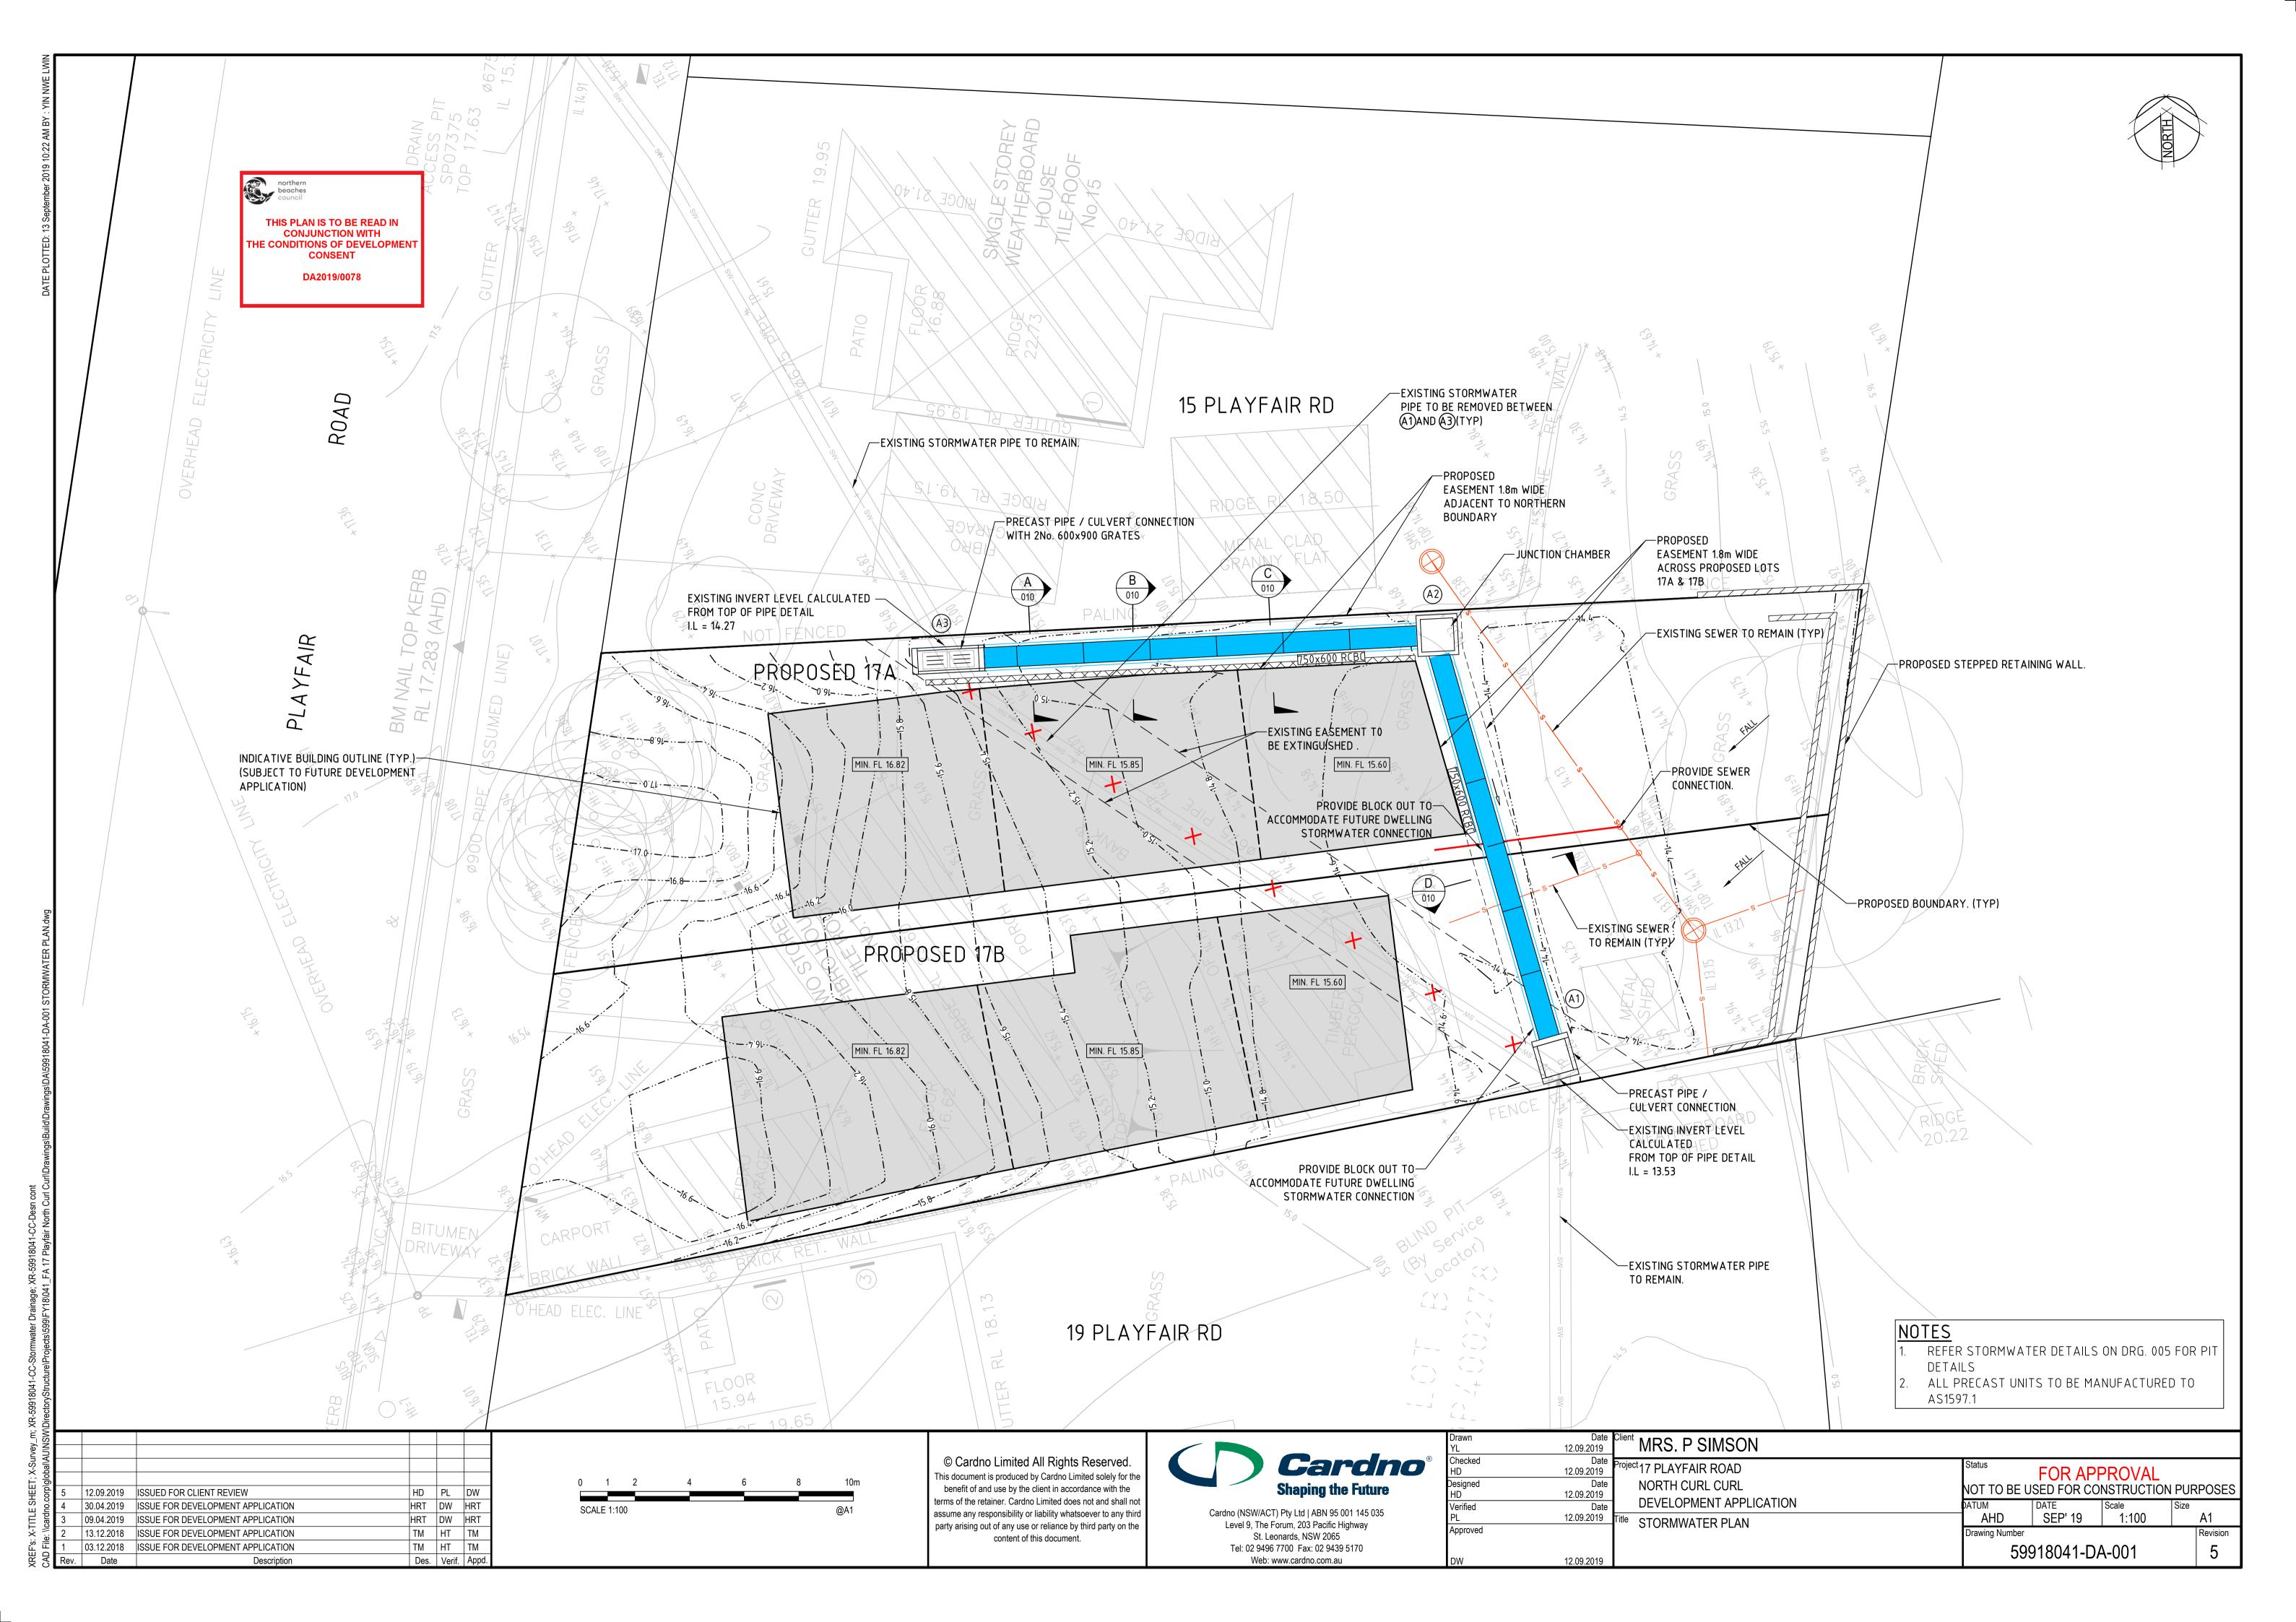UNDISTURBED AREA

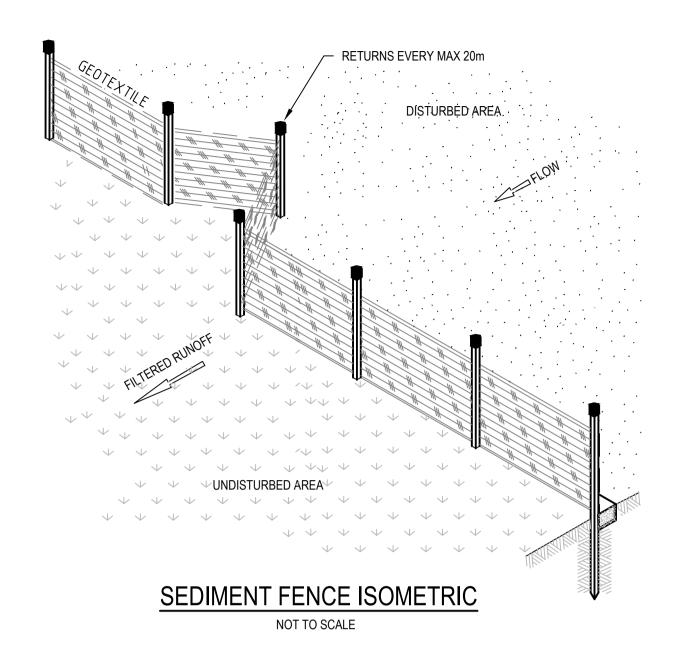
SEDIMENT FENCE PLAN

NOT TO SCALE

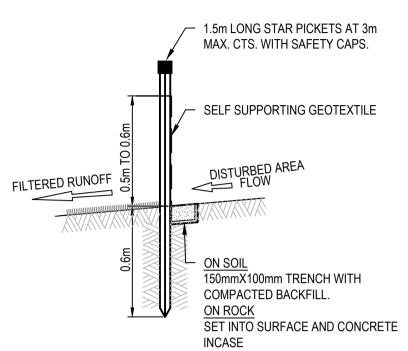


SEDIMENT FENCE SECTION

NOT TO SCALE

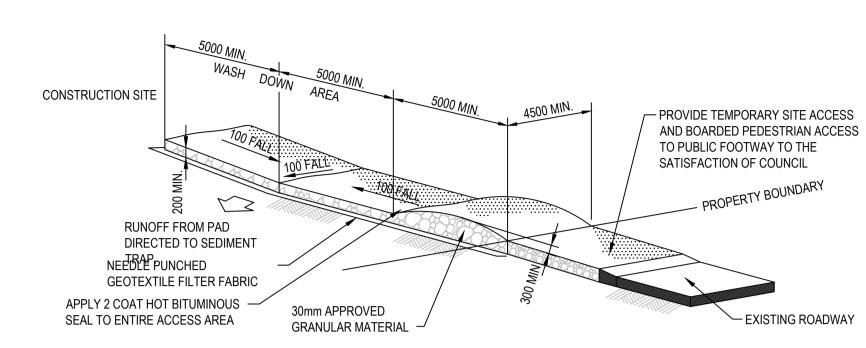

STABILISED SITE ACCESS AND TRUCK WASH DOWN AREA



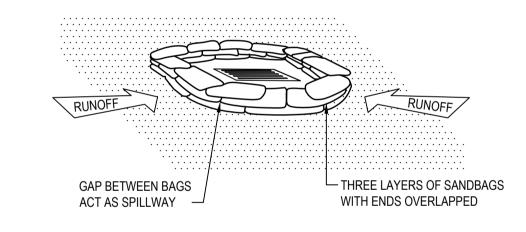

SEDIMENT TRAP AT LOW POINT - SANDBAG NOT TO SCALE

SEDIMENT TRAP FOR KERB INLET (ON GRADE - SANDBAG)


THREE LAYERS OF SANDBAGS
 WITH ENDS OVERLAPPED


SANDBAGS OVERLAP ONTO KERB

RUNOFF

GAP BETWEEN BAGS ACT AS SPILLWAY —

NOT TO SCALE

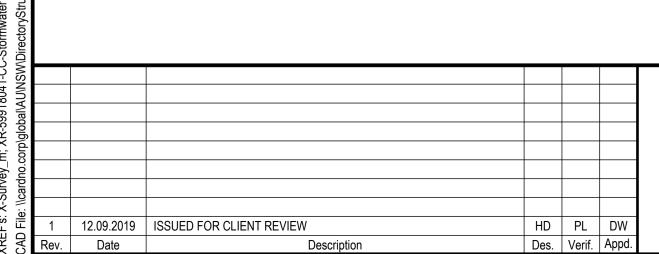

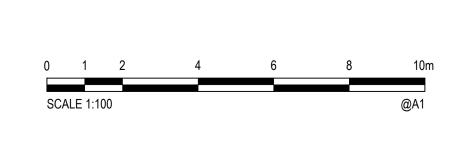

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Verified PL	Date 12.09.2019	DEVELOPMENT APPLICATION Title FROCION AND CERMENT CONTROL RETAIL C	DATUM AHD	DATE SEP' 19	Scale AS SHOWN	Size A1
Approved		EROSION AND SEDIMENT CONTROL DETAILS	Drawing Number			
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