

- ALL WORKS TO COMPLY WITH BUILDING CODE OF AUSTRALIA, REQUIREMENTS OF RELEVANT STATUTORY AUTHORITIES / LOCAL GOVERNMENT & RELEVANT AUSTRALIAN BUILDING STANDARDS

 DRAWINGS FOR THE PURPOSES OF DA ONLY FURTHER CONSULTANT / AUTHORITY COORDINATION WILL BE REQUIRED AT CC STAGE WHICH MAY IMPACT ON DESIGN AND DIANNING LAYOUTE. PLANNING LAYOUTS
- ARCHITECTURAL PLANS TO BE READ IN CONJUNCTION WITH CONSULTANT'S DRAWINGS, SPECIFICATIONS & REPORTS
 COPYRIGHT OF DESIGN SHOWN HEREON IS RETAINED BY PBD ARCHITECTS AND
- AUTHORITY IS REQUIRED FOR ANY REPRODUCTION AREA SCHEDULES SUPPLIED ARE APPROXIMATE ONLY- FUTURE ALLOWANCE FOR VERTICAL SERVICE DUCTS, STRUCTURAL WALL SYSTEMS AND CONSULTANT INPUT WILL BE REQUIRED

LEGEND:

AW AWNING HW HIGHLIGHT WINDOW A/C CONDENSER UNITS FH FIRE HYDRANT FHR FIRE HOSE REEL FS FIRE STAIRS

MV MECHANICAL RISER TO FUTURE DETAIL GARBAGE CHUTE

MB MAILBOX TO FUTU OG OPAQUE GLASS PB PLANTERBOX MAILBOX TO FUTURE DETAIL

240L RECYCLING BIN

SK SKYLIGHT
ST STORAGE
WT HOT WATER UNITS

MATERIALS LEGEND:

AFG ALUMINIUM FRAMED GLAZING
AFL ALUMINIUM ELLIPTICAL FIXED LOUVERS AW AWNING TO FUTURE DETAILS

BS BATTEN SCREEN (TO FUTURE DETAIL)

FRAMELESS TOUGHENED GLASS BALUSTRADE (TO BCA/AUSTRALIAN STANDARDS)

METAL FENCING (TO FUTURE SELECTION)
PRIVACY SCREEN (TO FUTURE SELECTION)

PS PRIVACY SCREEN (TO FU PTx PAINT FINISH TYPEX ROLLER DOOR

RIVER PEBBLES

RENDERED WALL/SELECTED PAINT FINISH TIMBER CLADDING

> GENERAL AMENDMENT REFER TO SCHEDULE OF AMENDMENT

DRAWING LIST

DA 000 DA 001 DA 002 DA 003	COVER PAGE PROJECT SUMMARY & AREA SCHEDULE DEMOLITION PLAN EXCAVATION & FILL PLAN	DA 510 DA 520 DA 530 DA 540 DA 550	CROSS VENTILATION DIAGRAM STORAGE DIAGRAM PRIVATE OPEN SPACE LANDSCAPE DIAGRAM HEIGHT PLANE DIAGRAM
DA010	SITE ANALYSIS PLAN	DA 000	
DA011	SITE PLAN	DA 600	SOLAR STUDY (21st JUNE 9AM)
DA 400	DAGENENT DI ANI	DA 601	SOLAR STUDY (21st JUNE 10AM)
DA 100	BASEMENT PLAN	DA 602	SOLAR STUDY (21st JUNE 11AM)
DA 101	GROUND FLOOR PLAN	DA 603	SOLAR STUDY (21st JUNE 12PM)
DA 102	LEVEL 1 PLAN	DA 604	SOLAR STUDY (21st JUNE 01PM)
DA 103	LEVEL 2 PLAN	DA 605	SOLAR STUDY (21st JUNE 02PM)
DA 104	ROOF PLAN	DA 606	SOLAR STUDY (21st JUNE 03PM)
DA 201	ELEVATION (EAST & WEST)	DA 607	SOLAR STUDY WITH EXISTING DEVELOPMENT (21st JUNE 9AM)
DA 202	ELEVATION (NORTH)	DA 608	SOLAR STUDY WITH EXISTING
		DA 000	DEVELOPMENT (21st JUNE 10AM)
D 4 004	OFOTIONS	DA 609	SOLAR STUDY WITH EXISTING
DA 301	SECTIONS	/ >	DEVELOPMENT (21st JUNE 11AM)
		DA 610	SOLAR STUDY WITH EXISTING
		>	DEVELOPMENT (21st JUNE 12PM)
DA 400	MATERIAL SCHEDULE	DA 611	SOLAR STUDY WITH EXISTING
DA 401	PHOTOMONTAGE A	\	DEVELOPMENT (21st JUNE 01PM)
DA 402	PHOTOMONTAGE B	DA 612	SOLAR STUDY WITH EXISTING
DA403	SKETCHUP VIEWS		DEVELOPMENT (21st JUNE 02PM)
		DA 613	SOLAR STUDY WITH EXISTING
DA 500	GFA DIAGRAM	>	DEVELOPMENT (21st JUNE 03PM)
			,

	DA 615	(21st JUNE 9AM-12PM) SOLAR STUDY CLOSE UP (21st JUNE 01PM-03PM)
	DA 616	SOLAR STUDY WITH EXISTING DEVELOPMENT CLOSED UP (21st JUNE 9AM-12PM)
	DA 617	SOLAR STUDY WITH ÉXISTING DEVELOPMENT CLOSED UP (21st JUNE 01PM-03PM)
_	DA 620 DA 621	SHADOW DIAGRAM (21st JUNE 9AM - 12PM SHADOW DIAGRAM (21st JUNE 1PM - 3PM)

SIGNAGE PLAN

SOLAR STUDY CLOSE UP

DA 614

DA700

drawings	or written spec		cifications sha	ll take preced	ased. If details included in these Specifications vary from other lence. If only one specification option is detailed for a building the project.
Windows	Glass *	Frame	U value	SHGC	Detail
Default	Single glazed low solar gain		ım 5.6	0.36	For window types: awning, bi-fold, casement – Glazing generally
Default	Single glazed low solar gain		ım 5.6	0.41	For window types: sliding window/ door, double hung, fixed – Glazing generally
Default	Double glazed low solar gain			0.27	For unit G03 – all glazing
* The glass	s type and frame	e descriptions are indi	cative only. The	U-value and	SHGC performance figures must be met to achieve compliance
Skylights	Glass	Frar	ne U value	SHGC	Detail
External v	walls Constru	ction Add	ed Insulation	Detai	il
Concrete	/ AFS	R 2.	0	All ex	cternal walls
Internal w	valls Constru	ction Add	ed Insulation	Detai	il
Plasterboa	ard on studs	Non	e	Walls	s within units
Concrete		Non	e	Party	walls
Concrete		R 1.	0	Walls	s separating units from stairwells, lift shafts, lobbies, service rooms
Floors	Constru	ction Add	ed Insulation	Detai	
Concrete		Non	е	Floor	s generally
Concrete		R 2.	0	Floor	s over basement carpark, garbage room, and open air
Ceilings	Constru	ction Add	ed Insulation	Detai	il
Plasterboa	ard	Non	е	For u	nits: G01, G02, G03
Plasterboa	ard	R 3.	0		eilings below roof and ceilings below roof spaces – : 101, 102, 103, 104, 105, 201, 202, 203
Roof	Constru	ction Add	ed Insulation		Detail
Concrete			er to ceiling de		
Tiles		Refe	er to ceiling de	tail above	
Other Red	quirements				

В	2022.08.29	REVISED
А	2020.12.18	DA LODGEMENT
ISSUE	DATE	DESCRIPTION

CLIENT:

MACARTHUR PROJECTS

ABN 36 147 035 550

ARCHITECT:

P - 02 9698 8140 E - info@pbdarchitects.com.au W - www.pbdarchitects.com.au Level 2, 52 Albion Street, Surry Hills NSW 2010 Nominated Architect: Paul Buljevic NSW 7768

PROPOSED SHOPTOP HOUSING

1105-1107 BARRENJOEY ROAD, PALM BEACH

DECEMBER 2017

DRAWING TITLE:

COVER PAGE

& NatHERS SPECIFICATION

a maniem	o or con to thor	
DRAWN BY:	CHECKED BY:	
WT, CN	PB	
SCALE:	DRAWING NO:	IS
N/A	DA000	[
PROJECT NO:	DAUUU	L
1816		

PROJECT INFORMATION					
1105 - 1107 Barrenjoey Rd, Palm Beach					
Site Area	1,366.50 s.q.m				
FSR	Retail/Commercial component must be minimum 25% of GFA of the building				
Zoning	B2 - Local Centre				
	Shoptop Housing				
	Serviced Apartments				
Height Control	8.5m				
Total Number of Dwellings	8 Residential Apartments				

JNIT MIX Level	1 Bed	2 Bed	3 Bed	Total
Residential	i Deu	Z Deu	J Deu	Total
EVEL 1	0	0	5	5
EVEL 2	0	0	3	3
TOTAL	0	0	0	0
TOTAL	0%	0%	100%	100%

	Rate	No. of Units / Area	Required	Proposed
Residential				
3 Bed	2 per unit	8	16	16
Accessible Parking	3% of required parking space	0.48	1	1
	excluding adapable units			
Visitor	1 per 3 units	8	3	3
Car Wash Space	1 for 10 or more units		1	1
			19	19
Retail				
Retail Premises	1 space per 30m²	330	11	11
Accessible For Retail	3% of required parking	11	1	1
	space or 1 space			
Commercial Premises	2.5 space per 100m²	120	3	3
		TOTAL	33	33

OTHER DARKING RE	OUDEMENTS			
OTHER PARKING REG	Rate	No. of Units / Area	Required	Proposed
D11-	NAME AND ADDRESS OF THE PARTY O	No. of Office / Area	Required	rioposeu
Bicycle	(Residential) 1 per 3 units	8	3	3
	(Serviced Apartments) 1 per 3 units	3	1	1
	(Business)1 / 1000 sqm GFA or	330	4	4
	Minimum 4			
			•	•

RESIDENTIAL	Rate	No. of Units	Per Week (Litres)	No. of 240L Bins Required
Garbage	80L/Household/week	8	640	3
Recycling - Paper	70L/Household/week	8	560	2
Recycling - Container	70L/Household/week	8	560	2
Vegetation	1 x 240L/200m² of landscaping			2
SERVICED APARTMENT	Rate	No. of Units	Per Week (Litres)	No. of 240L Bins Required
Garbage	80L/Household/week	#REF!	#REF!	#REF!
Recycling - Paper	70L/Household/week	#REF!	#REF!	#REF!
Recycling - Container	70L/Household/week	#REF!	#REF!	#REF!
RETAIL	Rate	L/day	Per Week (Litres)	No. of Bins Required
Café (Retail 5) 61m²				
Garbage	300L/100m² floor area/day	183	1281	5
Recycling	200L/100m² floor area/day	122	854	4
Retail Store (Non-Food): 201m²				
Carbana	50L/100m² floor area/day	101	704	3
Garbage				

Level		Area
GROUND		766.20 s.q.m
LEVEL 1		881.70 s.q.m
LEVEL 2		570.00 s.q.m
	TOTAL	2,217.90 s.q.m
	FSR	1.6:1

RETAIL/COMMERCIAL		
Retail & Commercial	577.60 s.q.m	
Percentage to total GFA	26.0%	

	DCP/ADG Req	Required	Proposed
Livable Housing	20%	2	3
	Silver level of Liveable Housing		
Solar Access (ADG)	70% of total number of dwellings	5.6	8
			100%
Private Open Space (ADG)	Min areas : 1Bed(8m²) 2Bed(10m²) 3Bed(12m²)		Compliant with ADG
Cross Ventilation (ADG)	60% of total number of dwellings	4.8	8
			100%
Infinity Soil zone		95.66 s.q.m	115.04 s.q.m
			8.42%

Area Sched	lule							
Level	Unit.No	Туре	Livable	Internal Area (m2)	Winter Garden/ Balcony (m2)	Storage (m3)	Min. Carpark Storage (m3)	
GF	RETAIL 1			330				
<u> </u>	TAL ITAL I			000				
	Comm G01			120				
RESIDENTIA	L							
LEVEL 1	101	3 BED		185	33	12.5	5.6	18.1
	102	3 BED		171	25	8.5	5.6	14.1
	103	3 BED		132	18	13.9	5.6	19.5
	104	3 BED		130	24	5.7	5.6	11.3
	105	3 BED		129	26	7.6	5.6	13.2
LEVEL 2	201	3 BED	Υ	196.6	30	6.8	5.6	12.4
	202	3 BED	Υ	175	32	9.6	5.6	15.2
	203	3 BED	Υ	183	43	11.2	5.6	16.8

330

120

1301.6

Residential NSA

GENERAL NOTES:

 ALL WORKS TO COMPLY WITH BUILDING CODE OF AUSTRALIA, REQUIREMENTS OF RELEVANT STATUTORY AUTHORITIES/ LOCAL GOVERNMENT & RELEVANT

- AUSTRALIAN BUILDING STANDARDS DRAWINGS FOR THE PURPOSES OF <u>DA ONLY</u> - FURTHER CONSULTANT/ AUTHORITY COORDINATION WILL BE REQUIRED AT CC STAGE WHICH MAY IMPACT ON DESIGN AND
- PLANNING LAYOUTS ARCHITECTURAL PLANS TO BE READ IN CONJUNCTION WITH CONSULTANT'S
- DRAWINGS, SPECIFICATIONS & REPORTS COPYRIGHT OF DESIGN SHOWN HEREON IS RETAINED BY PBD ARCHITECTS AND AUTHORITY IS REQUIRED FOR ANY REPRODUCTION
- AREA SCHEDULES SUPPLIED ARE APPROXIMATE ONLY- FUTURE ALLOWANCE FOR VERTICAL SERVICE DUCTS, STRUCTURAL WALL SYSTEMS AND CONSULTANT INPUT WILL BE REQUIRED

LEGEND:

AW AWNING HW HIGHLIGHT WINDOW CU A/C CONDENSER UNITS

FH FIRE HYDRANT FHR FIRE HOSE REEL

FS FIRE STAIRS MV MECHANICAL RISER TO FUTURE DETAIL

GC GARBAGE CHUTE

MB MAILBOX TO FUTURE DETAIL OG OPAQUE GLASS

PB PLANTERBOX 240L RECYCLING BIN

SK SKYLIGHT ST STORAGE WT HOT WATER UNITS

MATERIALS LEGEND:

AFG ALUMINIUM FRAMED GLAZING AFL ALUMINIUM ELLIPTICAL FIXED LOUVERS

AW AWNING TO FUTURE DETAILS BS BATTEN SCREEN (TO FUTURE DETAIL)

FB FACE BRICK GB FRAMELESS TOUGHENED GLASS BALUSTRADE (TO BCA/AUSTRALIAN

STANDARDS) MC METAL CLADDING

MF METAL FENCING (TO FUTURE SELECTION) PS PRIVACY SCREEN (TO FUTURE SELECTION)

PTx PAINT FINISH TYPEx

RD ROLLER DOOR RP RIVER PEBBLES

RW RENDERED WALL/SELECTED PAINT FINISH

TC TIMBER CLADDING

GENERAL AMENDMENT REFER TO

SCHEDULE OF AMENDMENT

2022.08.29 REVISED 2020.12.18 DA LODGEMENT ISSUE DATE DESCRIPTION

CLIENT:

MACARTHUR PROJECTS

ARCHITECT:

P - 02 9698 8140 E - info@pbdarchitects.com.au W - www.pbdarchitects.com.au Level 2, 52 Albion Street, Surry Hills NSW 2010 ABN 36 147 035 550

Nominated Architect: Paul Buljevic NSW 7768

SCALE:

N/A

1816

PROPOSED SHOPTOP HOUSING


1105-1107 BARRENJOEY ROAD, PALM BEACH


DECEMBER 2017 DRAWING TITLE:


PROJECT SUMMARY & AREA SCHEDULE DRAWN BY:


CHECKED BY: WT, CN DRAWING NO: DA001 PROJECT NO:


ISSUE: В

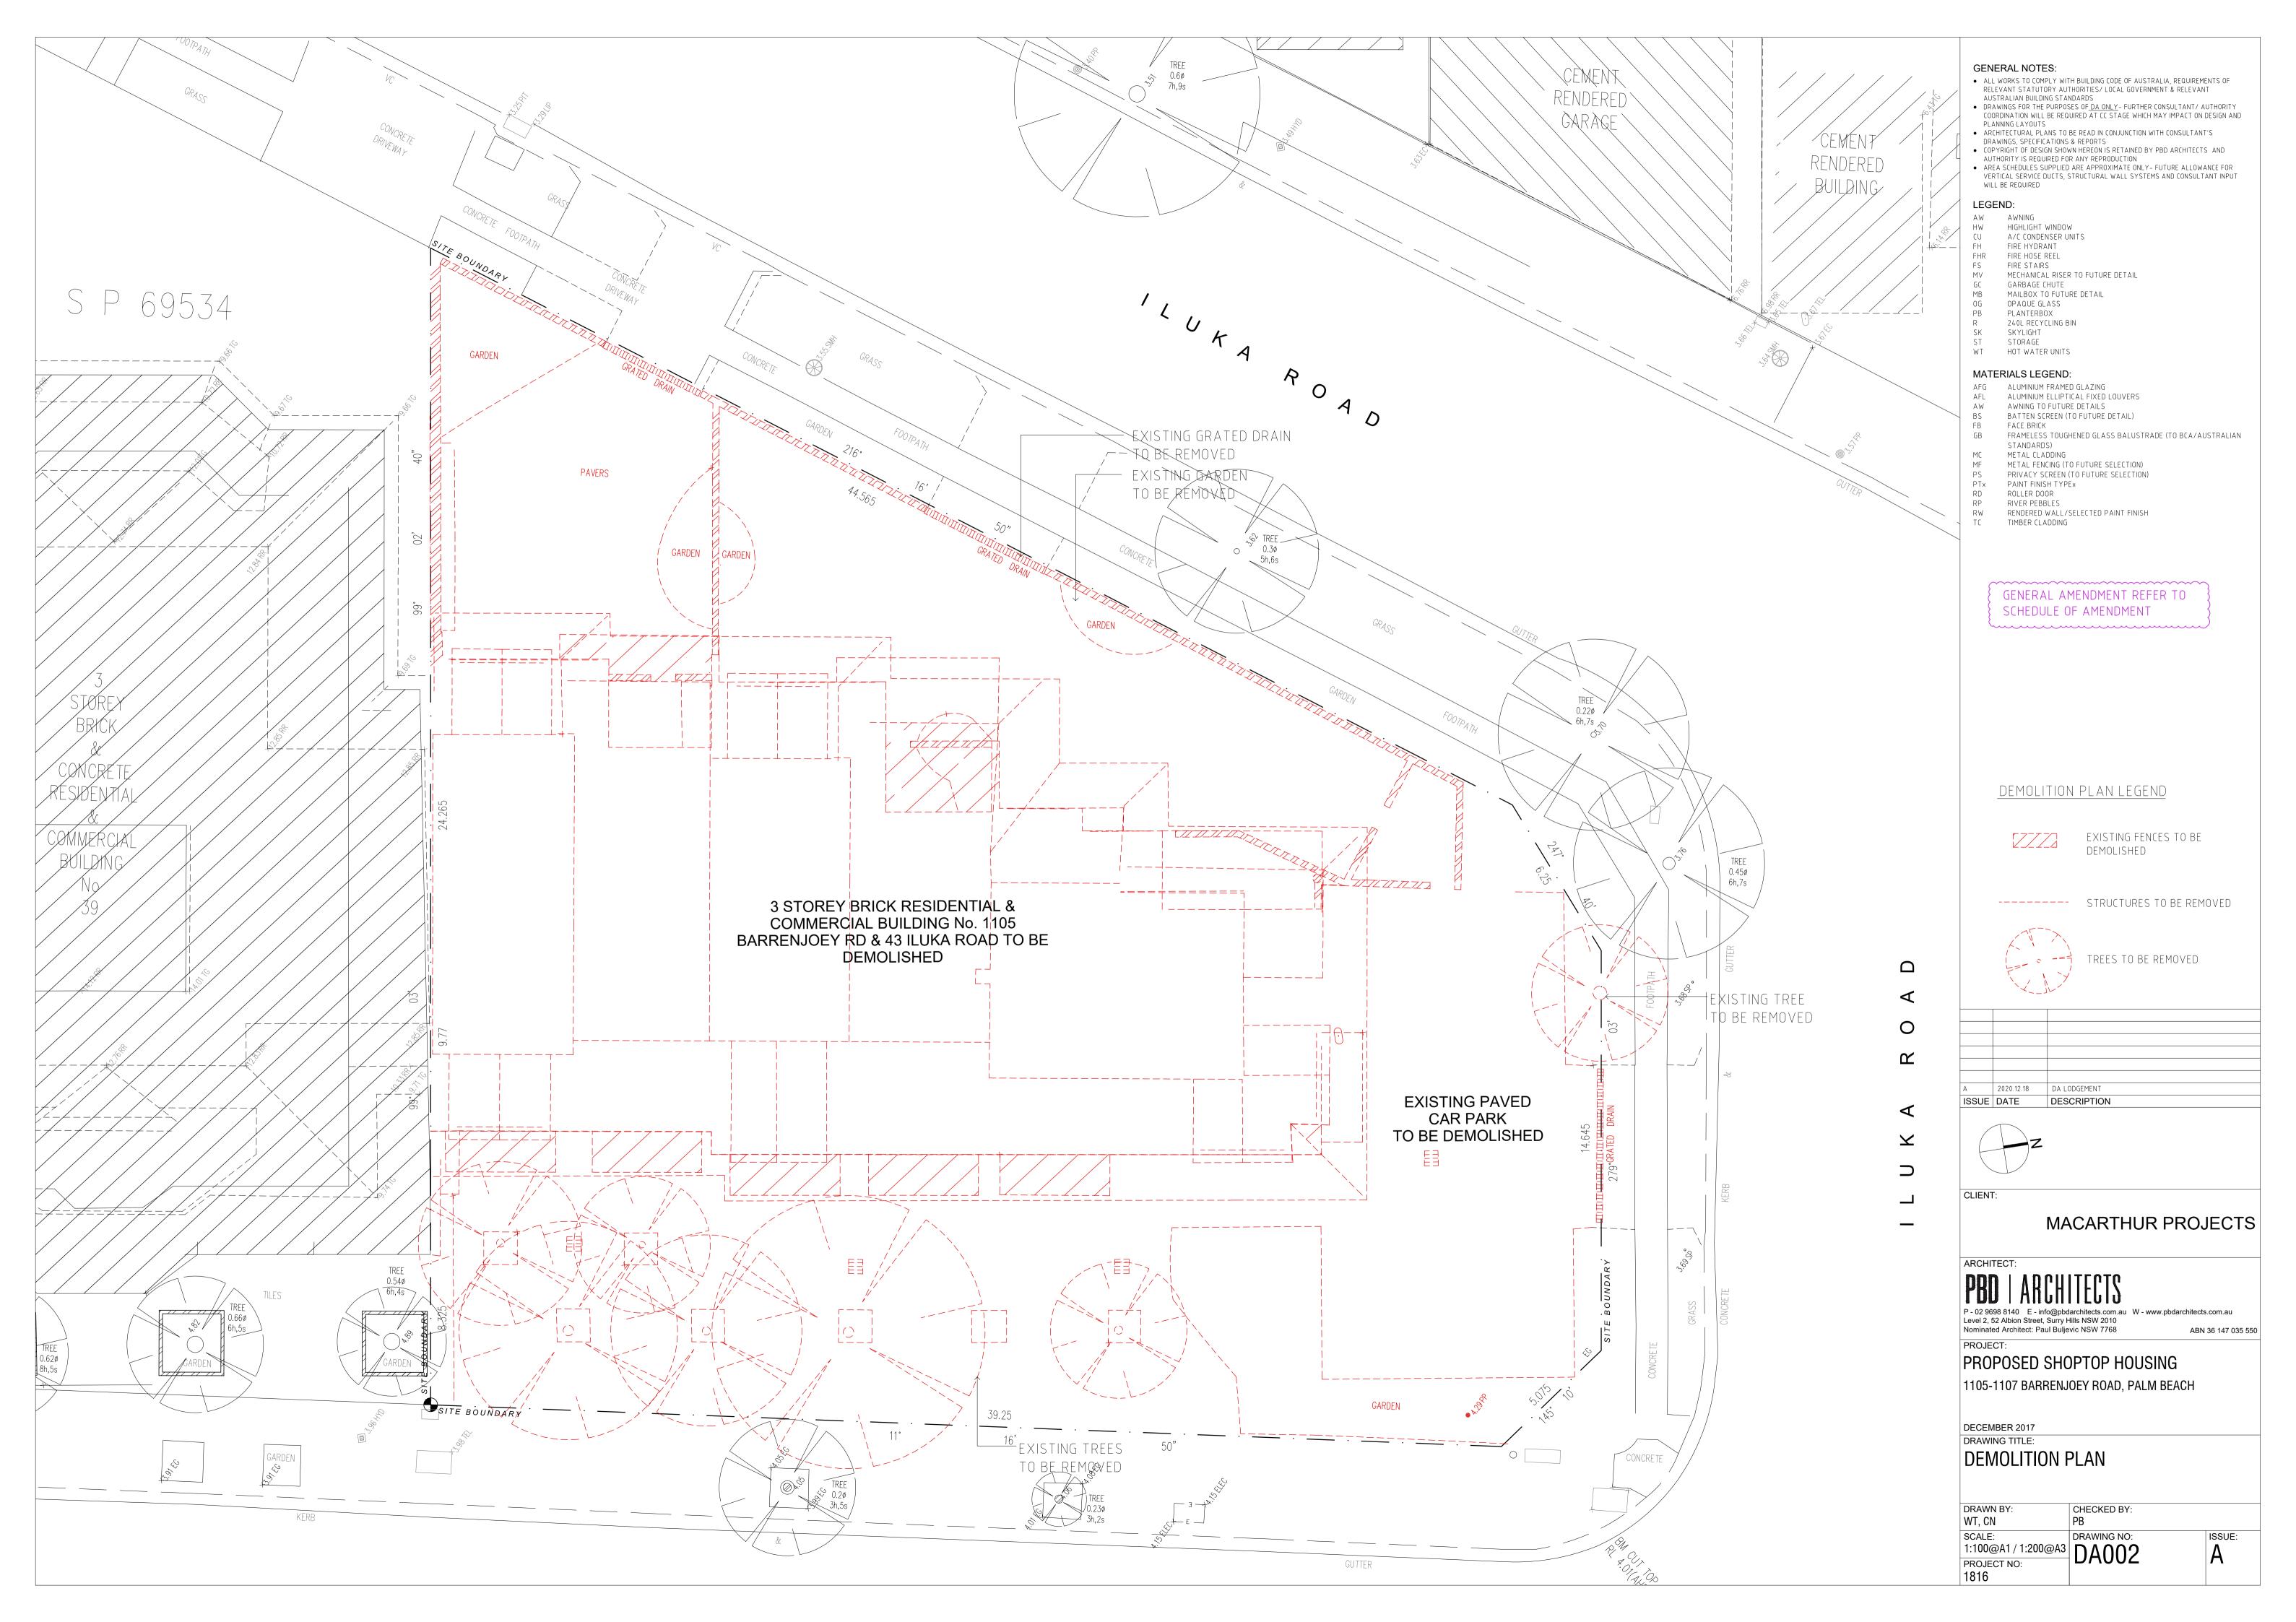


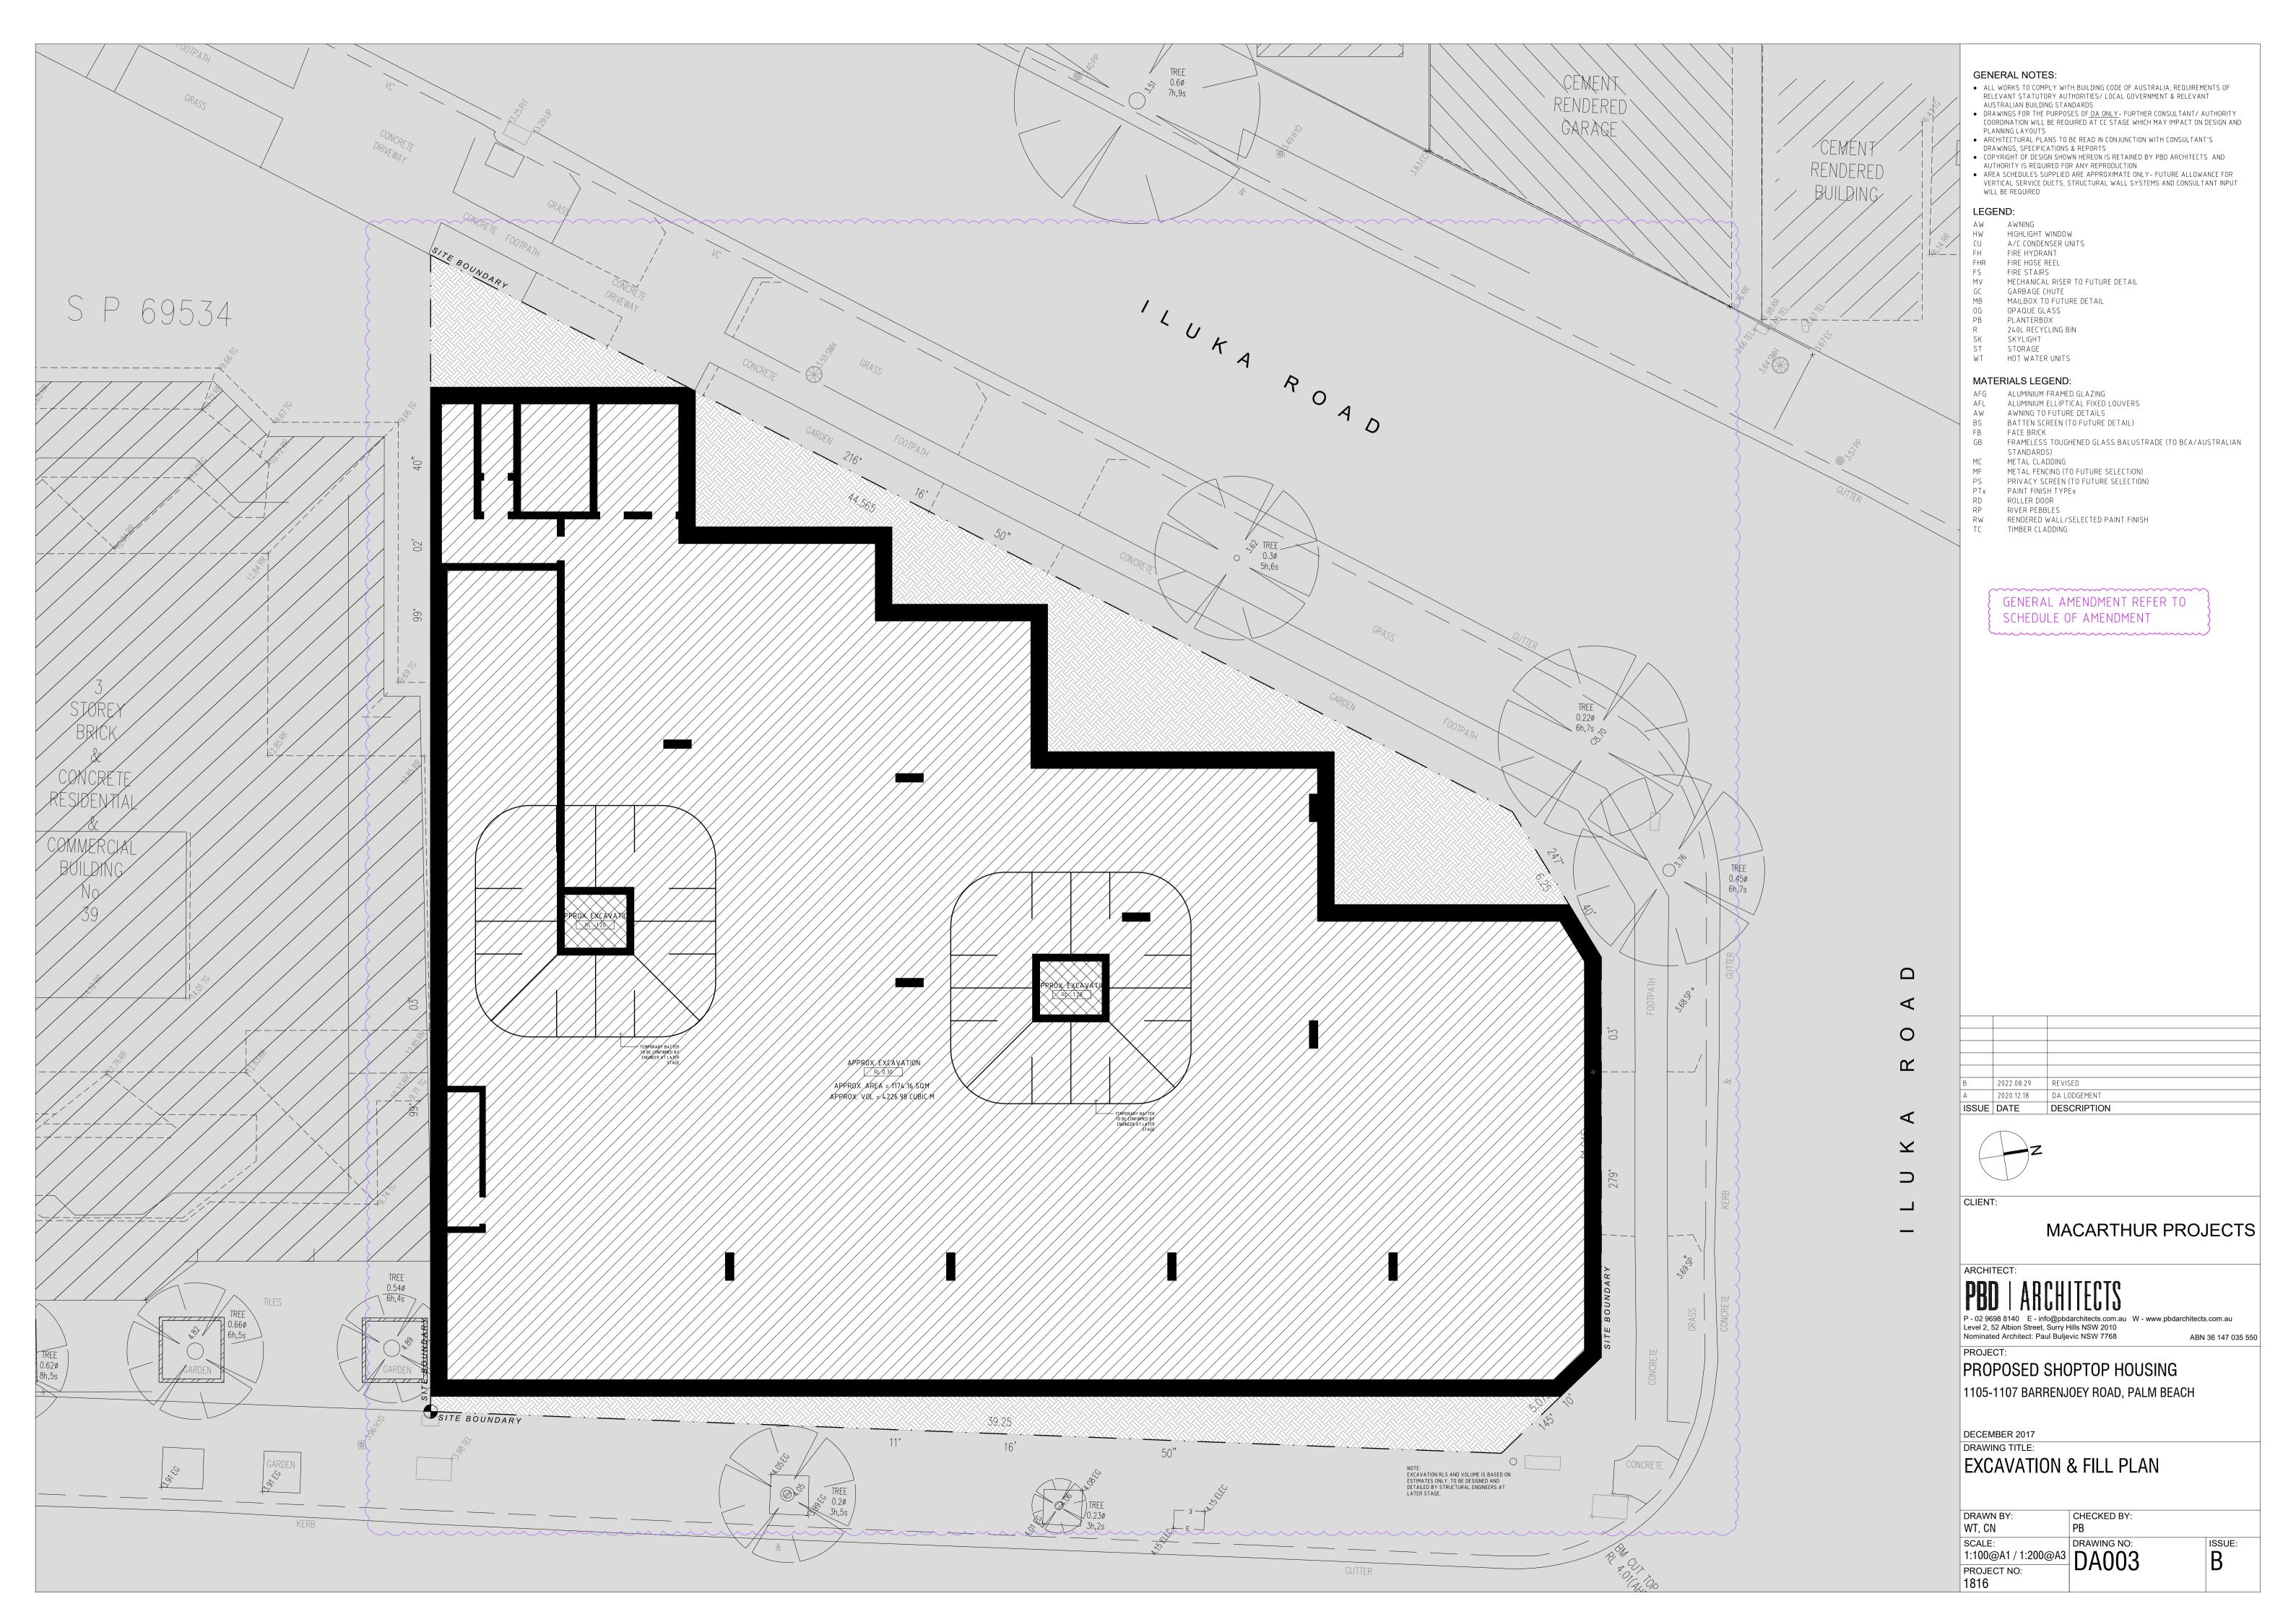


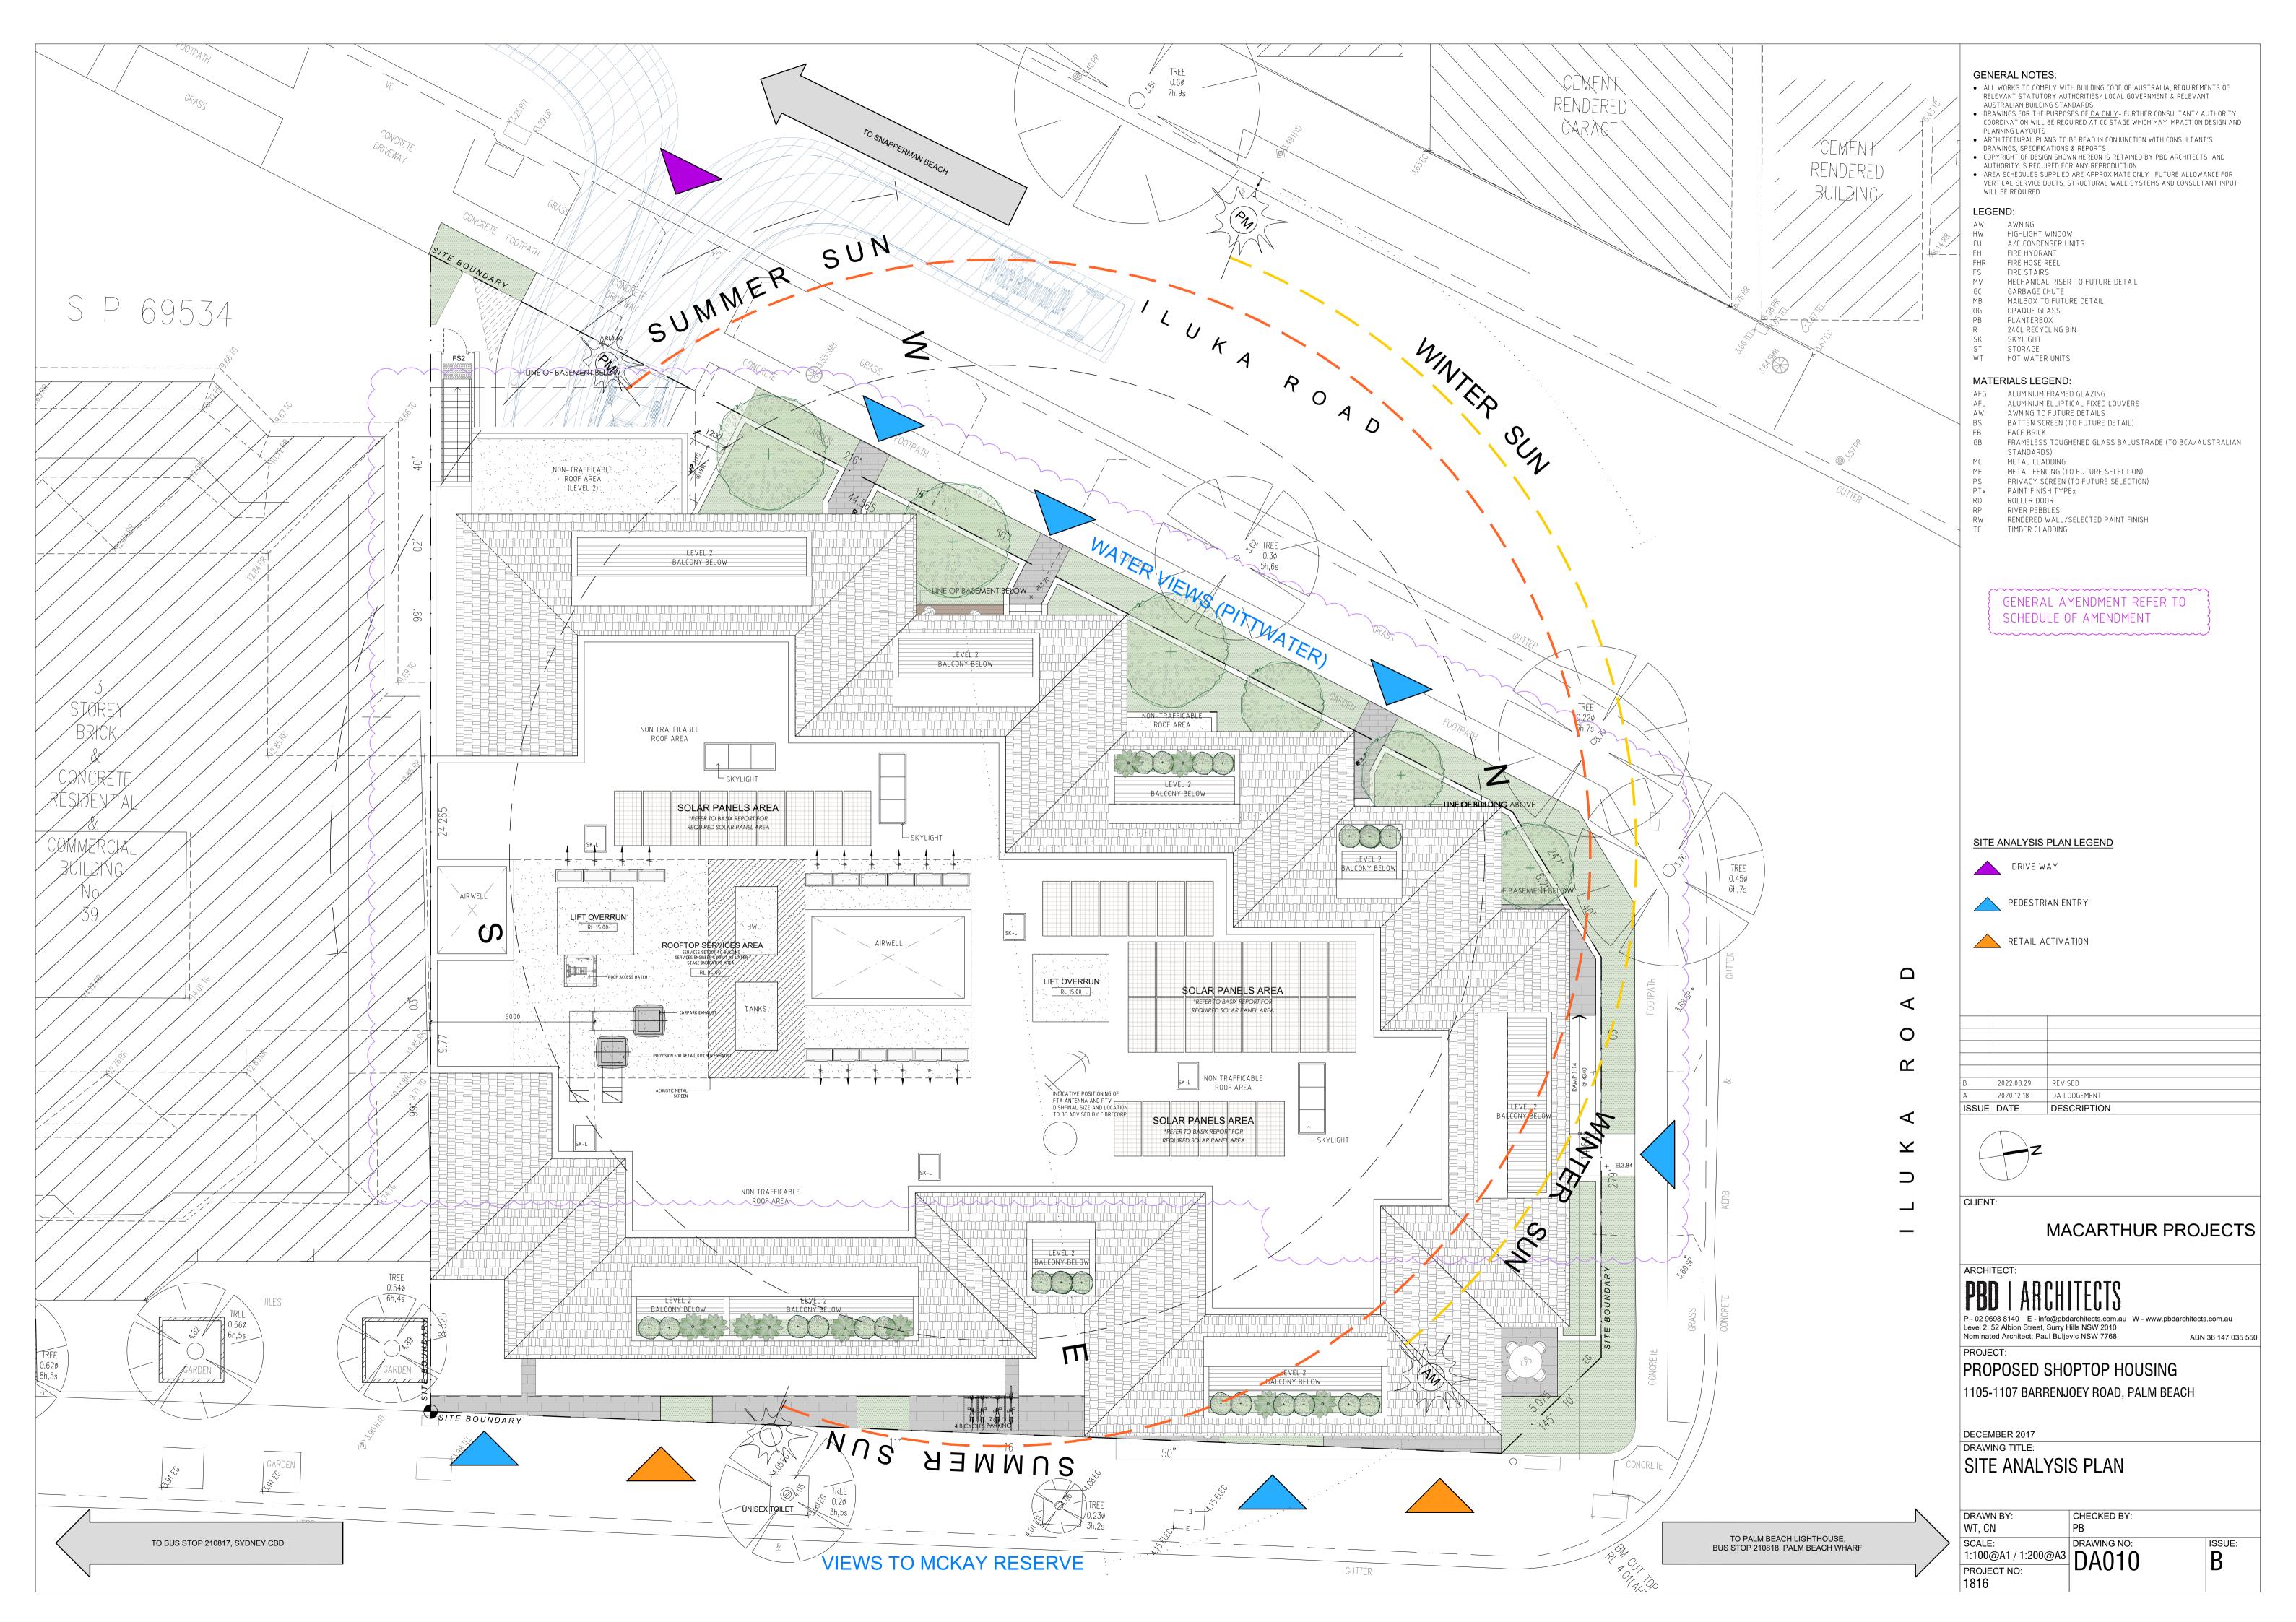


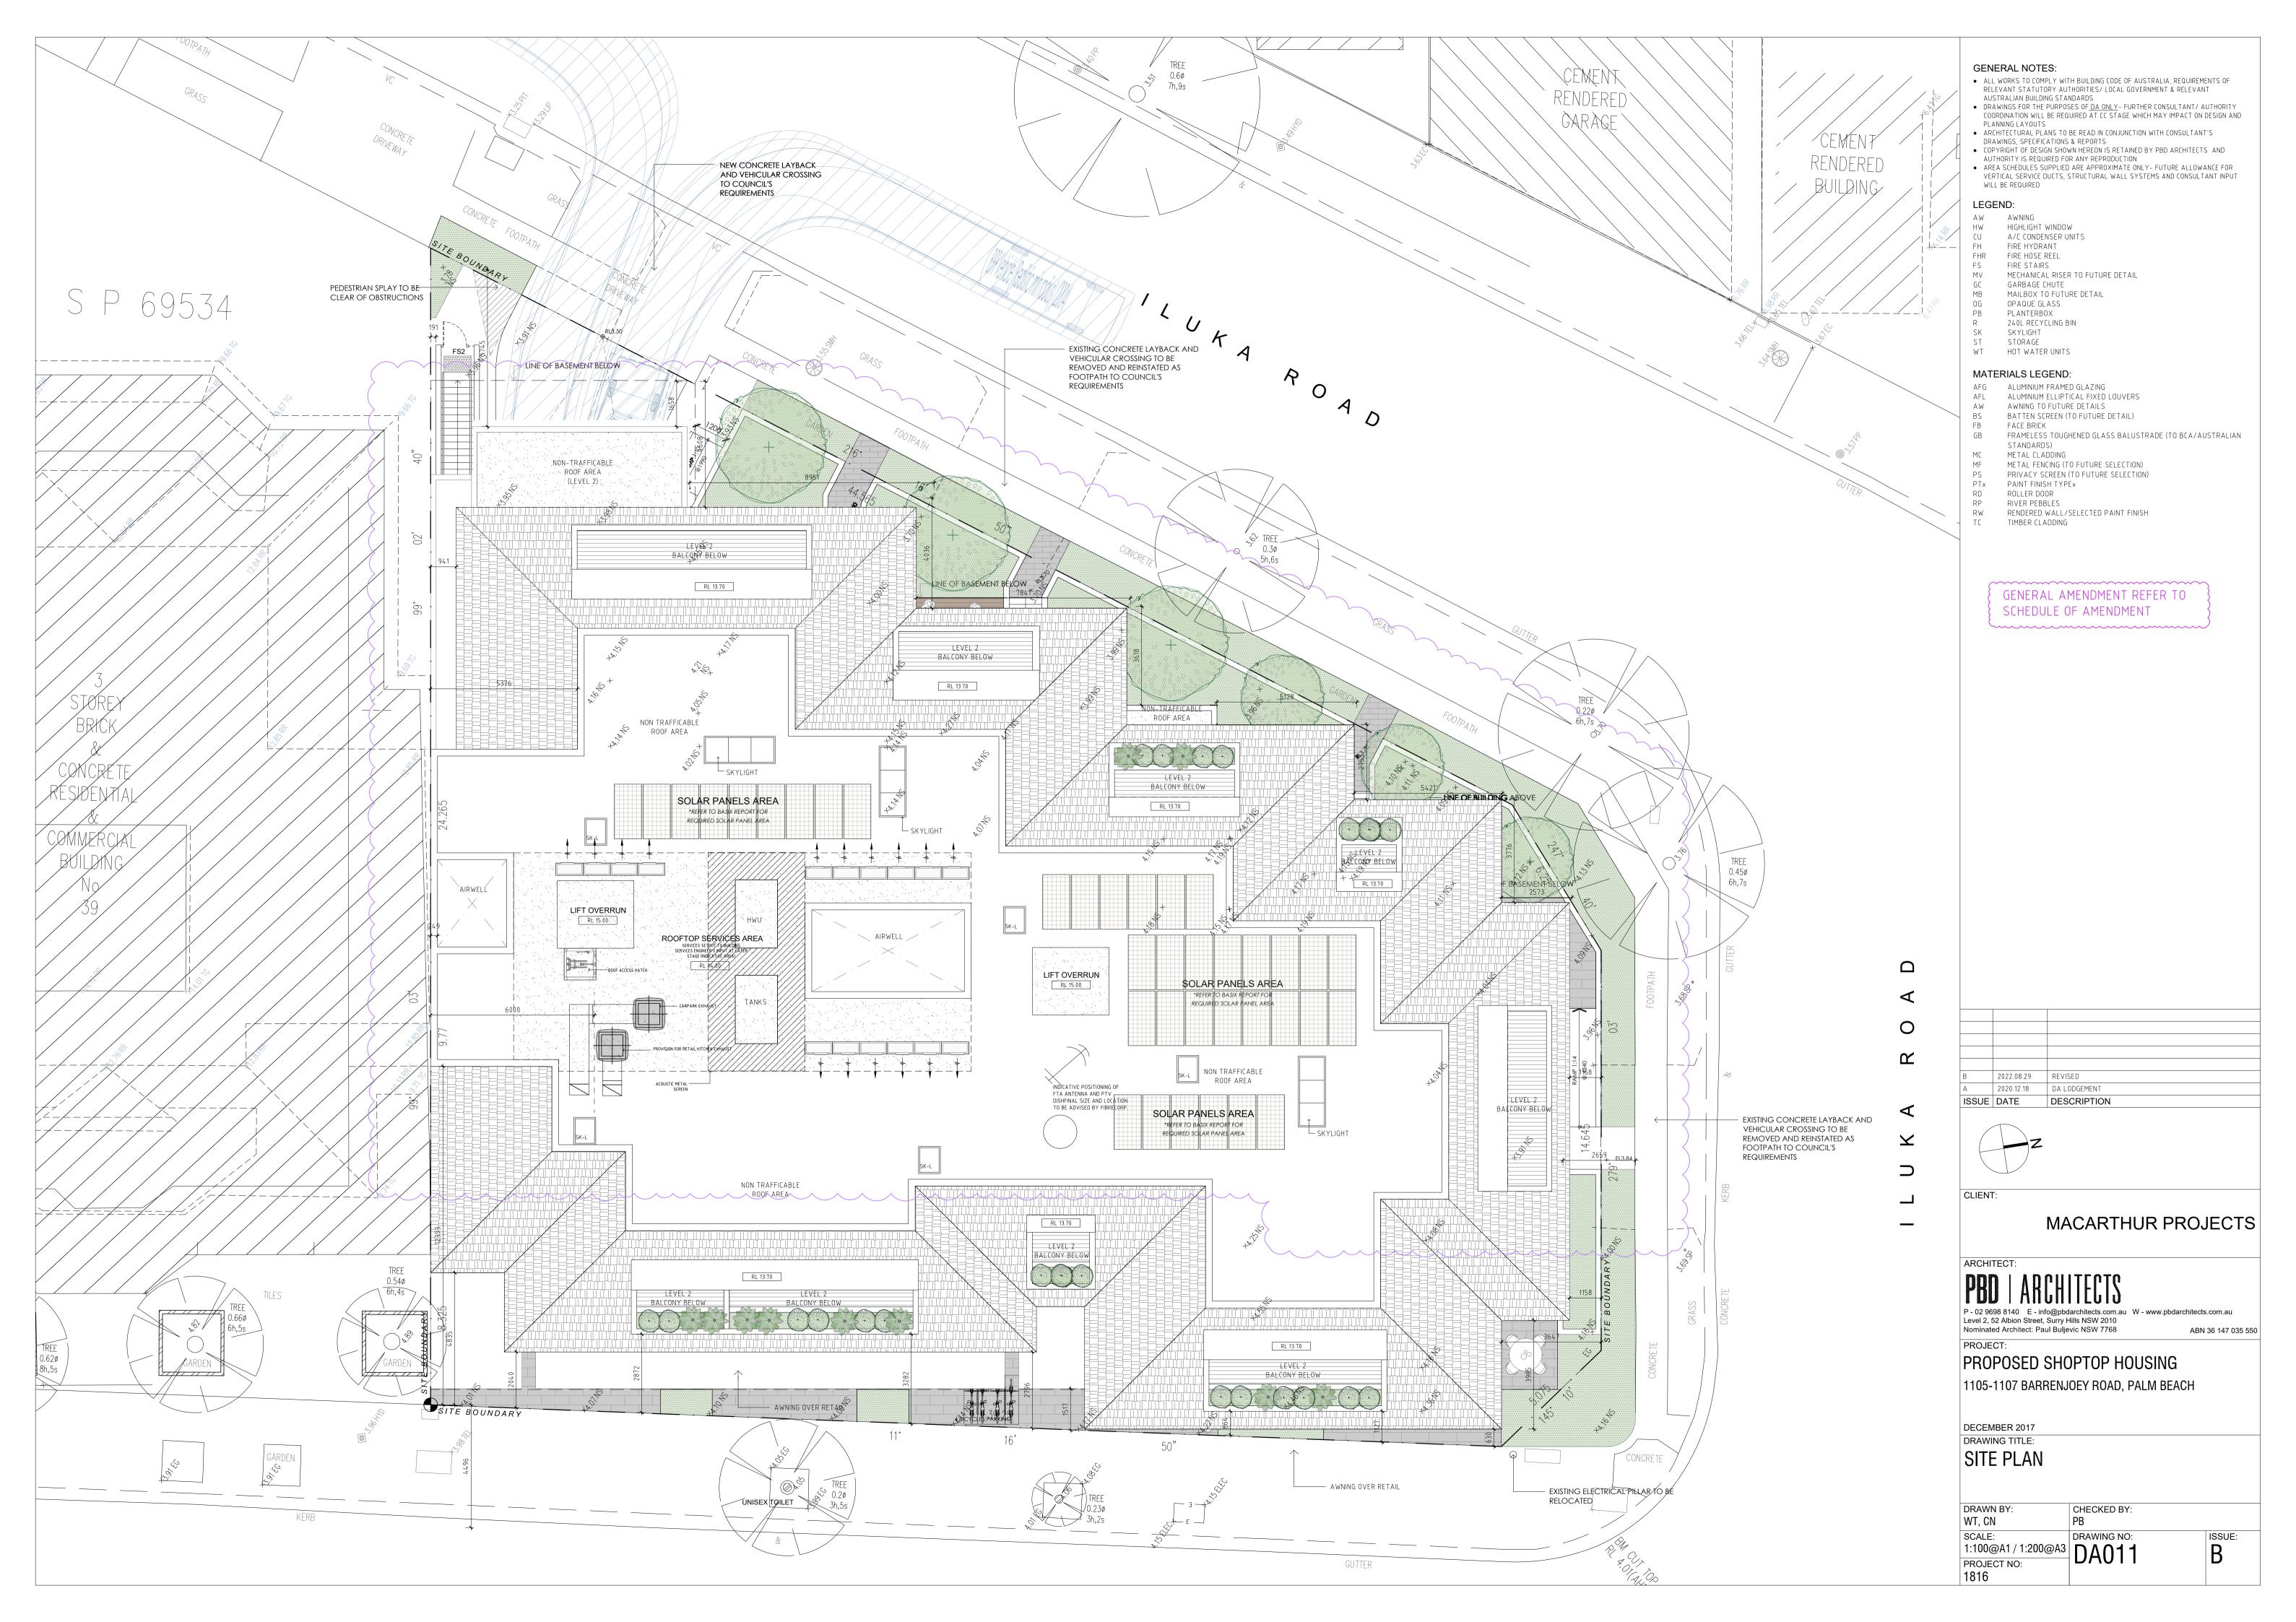


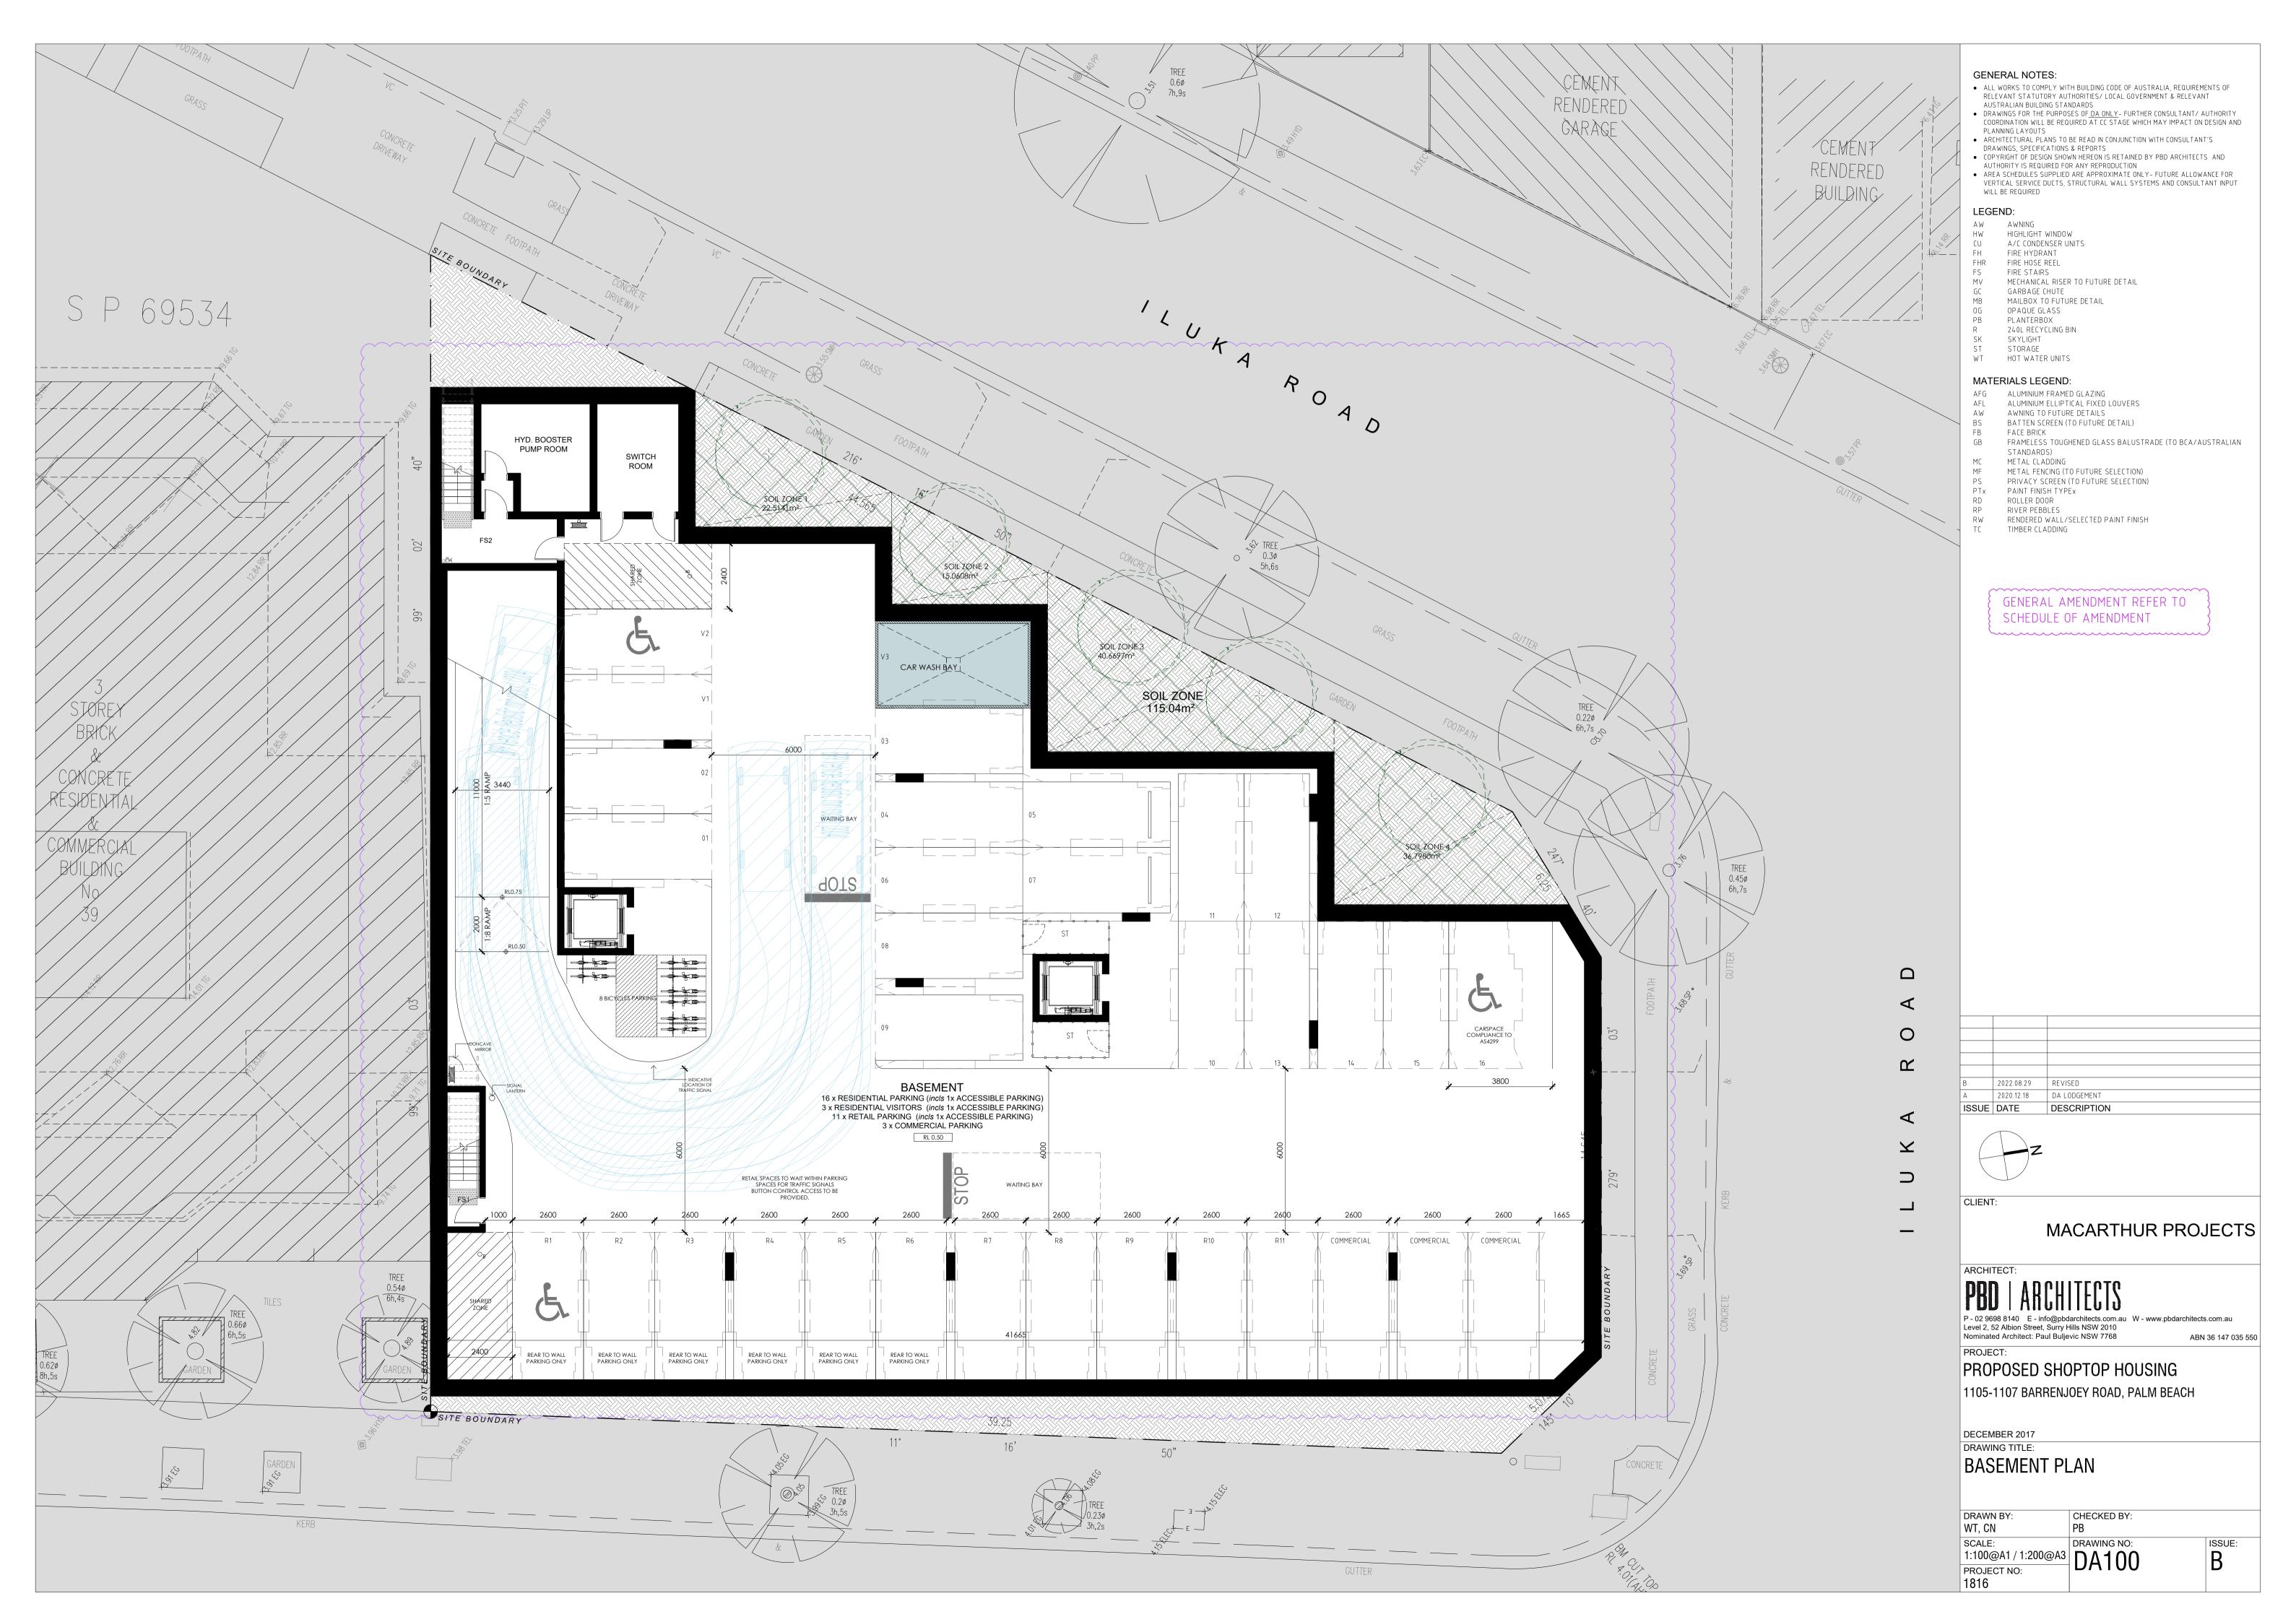

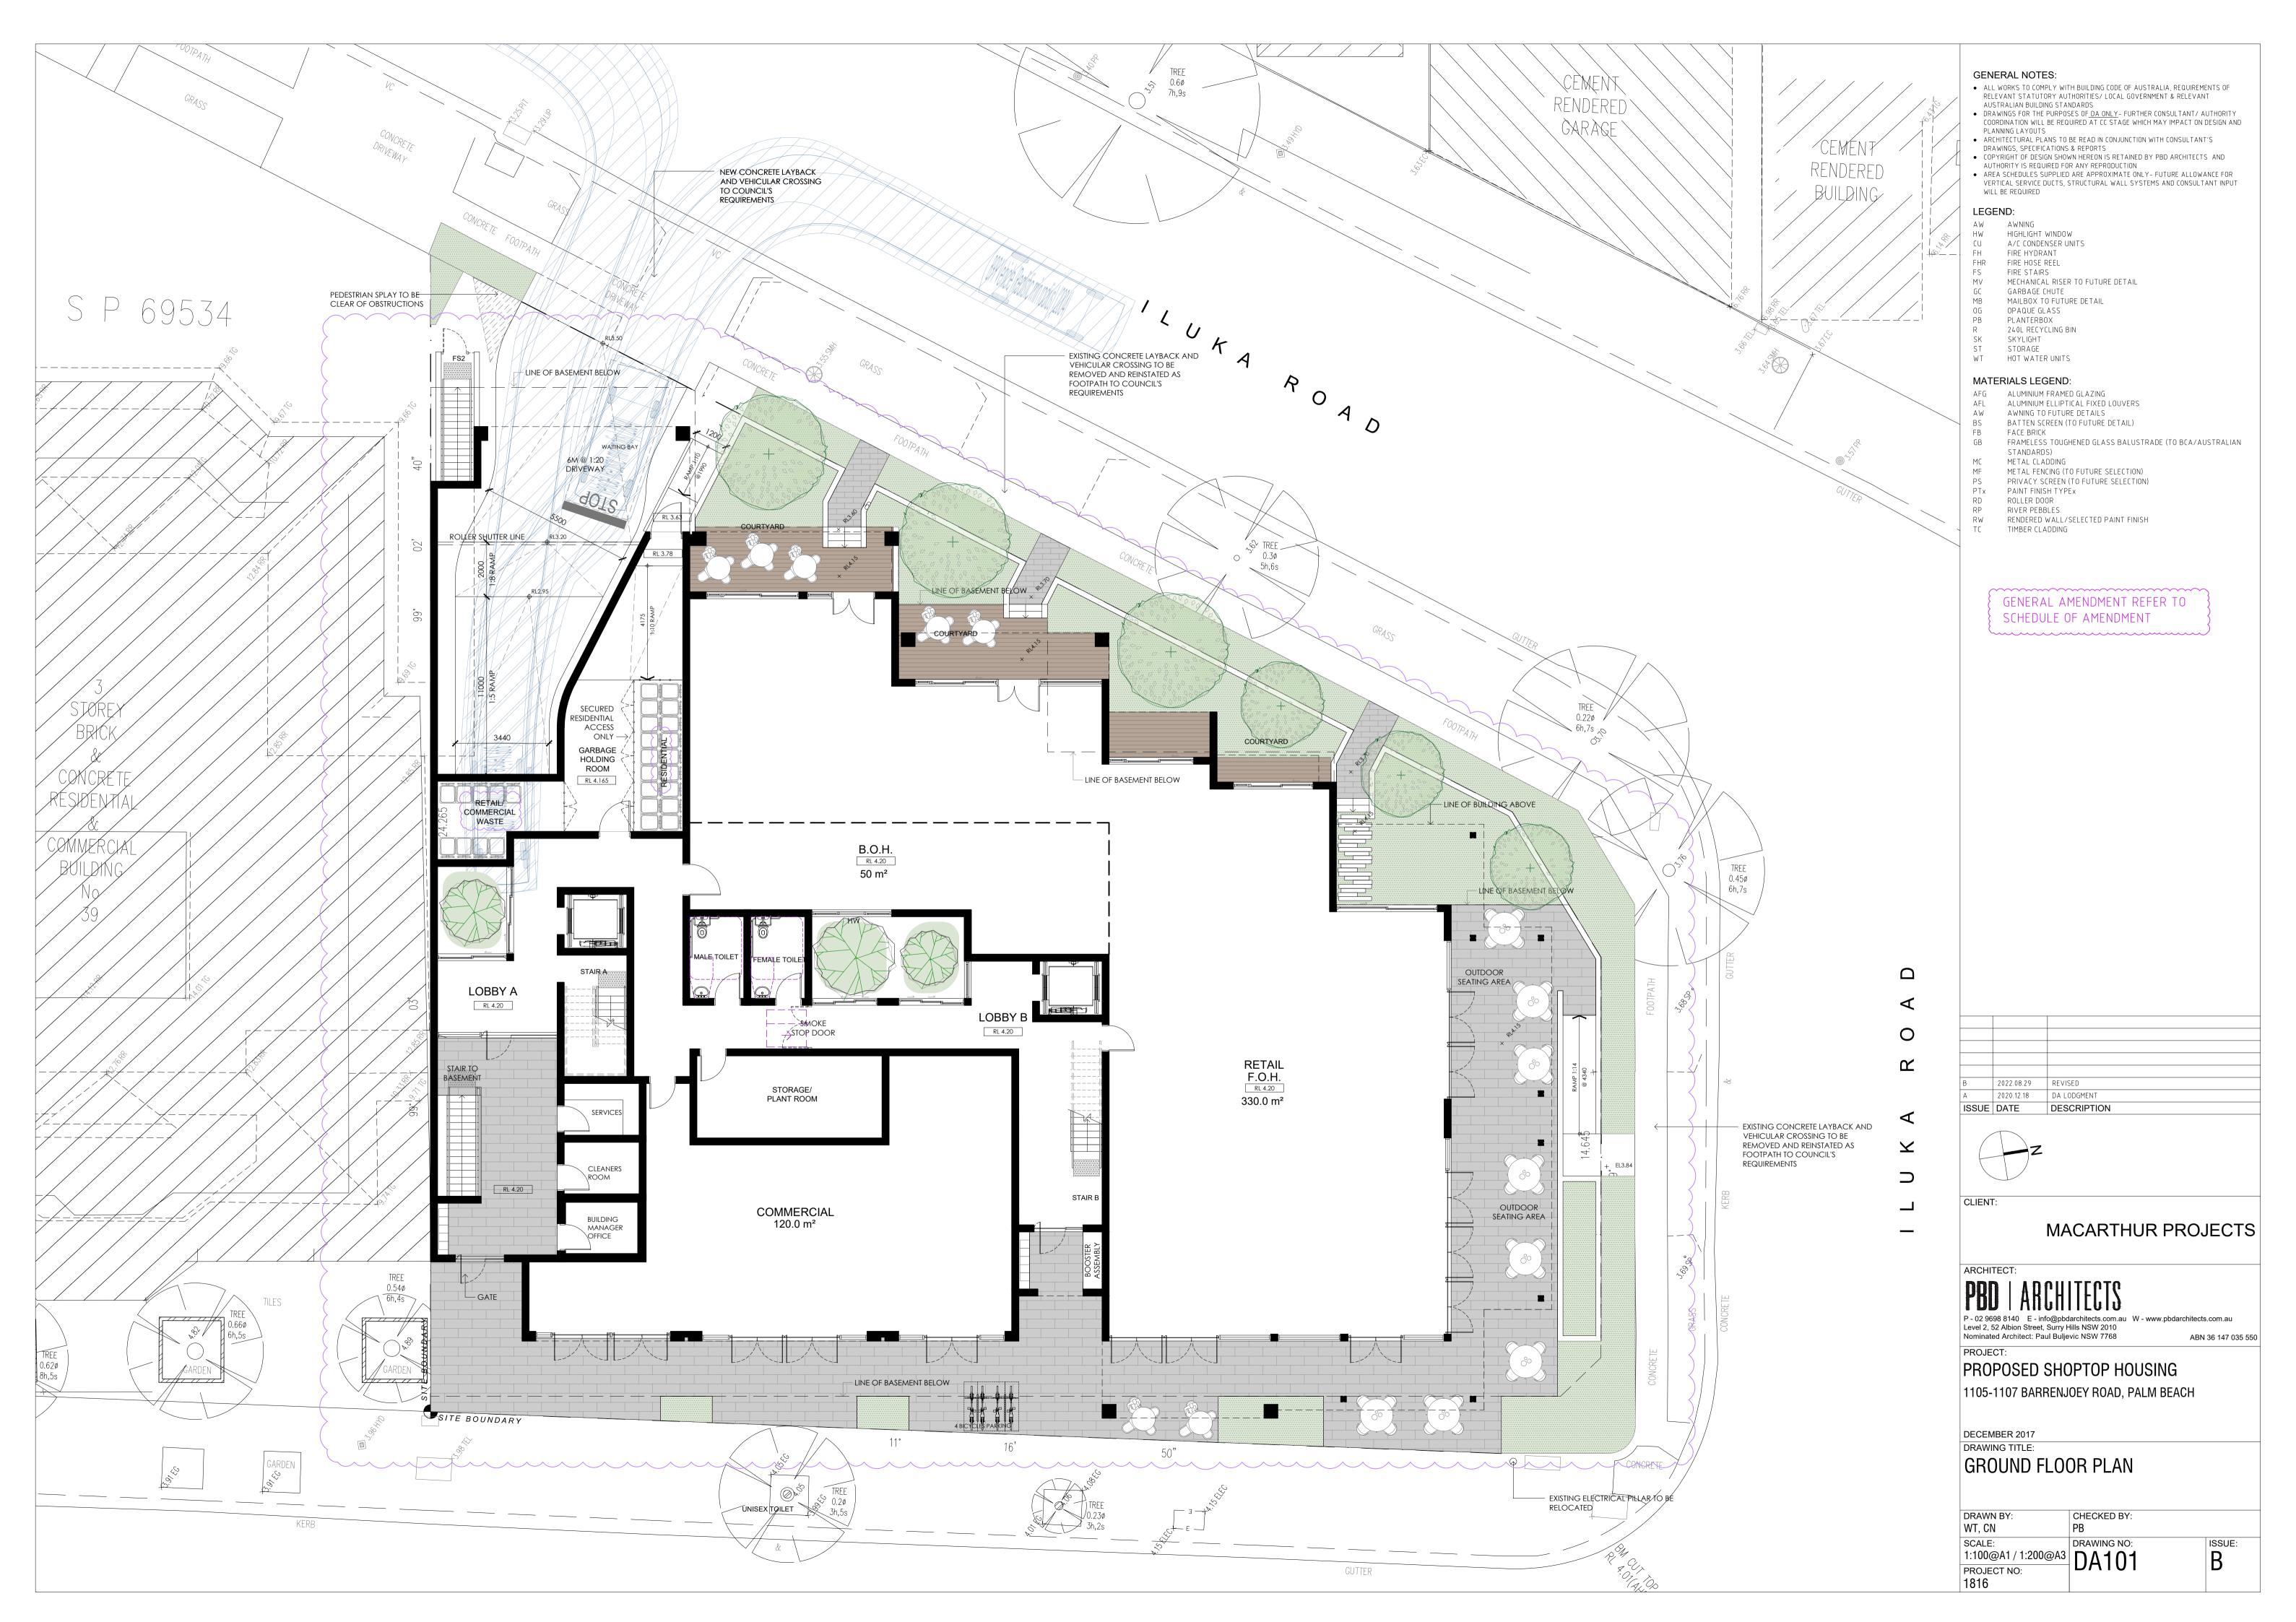

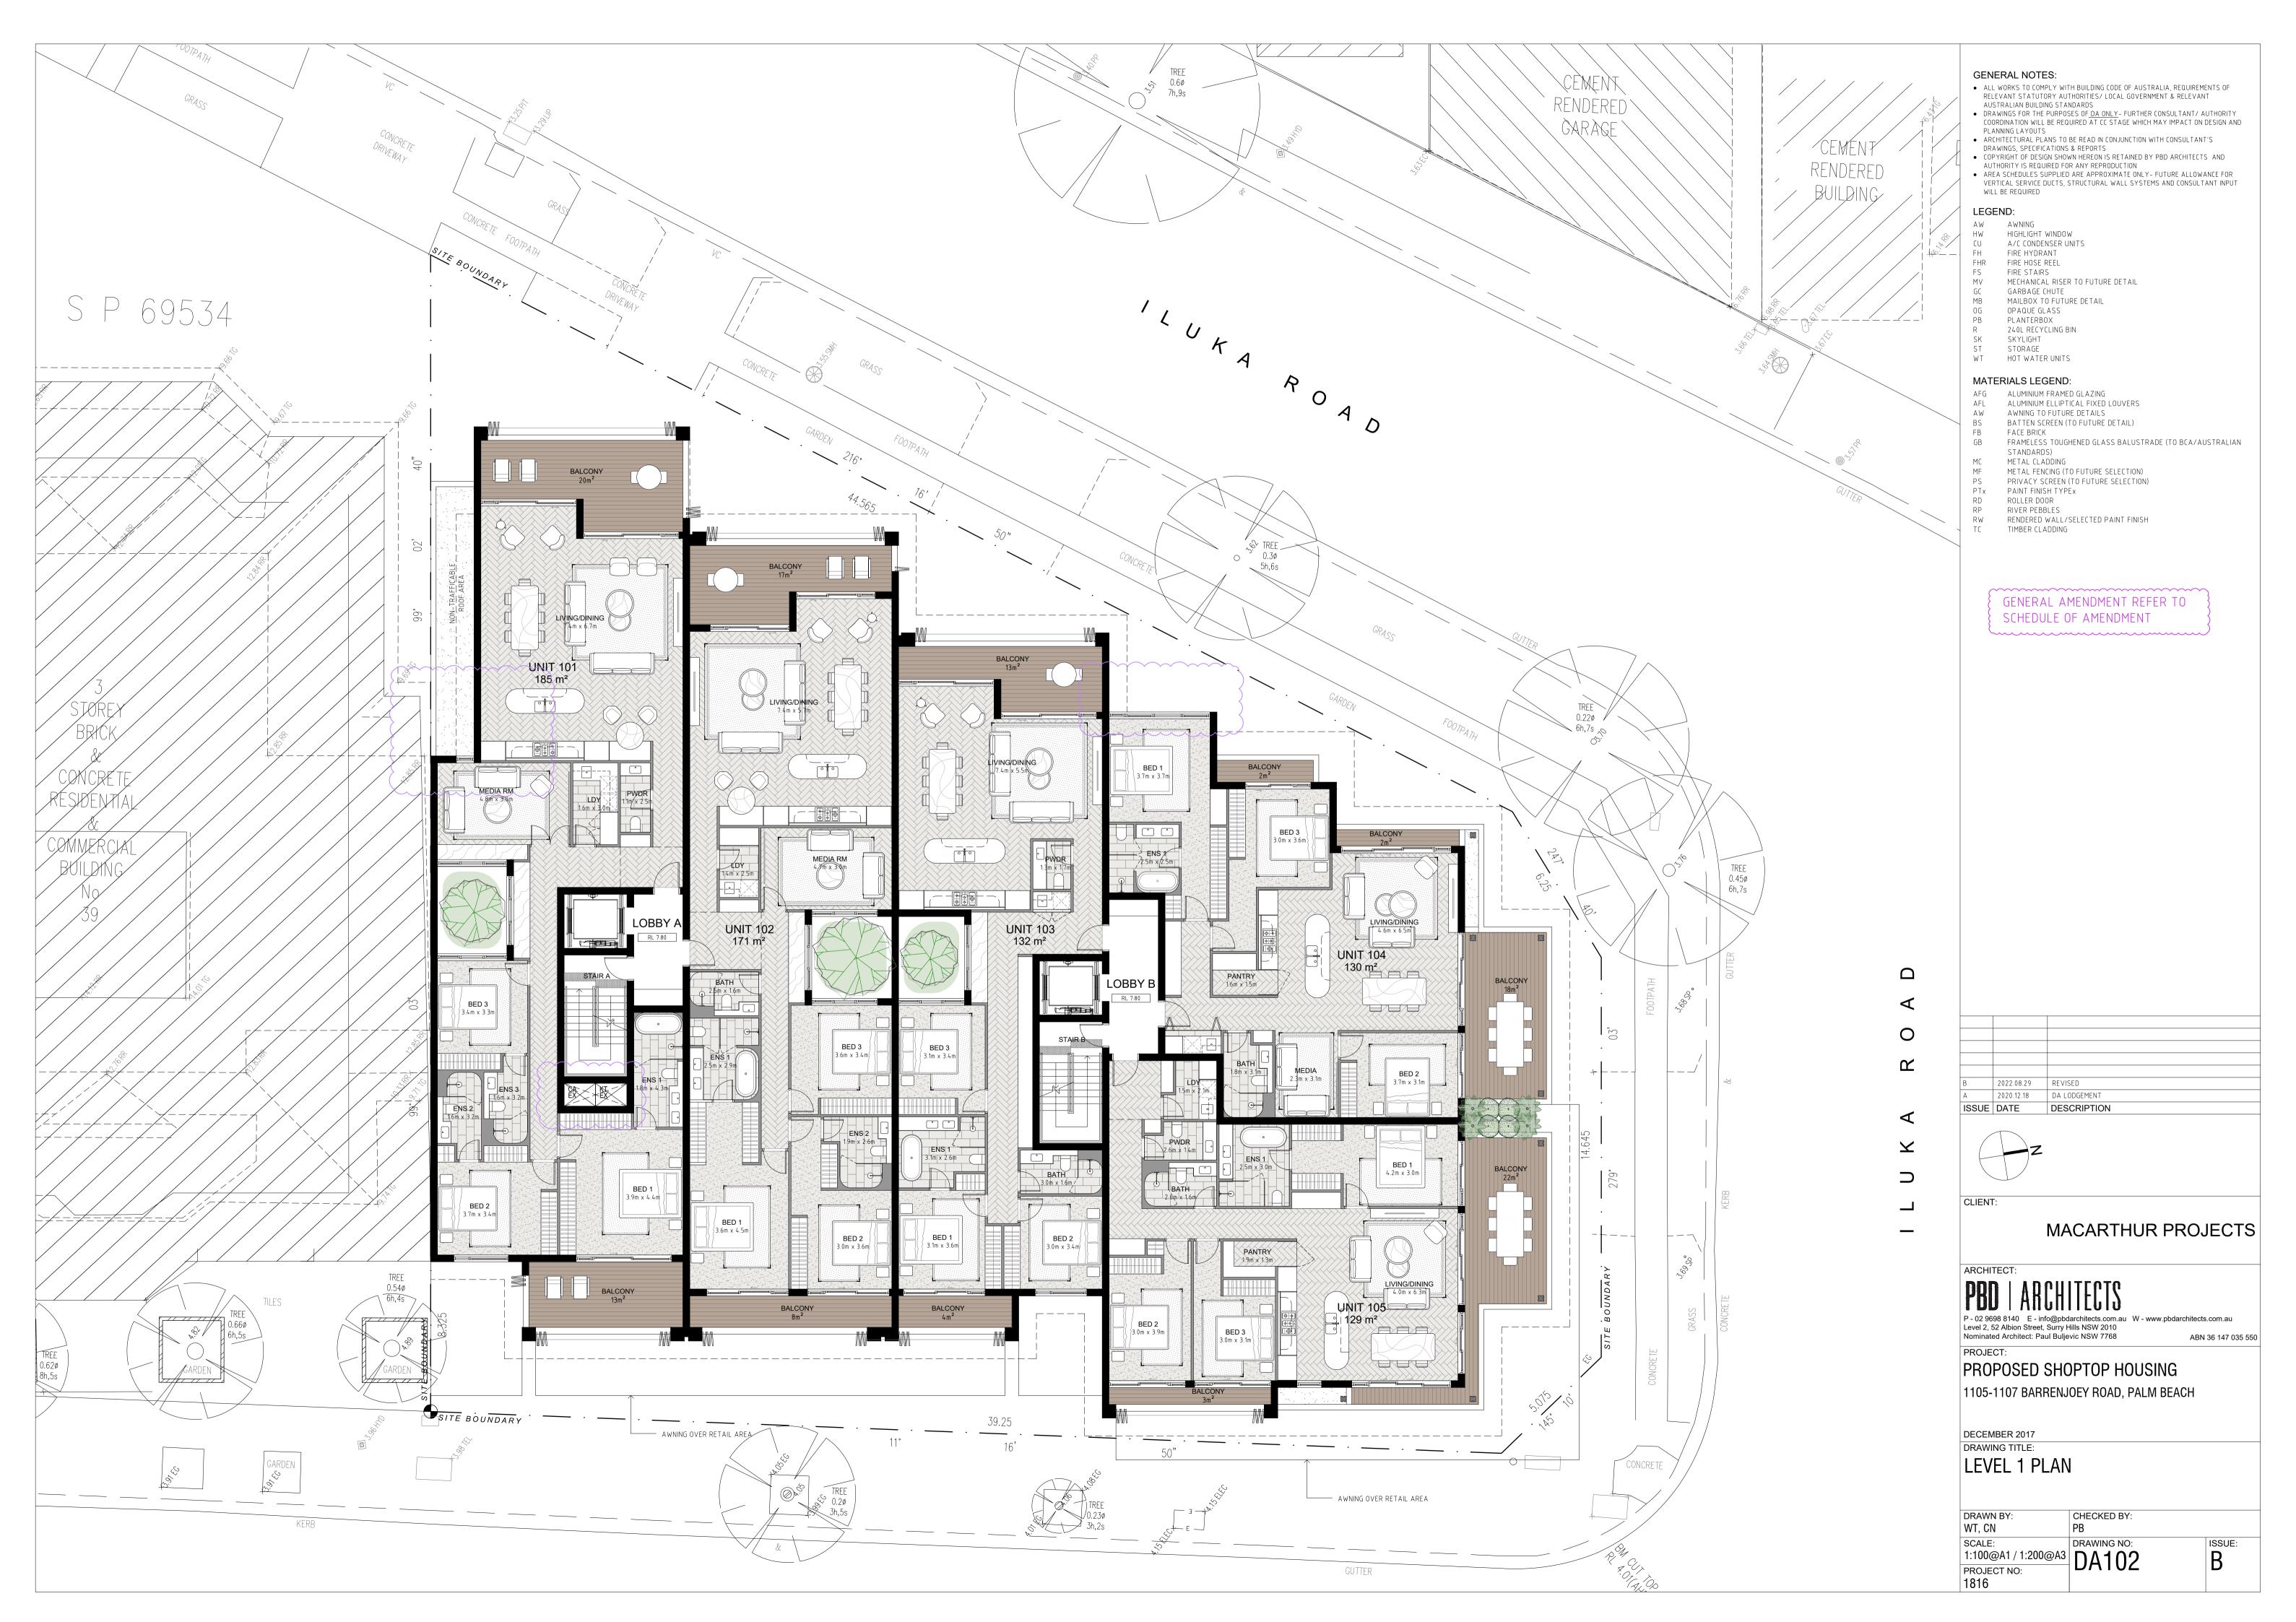

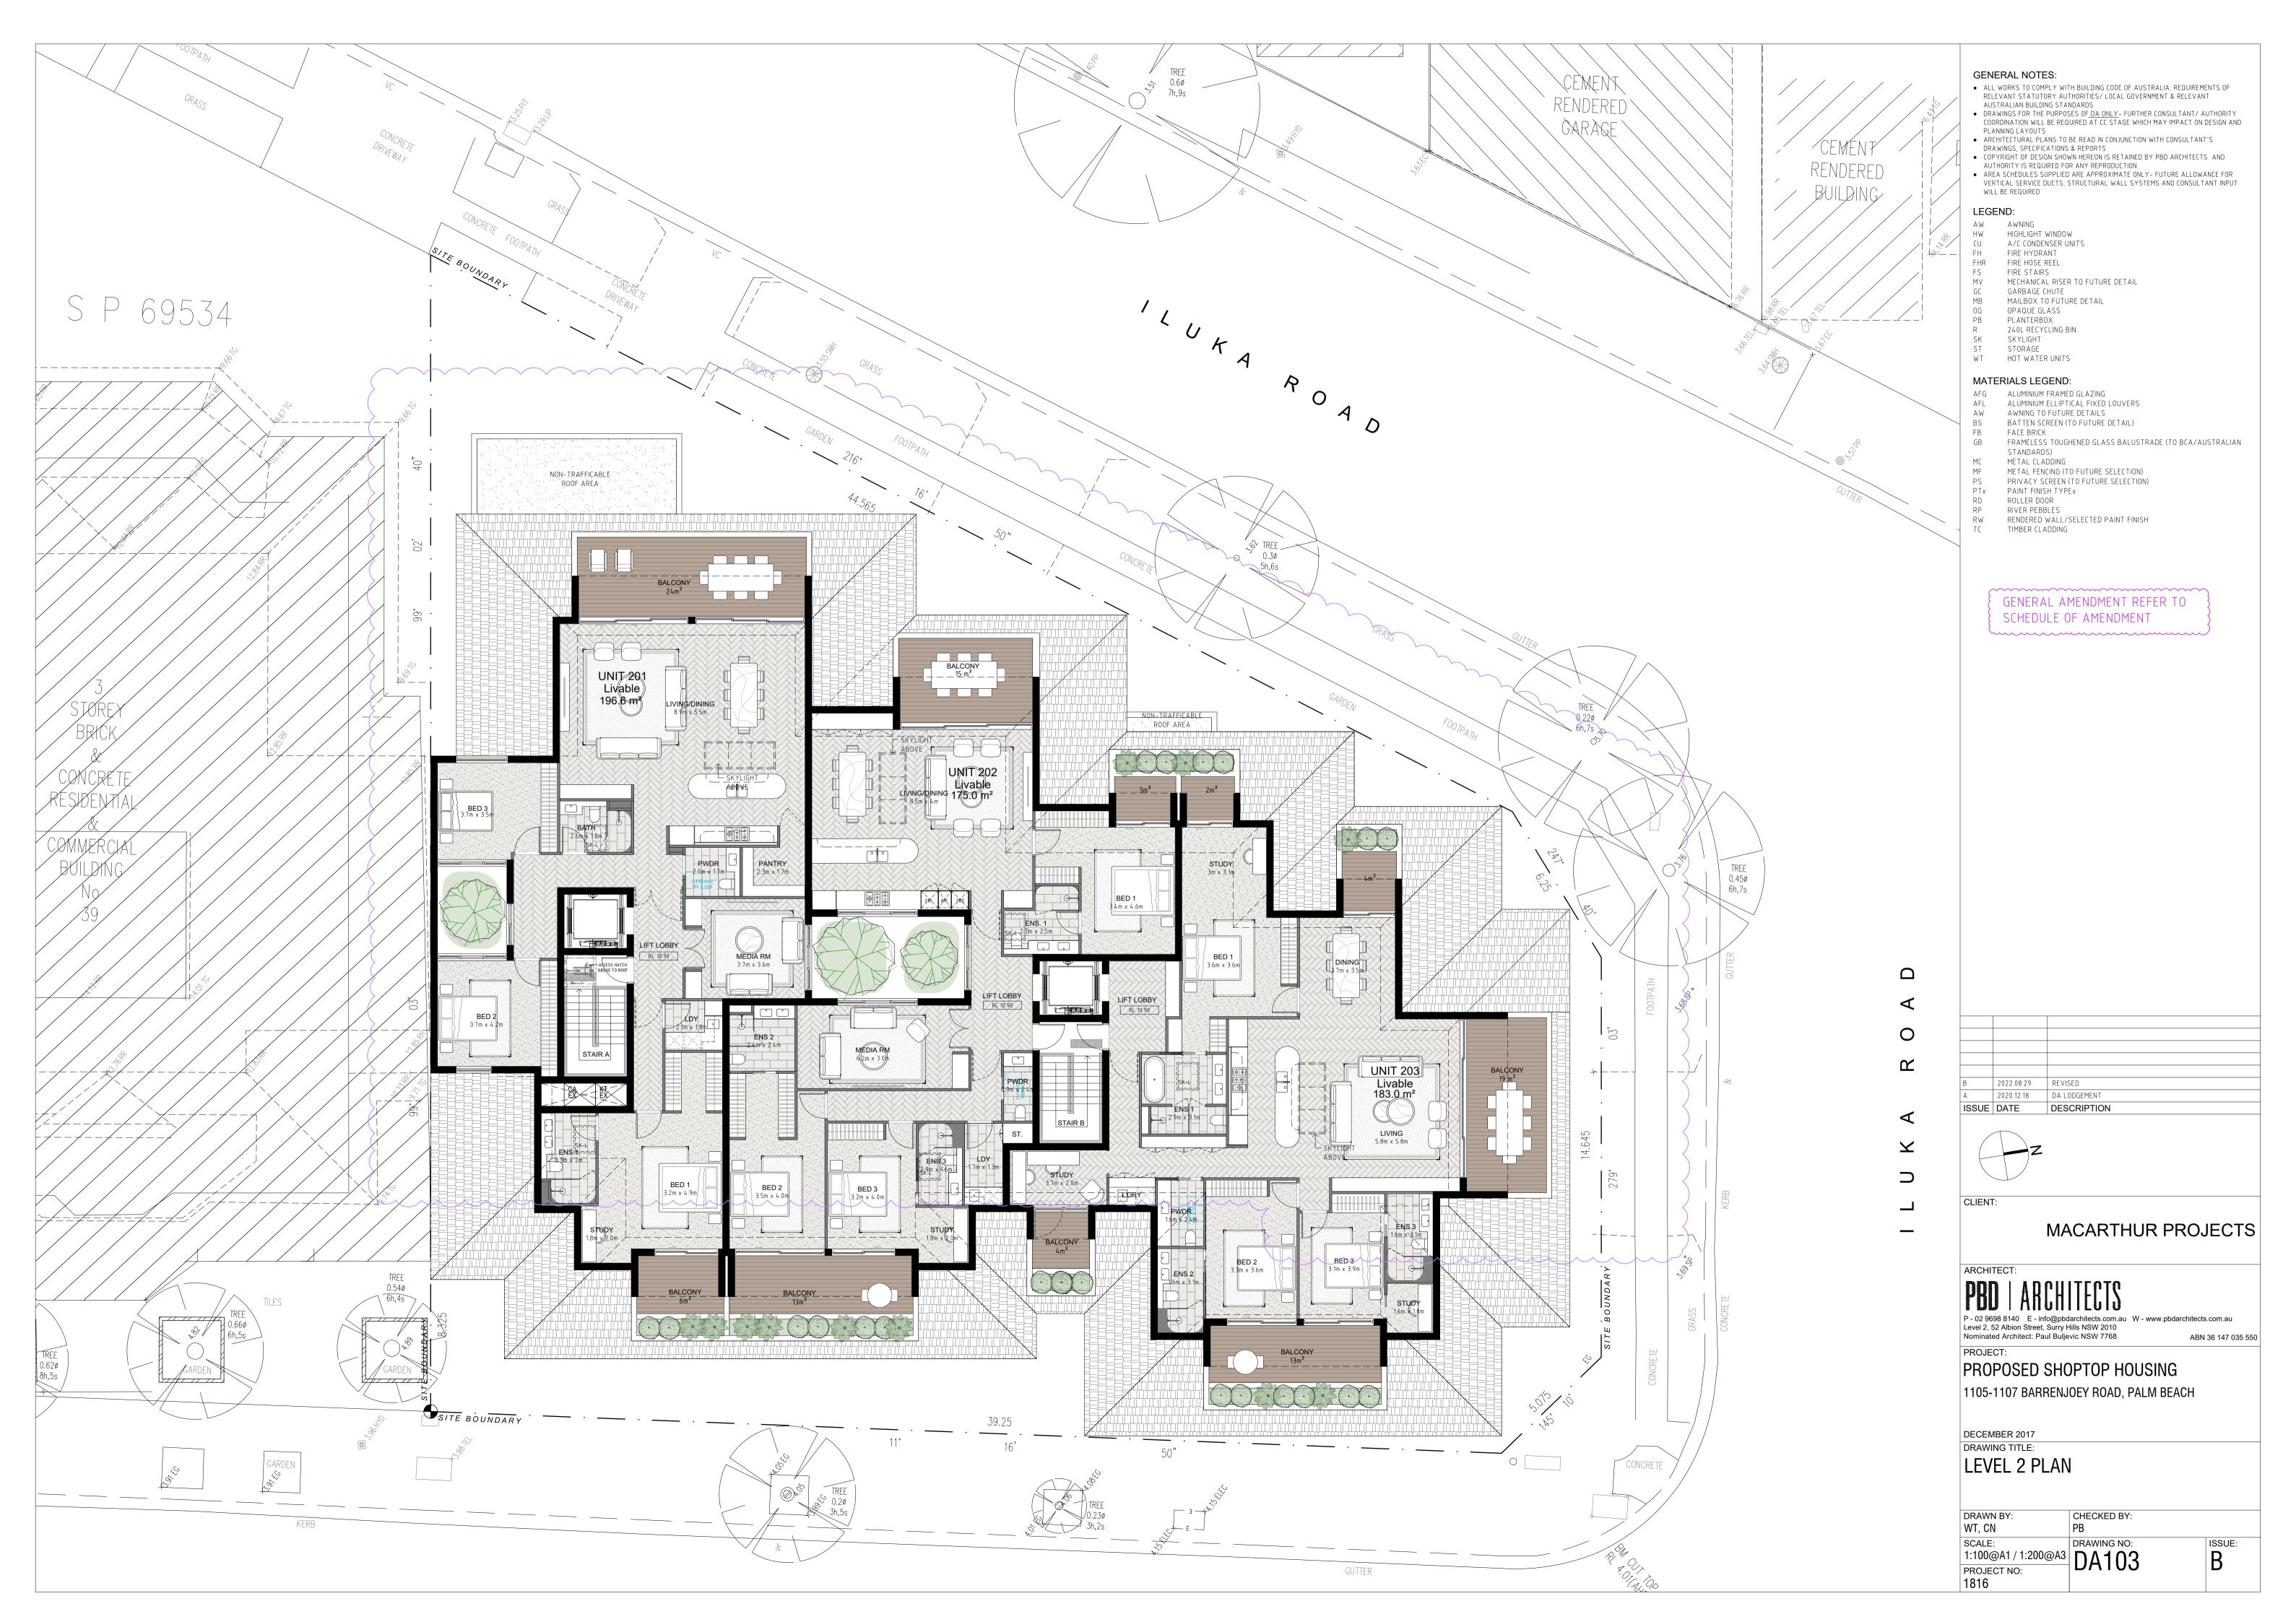

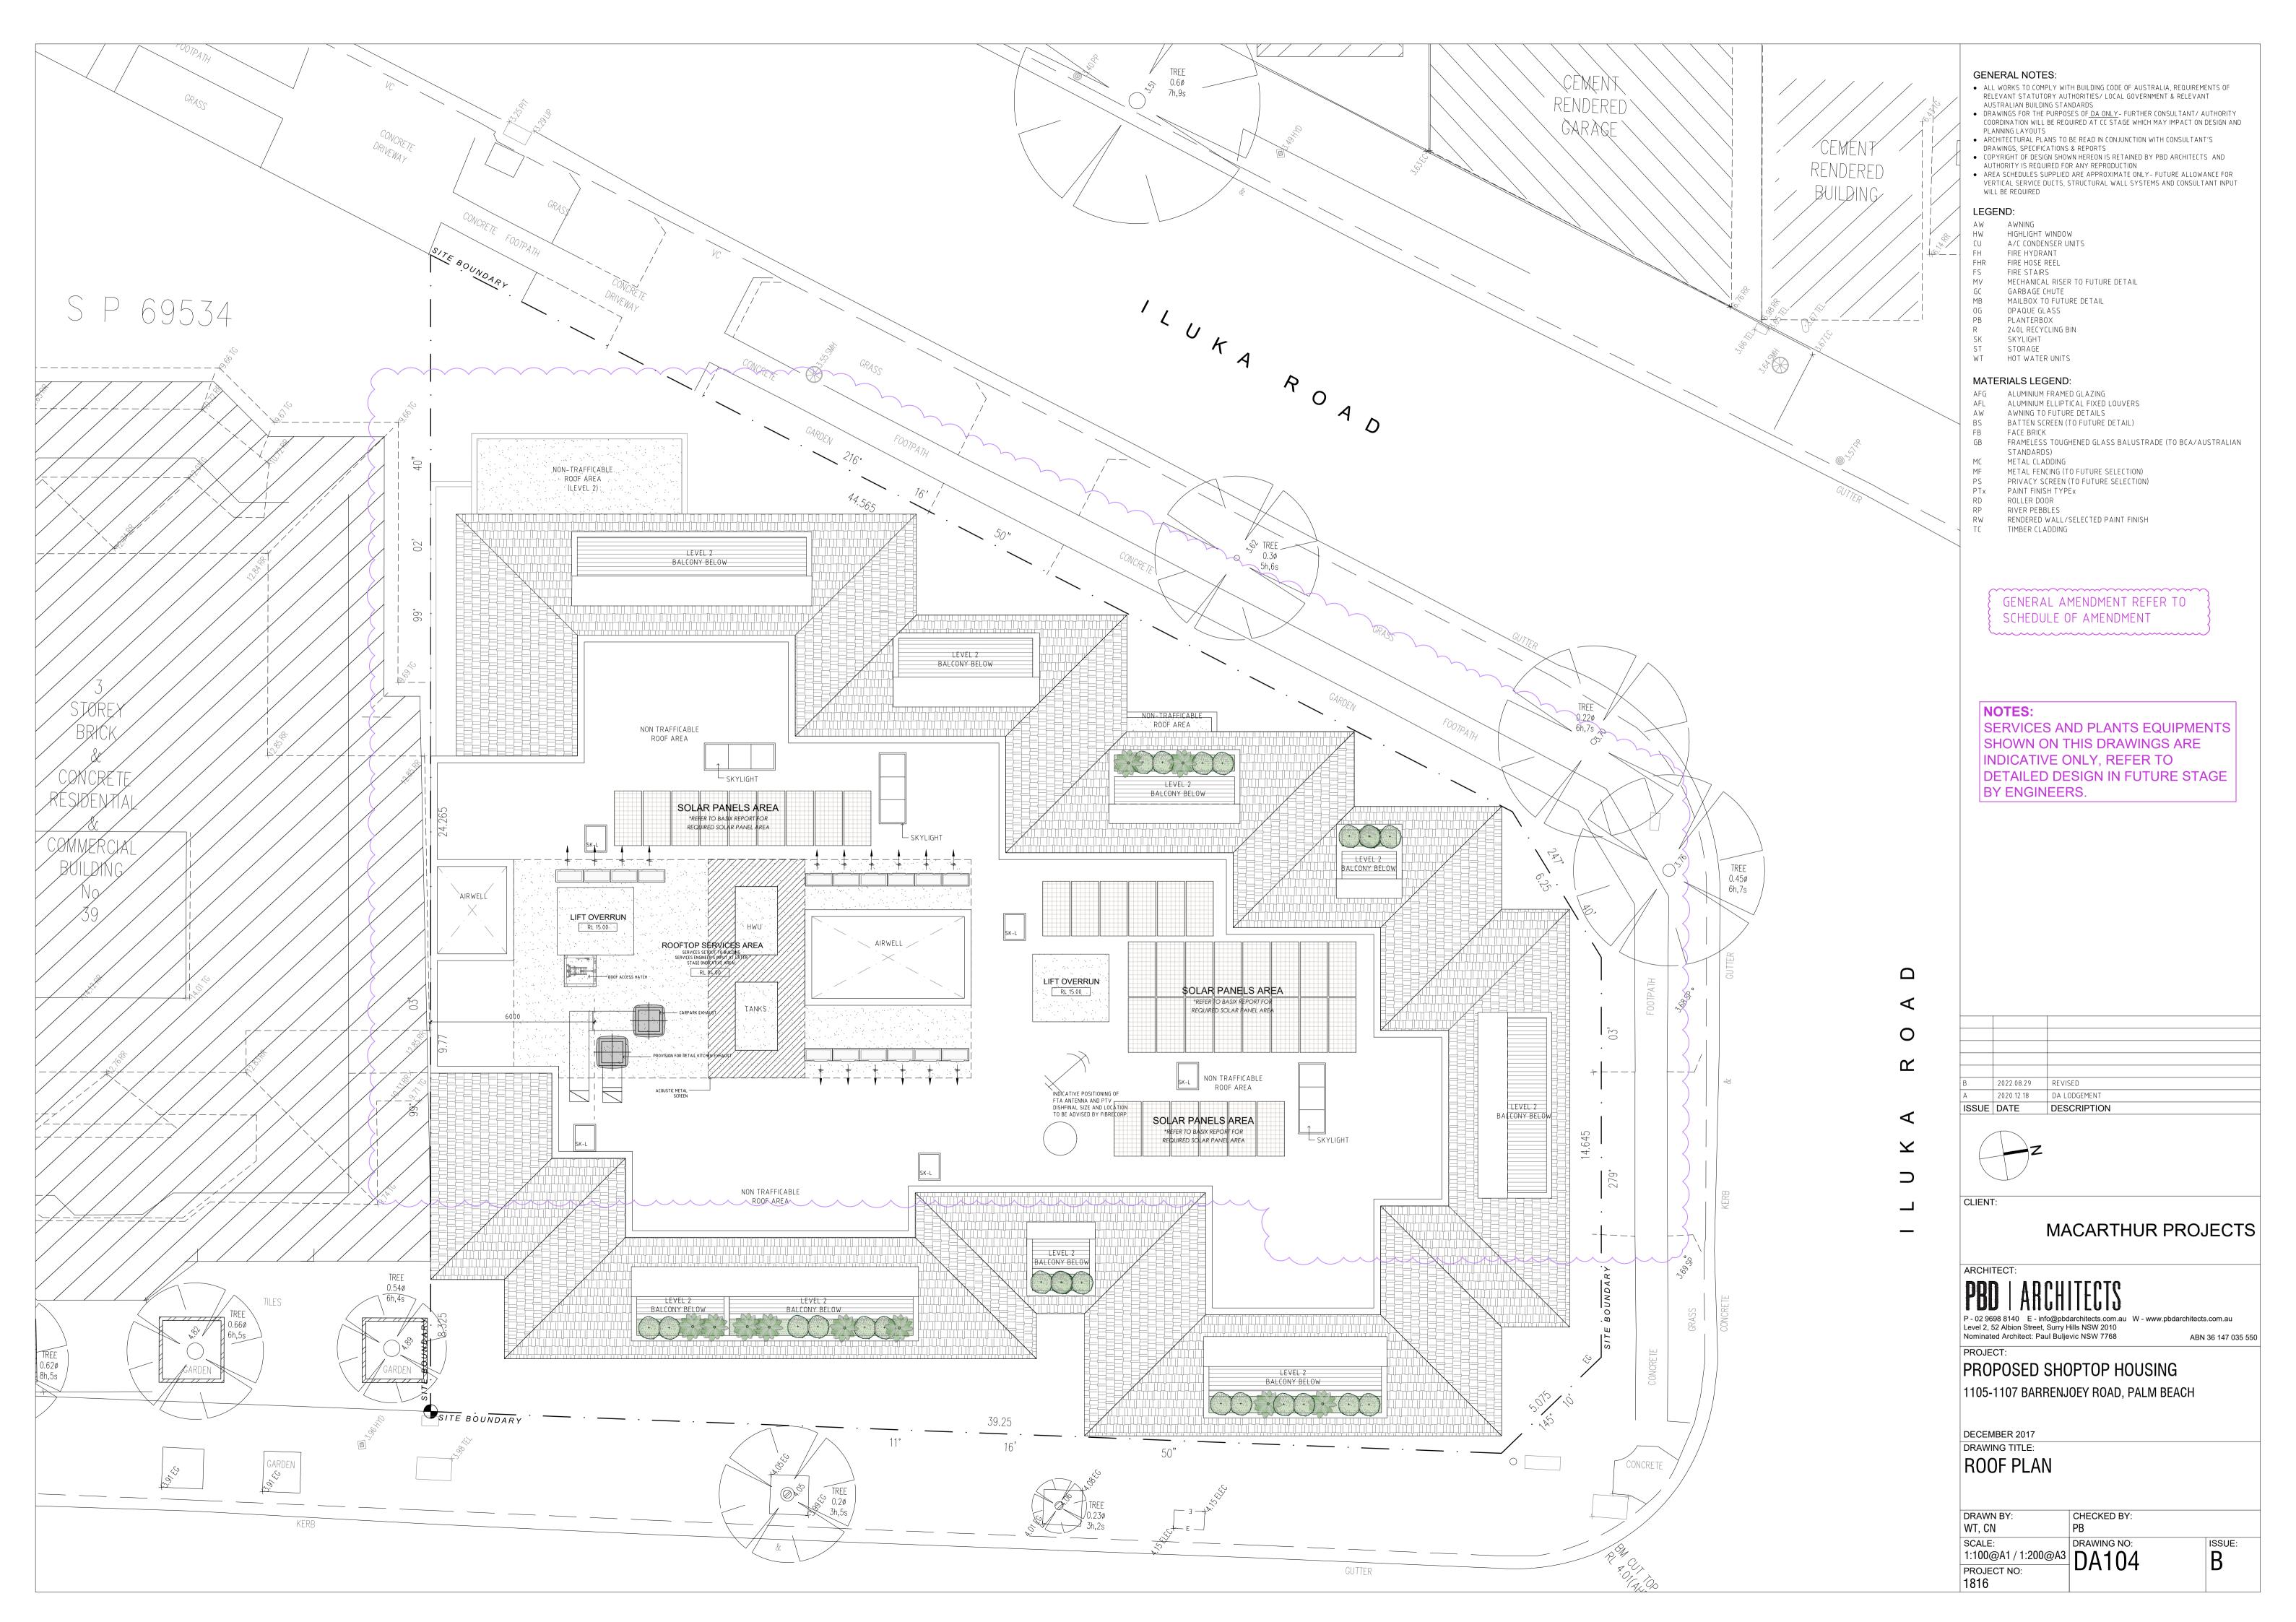





- ALL WORKS TO COMPLY WITH BUILDING CODE OF AUSTRALIA, REQUIREMENTS OF
- RELEVANT STATUTORY AUTHORITIES/ LOCAL GOVERNMENT & RELEVANT
 AUSTRALIAN BUILDING STANDARDS

 DRAWINGS FOR THE PURPOSES OF <u>DA ONLY</u> FURTHER CONSULTANT/ AUTHORITY
 COORDINATION WILL BE REQUIRED AT CC STAGE WHICH MAY IMPACT ON DESIGN AND PLANNING LAYOUTS
- ARCHITECTURAL PLANS TO BE READ IN CONJUNCTION WITH CONSULTANT'S DRAWINGS, SPECIFICATIONS & REPORTS
 COPYRIGHT OF DESIGN SHOWN HEREON IS RETAINED BY PBD ARCHITECTS AND
- AUTHORITY IS REQUIRED FOR ANY REPRODUCTION AREA SCHEDULES SUPPLIED ARE APPROXIMATE ONLY- FUTURE ALLOWANCE FOR VERTICAL SERVICE DUCTS, STRUCTURAL WALL SYSTEMS AND CONSULTANT INPUT

LEGEND:

WILL BE REQUIRED

AW AWNING HW HIGHLIGHT WINDOW A/C CONDENSER UNITS FH FIRE HYDRANT FHR FIRE HOSE REEL

FS FIRE STAIRS MECHANICAL RISER TO FUTURE DETAIL

GARBAGE CHUTE MAILBOX TO FUTURE DETAIL

OPAQUE GLASS PLANTERBOX

240L RECYCLING BIN

SKYLIGHT ST STORAGE WT HOT WATER UNITS

MATERIALS LEGEND:

AFG ALUMINIUM FRAMED GLAZING
AFL ALUMINIUM ELLIPTICAL FIXED LOUVERS

AW AWNING TO FUTURE DETAILS BATTEN SCREEN (TO FUTURE DETAIL)

FB FACE BRICK FRAMELESS TOUGHENED GLASS BALUSTRADE (TO BCA/AUSTRALIAN

STANDARDS)

MC METAL CLADDING
MF METAL FENCING (TO FUTURE SELECTION)
PS PRIVACY SCREEN (TO FUTURE SELECTION)

PTX PAINT FINISH TYPEX ROLLER DOOR

RIVER PEBBLES

RW RENDERED WALL/SELECTED PAINT FINISH TC TIMBER CLADDING

> GENERAL AMENDMENT REFER TO SCHEDULE OF AMENDMENT

	22.08.29 20.12.18	REVISED DDA LODGEMENT
В 20	22.08.29	REVISED

CLIENT:

MACARTHUR PROJECTS

ARCHITECT:

Level 2, 52 Albion Street, Surry Hills NSW 2010 Nominated Architect: Paul Buljevic NSW 7768

ABN 36 147 035 550

PROPOSED SHOPTOP HOUSING 1105-1107 BARRENJOEY ROAD, PALM BEACH

DECEMBER 2017


1816

DRAWING TITLE: NORTH ELEVATION

DRAWN BY: CHECKED BY: WT, CN

SCALE: DRAWING NO: 1:100@A1 / 1:200@A3 DA201 PROJECT NO:

ISSUE: В

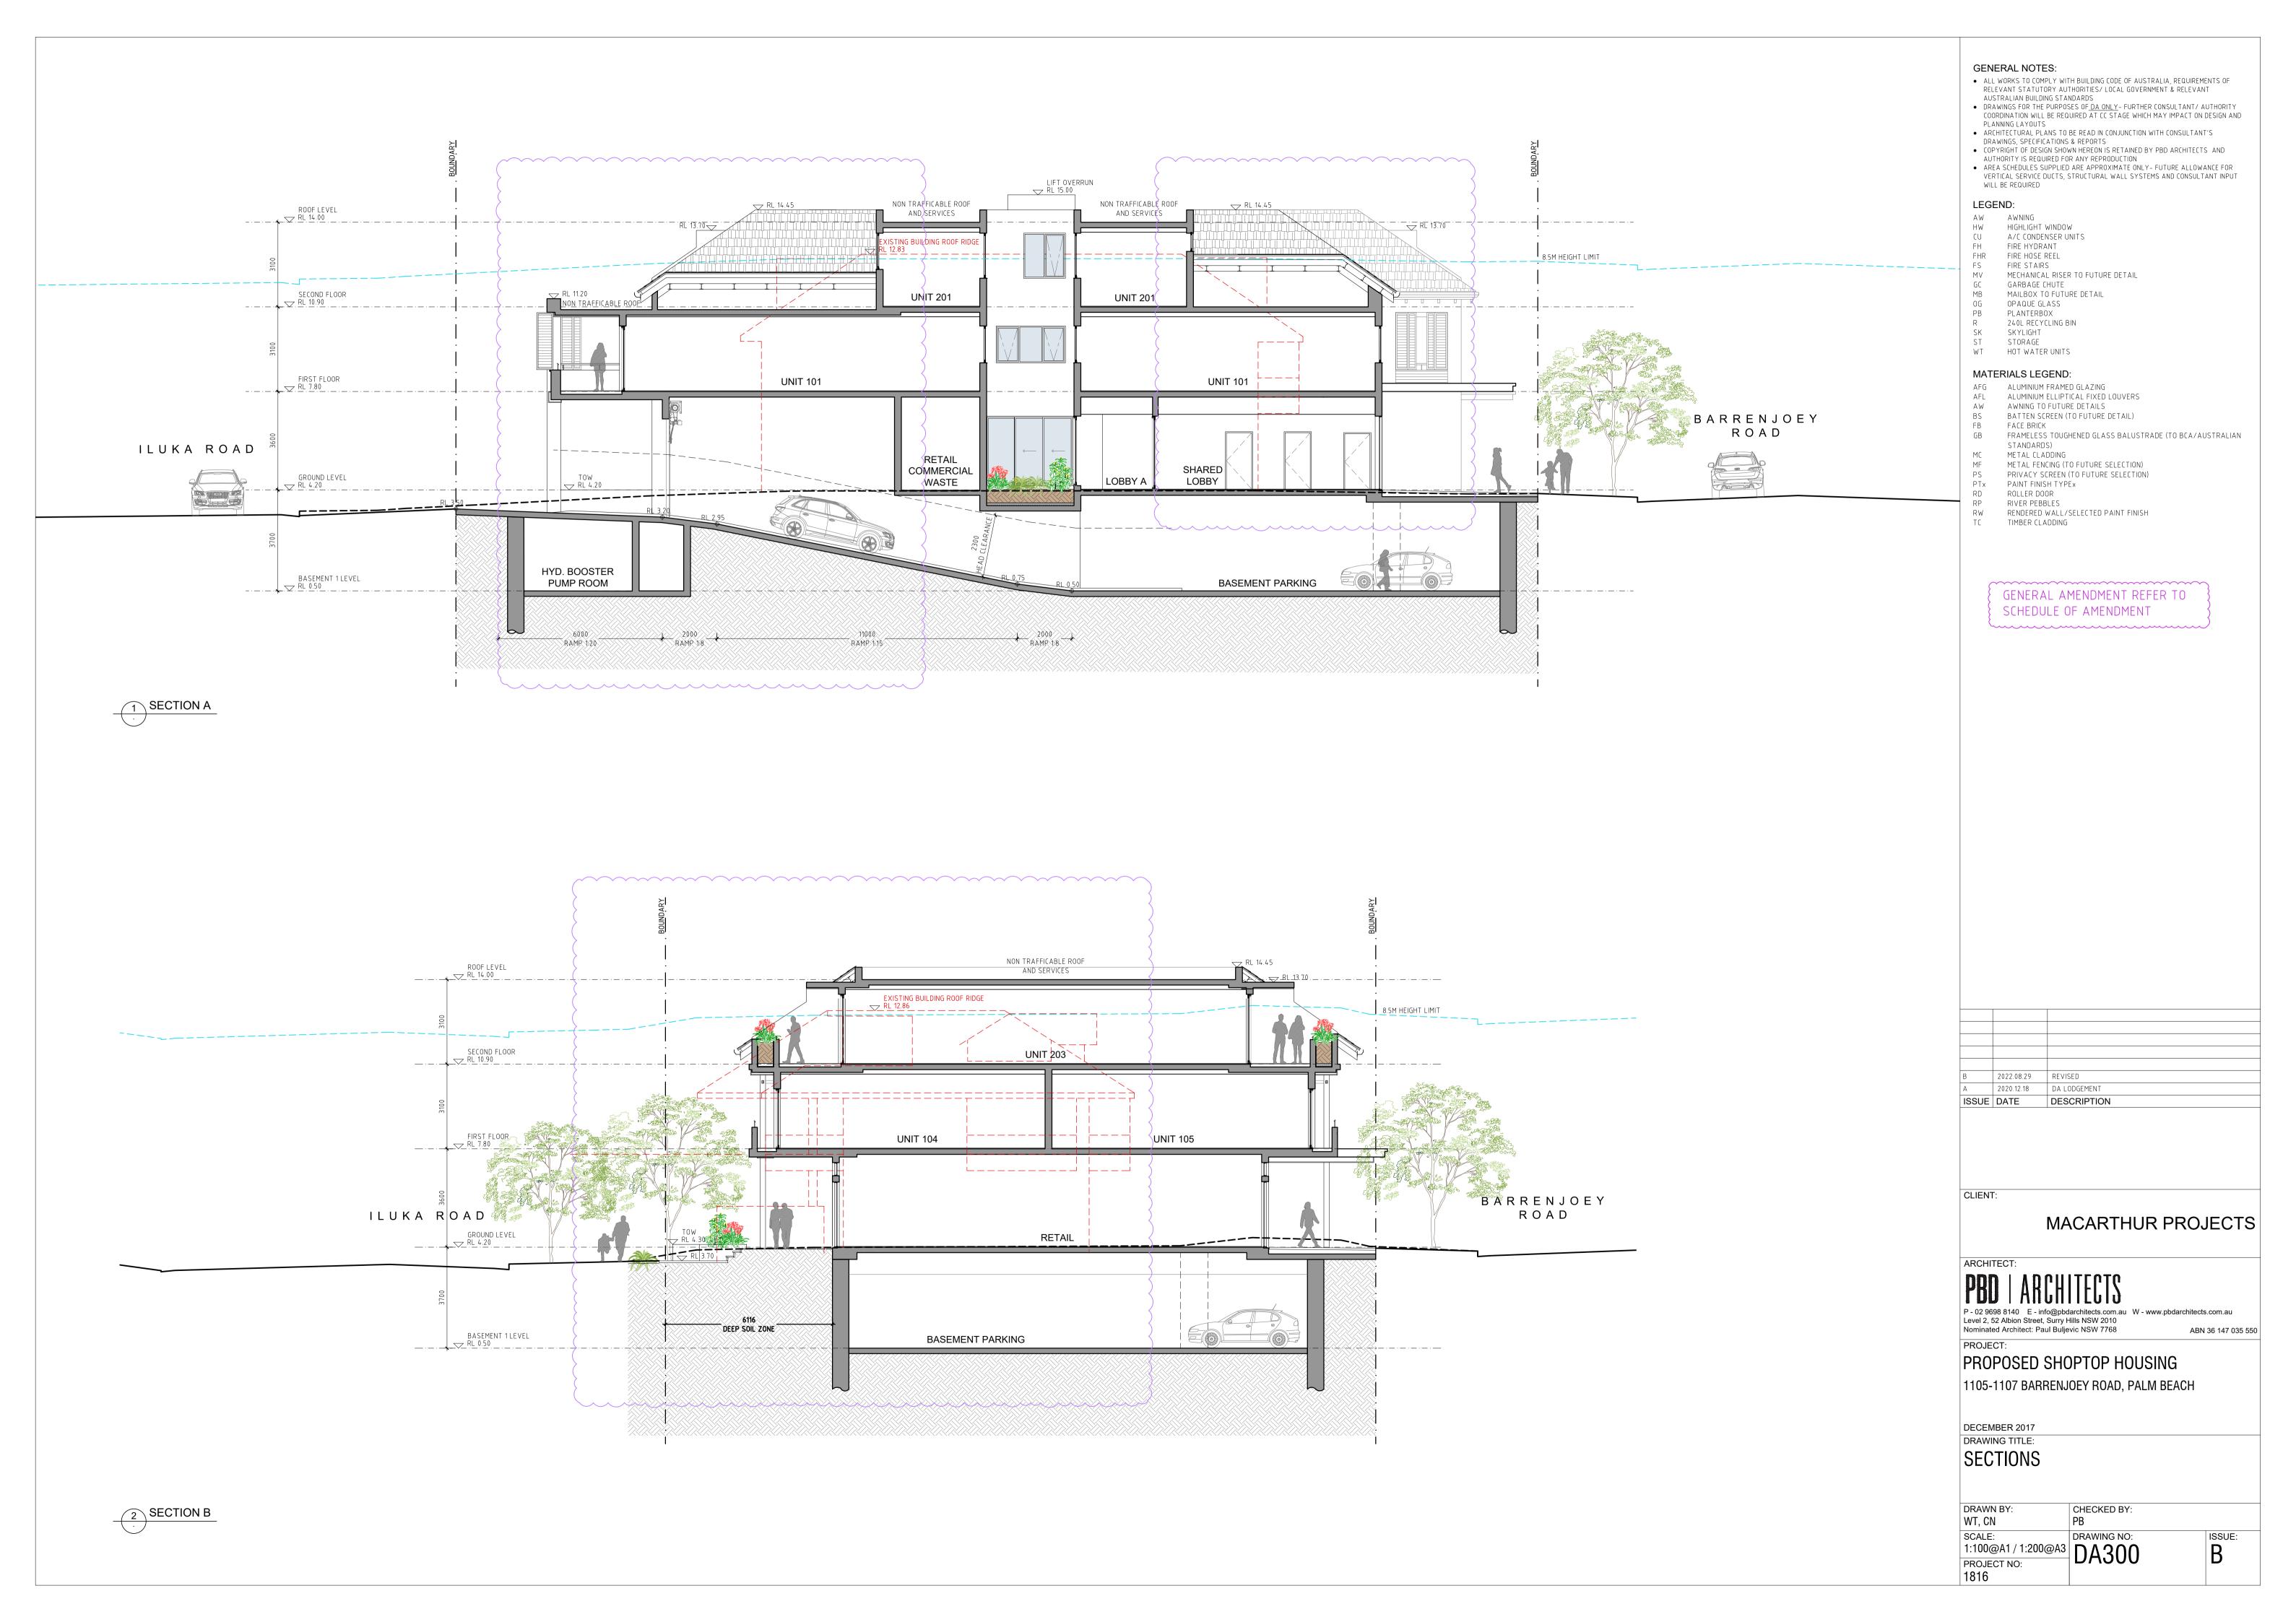




ROOF FINISH NULOK Welsh Slate or similar




FIRE RATED EXTERNAL TIMBER LOOK CLADDING Weathertex Weathergroove Woodsman 150mm or similar

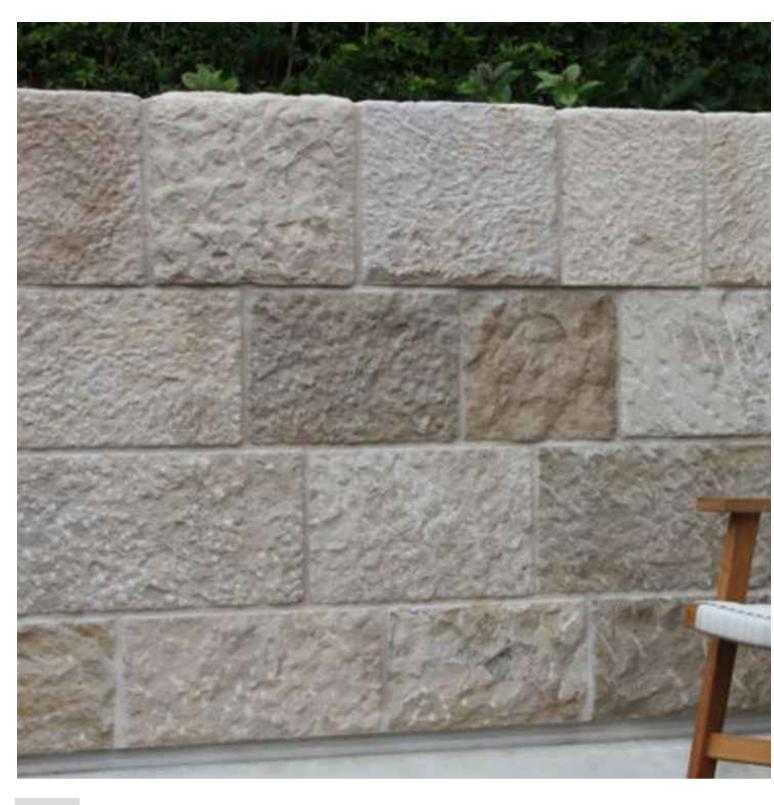

SANDSTONE FINISH Planter boxes / garden beds



AFG SLIDING DOORS AND WINDOWS Planter boxes / garden beds

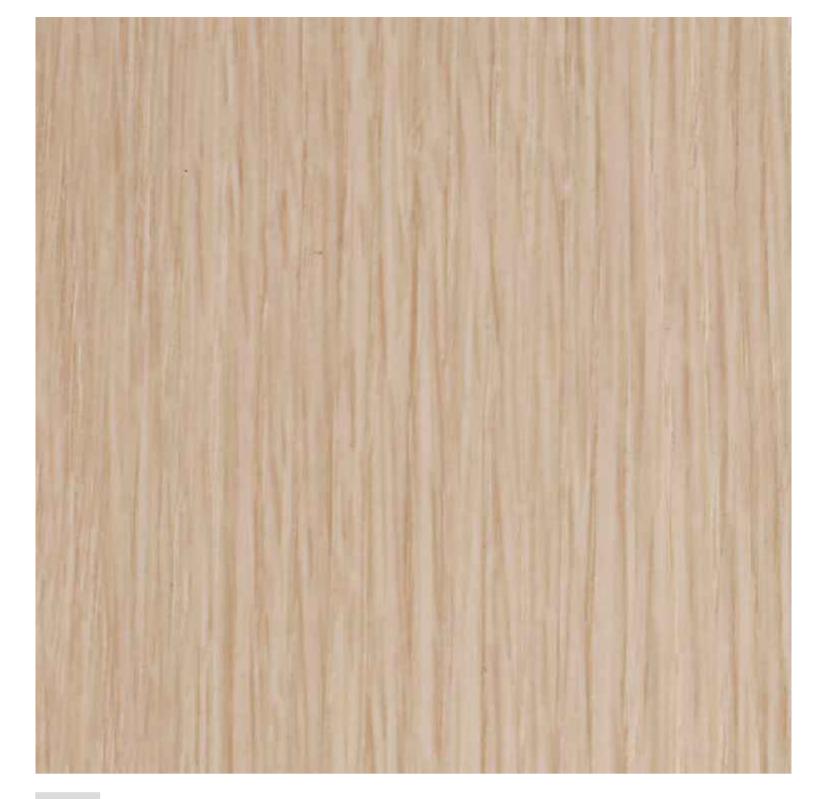

TC FIRE RATED TIMBER LOOK CLADDING COVET Supuringu Oku or similar

P1	DULUX - VIVID WHITE (SW1G1)	
	Rendered Wall	
P2	DULUX - TRANQUIL RETREAT (SN4G1)	
	Rendered wall	
P3	DULUX - WHITE BEACH QUARTER (SW1C4)	
	Rendered Wall	
P4	DULUX - DOMINO (GR10)	
	Door / Window Frames	
P5	DULUX - WHITE SATIN (2721139S)	
	Door / Window Frames	
P6	DULUX - MONUMENT (2729067S)	
	Door / Window Frames	

ALL WORKS TO COMPLY WITH BUILDING CODE OF AUSTRALIA, REQUIREMENTS OF RELEVANT STATUTORY AUTHORITIES/ LOCAL GOVERNMENT & RELEVANT

- AUSTRALIAN BUILDING STANDARDS DRAWINGS FOR THE PURPOSES OF <u>DA ONLY</u> - FURTHER CONSULTANT/ AUTHORITY COORDINATION WILL BE REQUIRED AT CC STAGE WHICH MAY IMPACT ON DESIGN AND
- PLANNING LAYOUTS
- ARCHITECTURAL PLANS TO BE READ IN CONJUNCTION WITH CONSULTANT'S DRAWINGS, SPECIFICATIONS & REPORTS
- COPYRIGHT OF DESIGN SHOWN HEREON IS RETAINED BY PBD ARCHITECTS AND AUTHORITY IS REQUIRED FOR ANY REPRODUCTION AREA SCHEDULES SUPPLIED ARE APPROXIMATE ONLY- FUTURE ALLOWANCE FOR VERTICAL SERVICE DUCTS, STRUCTURAL WALL SYSTEMS AND CONSULTANT INPUT

LEGEND:

AW AWNING HIGHLIGHT WINDOW

WILL BE REQUIRED

A/C CONDENSER UNITS FIRE HYDRANT

FHR FIRE HOSE REEL

FIRE STAIRS MECHANICAL RISER TO FUTURE DETAIL

GARBAGE CHUTE MAILBOX TO FUTURE DETAIL

OPAQUE GLASS PLANTERBOX 240L RECYCLING BIN

SKYLIGHT

STORAGE HOT WATER UNITS

MATERIALS LEGEND:

AFG ALUMINIUM FRAMED GLAZING
AFL ALUMINIUM ELLIPTICAL FIXED LOUVERS

AW AWNING TO FUTURE DETAILS

BATTEN SCREEN (TO FUTURE DETAIL) FACE BRICK

FRAMELESS TOUGHENED GLASS BALUSTRADE (TO BCA/AUSTRALIAN STANDARDS)

METAL CLADDING METAL FENCING (TO FUTURE SELECTION)

PRIVACY SCREEN (TO FUTURE SELECTION) PAINT FINISH TYPEX

ROLLER DOOR

RIVER PEBBLES RENDERED WALL/SELECTED PAINT FINISH

TIMBER CLADDING

GENERAL AMENDMENT REFER TO

SCHEDULE OF AMENDMENT

2020.12.18 DA LODGEMENT DESCRIPTION ISSUE DATE

MACARTHUR PROJECTS

ARCHITECT:

P - 02 9698 8140 E - info@pbdarchitects.com.au W - www.pbdarchitects.com.au Level 2, 52 Albion Street, Surry Hills NSW 2010
Nominated Architect: Paul Buljevic NSW 7768 ABN 36 147 035 550

PROPOSED SHOPTOP HOUSING 1105-1107 BARRENJOEY ROAD, PALM BEACH

DECEMBER 2017

DRAWING TITLE:

MATERIAL SCHEDULE

DRAWN BY: CHECKED BY: WT, CN SCALE: DRAWING NO: ISSUE: DA400 PROJECT NO: 1816





- ALL WORKS TO COMPLY WITH BUILDING CODE OF AUSTRALIA, REQUIREMENTS OF RELEVANT STATUTORY AUTHORITIES/LOCAL GOVERNMENT & RELEVANT AUSTRALIAN BUILDING STANDARDS

 DRAWINGS FOR THE PURPOSES OF DA ONLY-FURTHER CONSULTANT/AUTHORITY COORDINATION WILL BE REQUIRED AT CC STAGE WHICH MAY IMPACT ON DESIGN AND PLANNING LAYOUTS
- PLANNING LAYOUTS

 ARCHITECTURAL PLANS TO BE READ IN CONJUNCTION WITH CONSULTANT'S DRAWINGS, SPECIFICATIONS & REPORTS

 COPYRIGHT OF DESIGN SHOWN HEREON IS RETAINED BY PBD ARCHITECTS AND AUTHORITY IS REQUIRED FOR ANY REPRODUCTION

 AREA SCHEDULES SUPPLIED ARE APPROXIMATE ONLY-FUTURE ALLOWANCE FOR VERTICAL SERVICE DUCTS, STRUCTURAL WALL SYSTEMS AND CONSULTANT INPUT

WT HOT WATER UNITS

MATERIALS LEGEND:

STANDARDS)

MC METAL CLADDING

MF METAL FENCING (TO FUTURE SELECTION)

RW RENDERED WALL/SELECTED PAINT FINISH TC TIMBER CLADDING

А	2020.12.18	DA LODGEMENT
ISSUE	DATE	DESCRIPTION

MACARTHUR PROJECTS

P - 02 9698 8140 E - info@pbdarchitects.com.au W - www.pbdarchitects.com.au Level 2, 52 Albion Street, Surry Hills NSW 2010
Nominated Architect: Paul Buljevic NSW 7768 ABN 36 147 03

PROPOSED SHOPTOP HOUSING 1105-1107 BARRENJOEY ROAD, PALM BEACH

DECEMBER 2017

1816

PHOTOMONTAGE B

CORNER OF BARRENJOEY ROAD &

THE WILL ROAD CHECKED BY: PB SCALE: DRAWING NO: PROJECT NO:

ISSUE:





VIEW FROM BARRENJOEY ROAD LOOKING NORTH



VIEW FROM ILUKA ROAD LOOKING NORTH EAST



- ALL WORKS TO COMPLY WITH BUILDING CODE OF AUSTRALIA, REQUIREMENTS OF RELEVANT STATUTORY AUTHORITIES/ LOCAL GOVERNMENT & RELEVANT
- AUSTRALIAN BUILDING STANDARDS

 DRAWINGS FOR THE PURPOSES OF DA ONLY- FURTHER CONSULTANT/ AUTHORITY COORDINATION WILL BE REQUIRED AT CC STAGE WHICH MAY IMPACT ON DESIGN AND PLANNING LAYOUTS
- ARCHITECTURAL PLANS TO BE READ IN CONJUNCTION WITH CONSULTANT'S DRAWINGS, SPECIFICATIONS & REPORTS
- COPYRIGHT OF DESIGN SHOWN HEREON IS RETAINED BY PBD ARCHITECTS AND AUTHORITY IS REQUIRED FOR ANY REPRODUCTION AREA SCHEDULES SUPPLIED ARE APPROXIMATE ONLY- FUTURE ALLOWANCE FOR

VERTICAL SERVICE DUCTS, STRUCTURAL WALL SYSTEMS AND CONSULTANT INPUT

LEGEND:

AW AWNING HW HIGHLIGHT WINDOW A/C CONDENSER UNITS FH FIRE HYDRANT

WILL BE REQUIRED

FHR FIRE HOSE REEL FIRE STAIRS MECHANICAL RISER TO FUTURE DETAIL

GARBAGE CHUTE

MAILBOX TO FUTURE DETAIL OPAQUE GLASS

PLANTERBOX 240L RECYCLING BIN SKYLIGHT

ST STORAGE
WT HOT WATER UNITS

MATERIALS LEGEND:

AFG ALUMINIUM FRAMED GLAZING AFL ALUMINIUM ELLIPTICAL FIXED LOUVERS

AW AWNING TO FUTURE DETAILS

BATTEN SCREEN (TO FUTURE DETAIL) FACE BRICK

FRAMELESS TOUGHENED GLASS BALUSTRADE (TO BCA/AUSTRALIAN

STANDARDS) MC METAL CLADDING

METAL FENCING (TO FUTURE SELECTION) PRIVACY SCREEN (TO FUTURE SELECTION)

PAINT FINISH TYPEX

ROLLER DOOR

RIVER PEBBLES RW RENDERED WALL/SELECTED PAINT FINISH TC TIMBER CLADDING

> GENERAL AMENDMENT REFER TO SCHEDULE OF AMENDMENT

1 VIEW FROM BARRENJOEY ROAD LOOKING SOUTH WEST

VIEW FROM ILUKA ROAD LOOKING SOUTH EAST



CLIENT:

MACARTHUR PROJECTS

ARCHITECT:

P - 02 9698 8140 E - info@pbdarchitects.com.au W - www.pbdarchitects.com.au Level 2, 52 Albion Street, Surry Hills NSW 2010

2022.08.29 REVISED 2020.12.18 DA LODGEMENT ISSUE DATE DESCRIPTION

Nominated Architect: Paul Buljevic NSW 7768 ABN 36 147 035 550

PROJECT:

PROPOSED SHOPTOP HOUSING


1105-1107 BARRENJOEY ROAD, PALM BEACH


DECEMBER 2017


DRAWING TITLE: SKETCHUP VIEWS

DRAWN BY:


CHECKED BY: PB WT, CN SCALE: DRAWING NO: ISSUE: NTS DA403 PROJECT NO: 1816

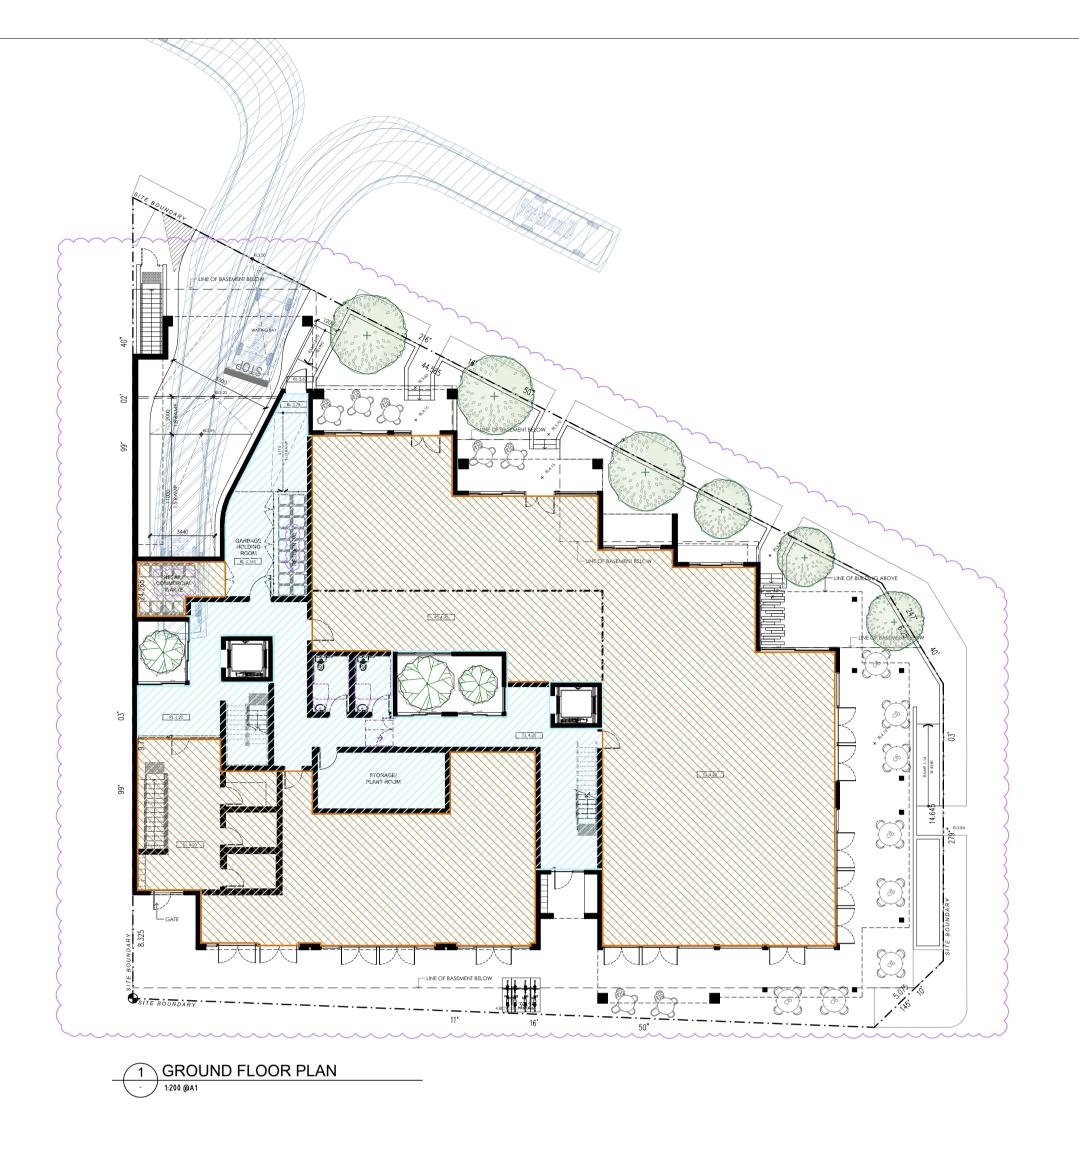

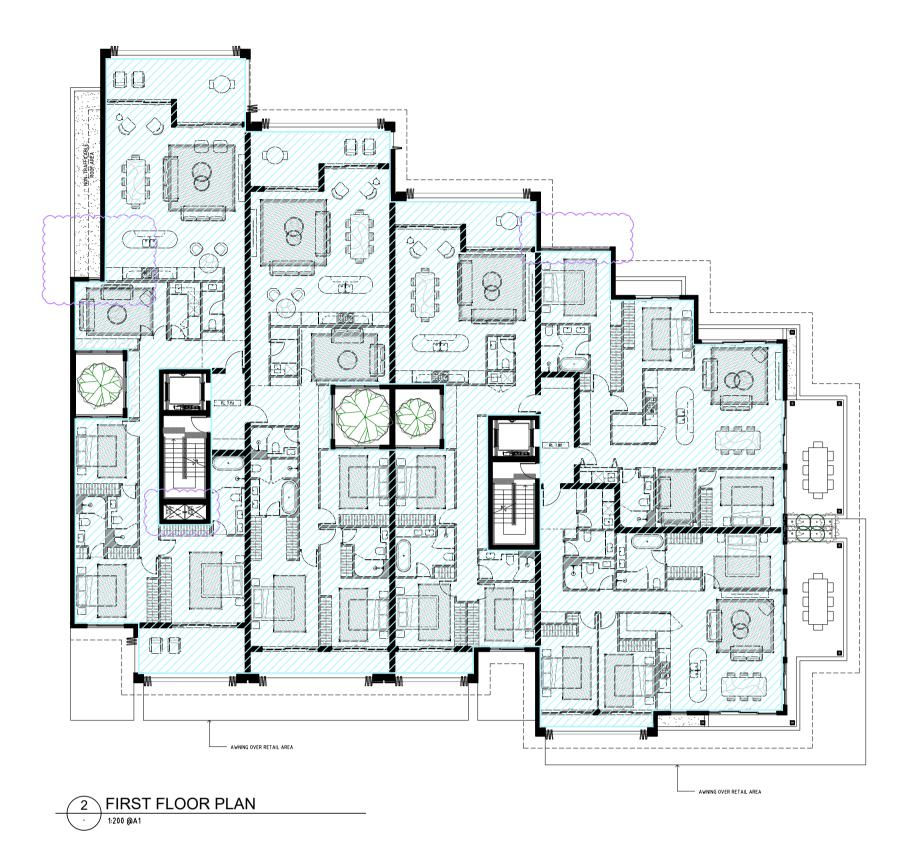

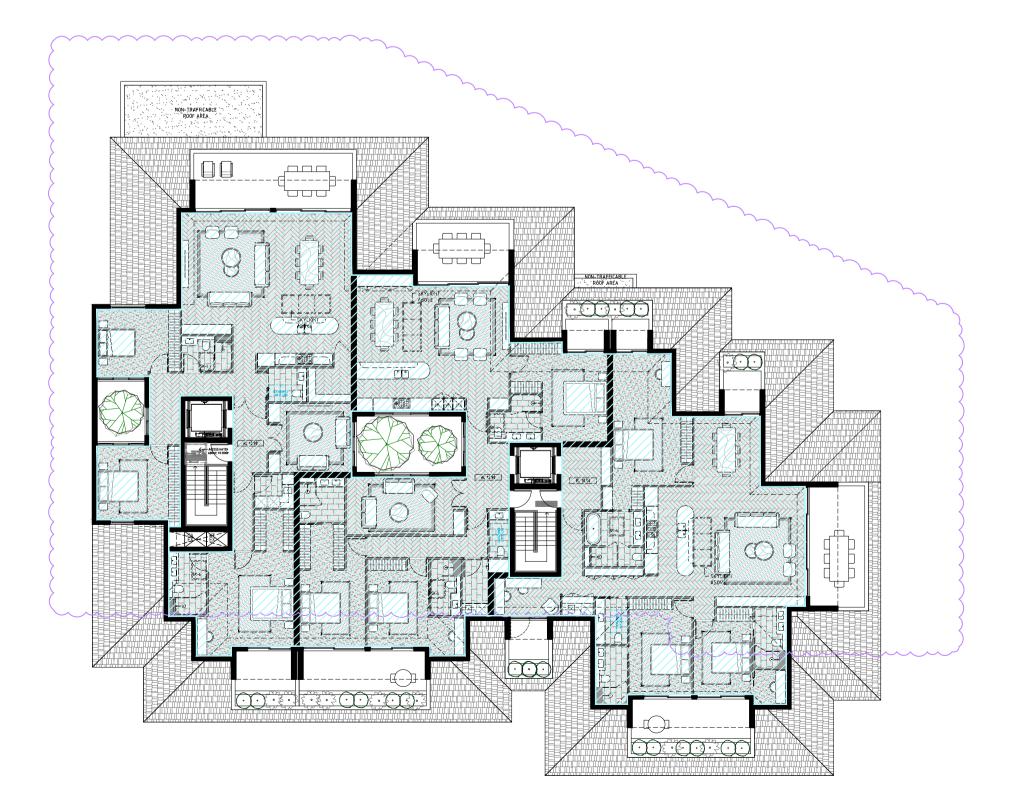

3 SECOND FLOOR PLAN

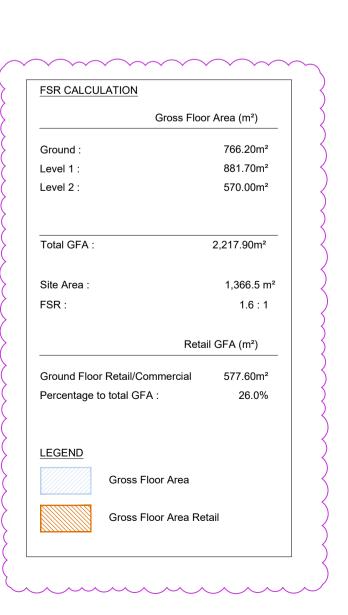

GENERAL NOTES:

- ALL WORKS TO COMPLY WITH BUILDING CODE OF AUSTRALIA, REQUIREMENTS OF RELEVANT STATUTORY AUTHORITIES/ LOCAL GOVERNMENT & RELEVANT
- AUSTRALIAN BUILDING STANDARDS

 DRAWINGS FOR THE PURPOSES OF <u>DA ONLY</u> FURTHER CONSULTANT/ AUTHORITY COORDINATION WILL BE REQUIRED AT CC STAGE WHICH MAY IMPACT ON DESIGN AND PLANNING LAYOUTS
- ARCHITECTURAL PLANS TO BE READ IN CONJUNCTION WITH CONSULTANT'S
- DRAWINGS, SPECIFICATIONS & REPORTS COPYRIGHT OF DESIGN SHOWN HEREON IS RETAINED BY PBD ARCHITECTS AND
- AUTHORITY IS REQUIRED FOR ANY REPRODUCTION AREA SCHEDULES SUPPLIED ARE APPROXIMATE ONLY- FUTURE ALLOWANCE FOR VERTICAL SERVICE DUCTS, STRUCTURAL WALL SYSTEMS AND CONSULTANT INPUT WILL BE REQUIRED

LEGEND:

AW AWNING HW HIGHLIGHT WINDOW A/C CONDENSER UNITS FIRE HYDRANT FHR FIRE HOSE REEL FIRE STAIRS

MECHANICAL RISER TO FUTURE DETAIL GARBAGE CHUTE

MAILBOX TO FUTURE DETAIL OPAQUE GLASS

PLANTERBOX 240L RECYCLING BIN SKYLIGHT

STORAGE WT HOT WATER UNITS

MATERIALS LEGEND:

AFG ALUMINIUM FRAMED GLAZING AFL ALUMINIUM ELLIPTICAL FIXED LOUVERS

AW AWNING TO FUTURE DETAILS BATTEN SCREEN (TO FUTURE DETAIL)

FACE BRICK FRAMELESS TOUGHENED GLASS BALUSTRADE (TO BCA/AUSTRALIAN

STANDARDS) MC METAL CLADDING

METAL FENCING (TO FUTURE SELECTION) PRIVACY SCREEN (TO FUTURE SELECTION)

PTx PAINT FINISH TYPEx

ROLLER DOOR RIVER PEBBLES

RW RENDERED WALL/SELECTED PAINT FINISH TIMBER CLADDING

GENERAL AMENDMENT REFER TO SCHEDULE OF AMENDMENT

2022.08.29 REVISED 2020.12.18 DA LODGEMENT ISSUE DATE DESCRIPTION



CLIENT:

MACARTHUR PROJECTS

ARCHITECT:

P - 02 9698 8140 E - info@pbdarchitects.com.au W - www.pbdarchitects.com.au Level 2, 52 Albion Street, Surry Hills NSW 2010 Nominated Architect: Paul Buljevic NSW 7768 ABN 36 147 035 550

PROPOSED SHOPTOP HOUSING 1105-1107 BARRENJOEY ROAD, PALM BEACH

DECEMBER 2017


DRAWING TITLE:

GFA DIAGRAM


DRAWN BY: CHECKED BY: WT, CN SCALE: 1:200@A1 / 1:400@A3 DA500

PROJECT NO: 1816

ISSUE:

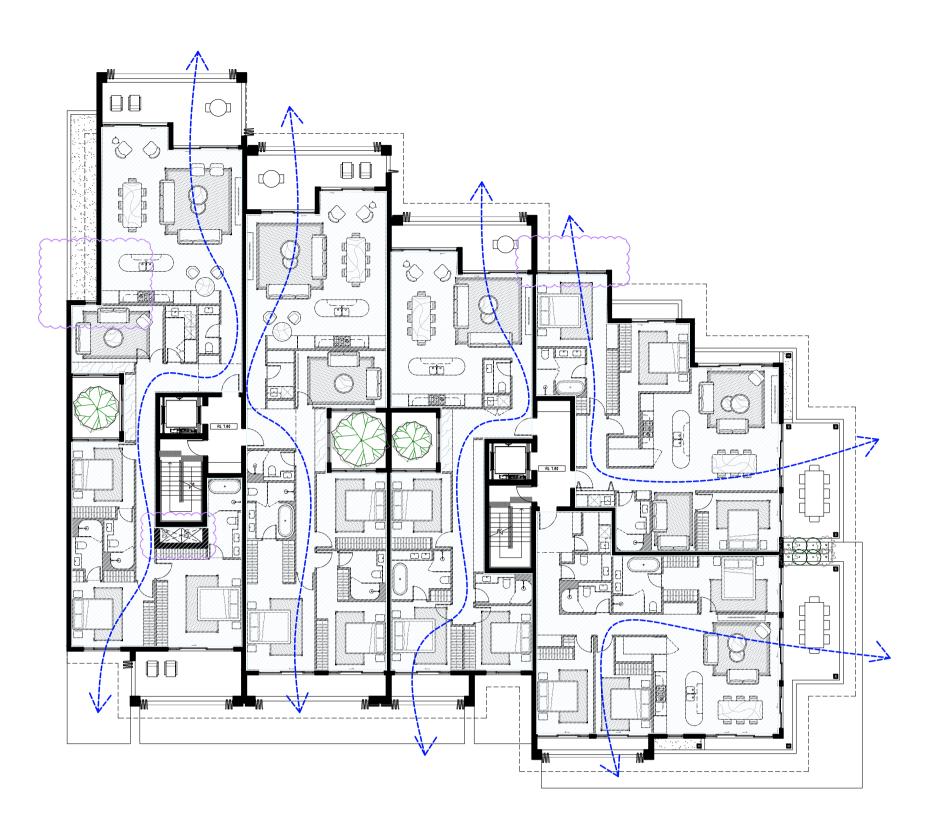



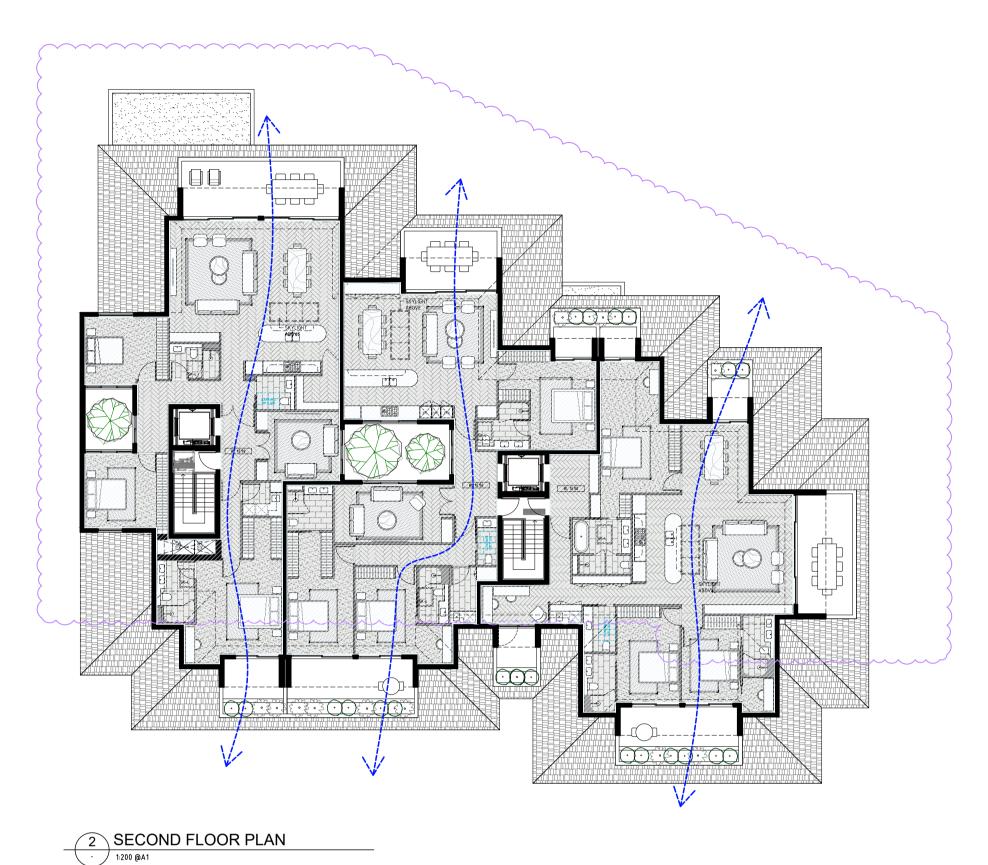

LEGEND

NATURALLY VENTILATED

NATURAL CROSS FLOW VENTILATION SUMMARY

	Number of Apartments achieving natural cross flow ventilation	
Ground		
₋evel 1	5	
evel 2	3	
ΓΟΤΑL	8	
3 / 8 apartme	nts	

ADG [4B]: NATURAL VENTILATION

- ALL HABITABLE ROOMS ARE NATURALLY VENTILATED
- AT LEAST 60% OF APARTMENTS ARE NATURALLY CROSS VENTILATED IN THE FIRST NINE STOREYS OF THE BUILDING.
- APARTMENTS AT TEN STOREYS OR GREATER ARE DEEMED TO BE CROSS VENTILATED ONLY IF ANY ENCLOSURE OF THE BALCONIES AT THESE LEVELS ALLOWS ADEQUATE NATURAL VENTILATION AND CANNOT BE
- **FULLY ENCLOSED** OVERALL DEPTH OF A CROSS-OVER APARTMENT DOES NOT EXCEED 18m

TOTAL NUMBER OF APARTMENTS : 8 UNITS

NATURALLY VENTILATED APARTMENTS: 8 UNITS

% APARTMENT WITH NATURAL CROSS VENTILATION = 100 %

GENERAL NOTES:

- ALL WORKS TO COMPLY WITH BUILDING CODE OF AUSTRALIA, REQUIREMENTS OF RELEVANT STATUTORY AUTHORITIES/ LOCAL GOVERNMENT & RELEVANT
- AUSTRALIAN BUILDING STANDARDS DRAWINGS FOR THE PURPOSES OF <u>DA ONLY</u>- FURTHER CONSULTANT/ AUTHORITY COORDINATION WILL BE REQUIRED AT CC STAGE WHICH MAY IMPACT ON DESIGN AND
- PLANNING LAYOUTS ARCHITECTURAL PLANS TO BE READ IN CONJUNCTION WITH CONSULTANT'S
- DRAWINGS, SPECIFICATIONS & REPORTS COPYRIGHT OF DESIGN SHOWN HEREON IS RETAINED BY PBD ARCHITECTS AND
- AUTHORITY IS REQUIRED FOR ANY REPRODUCTION AREA SCHEDULES SUPPLIED ARE APPROXIMATE ONLY- FUTURE ALLOWANCE FOR VERTICAL SERVICE DUCTS, STRUCTURAL WALL SYSTEMS AND CONSULTANT INPUT

LEGEND:

AW AWNING HW HIGHLIGHT WINDOW A/C CONDENSER UNITS

WILL BE REQUIRED

FIRE HYDRANT

FHR FIRE HOSE REEL FIRE STAIRS

MECHANICAL RISER TO FUTURE DETAIL GARBAGE CHUTE

MAILBOX TO FUTURE DETAIL OPAQUE GLASS

PLANTERBOX

240L RECYCLING BIN SKYLIGHT

STORAGE WT HOT WATER UNITS

MATERIALS LEGEND:

AFG ALUMINIUM FRAMED GLAZING
AFL ALUMINIUM ELLIPTICAL FIXED LOUVERS

AW AWNING TO FUTURE DETAILS BATTEN SCREEN (TO FUTURE DETAIL)

FACE BRICK FRAMELESS TOUGHENED GLASS BALUSTRADE (TO BCA/AUSTRALIAN

STANDARDS)

METAL CLADDING METAL FENCING (TO FUTURE SELECTION) PRIVACY SCREEN (TO FUTURE SELECTION)

PAINT FINISH TYPEX

ROLLER DOOR RIVER PEBBLES

RENDERED WALL/SELECTED PAINT FINISH TIMBER CLADDING

GENERAL AMENDMENT REFER TO

SCHEDULE OF AMENDMENT

В	2022.08.29	REVISED
Α	2020.12.18	DA LODGEMENT
ISSUE	DATE	DESCRIPTION



MACARTHUR PROJECTS

ARCHITECT:

P - 02 9698 8140 E - info@pbdarchitects.com.au W - www.pbdarchitects.com.au Level 2, 52 Albion Street, Surry Hills NSW 2010 Nominated Architect: Paul Buljevic NSW 7768 ABN 36 147 035 550

PROPOSED SHOPTOP HOUSING 1105-1107 BARRENJOEY ROAD, PALM BEACH


DECEMBER 2017

DRAWING TITLE: CROSS VENTILATION DIAGRAM


DRAWN BY:	CHECKED BY:	
WT, CN	PB	
SCALE:	DRAWING NO:	ISSUE
1:200@A1 / 1:400@A3	DA510	R
PROJECT NO:	DAGIO	ט
1816		






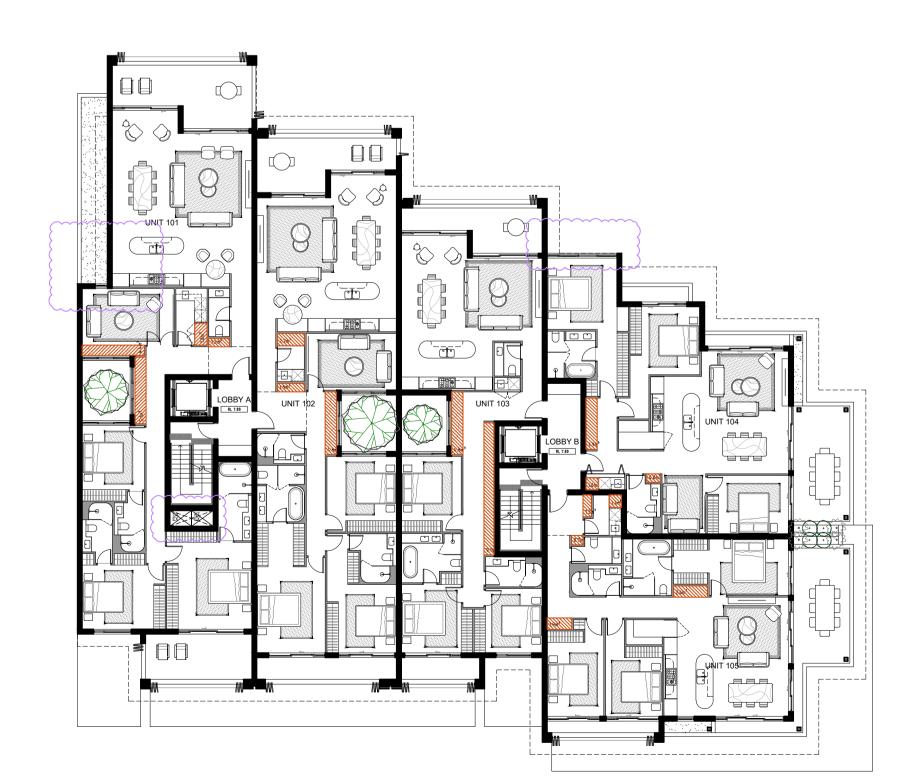



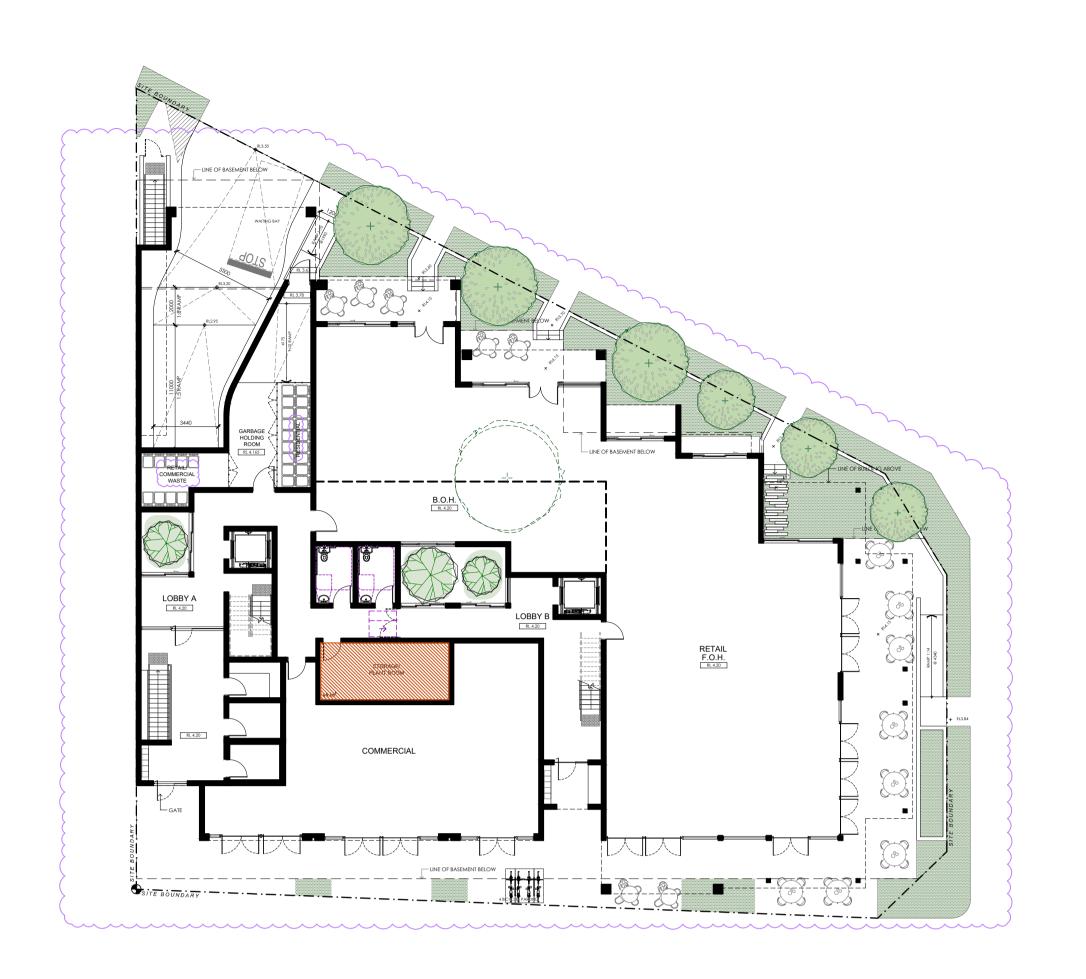

2 GROUND FLOOR PLAN

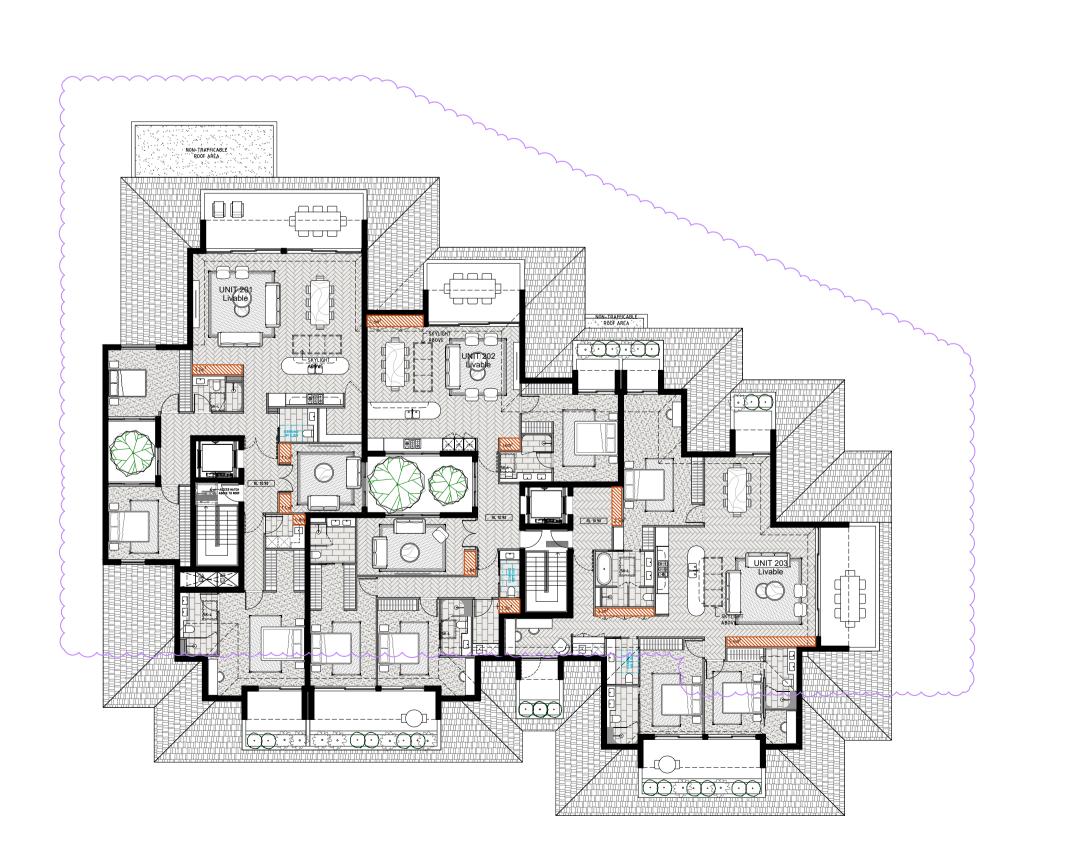

4 SECOND FLOOR PLAN
1:200 @A1

GENERAL NOTES:

- ALL WORKS TO COMPLY WITH BUILDING CODE OF AUSTRALIA, REQUIREMENTS OF
- RELEVANT STATUTORY AUTHORITIES/ LOCAL GOVERNMENT & RELEVANT
 AUSTRALIAN BUILDING STANDARDS

 DRAWINGS FOR THE PURPOSES OF <u>DA ONLY</u> FURTHER CONSULTANT/ AUTHORITY
 COORDINATION WILL BE REQUIRED AT CC STAGE WHICH MAY IMPACT ON DESIGN AND PLANNING LAYOUTS
- ARCHITECTURAL PLANS TO BE READ IN CONJUNCTION WITH CONSULTANT'S DRAWINGS, SPECIFICATIONS & REPORTS
 COPYRIGHT OF DESIGN SHOWN HEREON IS RETAINED BY PBD ARCHITECTS AND AUTHORITY IS REQUIRED FOR ANY REPRODUCTION
- AREA SCHEDULES SUPPLIED ARE APPROXIMATE ONLY- FUTURE ALLOWANCE FOR VERTICAL SERVICE DUCTS, STRUCTURAL WALL SYSTEMS AND CONSULTANT INPUT WILL BE REQUIRED

LEGEND:

AW AWNING HW HIGHLIGHT WINDOW A/C CONDENSER UNITS FIRE HYDRANT FHR FIRE HOSE REEL FIRE STAIRS MECHANICAL RISER TO FUTURE DETAIL GARBAGE CHUTE MAILBOX TO FUTURE DETAIL OPAQUE GLASS PLANTERBOX 240L RECYCLING BIN SKYLIGHT ST STORAGE WT HOT WATER UNITS

MATERIALS LEGEND:

AFG ALUMINIUM FRAMED GLAZING
AFL ALUMINIUM ELLIPTICAL FIXED LOUVERS AW AWNING TO FUTURE DETAILS BATTEN SCREEN (TO FUTURE DETAIL) FACE BRICK

FRAMELESS TOUGHENED GLASS BALUSTRADE (TO BCA/AUSTRALIAN STANDARDS)

METAL CLADDING METAL FENCING (TO FUTURE SELECTION)
PRIVACY SCREEN (TO FUTURE SELECTION)

PAINT FINISH TYPEX ROLLER DOOR

RIVER PEBBLES RENDERED WALL/SELECTED PAINT FINISH TIMBER CLADDING

GENERAL AMENDMENT REFER TO SCHEDULE OF AMENDMENT

LEGEND

STORAGE

REFER TO AREA SCHEDULE ON DA 001

2022.08.29 REVISED 2020.12.18 DA LODGEMENT ISSUE DATE DESCRIPTION

CLIENT:

MACARTHUR PROJECTS

ARCHITECT:

P - 02 9698 8140 E - info@pbdarchitects.com.au W - www.pbdarchitects.com.au Level 2, 52 Albion Street, Surry Hills NSW 2010 Nominated Architect: Paul Buljevic NSW 7768

PROPOSED SHOPTOP HOUSING 1105-1107 BARRENJOEY ROAD, PALM BEACH

DECEMBER 2017

1816

DRAWING TITLE:

STORAGE DIAGRAM

DRAWN BY: CHECKED BY: WT, CN SCALE:


1:200@A1 / 1:400@A3 DA520 PROJECT NO:

ISSUE:

ABN 36 147 035 550





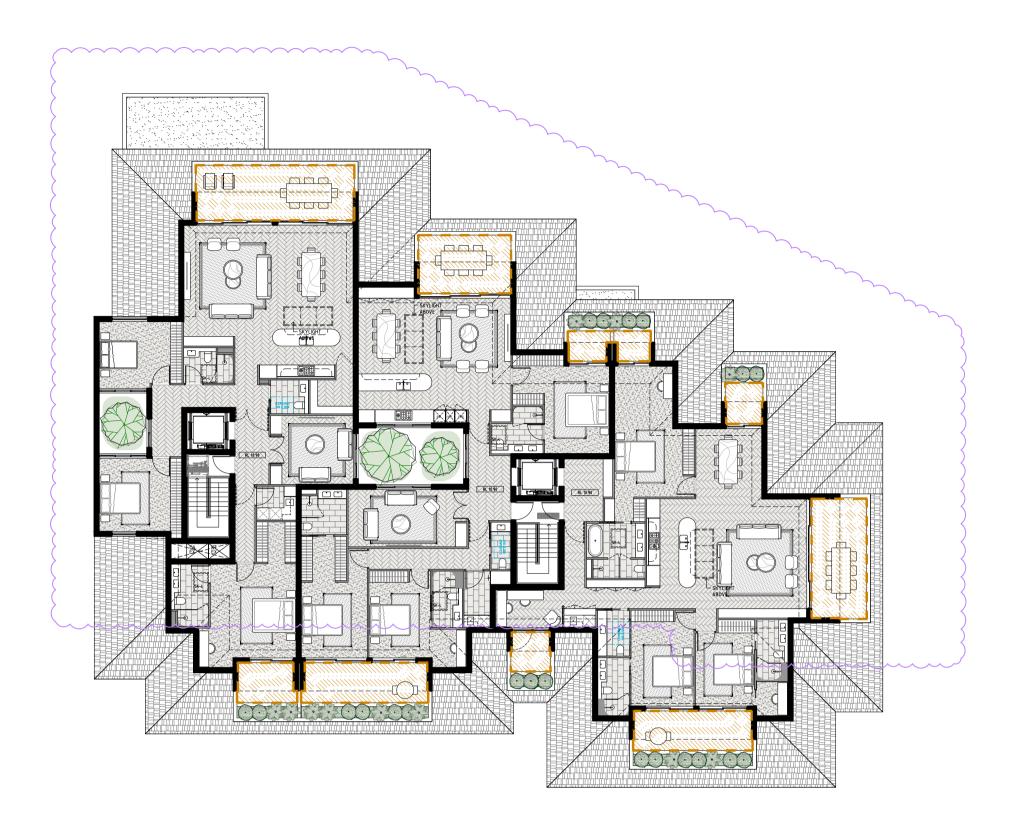

SECOND FLOOR PLAN
1:200 @A1

LEGEND



PRIVATE OPEN SPACE

ADG: PRIVATE OPEN SPACE + BALCONIES

- 15m², 3m DEPTH FOR GROUND FLOOR APARTMENTS
- 8m², 2M DEPTH FOR EACH 1 BEDROOM APARTMENTS
- 10m², 2m DEPTH FOR EACH 2 BEDROOM APARTMENTS
- 12m², 2.4m DEPTH FOR EACH 3+ BEDROOM APARTMENTS

GENERAL NOTES:

- ALL WORKS TO COMPLY WITH BUILDING CODE OF AUSTRALIA, REQUIREMENTS OF RELEVANT STATUTORY AUTHORITIES/ LOCAL GOVERNMENT & RELEVANT
- AUSTRALIAN BUILDING STANDARDS DRAWINGS FOR THE PURPOSES OF <u>DA ONLY</u>- FURTHER CONSULTANT/ AUTHORITY COORDINATION WILL BE REQUIRED AT CC STAGE WHICH MAY IMPACT ON DESIGN AND
- PLANNING LAYOUTS ARCHITECTURAL PLANS TO BE READ IN CONJUNCTION WITH CONSULTANT'S
- DRAWINGS, SPECIFICATIONS & REPORTS COPYRIGHT OF DESIGN SHOWN HEREON IS RETAINED BY PBD ARCHITECTS AND AUTHORITY IS REQUIRED FOR ANY REPRODUCTION AREA SCHEDULES SUPPLIED ARE APPROXIMATE ONLY- FUTURE ALLOWANCE FOR VERTICAL SERVICE DUCTS, STRUCTURAL WALL SYSTEMS AND CONSULTANT INPUT

WILL BE REQUIRED LEGEND:

AW AWNING HW HIGHLIGHT WINDOW A/C CONDENSER UNITS

FIRE HYDRANT

FHR FIRE HOSE REEL FIRE STAIRS

MECHANICAL RISER TO FUTURE DETAIL GARBAGE CHUTE

MAILBOX TO FUTURE DETAIL

240L RECYCLING BIN

OPAQUE GLASS PLANTERBOX

SKYLIGHT STORAGE

WT HOT WATER UNITS

MATERIALS LEGEND:

AFG ALUMINIUM FRAMED GLAZING
AFL ALUMINIUM ELLIPTICAL FIXED LOUVERS

AW AWNING TO FUTURE DETAILS

BATTEN SCREEN (TO FUTURE DETAIL) FACE BRICK FRAMELESS TOUGHENED GLASS BALUSTRADE (TO BCA/AUSTRALIAN

STANDARDS) METAL CLADDING

METAL FENCING (TO FUTURE SELECTION) PRIVACY SCREEN (TO FUTURE SELECTION)

PAINT FINISH TYPEX ROLLER DOOR

RIVER PEBBLES

RENDERED WALL/SELECTED PAINT FINISH

TIMBER CLADDING

GENERAL AMENDMENT REFER TO SCHEDULE OF AMENDMENT

2020.12.18 DA LODGEMENT ISSUE DATE DESCRIPTION



MACARTHUR PROJECTS

ARCHITECT:

P - 02 9698 8140 E - info@pbdarchitects.com.au W - www.pbdarchitects.com.au Level 2, 52 Albion Street, Surry Hills NSW 2010 Nominated Architect: Paul Buljevic NSW 7768 ABN 36 147 035 550

PROPOSED SHOPTOP HOUSING

1105-1107 BARRENJOEY ROAD, PALM BEACH


DECEMBER 2017

1816

PRIVATE OPEN SPACE DIAGRAM

CHECKED BY: PB DRAWN BY: WT, CN SCALE: 1:200@A1 / 1:400@A3 DA530

ISSUE:

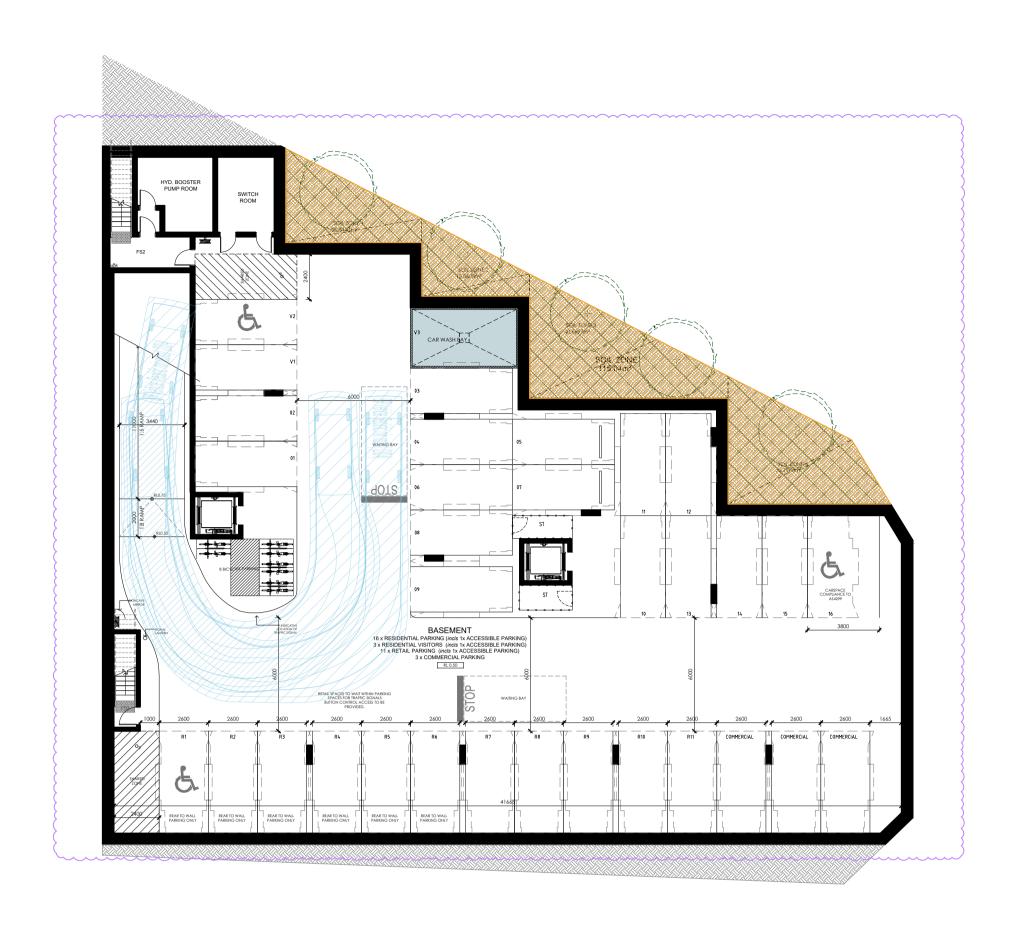


GROUND FLOOR PLAN
1:200 @A1



1 EXISTING

3 FIRST FLOOR PLAN
1:200 @A1

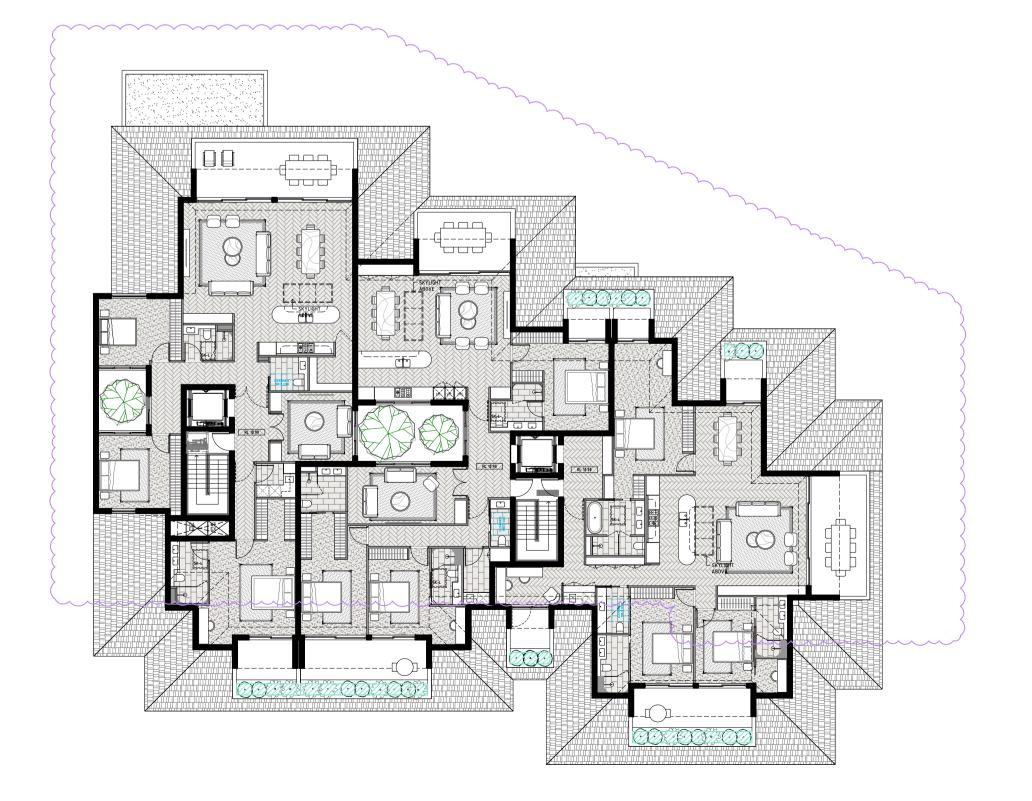

RL 4.20

3 SECOND FLOOR PLAN

GENERAL NOTES:

- ALL WORKS TO COMPLY WITH BUILDING CODE OF AUSTRALIA, REQUIREMENTS OF RELEVANT STATUTORY AUTHORITIES/ LOCAL GOVERNMENT & RELEVANT
- AUSTRALIAN BUILDING STANDARDS

 DRAWINGS FOR THE PURPOSES OF <u>DA ONLY</u> FURTHER CONSULTANT/ AUTHORITY COORDINATION WILL BE REQUIRED AT CC STAGE WHICH MAY IMPACT ON DESIGN AND PLANNING LAYOUTS
- ARCHITECTURAL PLANS TO BE READ IN CONJUNCTION WITH CONSULTANT'S DRAWINGS, SPECIFICATIONS & REPORTS
- COPYRIGHT OF DESIGN SHOWN HEREON IS RETAINED BY PBD ARCHITECTS AND AUTHORITY IS REQUIRED FOR ANY REPRODUCTION
- AREA SCHEDULES SUPPLIED ARE APPROXIMATE ONLY- FUTURE ALLOWANCE FOR VERTICAL SERVICE DUCTS, STRUCTURAL WALL SYSTEMS AND CONSULTANT INPUT WILL BE REQUIRED

LEGEND:

AW AWNING HW HIGHLIGHT WINDOW A/C CONDENSER UNITS FIRE HYDRANT FHR FIRE HOSE REEL FIRE STAIRS MECHANICAL RISER TO FUTURE DETAIL GARBAGE CHUTE MAILBOX TO FUTURE DETAIL OPAQUE GLASS PLANTERBOX 240L RECYCLING BIN SKYLIGHT

MATERIALS LEGEND:

ST STORAGE WT HOT WATER UNITS

AFG ALUMINIUM FRAMED GLAZING
AFL ALUMINIUM ELLIPTICAL FIXED LOUVERS AW AWNING TO FUTURE DETAILS

BATTEN SCREEN (TO FUTURE DETAIL) FACE BRICK FRAMELESS TOUGHENED GLASS BALUSTRADE (TO BCA/AUSTRALIAN

STANDARDS) METAL CLADDING

METAL FENCING (TO FUTURE SELECTION) PRIVACY SCREEN (TO FUTURE SELECTION)

PAINT FINISH TYPEX ROLLER DOOR

RIVER PEBBLES RENDERED WALL/SELECTED PAINT FINISH TIMBER CLADDING

GENERAL AMENDMENT REFER TO SCHEDULE OF AMENDMENT

SITE AREA = 1,366.5 sqm



INFINITY SOIL ZONE = 115.04 sqm (8.4% of site)



PROPOSED LANDSCAPING = 143.1 sqm (10.4% of site)

2022.08.29 REVISED 2020.12.18 DA LODGEMENT

ISSUE DATE DESCRIPTION



CLIENT:

MACARTHUR PROJECTS

ARCHITECT:

P - 02 9698 8140 E - info@pbdarchitects.com.au W - www.pbdarchitects.com.au Level 2, 52 Albion Street, Surry Hills NSW 2010 Nominated Architect: Paul Buljevic NSW 7768

ABN 36 147 035 550

PROPOSED SHOPTOP HOUSING 1105-1107 BARRENJOEY ROAD, PALM BEACH

DECEMBER 2017

DRAWING TITLE: LANDSCAPE DIAGRAM

DRAWN BY: CHECKED BY: WT, CN SCALE: 1:200@A1 / 1:400@A3 DA540

PROJECT NO: 1816

ISSUE: В



- GENERAL NOTES:
 ALL WORKS TO COMPLY WITH BUILDING CODE OF AUSTRALIA, REQUIREMENTS OF RELEVANT STATUTORY AUTHORITIES/ LOCAL GOVERNMENT & RELEVANT AUSTRALIAN BUILDING STANDARDS
 DRAWINGS FOR THE PURPOSES OF DA ONLY FURTHER CONSULTANT/ AUTHORITY COORDINATION WILL BE REQUIRED AT CC STAGE WHICH MAY IMPACT ON DESIGN AND PLANNING LAYOUTS
 ARCHITECTURAL PLANS TO BE READ IN CONJUNCTION WITH CONSULTANT'S DRAWINGS, SPECIFICATIONS & REPORTS
 COPYRIGHT OF DESIGN SHOWN HEREON IS RETAINED BY PBD ARCHITECTS AND AUTHORITY IS REQUIRED FOR ANY REPRODUCTION
 AREA SCHEDULES SUPPLIED ARE APPROXIMATE ONLY FUTURE ALLOWANCE FOR VERTICAL SERVICE DUCTS, STRUCTURAL WALL SYSTEMS AND CONSULTANT INPUT WILL BE REQUIRED

LEGEND:

AW AWNING HIGHLIGHT WINDOW

CU A/C CONDENSER U
FH FIRE HYDRANT
FHR FIRE HOSE REEL
FS FIRE STAIRS A/C CONDENSER UNITS

MECHANICAL RISER TO FUTURE DETAIL

GARBAGE CHUTE MAILBOX TO FUTURE DETAIL

OPAQUE GLASS PLANTERBOX

240L RECYCLING BIN SKYLIGHT STORAGE

HOT WATER UNITS

MATERIALS LEGEND:

AFG ALUMINIUM FRAMED GLAZING
AFL ALUMINIUM ELLIPTICAL FIXED LOUVERS
AW AWNING TO FUTURE DETAILS
BS BATTEN SCREEN (TO FUTURE DETAIL)
FB FACE BRICK FRAMELESS TOUGHENED GLASS BALUSTRADE (TO BCA/AUSTRALIAN

STANDARDS) METAL CLADDING

METAL FENCING (TO FUTURE SELECTION)
PRIVACY SCREEN (TO FUTURE SELECTION)

PAINT FINISH TYPEX

ROLLER DOOR

RIVER PEBBLES
RENDERED WALL/SELECTED PAINT FINISH
TIMBER CLADDING

GENERAL AMENDMENT REFER TO SCHEDULE OF AMENDMENT

	DATE	DESCRIPTION
ISSUE	DATE	DESCRIPTION
Α	2020.12.18	DA LODGEMENT
В	2022.08.29	REVISED

MACARTHUR PROJECTS

ARCHITECT:

P - 02 9698 8140 E - info@pbdarchitects.com.au W - www.pbdarchitects.com.au Level 2, 52 Albion Street, Surry Hills NSW 2010
Nominated Architect: Paul Buljevic NSW 7768 ABN 36 147 03 ABN 36 147 035 550

PROPOSED SHOPTOP HOUSING 1105-1107 BARRENJOEY ROAD, PALM BEACH

DECEMBER 2017 DRAWING TITLE:

HEIGHT PLANE DIAGRAM

DRAWN BY:	CHECKED BY:	
WT, CN	PB	
SCALE:	DRAWING NO:	ISSUE:
NTS	— DA550	∣ R
PROJECT NO:	טרטטט	U
1216		



- ALL WORKS TO COMPLY WITH BUILDING CODE OF AUSTRALIA, REQUIREMENTS OF RELEVANT STATUTORY AUTHORITIES / LOCAL GOVERNMENT & RELEVANT AUSTRALIAN BUILDING STANDARDS

 DRAWINGS FOR THE PURPOSES OF DA ONLY FURTHER CONSULTANT / AUTHORITY COORDINATION WILL BE REQUIRED AT CC STAGE WHICH MAY IMPACT ON DESIGN AND DIANNING LAYOUTE.
- AREA SCHEDULES SUPPLIED ARE APPROXIMATE ONLY- FUTURE ALLOWANCE FOR VERTICAL SERVICE DUCTS, STRUCTURAL WALL SYSTEMS AND CONSULTANT INPUT

UNIT 19/39 ILUKA ROAD GALZING

ABN 36 147 035 550

1105-1107 BARRENJOEY ROAD, PALM BEACH

DRAWN BY: CHECKED BY: PB WT, CN SCALE: DRAWING NO: ISSUE: DA600 NTS PROJECT NO: 1816



- ALL WORKS TO COMPLY WITH BUILDING CODE OF AUSTRALIA, REQUIREMENTS OF RELEVANT STATUTORY AUTHORITIES / LOCAL GOVERNMENT & RELEVANT AUSTRALIAN BUILDING STANDARDS

 DRAWINGS FOR THE PURPOSES OF DA ONLY FURTHER CONSULTANT / AUTHORITY COORDINATION WILL BE REQUIRED AT CC STAGE WHICH MAY IMPACT ON DESIGN AND DIANNING LAYOUTE.
- AREA SCHEDULES SUPPLIED ARE APPROXIMATE ONLY- FUTURE ALLOWANCE FOR VERTICAL SERVICE DUCTS, STRUCTURAL WALL SYSTEMS AND CONSULTANT INPUT

UNIT 19/39 ILUKA ROAD BALCONY

MACARTHUR PROJECTS

ABN 36 147 035 550

PROPOSED SHOPTOP HOUSING

DRAWN BY: CHECKED BY: PB WT, CN SCALE: DRAWING NO: ISSUE: NTS DA601 PROJECT NO: 1816














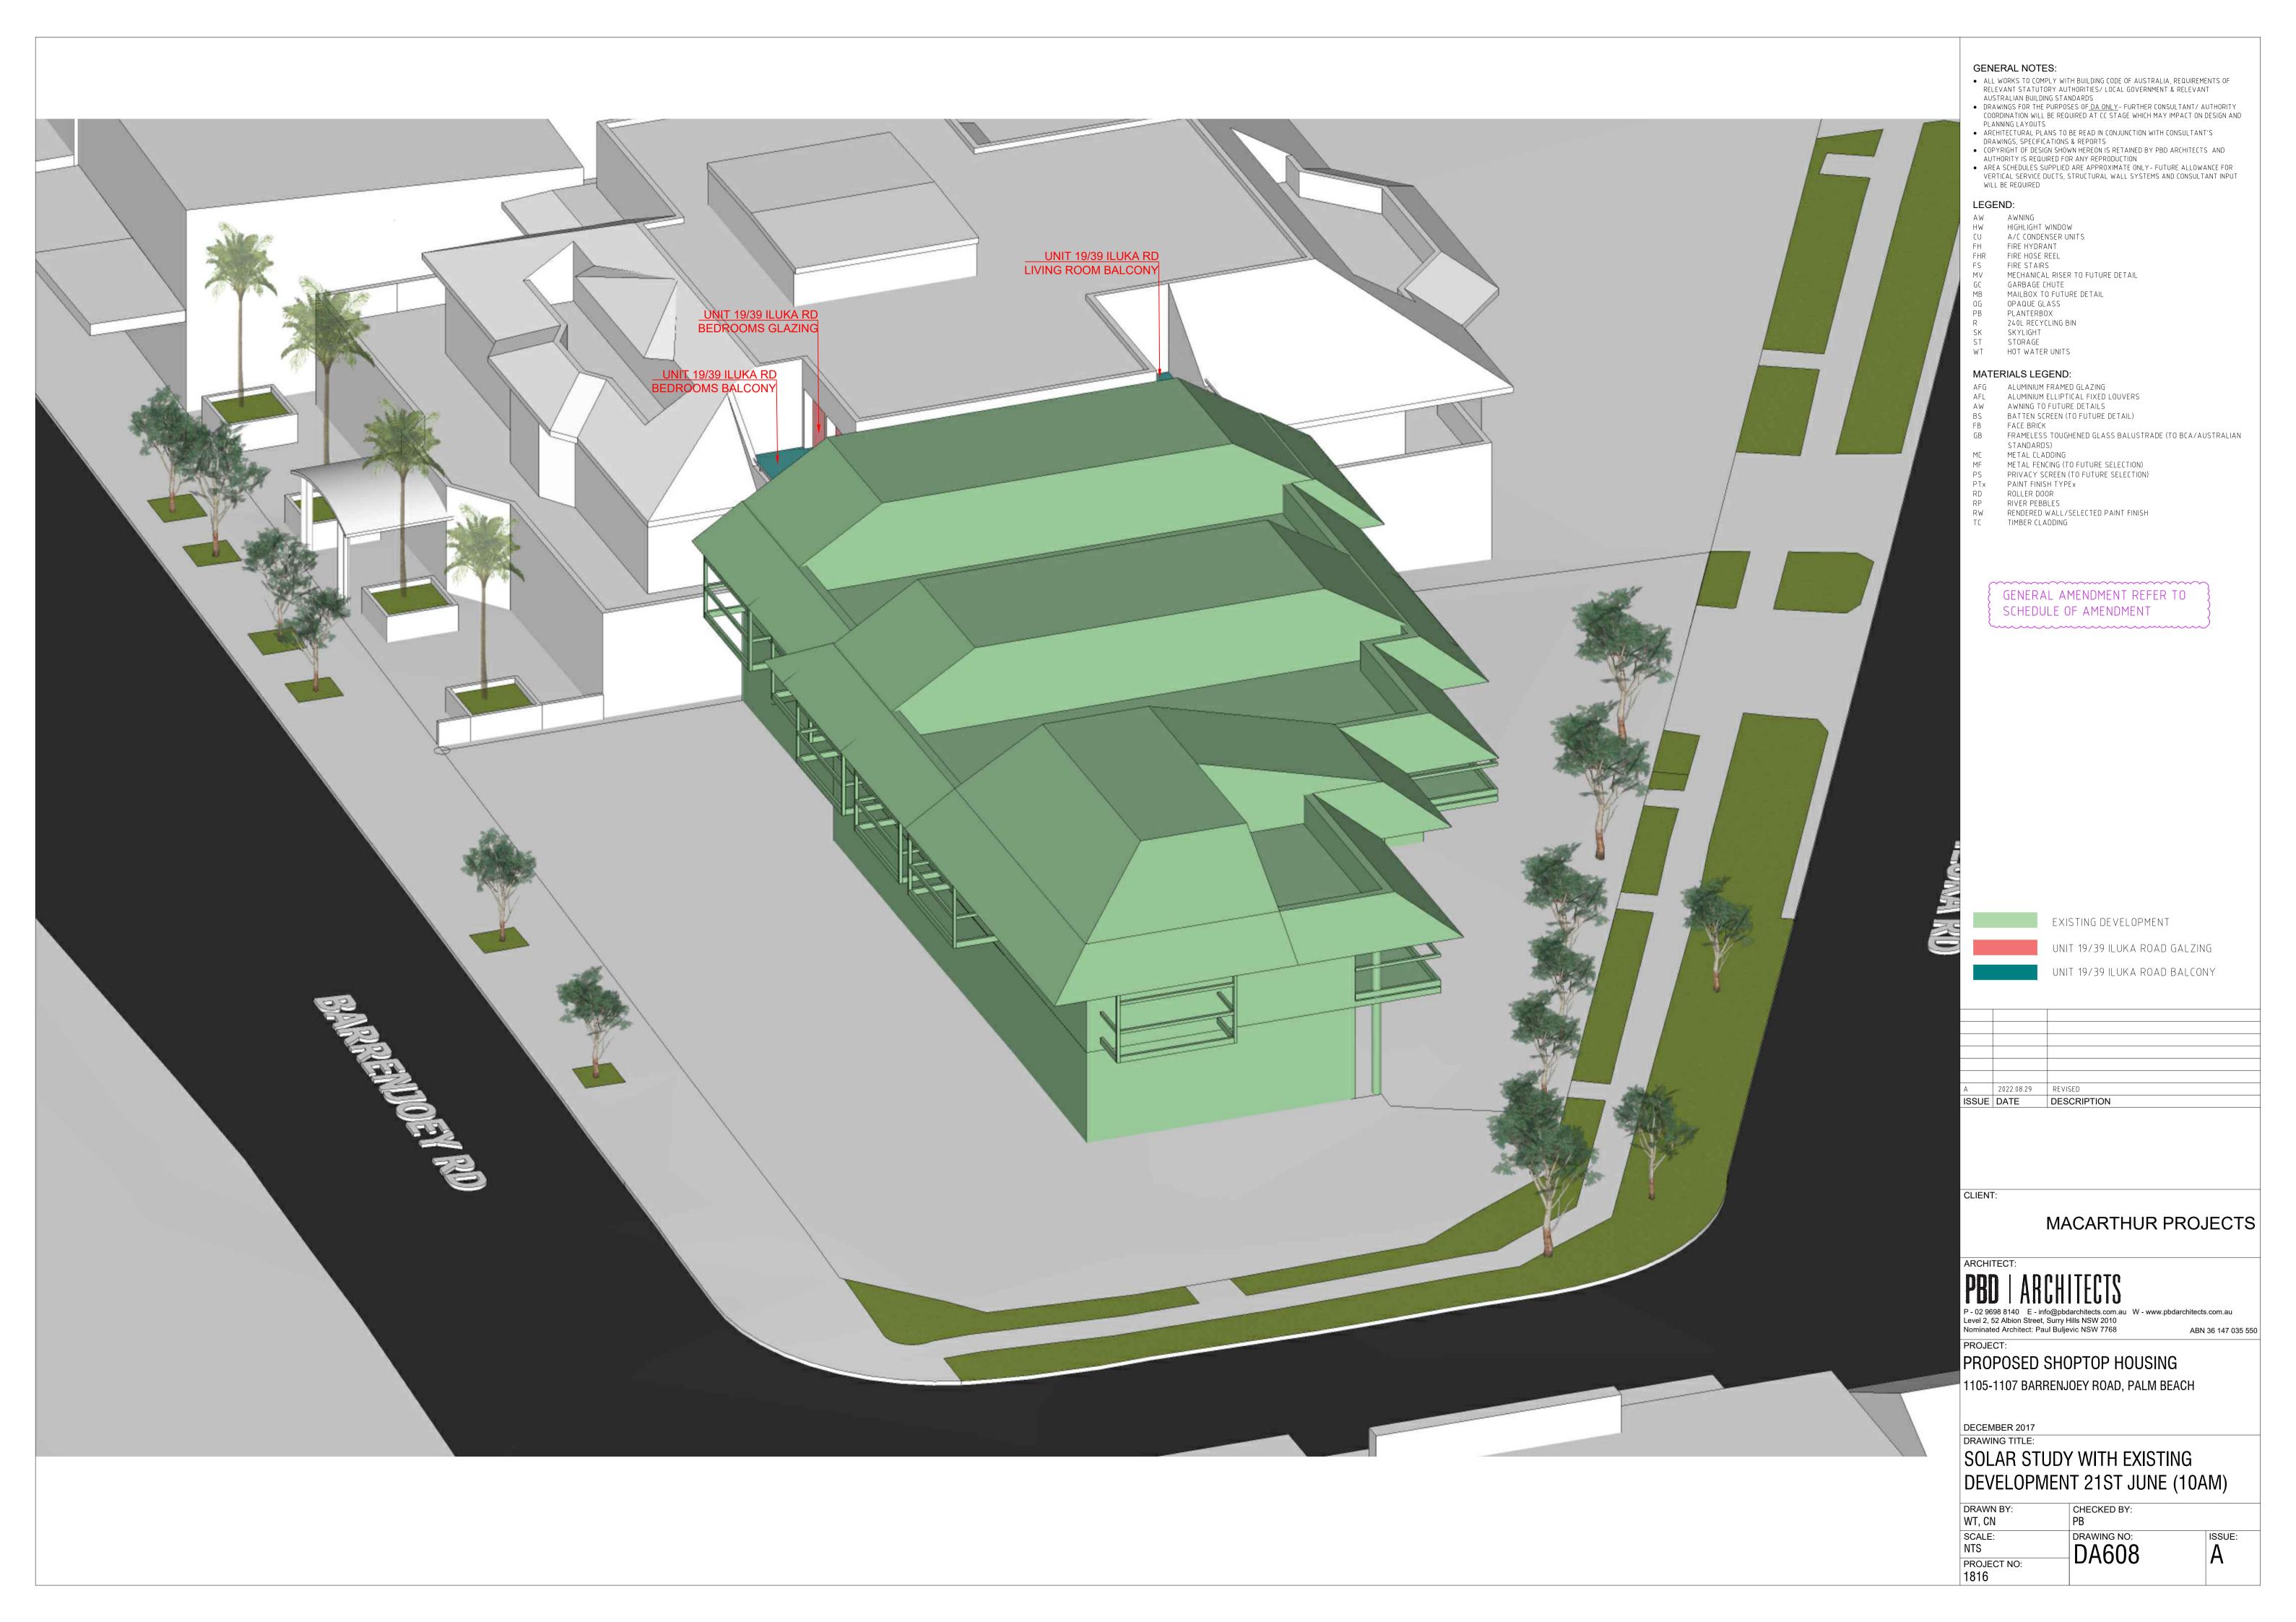













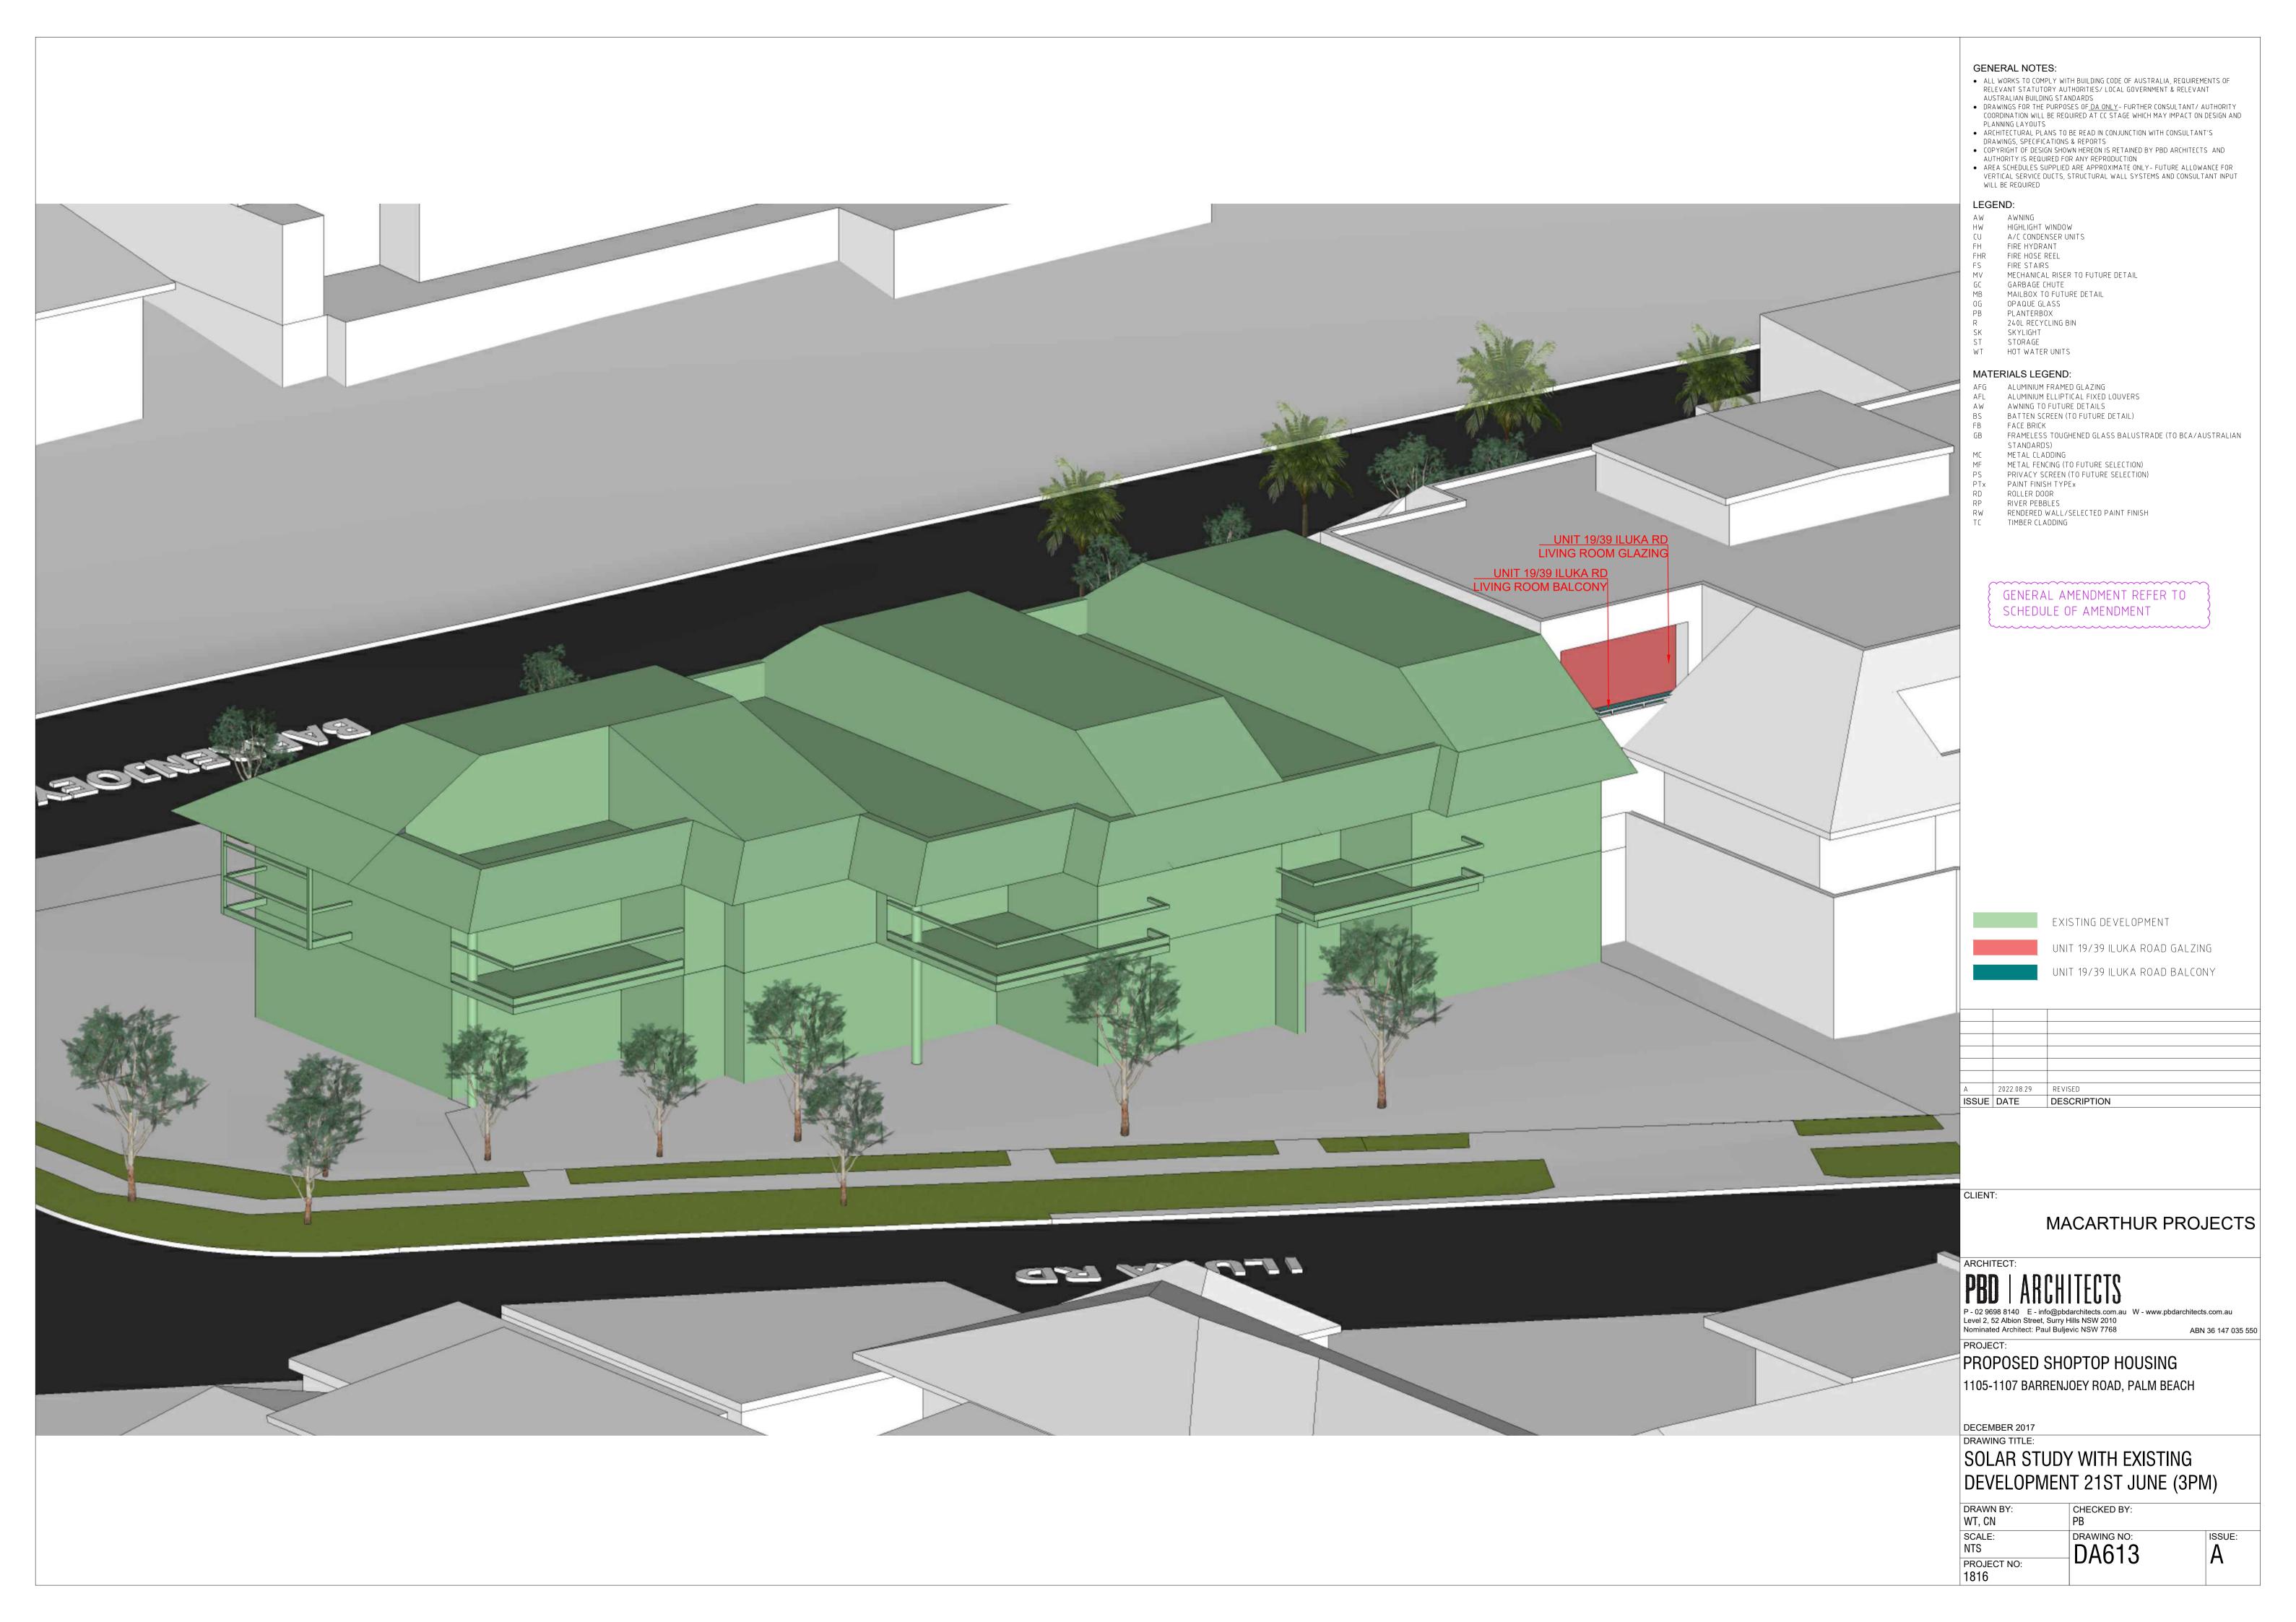


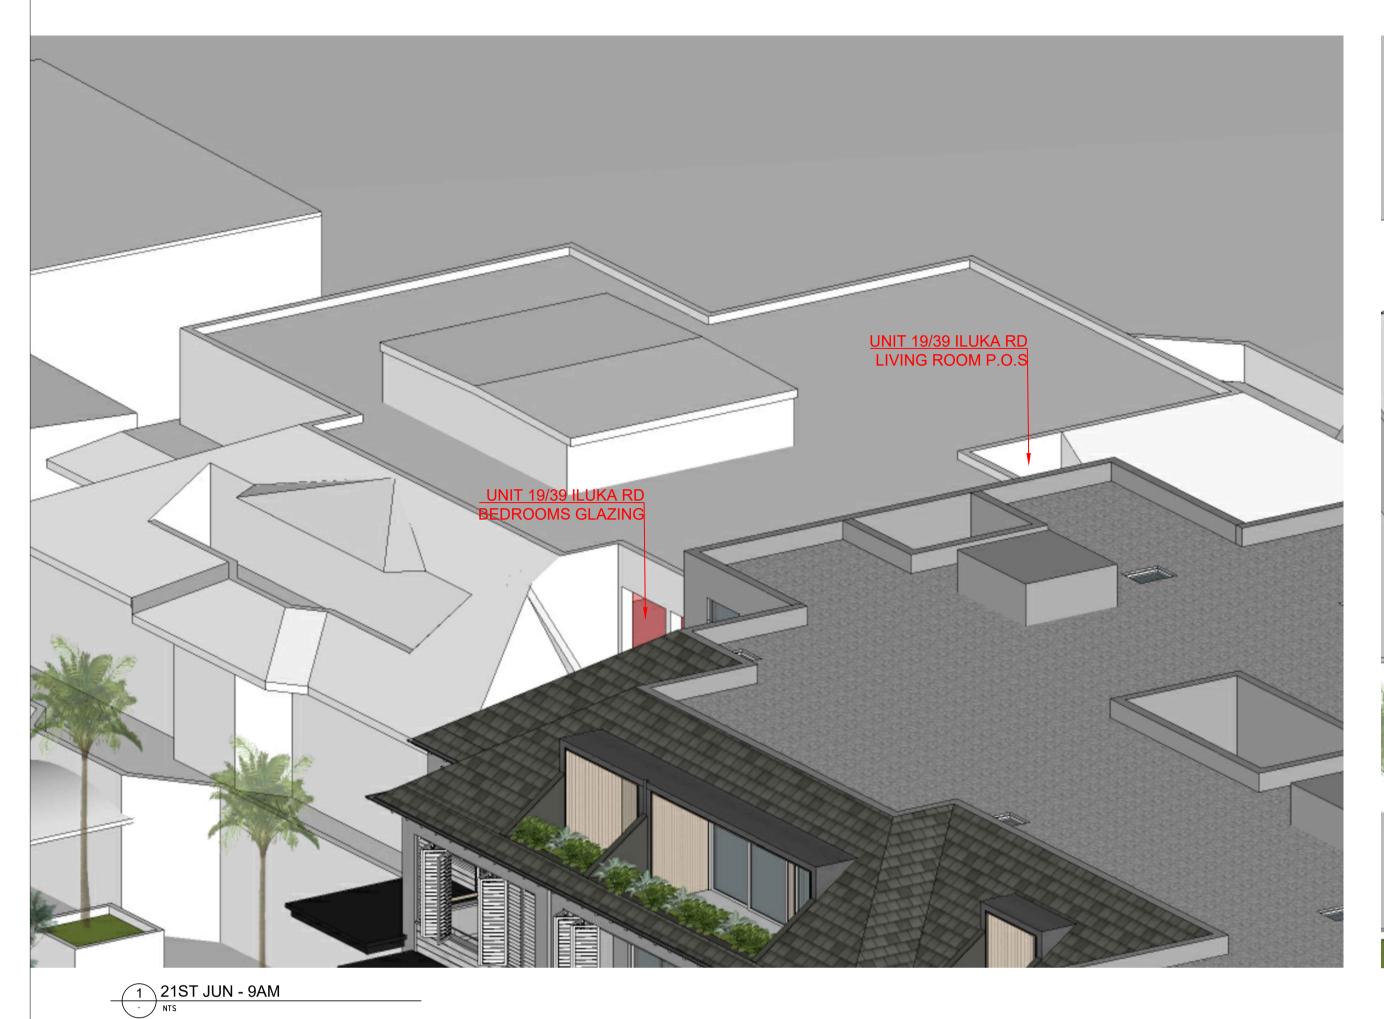

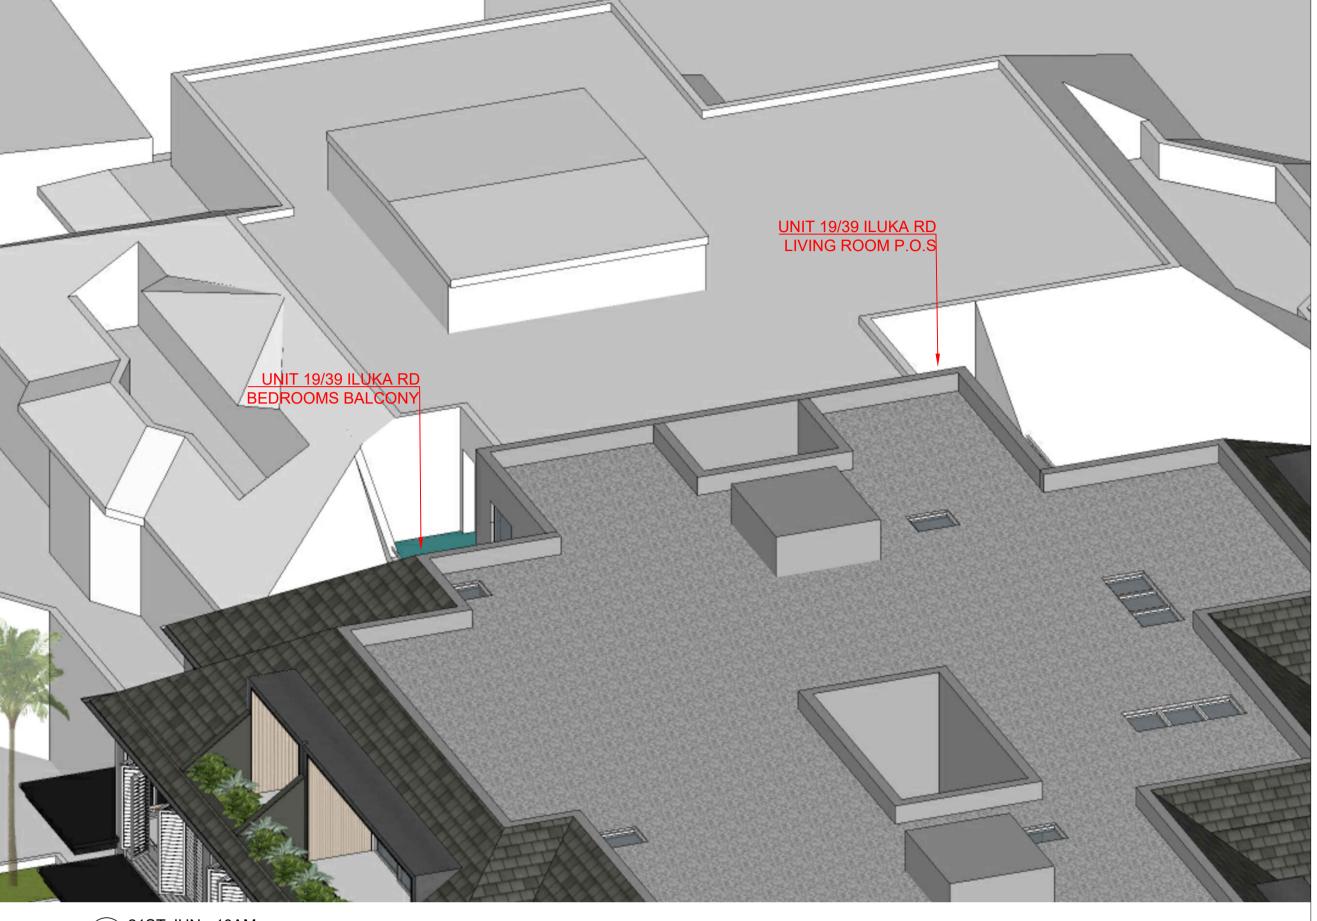



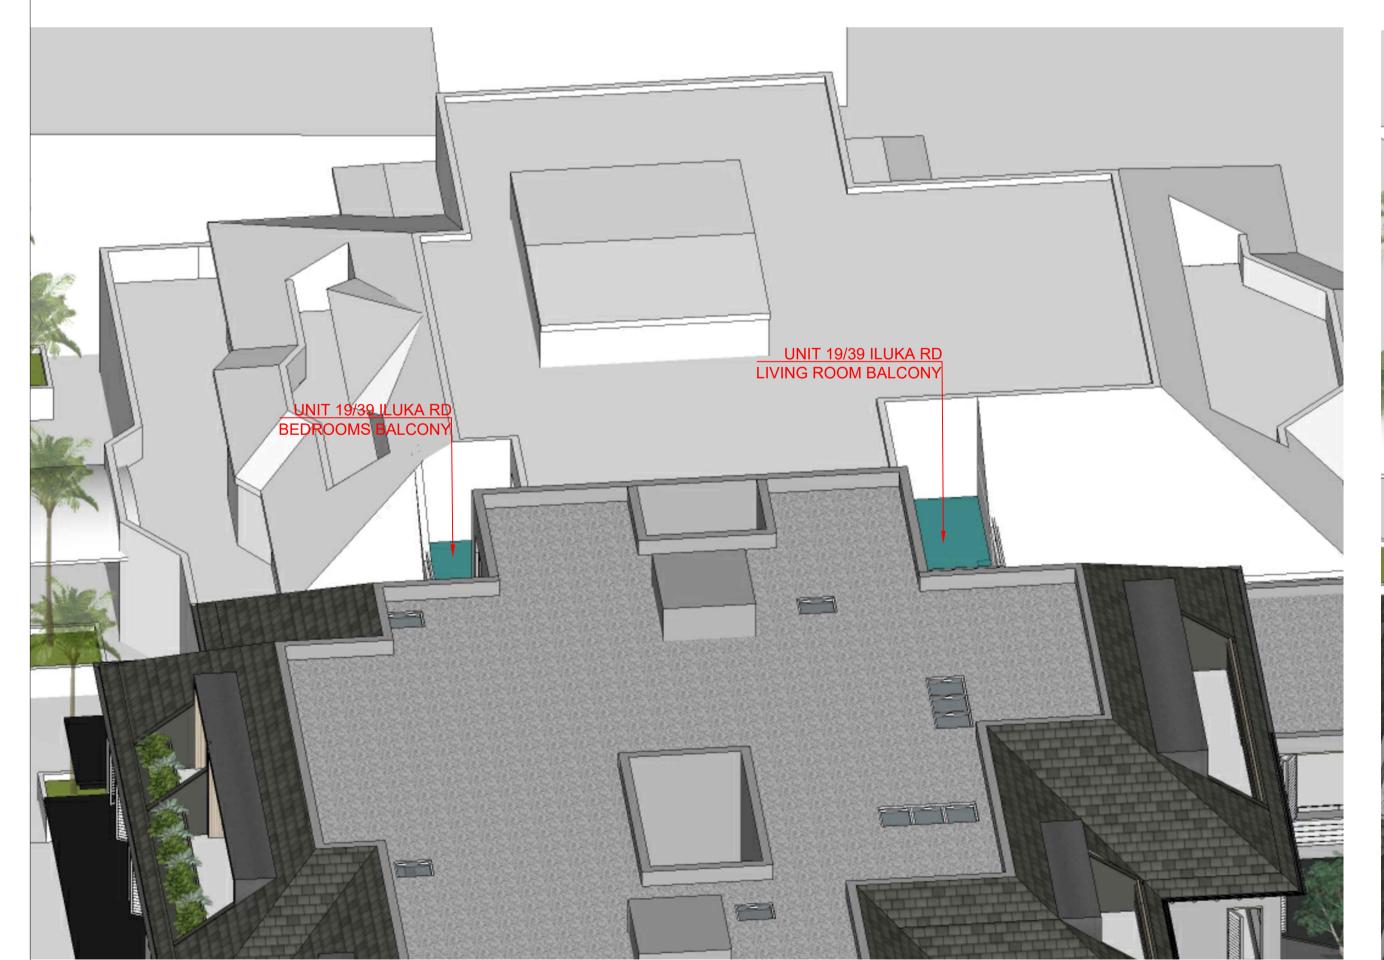

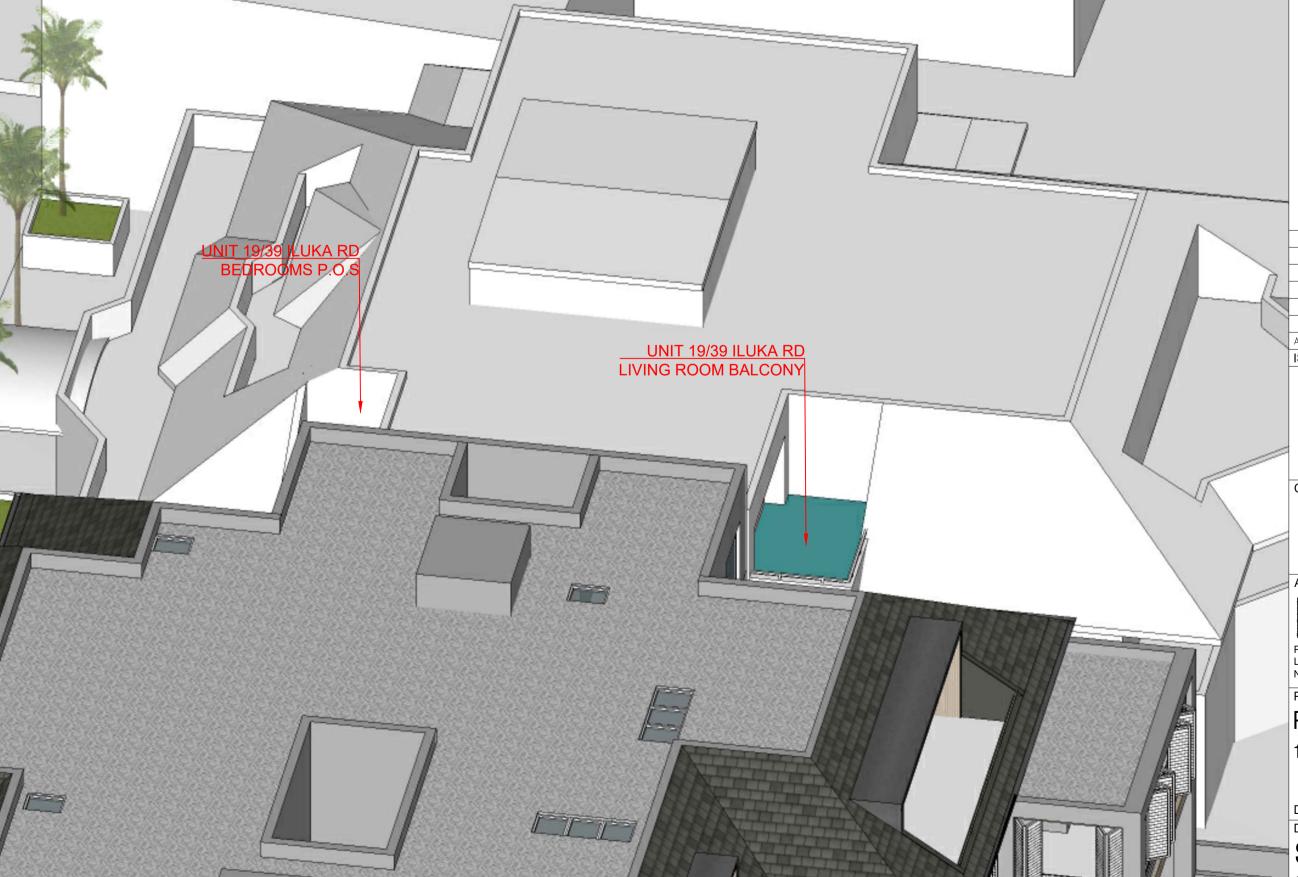

4 21ST JUN - 12PM - NTS

- ALL WORKS TO COMPLY WITH BUILDING CODE OF AUSTRALIA, REQUIREMENTS OF RELEVANT STATUTORY AUTHORITIES/ LOCAL GOVERNMENT & RELEVANT
- AUSTRALIAN BUILDING STANDARDS

 DRAWINGS FOR THE PURPOSES OF <u>DA ONLY</u> FURTHER CONSULTANT/ AUTHORITY COORDINATION WILL BE REQUIRED AT CC STAGE WHICH MAY IMPACT ON DESIGN AND PLANNING LAYOUTS
- ARCHITECTURAL PLANS TO BE READ IN CONJUNCTION WITH CONSULTANT'S DRAWINGS, SPECIFICATIONS & REPORTS
- COPYRIGHT OF DESIGN SHOWN HEREON IS RETAINED BY PBD ARCHITECTS AND AUTHORITY IS REQUIRED FOR ANY REPRODUCTION AREA SCHEDULES SUPPLIED ARE APPROXIMATE ONLY- FUTURE ALLOWANCE FOR VERTICAL SERVICE DUCTS, STRUCTURAL WALL SYSTEMS AND CONSULTANT INPUT

LEGEND:

AW AWNING HIGHLIGHT WINDOW A/C CONDENSER UNITS FIRE HYDRANT

WILL BE REQUIRED

FIRE HOSE REEL FIRE STAIRS

MECHANICAL RISER TO FUTURE DETAIL GARBAGE CHUTE

MAILBOX TO FUTURE DETAIL OPAQUE GLASS

PLANTERBOX 240L RECYCLING BIN

SKYLIGHT STORAGE

HOT WATER UNITS

MATERIALS LEGEND:

AFG ALUMINIUM FRAMED GLAZING
AFL ALUMINIUM ELLIPTICAL FIXED LOUVERS

AW AWNING TO FUTURE DETAILS

BATTEN SCREEN (TO FUTURE DETAIL) FACE BRICK FRAMELESS TOUGHENED GLASS BALUSTRADE (TO BCA/AUSTRALIAN

STANDARDS) METAL CLADDING

METAL FENCING (TO FUTURE SELECTION)
PRIVACY SCREEN (TO FUTURE SELECTION)

PAINT FINISH TYPEX ROLLER DOOR

RIVER PEBBLES

RENDERED WALL/SELECTED PAINT FINISH TIMBER CLADDING

> GENERAL AMENDMENT REFER TO SCHEDULE OF AMENDMENT

UNIT 19/39 ILUKA ROAD GALZING UNIT 19/39 ILUKA ROAD BALCONY

2022.08.29 REVISED ISSUE DATE DESCRIPTION

CLIENT:

MACARTHUR PROJECTS

ARCHITECT:

P - 02 9698 8140 E - info@pbdarchitects.com.au W - www.pbdarchitects.com.au Level 2, 52 Albion Street, Surry Hills NSW 2010
Nominated Architect: Paul Buljevic NSW 7768

ABN 36 147 035

ABN 36 147 035 550

PROJECT:

PROPOSED SHOPTOP HOUSING 1105-1107 BARRENJOEY ROAD, PALM BEACH


DECEMBER 2017

DRAWING TITLE: SOLAR STUDY

21ST JUNE (9AM-12PM)

CHECKED BY: PB DRAWN BY: WT, CN SCALE: DRAWING NO: ISSUE: NTS DA614 PROJECT NO: 1816



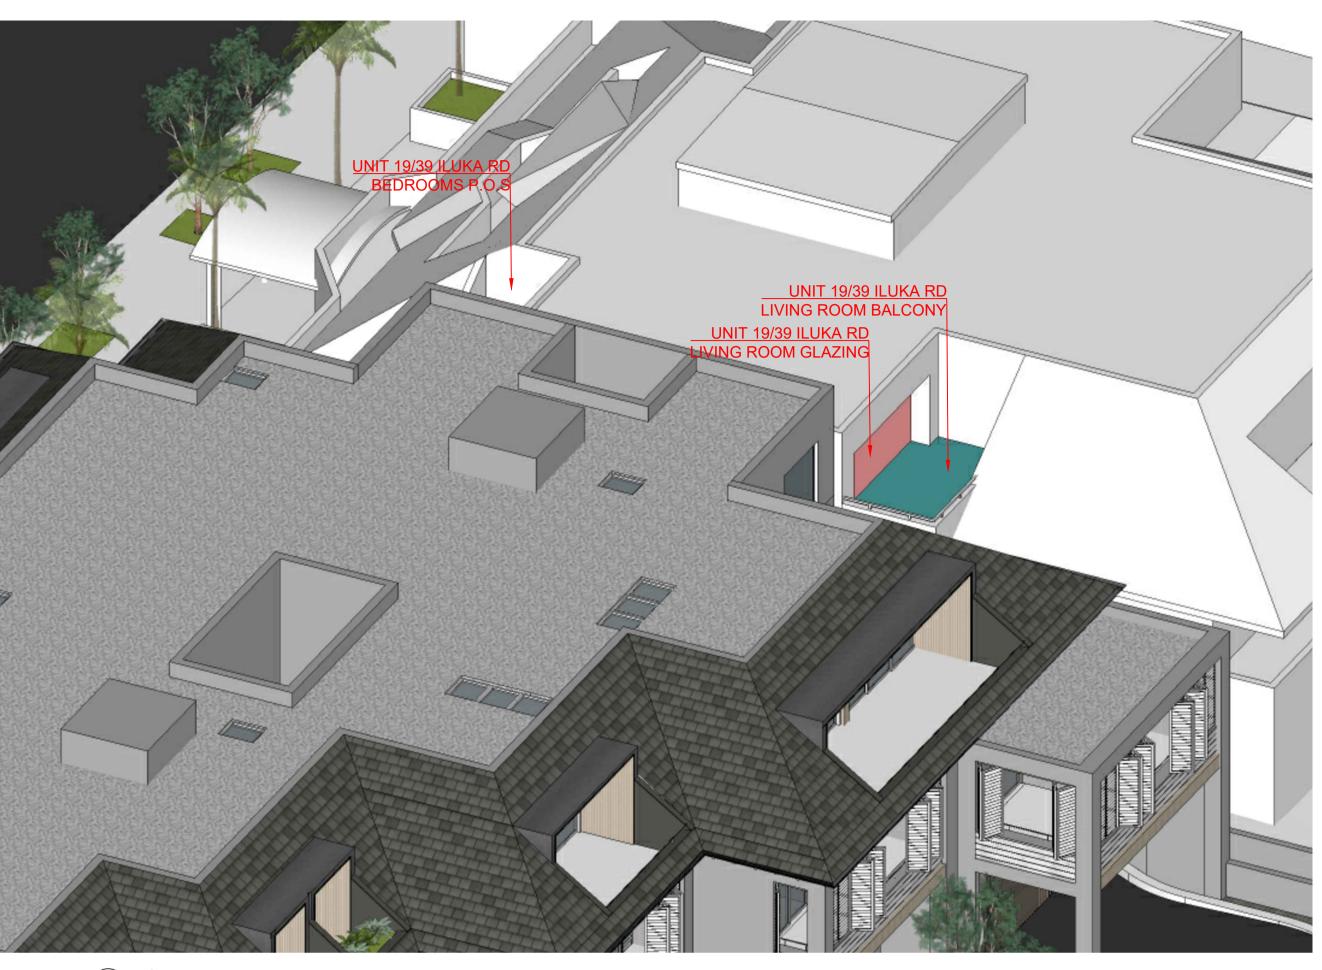







2 21ST JUN - 02PM NTS

GENERAL NOTES:

- ALL WORKS TO COMPLY WITH BUILDING CODE OF AUSTRALIA, REQUIREMENTS OF RELEVANT STATUTORY AUTHORITIES/ LOCAL GOVERNMENT & RELEVANT AUSTRALIAN BUILDING STANDARDS
 DRAWINGS FOR THE PURPOSES OF DA ONLY FURTHER CONSULTANT/ AUTHORITY COORDINATION WILL BE REQUIRED AT CC STAGE WHICH MAY IMPACT ON DESIGN AND DIANNING LAYOUTE. PLANNING LAYOUTS
- ARCHITECTURAL PLANS TO BE READ IN CONJUNCTION WITH CONSULTANT'S DRAWINGS, SPECIFICATIONS & REPORTS
 COPYRIGHT OF DESIGN SHOWN HEREON IS RETAINED BY PBD ARCHITECTS AND AUTHORITY IS REQUIRED FOR ANY REPRODUCTION
- AREA SCHEDULES SUPPLIED ARE APPROXIMATE ONLY- FUTURE ALLOWANCE FOR VERTICAL SERVICE DUCTS, STRUCTURAL WALL SYSTEMS AND CONSULTANT INPUT WILL BE REQUIRED

LEGEND:

AW AWNING HW HIGHLIGHT WINDOW A/C CONDENSER UNITS FIRE HYDRANT

FHR FIRE HOSE REEL FIRE STAIRS

MECHANICAL RISER TO FUTURE DETAIL GARBAGE CHUTE

MAILBOX TO FUTURE DETAIL OPAQUE GLASS

PLANTERBOX 240L RECYCLING BIN SKYLIGHT

STORAGE HOT WATER UNITS

MATERIALS LEGEND:

AFG ALUMINIUM FRAMED GLAZING
AFL ALUMINIUM ELLIPTICAL FIXED LOUVERS

AW AWNING TO FUTURE DETAILS BATTEN SCREEN (TO FUTURE DETAIL)

FACE BRICK FRAMELESS TOUGHENED GLASS BALUSTRADE (TO BCA/AUSTRALIAN

STANDARDS) METAL CLADDING


METAL FENCING (TO FUTURE SELECTION)
PRIVACY SCREEN (TO FUTURE SELECTION)

PAINT FINISH TYPEX ROLLER DOOR

RIVER PEBBLES

RENDERED WALL/SELECTED PAINT FINISH TIMBER CLADDING

GENERAL AMENDMENT REFER TO SCHEDULE OF AMENDMENT

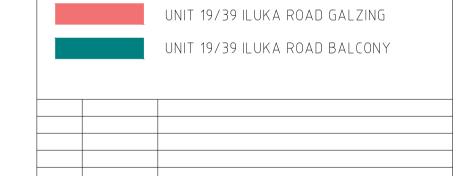

2022.08.29 REVISED ISSUE DATE DESCRIPTION

MACARTHUR PROJECTS

ARCHITECT:

CLIENT:

P - 02 9698 8140 E - info@pbdarchitects.com.au W - www.pbdarchitects.com.au Level 2, 52 Albion Street, Surry Hills NSW 2010
Nominated Architect: Paul Buljevic NSW 7768

ABN 36 147 038

ABN 36 147 035 550


PROPOSED SHOPTOP HOUSING 1105-1107 BARRENJOEY ROAD, PALM BEACH


DECEMBER 2017
DRAWING TITLE:

SOLAR STUDY


21ST JUNE (1PM-3PM)

DRAWN BY: WT, CN	CHECKED BY: PB	
SCALE: NTS	DA615	ISSUE:
PROJECT NO: 1816		

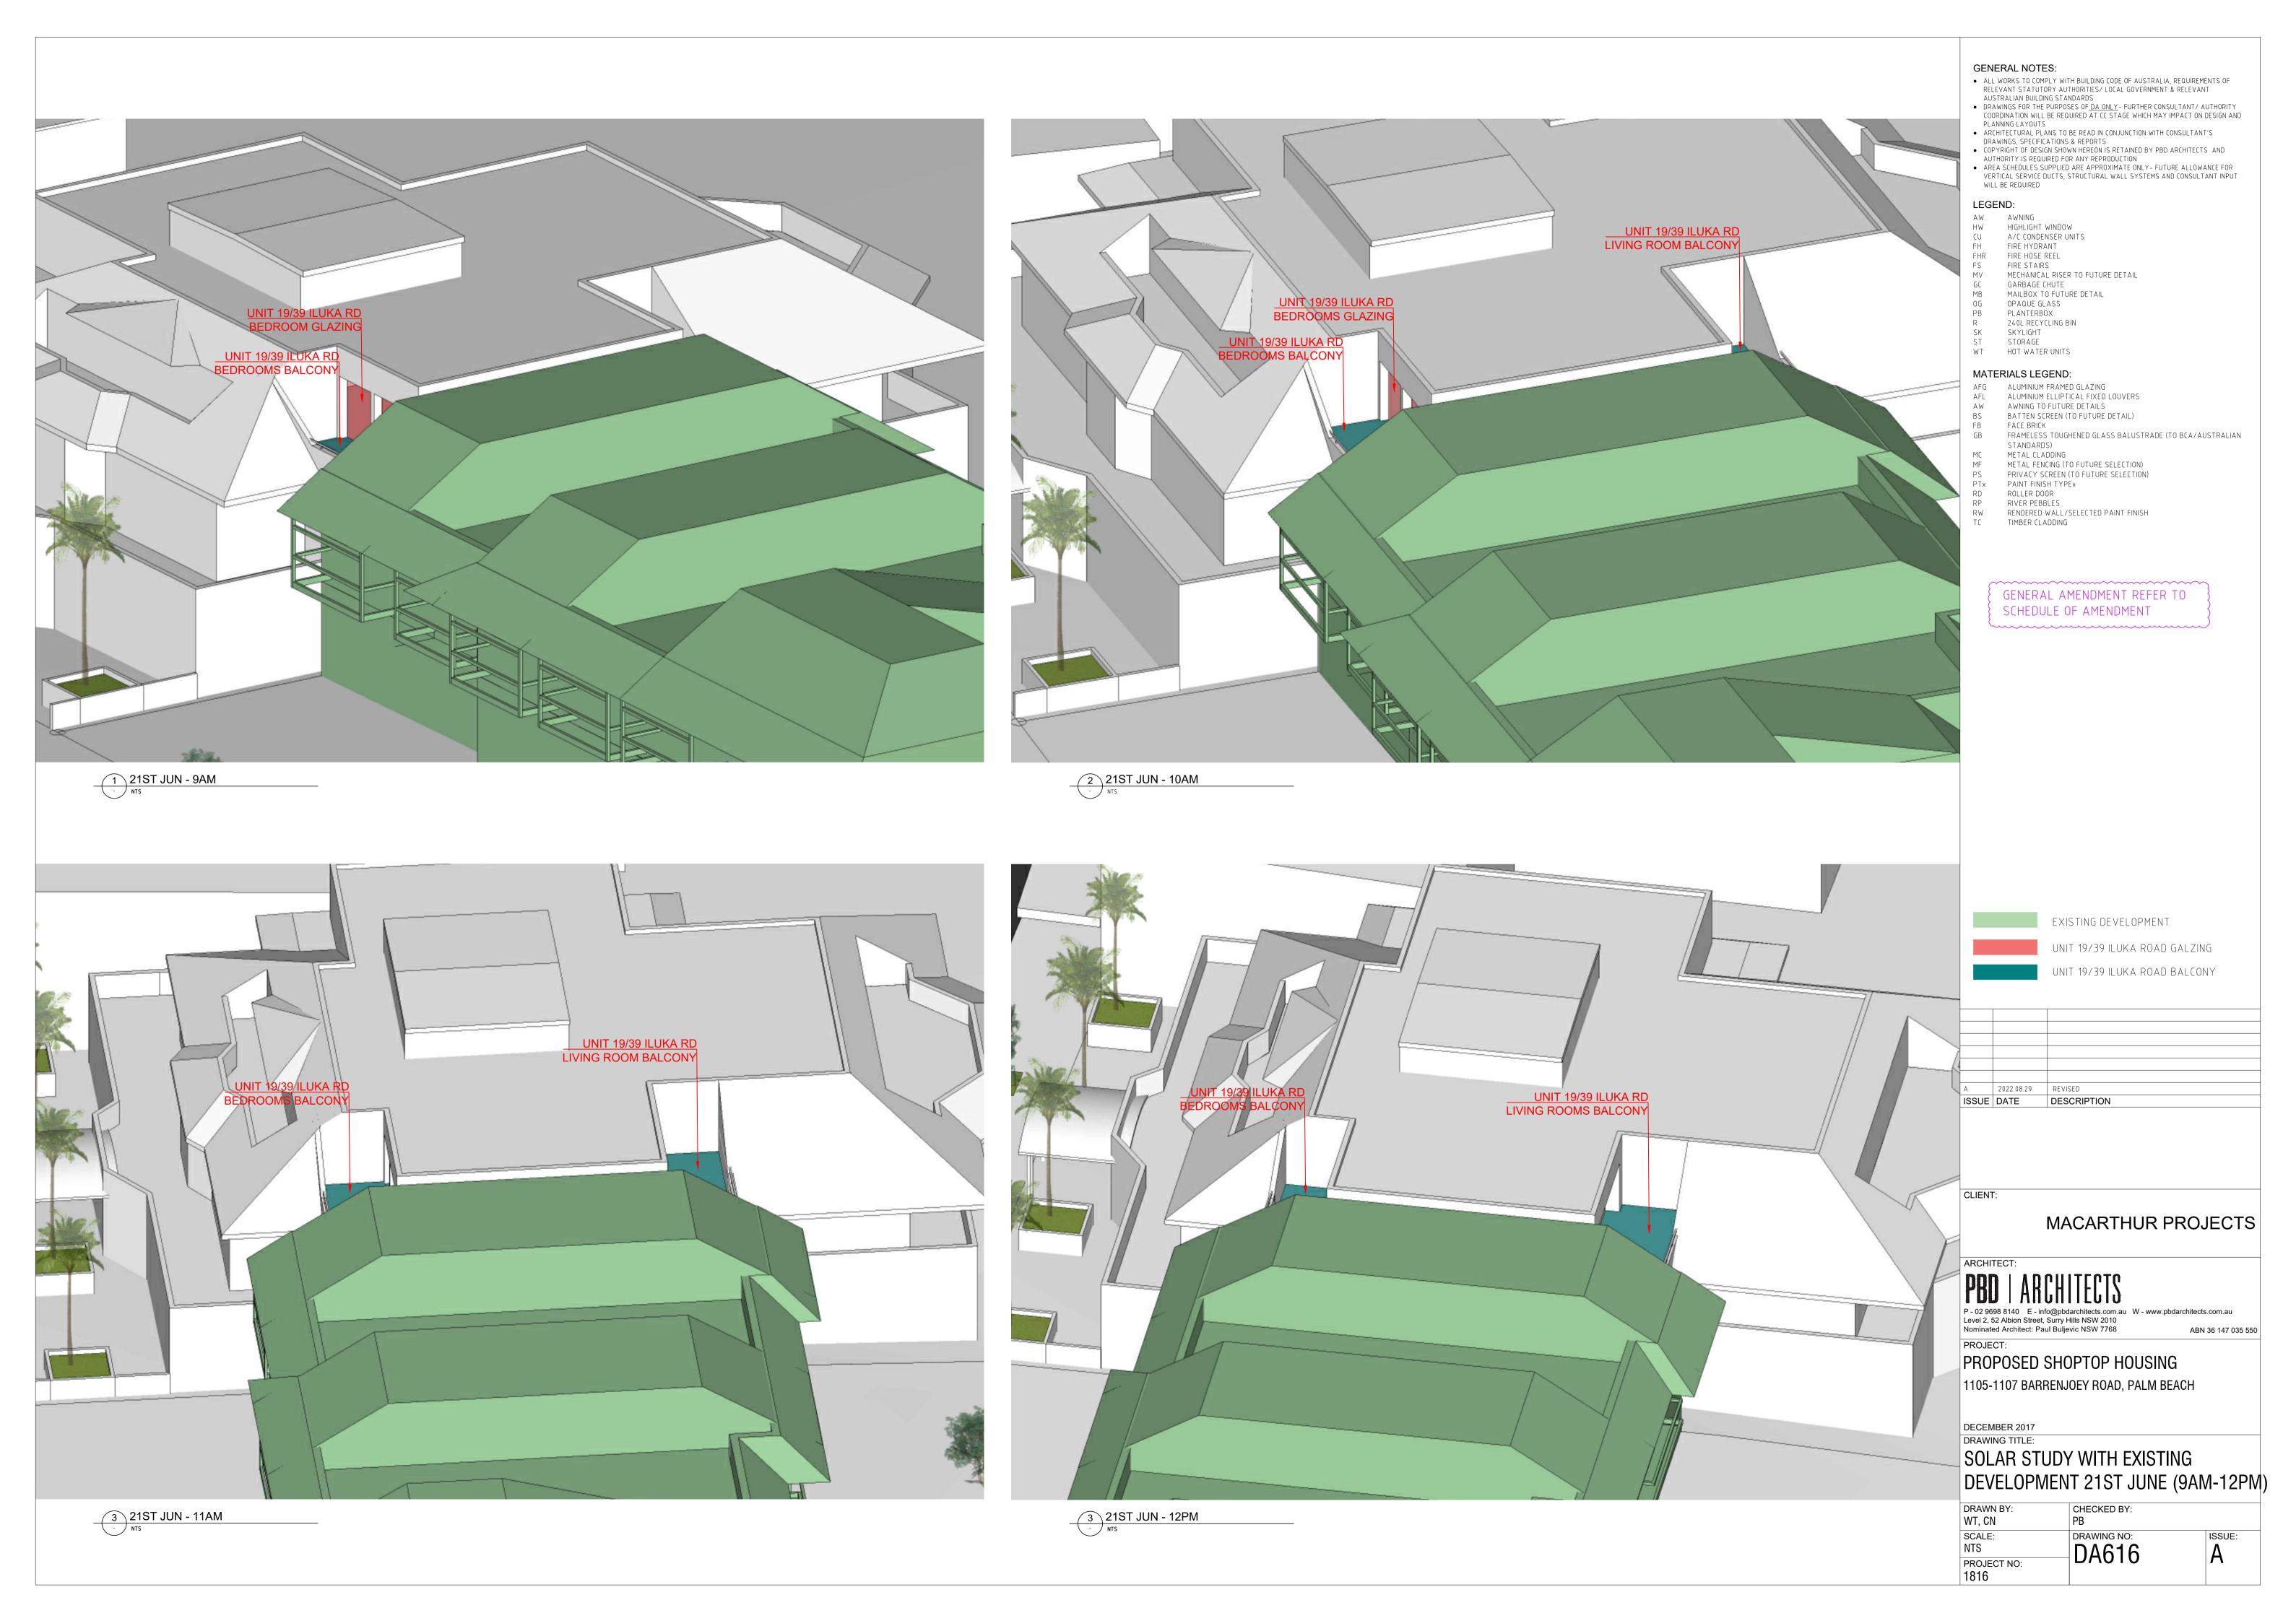

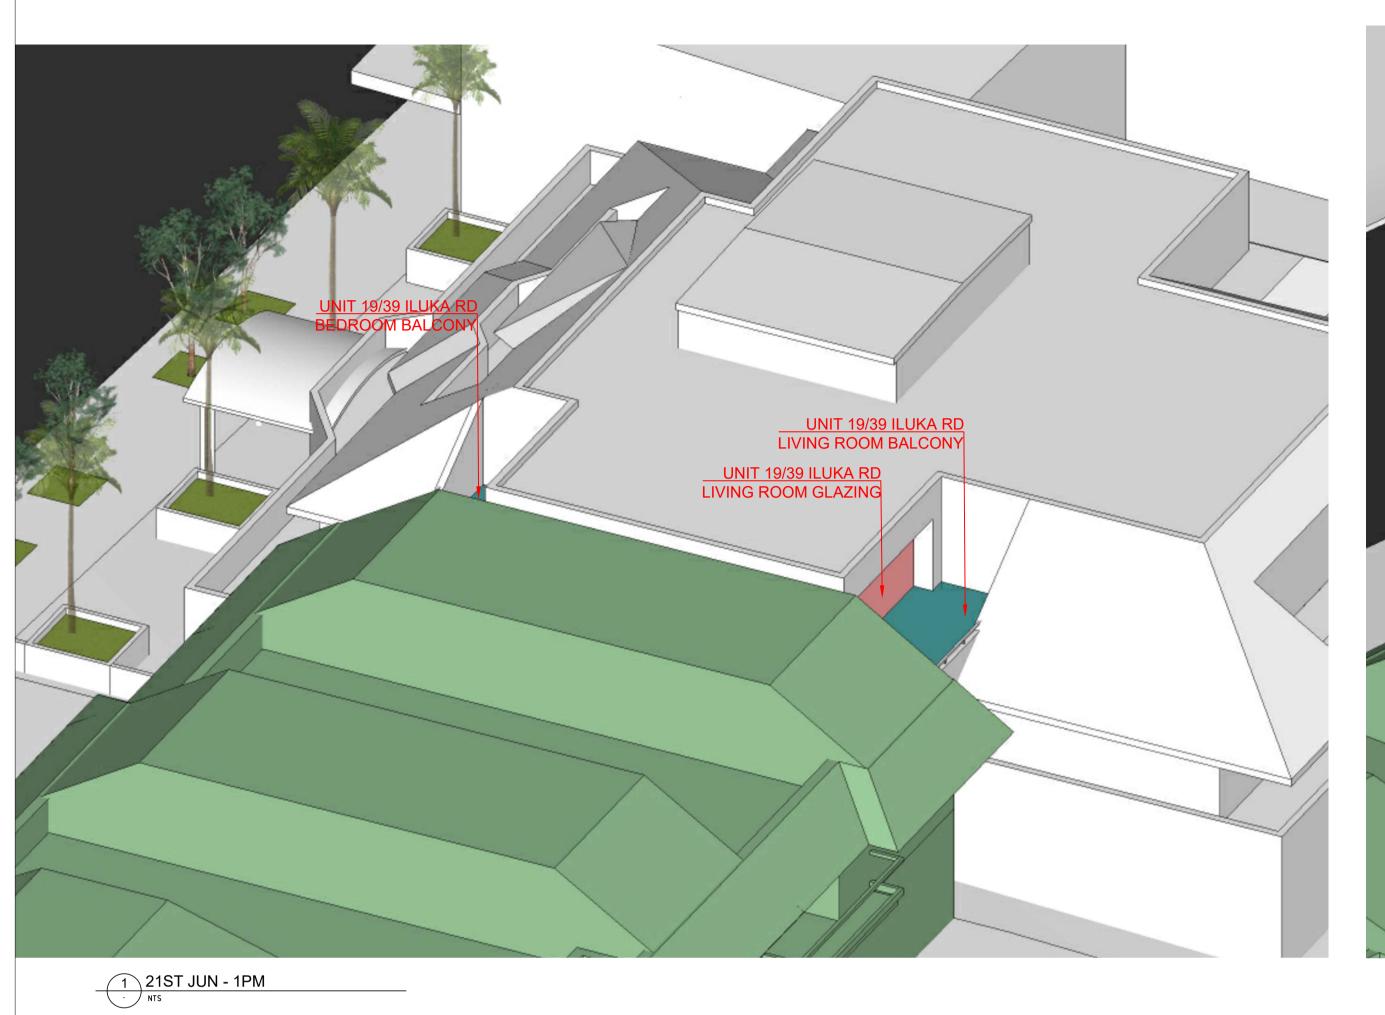



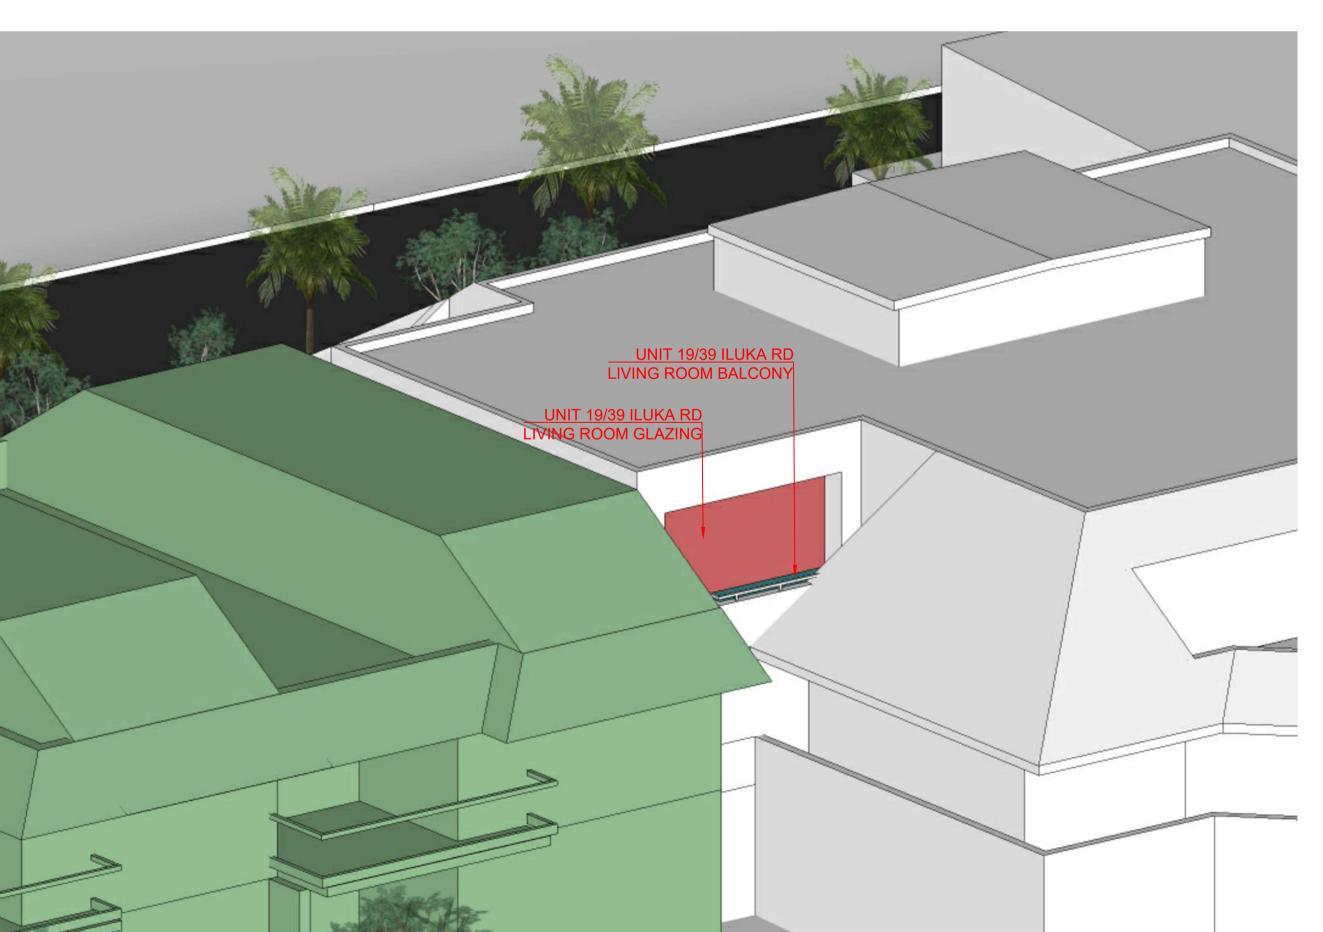

3 21ST JUN - 3PM - NTS

2 21ST JUN - 2PM • NTS

GENERAL NOTES:

- ALL WORKS TO COMPLY WITH BUILDING CODE OF AUSTRALIA, REQUIREMENTS OF RELEVANT STATUTORY AUTHORITIES/ LOCAL GOVERNMENT & RELEVANT
- AUSTRALIAN BUILDING STANDARDS

 DRAWINGS FOR THE PURPOSES OF <u>DA ONLY</u> FURTHER CONSULTANT/ AUTHORITY COORDINATION WILL BE REQUIRED AT CC STAGE WHICH MAY IMPACT ON DESIGN AND PLANNING LAYOUTS
- ARCHITECTURAL PLANS TO BE READ IN CONJUNCTION WITH CONSULTANT'S DRAWINGS, SPECIFICATIONS & REPORTS
- COPYRIGHT OF DESIGN SHOWN HEREON IS RETAINED BY PBD ARCHITECTS AND AUTHORITY IS REQUIRED FOR ANY REPRODUCTION AREA SCHEDULES SUPPLIED ARE APPROXIMATE ONLY- FUTURE ALLOWANCE FOR

VERTICAL SERVICE DUCTS, STRUCTURAL WALL SYSTEMS AND CONSULTANT INPUT

WILL BE REQUIRED LEGEND:

AW AWNING

HW HIGHLIGHT WINDOW
CU A/C CONDENSER UNIT A/C CONDENSER UNITS

FIRE HYDRANT FHR FIRE HOSE REEL

FIRE STAIRS MECHANICAL RISER TO FUTURE DETAIL

GARBAGE CHUTE

MAILBOX TO FUTURE DETAIL OPAQUE GLASS PLANTERBOX

240L RECYCLING BIN SKYLIGHT

STORAGE HOT WATER UNITS

MATERIALS LEGEND:

- AFG ALUMINIUM FRAMED GLAZING
 AFL ALUMINIUM ELLIPTICAL FIXED LOUVERS
- AW AWNING TO FUTURE DETAILS
- BATTEN SCREEN (TO FUTURE DETAIL) FACE BRICK
- FRAMELESS TOUGHENED GLASS BALUSTRADE (TO BCA/AUSTRALIAN
- STANDARDS) METAL CLADDING
- METAL FENCING (TO FUTURE SELECTION)
- PRIVACY SCREEN (TO FUTURE SELECTION) PAINT FINISH TYPEX
- ROLLER DOOR
- RIVER PEBBLES RENDERED WALL/SELECTED PAINT FINISH

TIMBER CLADDING

GENERAL AMENDMENT REFER TO SCHEDULE OF AMENDMENT

EXISTING DEVELOPMENT UNIT 19/39 ILUKA ROAD GALZING UNIT 19/39 ILUKA ROAD BALCONY 2022.08.29 REVISED

CLIENT:

MACARTHUR PROJECTS

ABN 36 147 035 550

ARCHITECT:

ISSUE DATE DESCRIPTION

P - 02 9698 8140 E - info@pbdarchitects.com.au W - www.pbdarchitects.com.au Level 2, 52 Albion Street, Surry Hills NSW 2010
Nominated Architect: Paul Buljevic NSW 7768

ABN 36 147 038


PROPOSED SHOPTOP HOUSING 1105-1107 BARRENJOEY ROAD, PALM BEACH


DECEMBER 2017

DRAWING TITLE:

SOLAR STUDY WITH EXISTING DEVELOPMENT 21ST JUNE (1PM-3PM)

DRAWN BY: CHECKED BY: PB WT, CN SCALE: DRAWING NO: ISSUE: NTS DA617 PROJECT NO: 1816

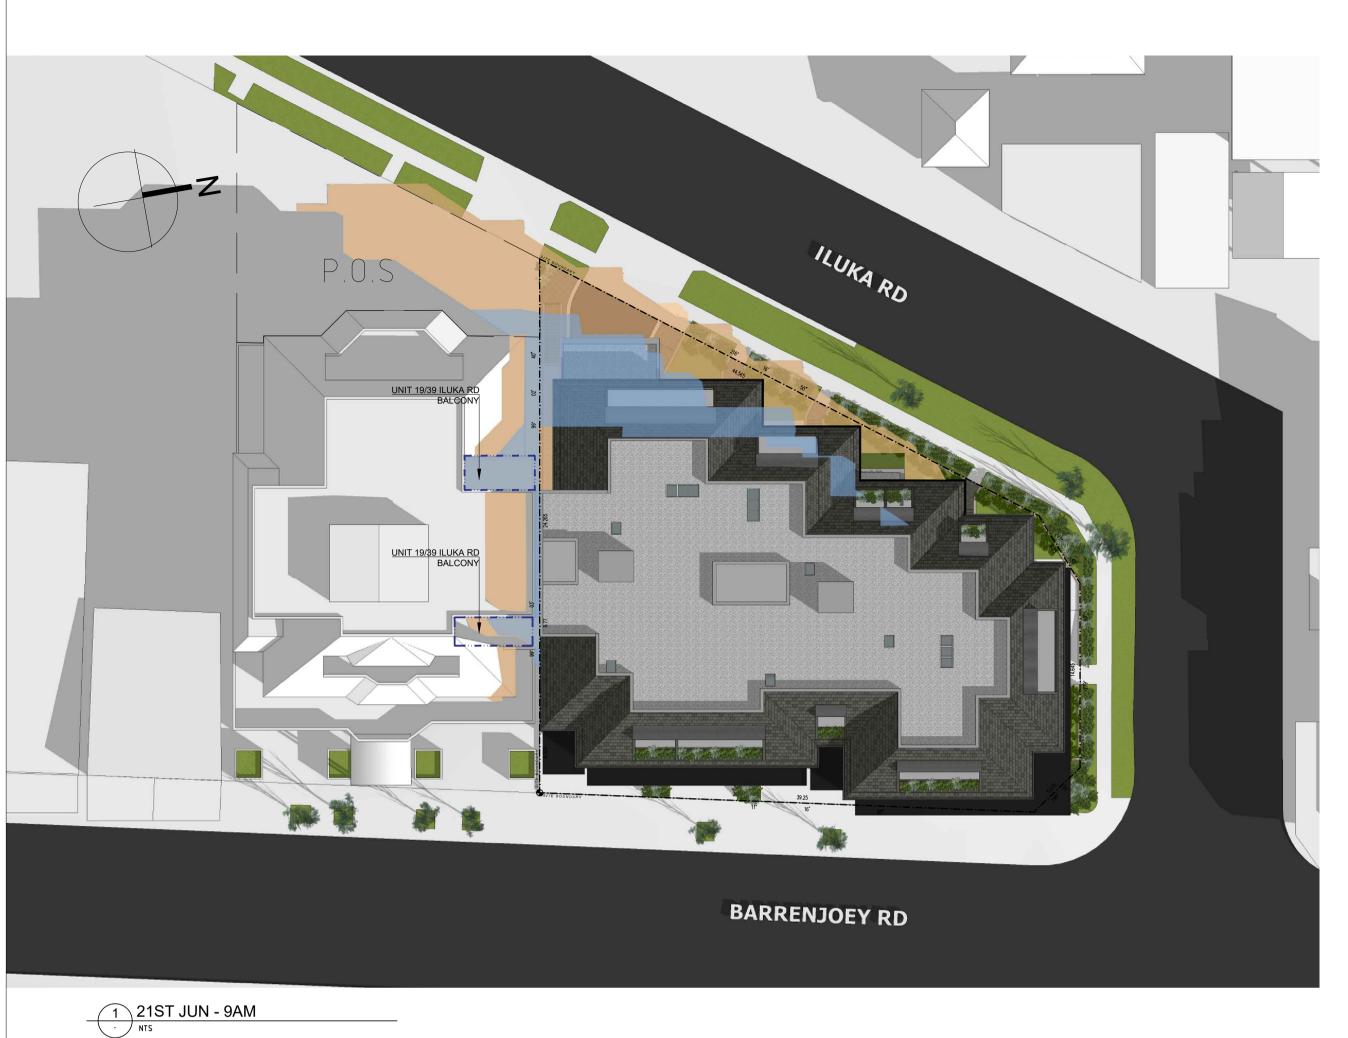

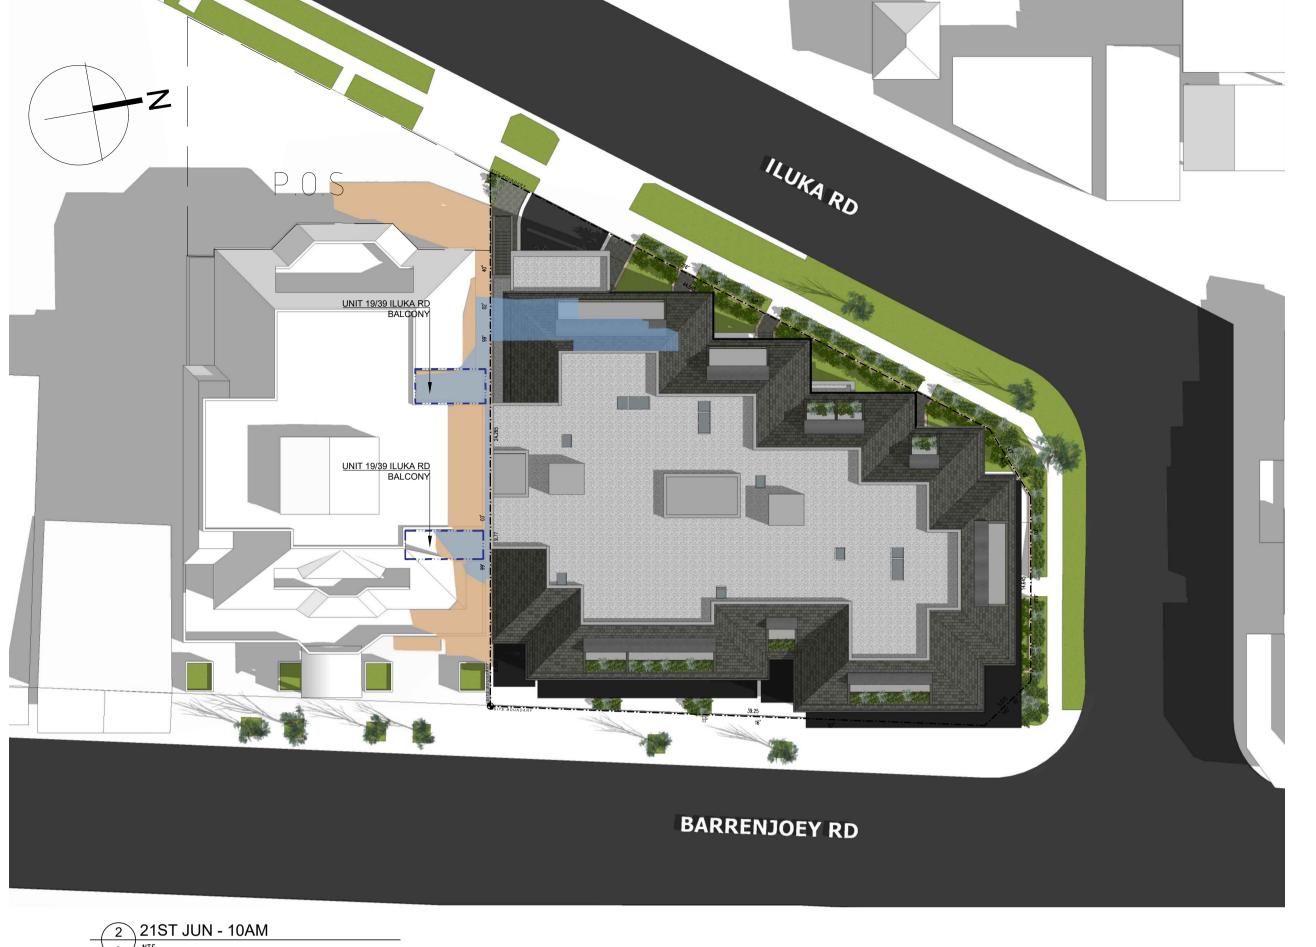

ILUKA RD P.O.S UNIT 19/39 ILUKA RD BALCONY BARRENJOEY RD

3 21ST JUN - 11AM NTS



4 21ST JUN - 12PM NTS

GENERAL NOTES:

- ALL WORKS TO COMPLY WITH BUILDING CODE OF AUSTRALIA, REQUIREMENTS OF RELEVANT STATUTORY AUTHORITIES/ LOCAL GOVERNMENT & RELEVANT
- AUSTRALIAN BUILDING STANDARDS

 DRAWINGS FOR THE PURPOSES OF <u>DA ONLY</u> FURTHER CONSULTANT/ AUTHORITY COORDINATION WILL BE REQUIRED AT CC STAGE WHICH MAY IMPACT ON DESIGN AND
- ARCHITECTURAL PLANS TO BE READ IN CONJUNCTION WITH CONSULTANT'S DRAWINGS, SPECIFICATIONS & REPORTS
 COPYRIGHT OF DESIGN SHOWN HEREON IS RETAINED BY PBD ARCHITECTS AND
- AUTHORITY IS REQUIRED FOR ANY REPRODUCTION AREA SCHEDULES SUPPLIED ARE APPROXIMATE ONLY- FUTURE ALLOWANCE FOR VERTICAL SERVICE DUCTS, STRUCTURAL WALL SYSTEMS AND CONSULTANT INPUT

LEGEND:

AW AWNING HIGHLIGHT WINDOW A/C CONDENSER UNITS FIRE HYDRANT

> FIRE STAIRS MECHANICAL RISER TO FUTURE DETAIL

GARBAGE CHUTE MAILBOX TO FUTURE DETAIL

OPAQUE GLASS PLANTERBOX

FIRE HOSE REEL

240L RECYCLING BIN SKYLIGHT STORAGE

HOT WATER UNITS

MATERIALS LEGEND:

AFG ALUMINIUM FRAMED GLAZING
AFL ALUMINIUM ELLIPTICAL FIXED LOUVERS

AWNING TO FUTURE DETAILS

BATTEN SCREEN (TO FUTURE DETAIL) FACE BRICK

FRAMELESS TOUGHENED GLASS BALUSTRADE (TO BCA/AUSTRALIAN STANDARDS)

METAL CLADDING

METAL FENCING (TO FUTURE SELECTION) PRIVACY SCREEN (TO FUTURE SELECTION)

PAINT FINISH TYPEX

ROLLER DOOR RIVER PEBBLES

RENDERED WALL/SELECTED PAINT FINISH TIMBER CLADDING

GENERAL AMENDMENT REFER TO

SCHEDULE OF AMENDMENT

OUTLINE OF SHADOW CAST BY PROPOSED DEVELOPMENT SHADOW CAST BY EXISTING BUILDINGS UNIT 12/39 ILUKA RD BALCONIES

> DA LODGEMENT DESCRIPTION

CLIENT:

MACARTHUR PROJECTS

ARCHITECT:

2022.08.29 2020.12.18

P - 02 9698 8140 E - info@pbdarchitects.com.au W - www.pbdarchitects.com.au
Level 2, 52 Albion Street, Surry Hills NSW 2010
Nominated Architect: Paul Buljevic NSW 7768

ABN 36 147 038

ABN 36 147 035 550

PROPOSED SHOPTOP HOUSING


1105-1107 BARRENJOEY ROAD, PALM BEACH

DECEMBER 2017


DRAWING TITLE: SHADOW DIAGRAM


21ST JUNE (9AM-3PM)

DRAWN BY: WT, CN	CHECKED BY: PB	
SCALE: NTS	DA620	ISSUE:
PROJECT NO: 1816	DAUZU	ט

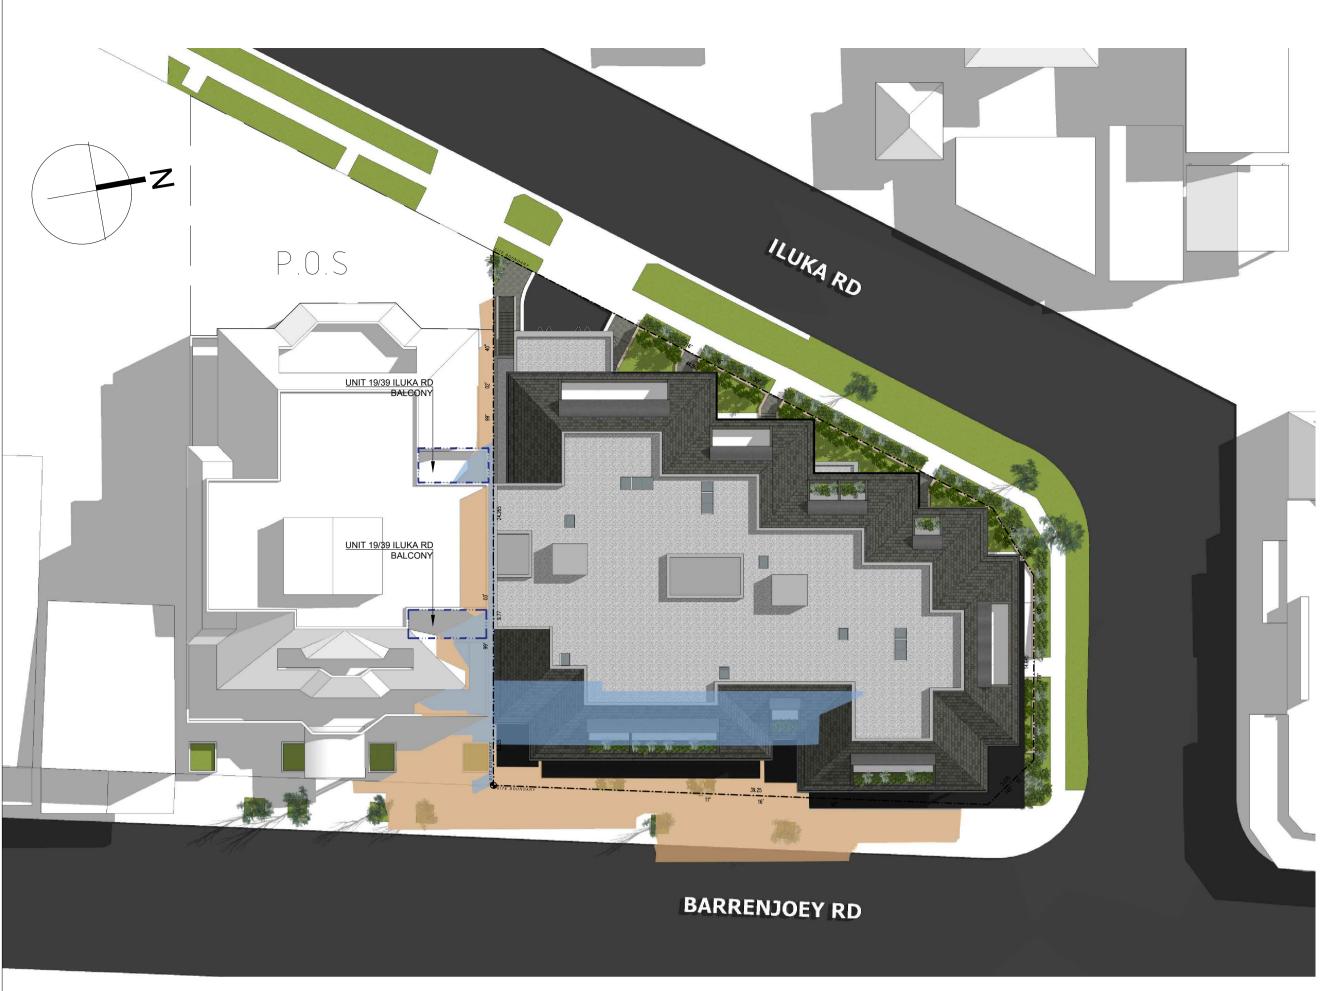



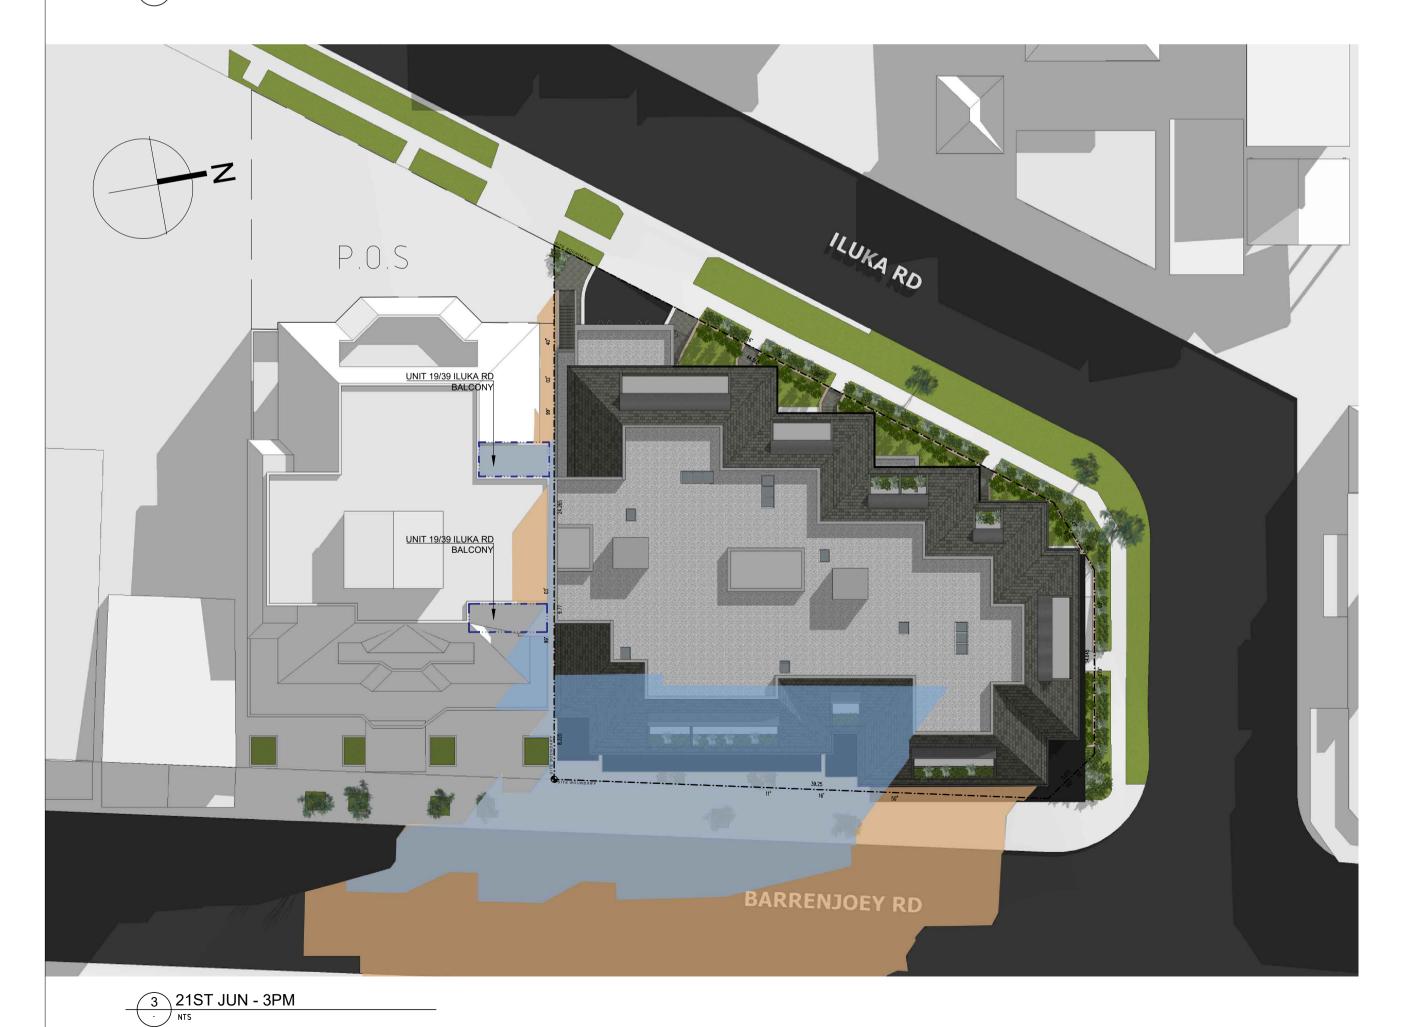

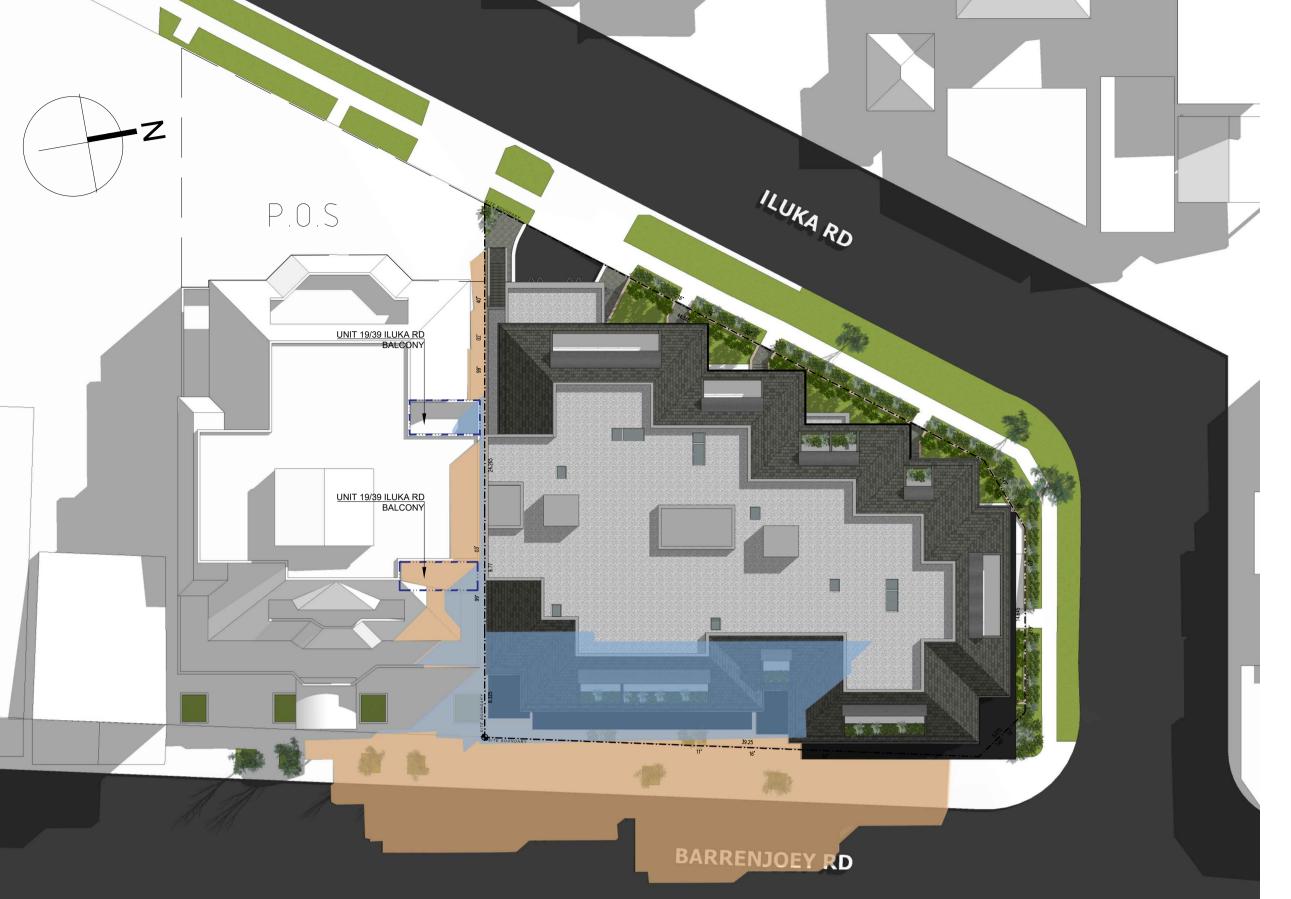

2 21ST JUN - 02PM NTS

GENERAL NOTES:

- ALL WORKS TO COMPLY WITH BUILDING CODE OF AUSTRALIA, REQUIREMENTS OF RELEVANT STATUTORY AUTHORITIES/ LOCAL GOVERNMENT & RELEVANT
- AUSTRALIAN BUILDING STANDARDS

 DRAWINGS FOR THE PURPOSES OF <u>DA ONLY</u> FURTHER CONSULTANT/ AUTHORITY COORDINATION WILL BE REQUIRED AT CC STAGE WHICH MAY IMPACT ON DESIGN AND PLANNING LAYOUTS
- ARCHITECTURAL PLANS TO BE READ IN CONJUNCTION WITH CONSULTANT'S DRAWINGS, SPECIFICATIONS & REPORTS
- AUTHORITY IS REQUIRED FOR ANY REPRODUCTION AREA SCHEDULES SUPPLIED ARE APPROXIMATE ONLY- FUTURE ALLOWANCE FOR VERTICAL SERVICE DUCTS, STRUCTURAL WALL SYSTEMS AND CONSULTANT INPUT WILL BE REQUIRED

COPYRIGHT OF DESIGN SHOWN HEREON IS RETAINED BY PBD ARCHITECTS AND

LEGEND:

AW AWNING HW HIGHLIGHT WINDOW A/C CONDENSER UNITS FIRE HYDRANT FHR FIRE HOSE REEL FIRE STAIRS

MECHANICAL RISER TO FUTURE DETAIL GARBAGE CHUTE

240L RECYCLING BIN

MAILBOX TO FUTURE DETAIL OPAQUE GLASS PLANTERBOX

SKYLIGHT STORAGE HOT WATER UNITS

MATERIALS LEGEND:

AFG ALUMINIUM FRAMED GLAZING
AFL ALUMINIUM ELLIPTICAL FIXED LOUVERS

AWNING TO FUTURE DETAILS BATTEN SCREEN (TO FUTURE DETAIL)

FACE BRICK FRAMELESS TOUGHENED GLASS BALUSTRADE (TO BCA/AUSTRALIAN

STANDARDS) METAL CLADDING

METAL FENCING (TO FUTURE SELECTION) PRIVACY SCREEN (TO FUTURE SELECTION)

PAINT FINISH TYPEX ROLLER DOOR RIVER PEBBLES

RENDERED WALL/SELECTED PAINT FINISH TIMBER CLADDING

GENERAL AMENDMENT REFER TO

SCHEDULE OF AMENDMENT

LEGEND OUTLINE OF SHADOW CAST BY PROPOSED DEVELOPMENT SHADOW CAST BY EXISTING BUILDINGS UNIT 12/39 ILUKA RD BALCONIES 2022.08.29 REVISED 2020.12.18 DA LODGEMENT

CLIENT:

MACARTHUR PROJECTS

ARCHITECT:

ISSUE DATE DESCRIPTION

P - 02 9698 8140 E - info@pbdarchitects.com.au W - www.pbdarchitects.com.au Level 2, 52 Albion Street, Surry Hills NSW 2010
Nominated Architect: Paul Buljevic NSW 7768 ABN 36 147 03

ABN 36 147 035 550

PROPOSED SHOPTOP HOUSING

1105-1107 BARRENJOEY ROAD, PALM BEACH

DECEMBER 2017

DRAWING TITLE: SHADOW DIAGRAM

21ST JUNE	(9AM-3PM)	
DRAWN BY: WT, CN	CHECKED BY: PB	
SCALE: NTS	DA621	ISSUE:
PROJECT NO: 1816	DAULI	

