

**SITE PLAN** 

LOT 19 - DP 222082 SITE AREA: 690.30m2

TRUE NORTH:



- NOTES:

  All structures including stormwater & drainage to engineer's details.

  Do not obtain dimensions by scaling drawings.

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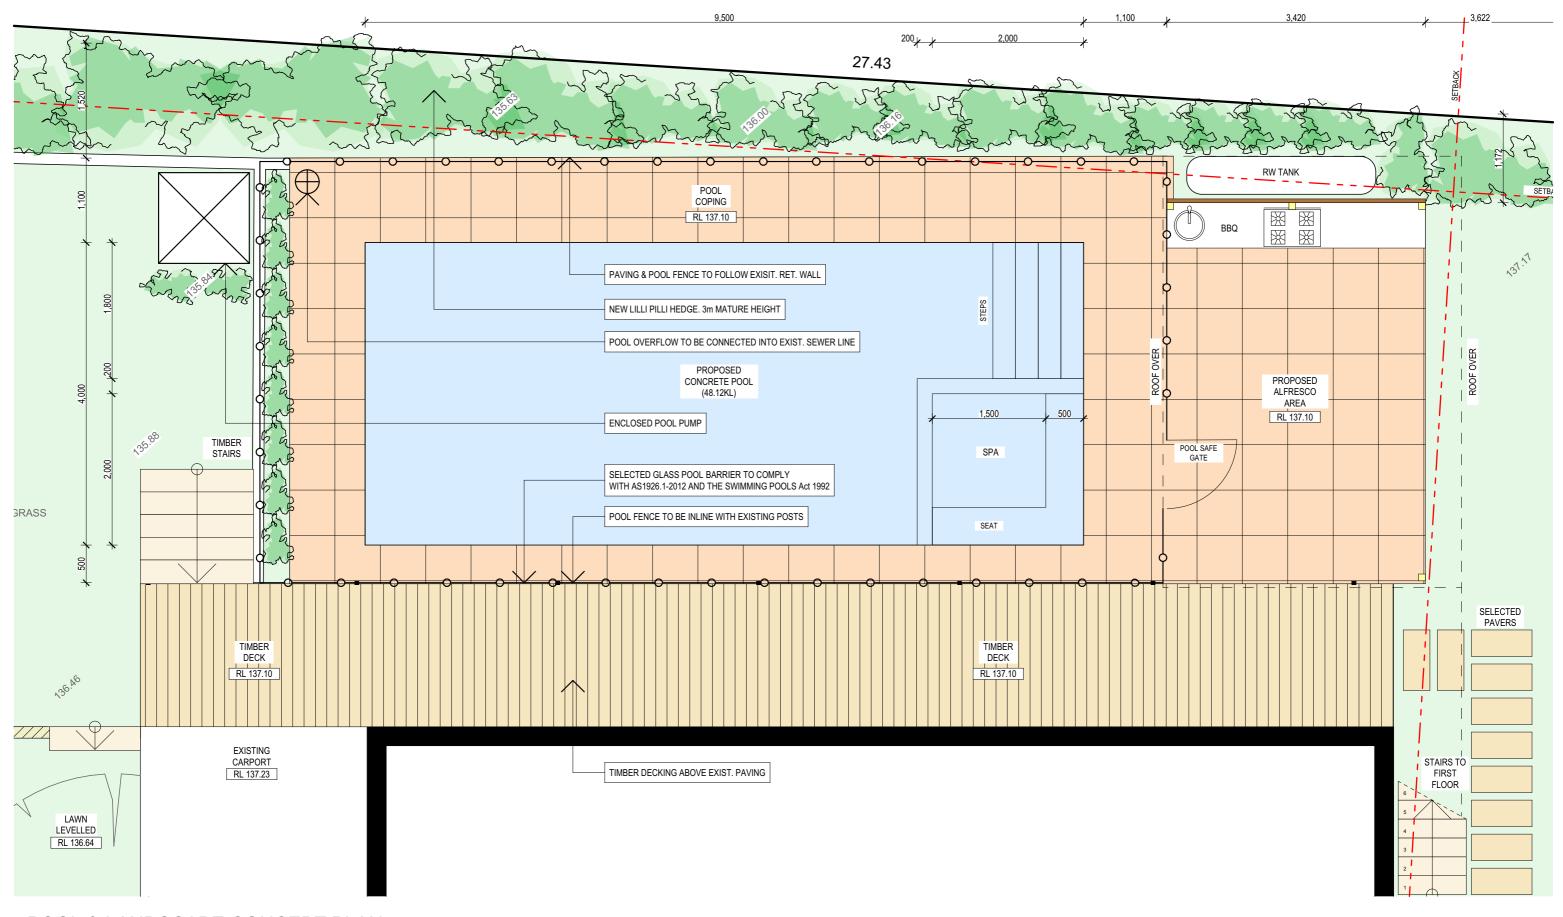
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PROJECT DETAILS: PROPOSED ALTERATIONS AND ADDITIONS 37 TERAMA ST, BILGOLA PLATEAU	DATE: JUNE 2019	DRAWN BY: AHB	SCALE: 1:200 @ A3
DRAWING TITLE: SITE ANALYSIS PLAN	JOB No: 718/19	CHECKED BY:	DRAWING No: DA.01



DESCRIPTION:

### **POOL & LANDSCAPE CONCEPT PLAN**



- NOTES:

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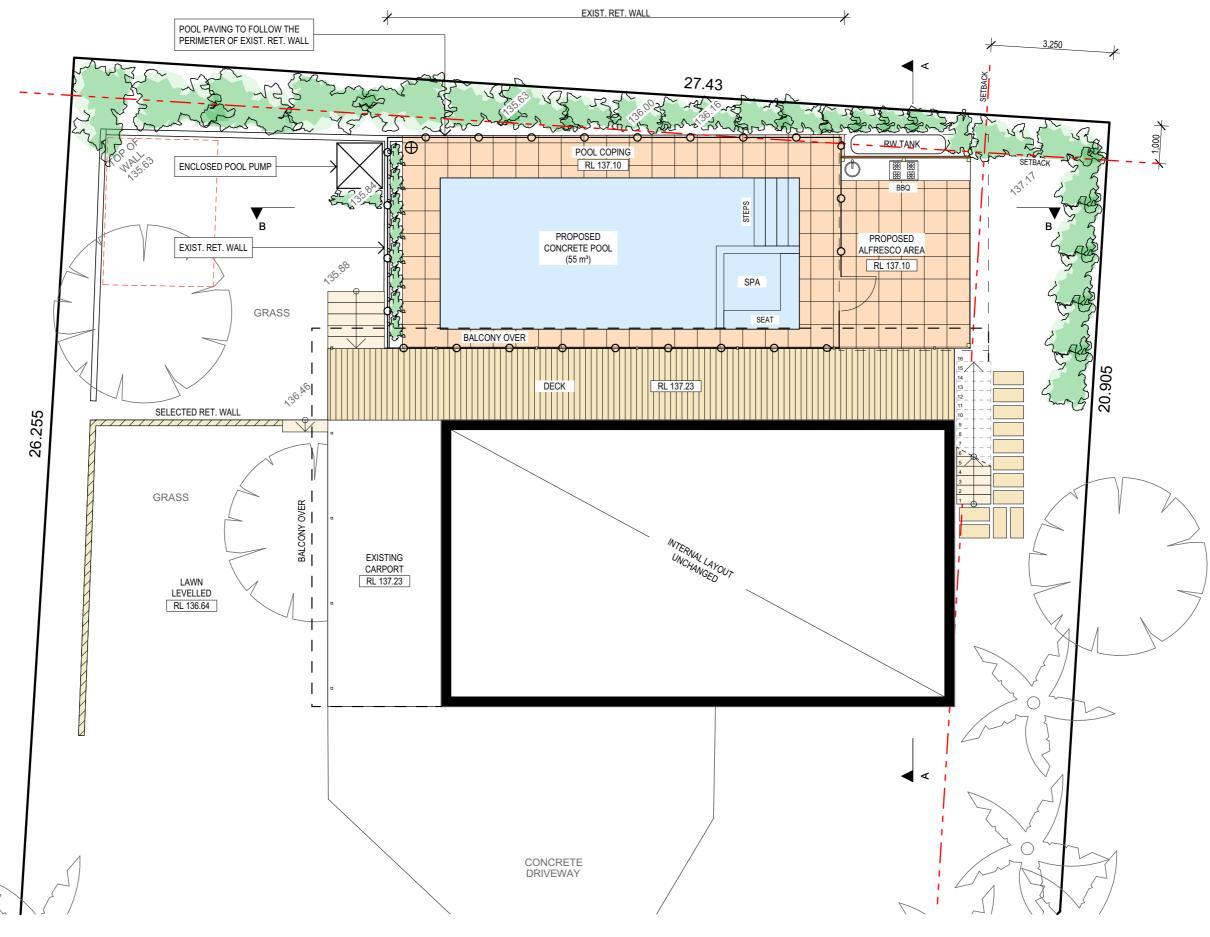
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PROJECT DETAILS: PROPOSED ALTERATIONS AND ADDITIONS 37 TERAMA ST, BILGOLA PLATEAU	DATE: JUNE 2019	DRAWN BY: AHB	1:50 @ A3
DRAWING TITLE: POOL & LANDSCAPE CONCEPT PLAN	JOB No: 718/19	CHECKED BY:	DRAWING No: DA.02



### **GROUND FLOOR PLAN**

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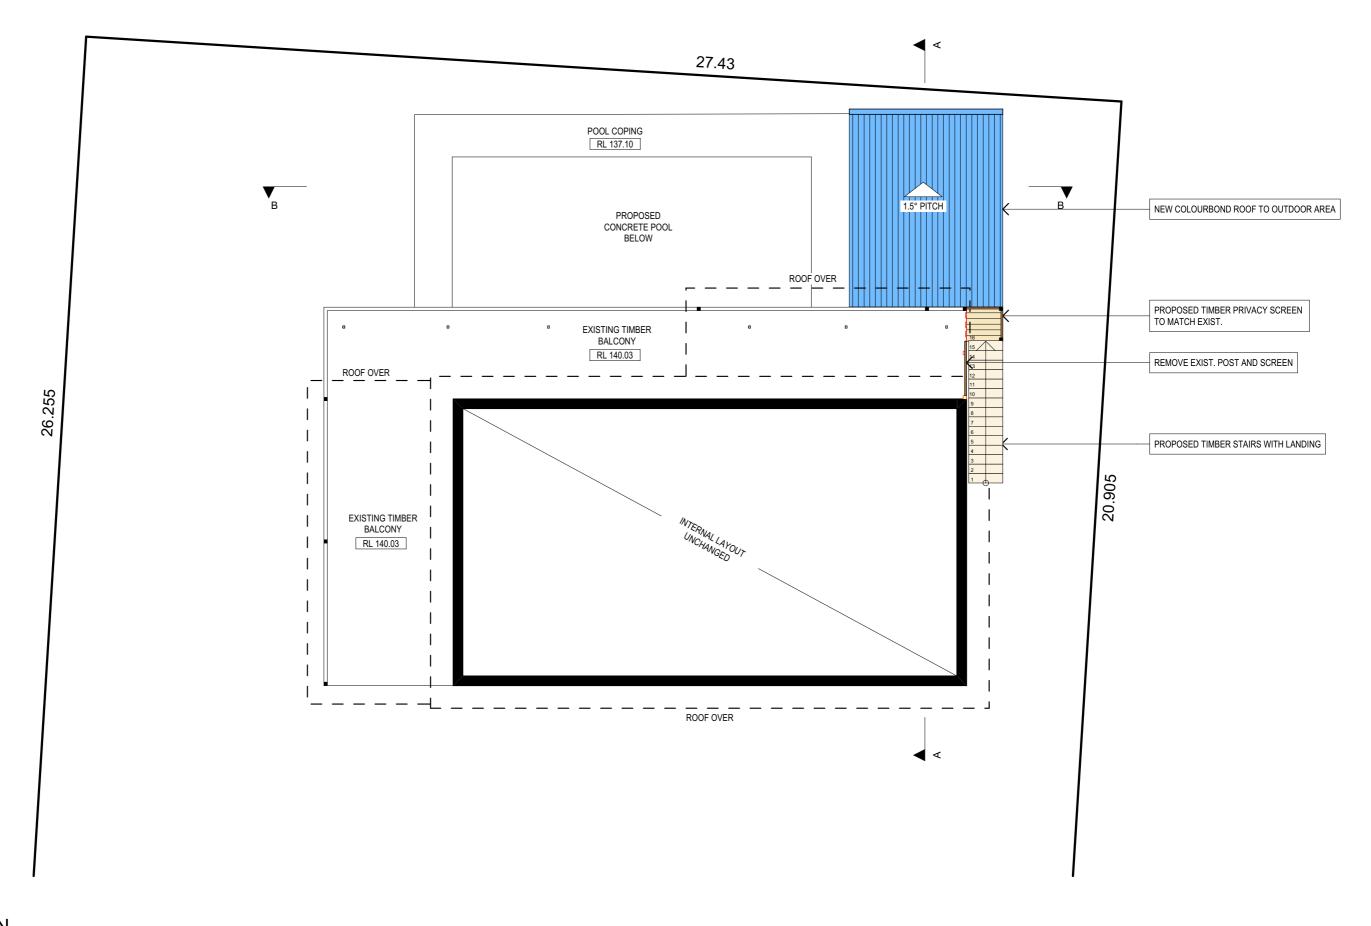
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PROJECT DETAILS: PROPOSED ALTERATIONS AND ADDITIONS 37 TERAMA ST, BILGOLA PLATEAU	DATE: JUNE 201	
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718/19	JJ	DA.03



### FIRST FLOOR PLAN

TRUE NORTH:



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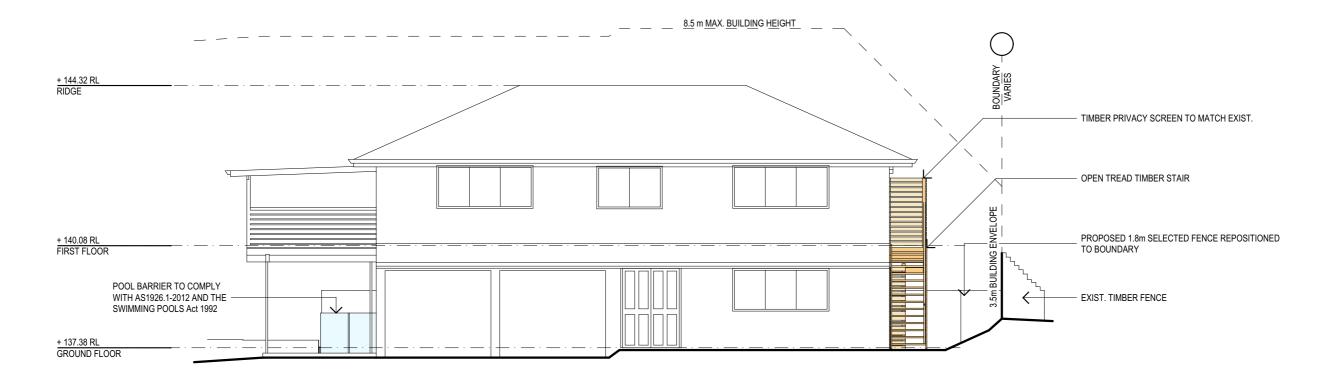
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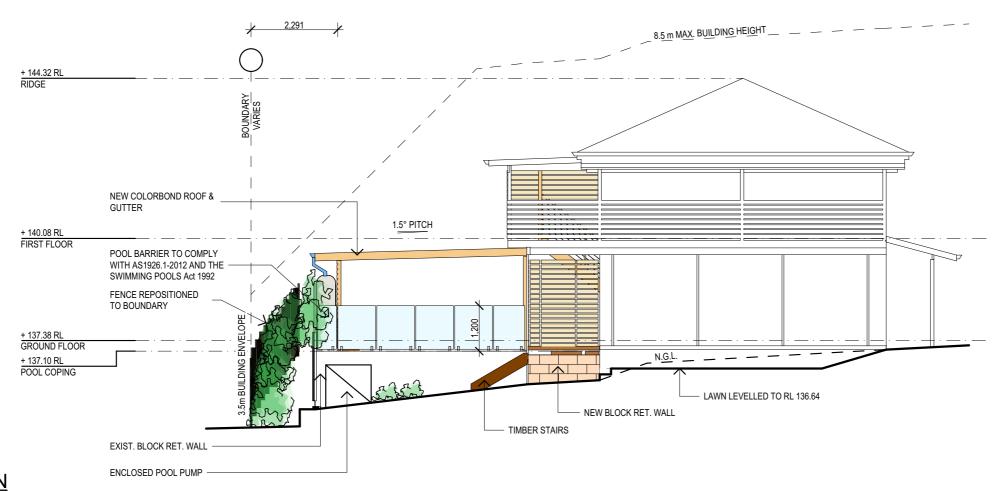
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PROJECT DETAILS:
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37 TERAMA ST, BILGOLA PLATEAU
DRAWING TITLE:
FIRST FLOOR PLAN

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	718/19	JJ	DA.04



### **SOUTH ELEVATION**



### WEST ELEVATION

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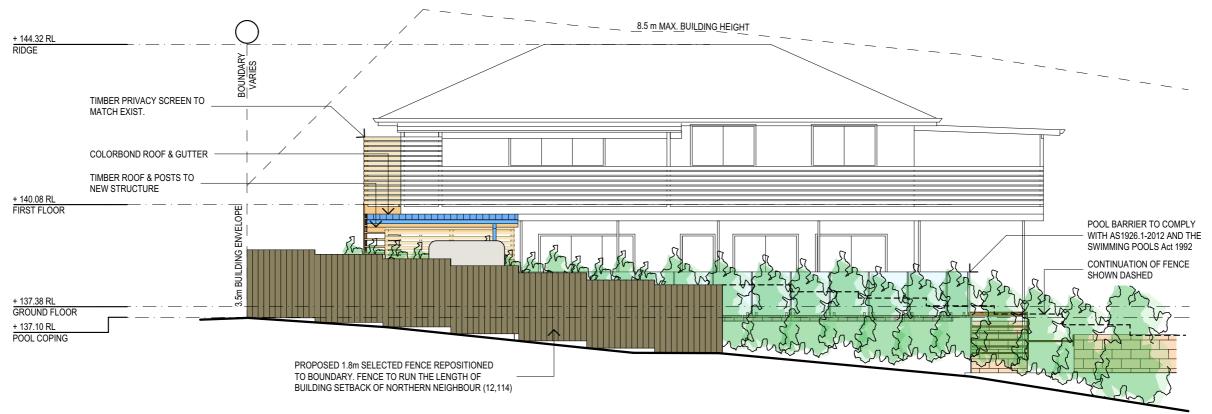
PROJECT DETAILS: PROPOSED ALTERATIONS AND ADDITIONS 37 TERAMA ST, BILGOLA PLATEAU	DATE: JUNE 2019	DRAWN BY:
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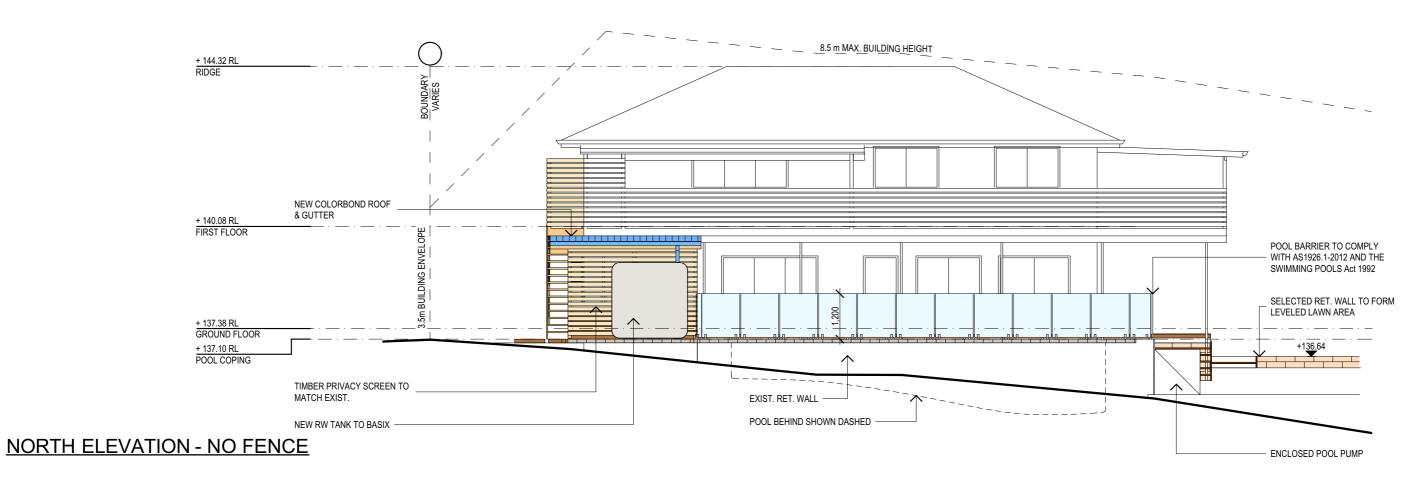
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### **NORTH ELEVATION**




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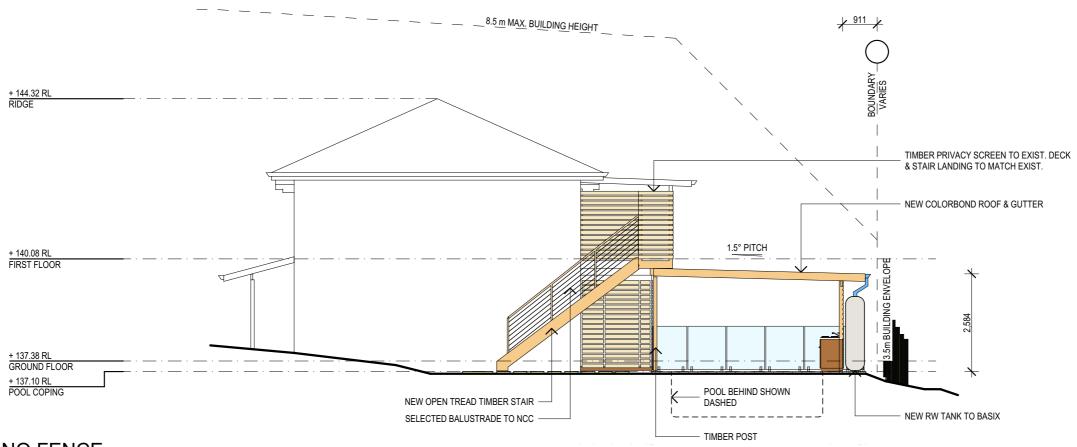
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PROJECT DETAILS: PROPOSED ALTERATIONS AND ADDITIONS 37 TERAMA ST, BILGOLA PLATEAU	DATE: JUNE 2019	DRAWN BY:	SCALE: 1:100 @ A3
DRAWING TITLE: ELEVATIONS	JOB No: 718/19	CHECKED BY:	DRAWING No: DA.06





### **EAST ELEVATION - TERAMA ST.**

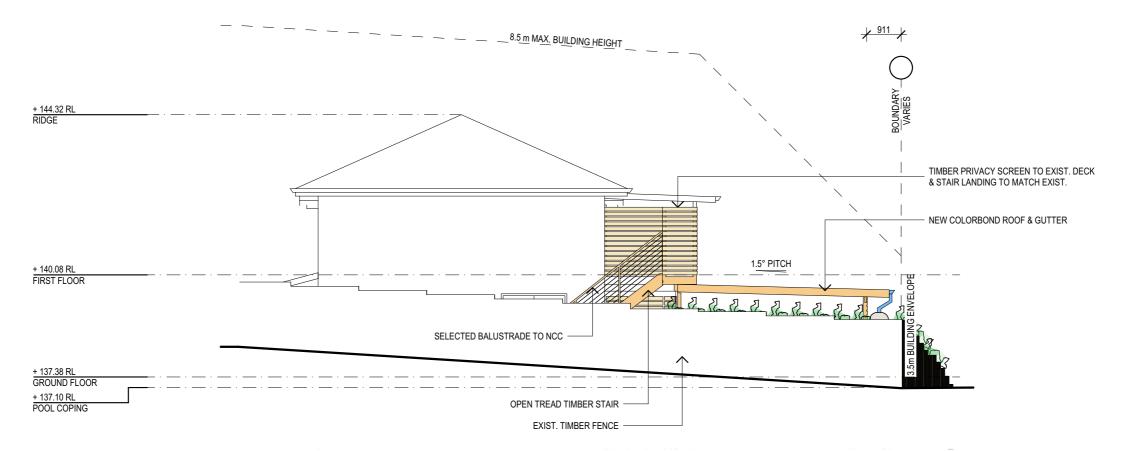

### **EAST ELEVATION - NO FENCE**

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### **BASIX REQUIREMENTS**

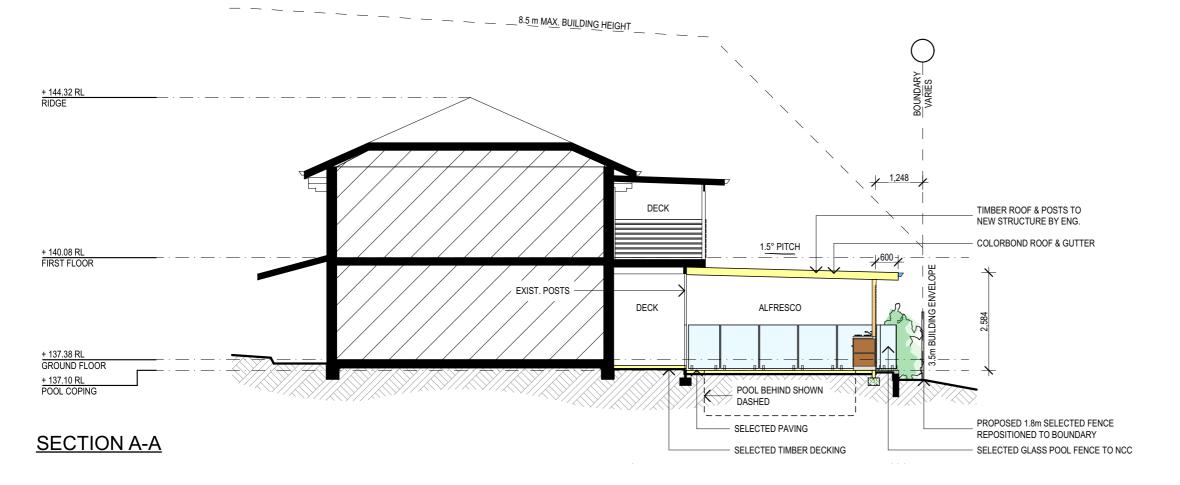37 TERAMA ST, BILGOLA PLATUEA
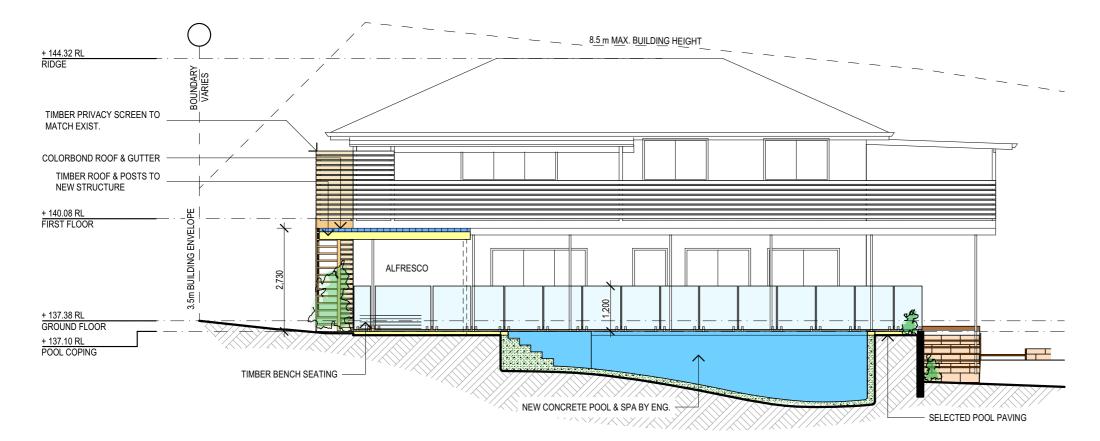
<u>POOL & SPA</u> - INSTALL A RAINWATER TANK OF AT LEAST 4943 LITRES ON SITE.

OUTDOOR SWIMMING POOL - SWIMMING POOL MUST NOT HAVE A CAPACITY GREATER THAN 48.12 KILOLITRES

OUTDOOR SPA MUST NOT HAVE A CAPACITY GREATER THAN 4 KILOLITRES

### **SECTION B-B**

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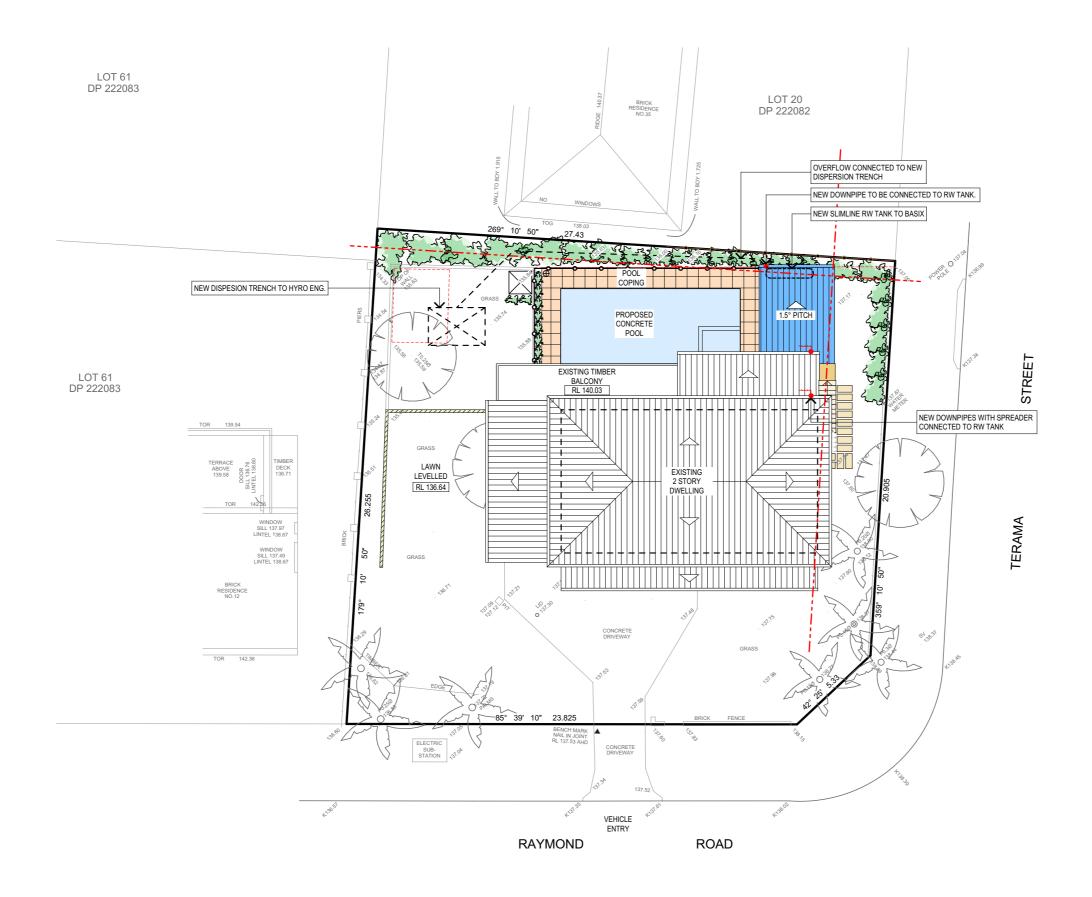
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PROJECT DETAILS: PROPOSED ALTERATIONS AND ADDITIONS 37 TERAMA ST, BILGOLA PLATEAU	DATE: JUNE 2019	DRAWN BY:	SCALE: 1:100 @ A3
DRAWING TITLE: SECTIONS	JOB No: 718/19	CHECKED BY:	DRAWING No: DA.08



### **ROOF & STORMWATER CONCEPT PLAN**

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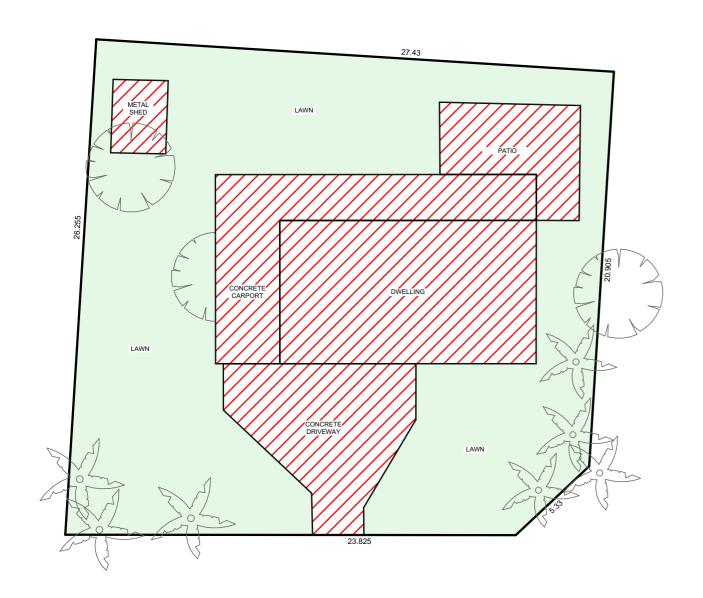
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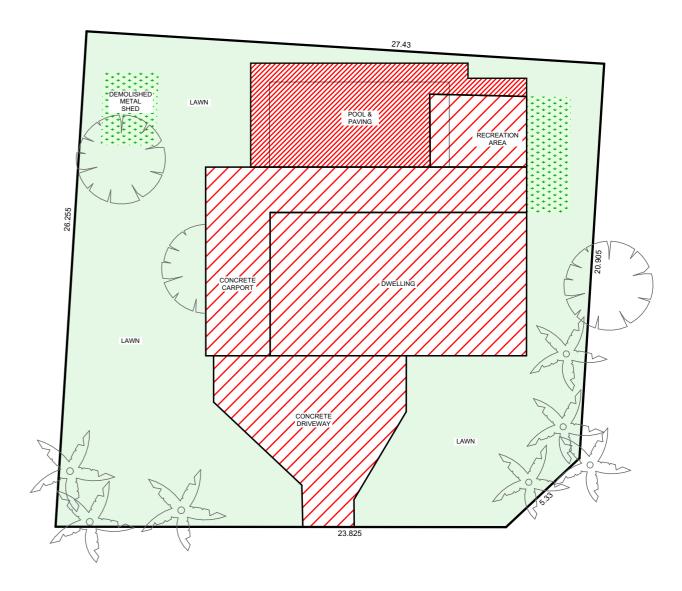
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DRAWING TITLE: ROOF & STORMWATER CONCEPT PLAN	JOB No: 718/19	CHECKED BY:	DRAWING No: DA.09





CALCULATIONS - EXISTI	NG		
SITE AREA			690.30 m <sup>2</sup>
LANDSCAPE CONTROL		MIN. 60%	414.18 m <sup>2</sup>
EXISTING LANDSCAPE AREA		60%	414.18 m <sup>2</sup>
EXISTING IMPERVIOUS AREA			276.12m <sup>2</sup>

CALCULATIONS - PROPO	<u>OSED</u>		
SITE AREA			690.30 m <sup>2</sup>
LANDSCAPE CONTROL		MIN. 60%	414.18 m <sup>2</sup>
HARD SURFACE REINSTATED TO LANDSCAPING	\ \ \ \ \ \ \ \ \ \ \ \ \ \ \ \ \ \ \		25.46 m <sup>2</sup>
PROPOSED LANDSCAPED AREA INCLUDING 6% OF SITE AREA TO OUTDOOR RECREATIONAL USE		61.76%	426.38 m <sup>2</sup>
NEW HARD SURFACE AREA			
IMPERVIOUS AREA TO REMAIN			301.58 m <sup>2</sup>

### LANDSCAPED CALCULATION PLAN



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REV:	DATE:	DESCRIPTION:	PROJECT DETAILS: PROPOSED ALTERATIONS AND ADDITIONS 37 TERAMA ST, BILGOLA PLATEAU
			DRAWING TITLE:  LANDSCAPE OPEN SPACE CALCULATION PLAN

ROJECT DETAILS: PROPOSED ALTERATIONS AND ADDITIONS 37 TERAMA ST, BILGOLA PLATEAU	DATE: JUNE 2019	DRAWN BY:	SCALE: 1:200 @ A3
RAWING TITLE: LANDSCAPE OPEN SPACE CALCULATION PLAN	JOB No: 718/19	CHECKED BY:	DRAWING No:

### Designated Site Manager/Builder

PRIOR TO COMMENCEMENT OF WORK A SITE MANAGER OR BUILDER MUST BE NOMINATED. THE SITE MANAGER OR BUILDER WILL BE RESPONSIBLE AND LIABLE FOR ALL WORKS CARRIED OUT ON THE SITE. THIS ASSUMES THE RESONSIBILITY FOR THE ACTIONS OF ALL SUBCONTRACTED PARTIES AS WELL AS ADVISING THEM OF COUNCIL'S REQUIREMENTS WHEN CARRYING OUT WORKS.

### Topsoil Management

PRIOR TO THE STRIPPING OF TOPSOIL, THE VEGETATIVE COVER MUST BE REDUECED BY EITHER SLASHING OR MOWING ALL TOPSOIL IS TO BE RETAINED AND PROTECTED FOR REUSE ON SITE. SOIL STOCKPILES MUST NOT BE LOCATED ON NATURE STRIPS, FOOTPATHS, ROADWAYS, KERBS, ACCESSWAYS, WITHIN DRAINAGE LINES/FLOWS/PATHS OR AROUND OR AGAINST TREE SHRUBS.

SEDIMENT CONTROL MEASURES MUST BE INCORPORATED WITH ANY RESULTING STOCKPILE. THE STOCKPILE CAN BE PROTECTED FROM EROSION BY COVERING IT WITH AN IMPERVIOUS MATERIAL. IN CONJUNCTION WITH THE INSTALLATION OF A SEDIMENT FENCE AROUND IT.

IF STOCKPILES ARE TO REMAIN FOR MORE THAN ONE MONTH THEY ARE TO BE GRASSED IMMEDIATELY AND STABILISED WITHIN FOURTEEN DAYS. SURPLUS TOPSOIL MUST BE REASONABLY REMOVED FROM SITE.

### **Builidng Material Stockpiling**

SUFFICIENT AREA MUST BE ALLOCATED WITHIN THE SITE FOR SUCH STORAGE OF BUILDING MATERIALS, DEMOLITION WASTE, WASTE CONTAINERS, ETC. AS WILL BE REQUIRED

### Sediment Fences

A SEDIMENT FENCE SHOULD BE LOCATED ALONG THE DOWNSLOPE BOUNDARY(S)OF THE SITE. ON THE CONSTRUCTION SIDE OF THE TURF FILTER STRIP OR NATIVE VEGETATION. AND AROUND ALL STOCKPILES OF MATERIAL ON THE SITE

### **Dust Control**

ALL TRUCKS/UTES MUST COVER THEIR LOADS AT ALL TIMES. APPROPRIATE METHODS ARE TO BE EMPLOYED TO PREVENT BLOWING DUST CREATING AN UNACCEPTABLE HAZARD OR NUISANCE ON THE SITE OR DOWN WIND. PRODUCTION OF DUST CAN BE MINIMISED BY LIMITING AREA OF EARTHWORKS, WATERING AND PROGRESSIVE VEGETATION. WHERE DUST IS CREATED AS A RESULT WORKS AND/OR SOIL EXPOSURE, THE BARE SOIL AREAS MUST BE WATERED, DURING AND/OR AT THE END OF EACH DAY TO LAY THE DUST

EARTH MOVONG ACTIVITIES SHOULD BE AVOIDED WHERE WINDS ARE SUFFICIENTLY STRONG ENOUGH TO RAISE VISIBLE DUST.

### **Erosion & Sediment Controls**

APPROPRIATE EROSION AND SEDIMENT CONTROLS MUST BE IMPLEMENTED ON ALL SITES THAT INVOLVE SOIL DISTURBANCE. THE MEASURES MUST BE IN PLACE PRIOR TO THE COMMENCEMENT OF WORK

THOSE CONTROLS ARE TO BE MONITORED AND MAINTAINED IN ORDER TO SERVE THEIR INTENDED FUNCTION FOR THE DURATION OF THW WORKS OR UNTIL SUCH TIME AS THE SITE IS FULLY STABILISED. IF ANY CONTROLS ARE DAMAGED OR BECOME INFEFECTIVE DURING THE COURSE OF THE WORKS THEY ARE TO BE REINSTATED OR REPLACED IMMEDIATELY. SUFFICIENT ACCESS TO THESE CONTROLS MUST BE PROVIDED IN CASE OF THE NEED TO REPAIR.

### Sediment Traps


WHERE A SEDIMENT FENCE IS NOT USED APPROPRIATE SEDIMENT TRAPS SHOULD BE LOCATED AT ALL POINTS WHERE STORMWATER LEAVES THE CONSTRUCTION SITE OR LEAVES THE GUTTER AND ENTERS THE DRAINAGE SYSTEM. A COMMON TECHNIQUE IS THE GRAVEL SAUSAGE.

### **Diversion Channels**

A DIVERSION CHANNEL IS AN EXCAVATED EARTH DITCH OR PATH. THESE STRUCTURES AREE USED TO INTERCEPT AND DIRECT RUN-OFF TO A DESIRED LOCATION WHERE POSSIBLE.

ALL STORMWATER RUN-OFF FLOWING ONTO DISTURBED AREAS, INCLUDING STOCKPILES, MUST BE INTERCEPTED, DIVERTED AND/OR SAFELY DISPOSED OF. THIS CAN BE ACHIVED BY CONSTRUCTING A TEMPORARY EARTH BANK AROUND THE UPSLOPE EXTENT OF THE CONSTRUCTION SITE WHERE THE DIVERSION DOES NOT AFFECT THE NEIGHBOURING PROPERTIES.




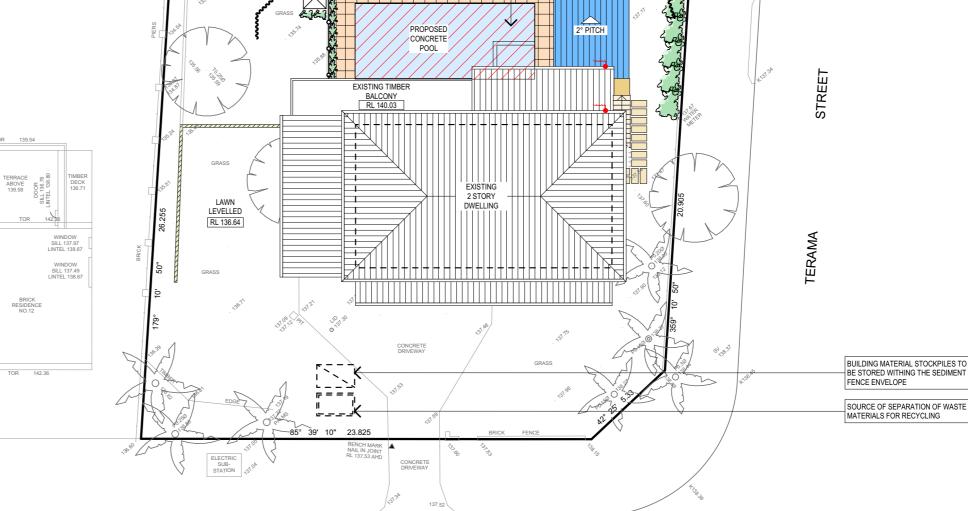

**ROAD** 

### **EROSION & SEDIMENT CONTROL / WASTE MANAGEMENT PLAN**

**RAYMOND** 

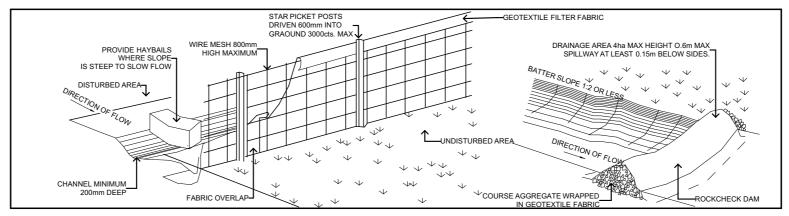

VEHICLE

TYPICAL SEDIMENT FENCE

TYPICAL DIVERSION CHANNEL

### Vehicle Movements

AREA TO BE EXCAVATED SHOWN

SEDIMENT CONTROL BARRIER

TO LIMIT DISTURBANCE TO THE SITE AND TRACKING OF MATERIAL ONTO THE STREET ALL VEHICLES AND PLANT FOLIPMENT ARE TO USE A SINGLE ENTRY/EXIT POINT UNLESS COUMCIL HAS APPROVED ALTERNATIVE ARRANGEMENTS.

ACCESS POINTS AND APRKING AREAS ARE TO BE STABILISED WITH

COMPACTED SUB-GRADE AS SOON AS POSSIBLE AFTER THEIR FORMATION. WHERE SPILLAGE DOES OCCUR IT IS TO BE CONTAINED IMMEDIATELY AND CAREFULLY REMOVED. THE AREA AFFECTED IS TO BE RESTORED TO A STANDARD EQUAL TO OR BETTER THAN ITS PREVIOUS CONDITION. ALL VEHICLES ARE TO BE WASHED PRIOR TO EXISTING THE SITE. THIS SERVES THE PURPOSE OF REMOVING SITE MATERIAL ON THE VEHICLE AND PREVENTS IT FROM BEING DEPOSITED ON THE ROAD NETWORK ADJACENT TO THE SITE AND THUS, THE STORWATER SYSTEM. ALL POLLUTED WATER MUST BE RETAINED ON SITE FOR TREATMENT BEFORE IT IS DISCHARGED

INTO THE STORMWATER SYSTEM. NO VEHICLE ASSOCIATED WITH THE WORK IS TO BE PARKED ON A FOOTPATH

ALL VEHILCES VISITING THE SITE DURING DEMOLITION, EXCAVATION AND/OR CONSTRUCTION WORKS, ARE TO COMPLY WITH THE PARKING REQUIREMENTS

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PROJECT DETAILS: PROPOSED ALTERATIONS AND ADDITIONS 37 TERAMA ST, BILGOLA PLATEAU	DATE: JUNE 2019	DRAWN BY:
PRAWING TITLE: EROSION & SEDIMENT CONTROL / WASTE MANAGEMENT PLAN	JOB No: 718/19	CHECKED BY:



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PROJECT DETAILS: PROPOSED ALTERATIONS AND ADDITIONS 37 TERAMA ST, BILGOLA PLATEAU	DATE: JUNE 2019	DRAWN BY: AHB	SCALE: 1:200 @ A3
DRAWING TITLE: SHADOWS JUNE 21 9am	JOB No: 718/19	CHECKED BY:	DRAWING No: DA.12



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DRAWING TITLE: SHADOWS JUNE 21 12pm	JOB No: 718/19	CHECKED BY:	DRAWING No: DA.13



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DESCRIPTION:

PROJECT DETAILS: PROPOSED ALTERATIONS AND ADDITIONS 37 TERAMA ST, BILGOLA PLATEAU	DATE: JUNE 2019	DRAWN BY:	SCALE: 1:200 @ A3
DRAWING TITLE: SHADOWS JUNE 21 3pm	JOB No: 718/19	CHECKED BY:	DRAWING No: DA.14