

Hammond Residence



d	drawing list					
00	Coversheet					
01	Perspectives					
02	Site Context Plan					
03	Site Plan					
04	SWMP					
05	Floor Plan					
06	Elevations					
07	Roof Plan					
08	Sections 1-1					
09	Modular Construction Plan					
10	Shadows					
11	Notification Plan					







1114 Bass Highway, The Gurdies VIC P.O. Box 222, Grantville VIC 3984

Ph: 03 5672 5196

Project: Proposed Moveable Dwelling

Address: Lot 1, 47 Woodbine Street North Balgowlah, NSW, 2093

Mitchell & Rebekah Hammond



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Development Approval Perspectives

Drawn By: SW Scale: 1:1 @ A3

Job No: 22-02

Project Inclusions: EcoLiving


Issue: DA₁ Drawing No:

site details

345.80m² site area



EILEEN STREET

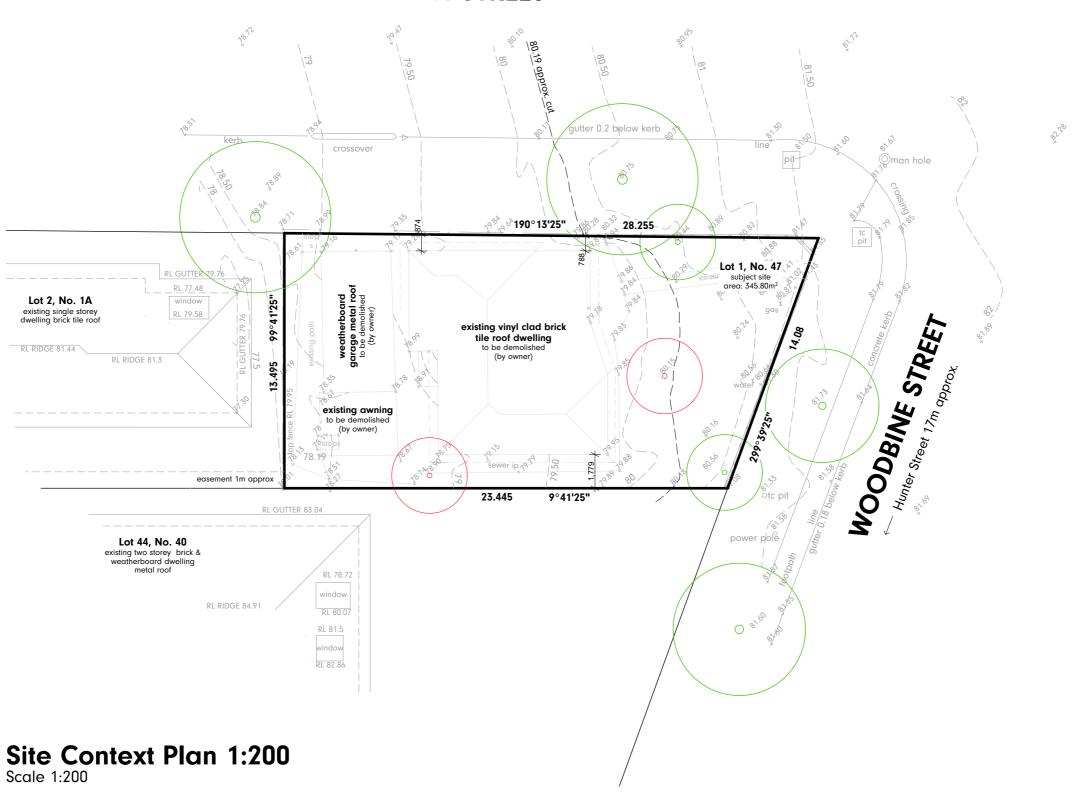



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Drawn By: SW Scale: 1:200 @ A3

Job No: 22-02 Project Inclusions: EcoLiving

Issue: DA₁ Drawing No:

site details

345.80m²

legend

temporary bench

natural surface

downpipe

rainwater head

spreader

box gutter min.

power pole


existing vegetation

existing vegetation

300mm wide



EILEEN STREET

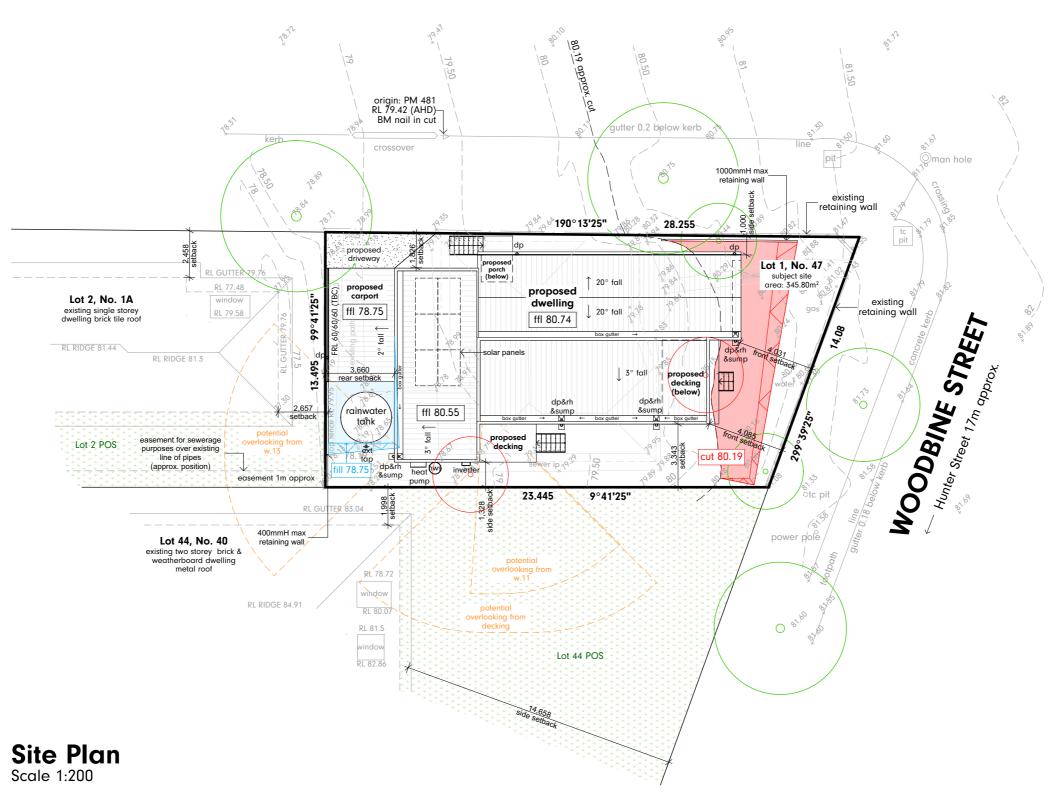

development schedule				
m2				
ground floor	147.38			
decking	23.18			
carport	21.00			
	191.56 m²			



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Development Approval Site Plan

Scale: 1:200 @ A3 Drawn By: SW


Job No: 22-02 Project Inclusions: EcoLiving DA₁ Drawing No: 03

stormwater management


All roof & hardstand captured stormwater to be plumbed and directed to a 10,000L Rain Water Tank with overflow from tank to be disposed of onsite by way of an 'absorption trench' system. Absorption trench area shown with blue hatch (minimum 3m offset from boundaries and dwelling)

geotextile sediment fence

- 1. Construct sediment fences as close as possible to follow the contours of the site.
- 2. Drive 1.5 metre long posts into round, maximum 3 metres apart.
- Staple to 40 mm square hardwood posts or wire tied to steel posts.
- 4. Dig a 150 mm deep trench along the up-slope line of the fence for the bottom of the fabric to be
- 5. Backfill trench over base of fabric and compact on both sides.

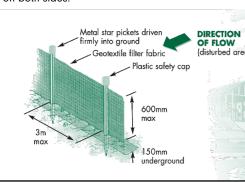


site details					
site area	345.80m ²				

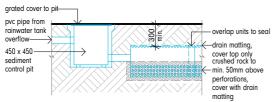


Section a

Section b Scale 1:50



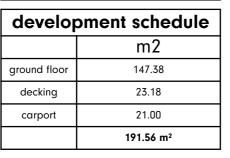

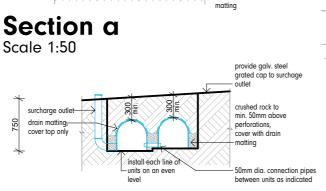


50mm dia. connection pipes between units as indicated reln jumbo trench drain units,

overlap adioinina units to sea

utter 0.2 below kerb location of geotexile sediment fence as required [▶]190°13'25" 28.255 Lot 1, No. 47 subject site area: 345.80m² Lot 2, No. 1A WOODBINE STREET existing single storey dwelling brick tile roof 23.445 9°41'25" RL GUTTER 83.04 Lot 44, No. 40 absorbtion trench existing two storey brick & weatherboard dwelling location&design TBC RL 78.72 RL 80.07 0 8/1/0 RL 81.5 RL 82.86 cap to ends

EILEEN STREET

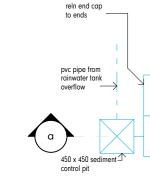

Plan View Scale 1:50



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Mitchell & Rebekah Hammond



SWMP 1:200

Scale 1:200

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Scale: 1:200, 1:50 @ A3 Date: 12/08/2022

Job No: 22-02 Project Inclusions: EcoLiving DA₁ Drawing No: 04

legend wm - washing machine

dr - dryer

b - bath

hp - hot plate

s - smoke detector

ref - refridgerator

s - stainless steel sink

sdu - sliding door unit - cavity slider

CS fows - face of wall slider vb - vanity basin

wash basin shr shower


- laundary trough - dishwasher dp/rh - downpipe with

ubo - under bench oven

fw - floor waste ss - split system rainhead

Taninous							
glazing schedule							
mark	height x wid		width	window style			
1	2,100	х	920	external hinged			
2	1,800	х	600	awning			
3	600	х	2,100	awning			
4	600	х	2,100	fixed			
5	1,500	х	2,100	awning			
6	2,100	х	2,700	sliding stacker door			
7	2,100	х	2,700	sliding stacker door			
8	1,800	х	600	awning			
9	1,800	х	600	awning			
10	2,100	х	920	external hinged			
11	2,100	х	1,800	sliding door			
12	1,800	х	600	awning			
13	400	х	1,600	fixed			
14	1,800	х	600	awning			
15	1,800	х	600	awning			

door schedule							
mark	height	х	width	door style			
1	2,100	х	820	face slider			
2	2,100	х	820	internal hinged			
3	2,100	х	820	internal hinged			
4	2,100	х	820	face slider			
5	2,100	х	820	internal hinged			
6	2,340		2,920	3 panel robe doors			
7	2,100	х	820	internal hinged			
8	2,340		2,920	3 panel robe doors			
9	2,100	х	820	internal hinged			
10	2,340		2,920	3 panel robe doors			

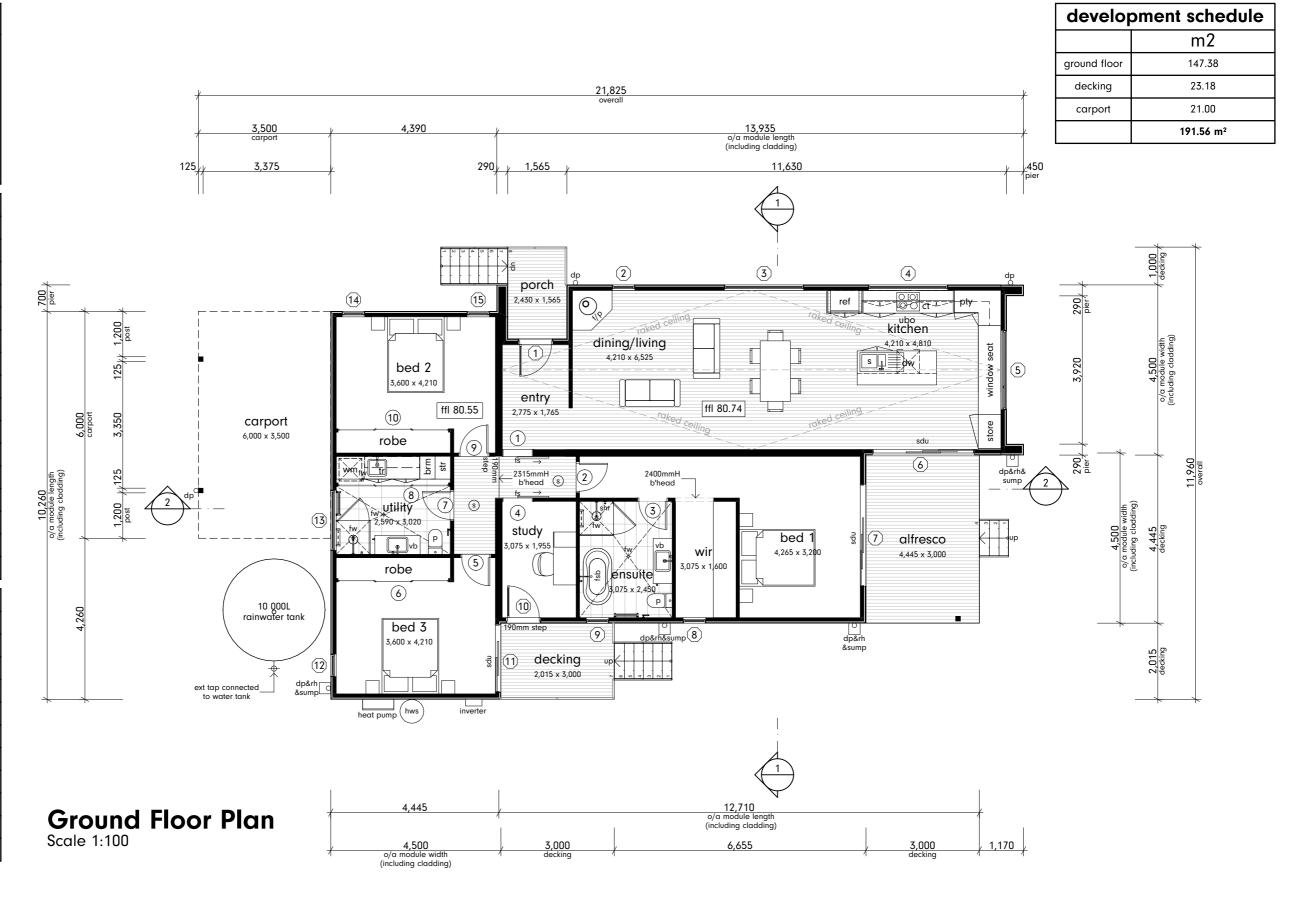



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Scale: 1:100 @ A3 Drawn By: SW

Job No: 22-02

DA₁ Drawing No:

Project Inclusions: EcoLiving

05



1. wall cladding: Weathertex Smooth 150mm Colour: Night Sky

Feature timber cladding Colour: Silvertop Ash 2. wall cladding:

3. Windows: Colour: Black

4. Roofing: Trimdek Colour: Night Sky

5. Capping, Flashings Colour: Night Sky Downpipes &

Rainwater Heads:

6. Decking: Silvertop Ash

7. Balustrade: Steel balustrade & handrail


Colour: Black







Silvertop Ash

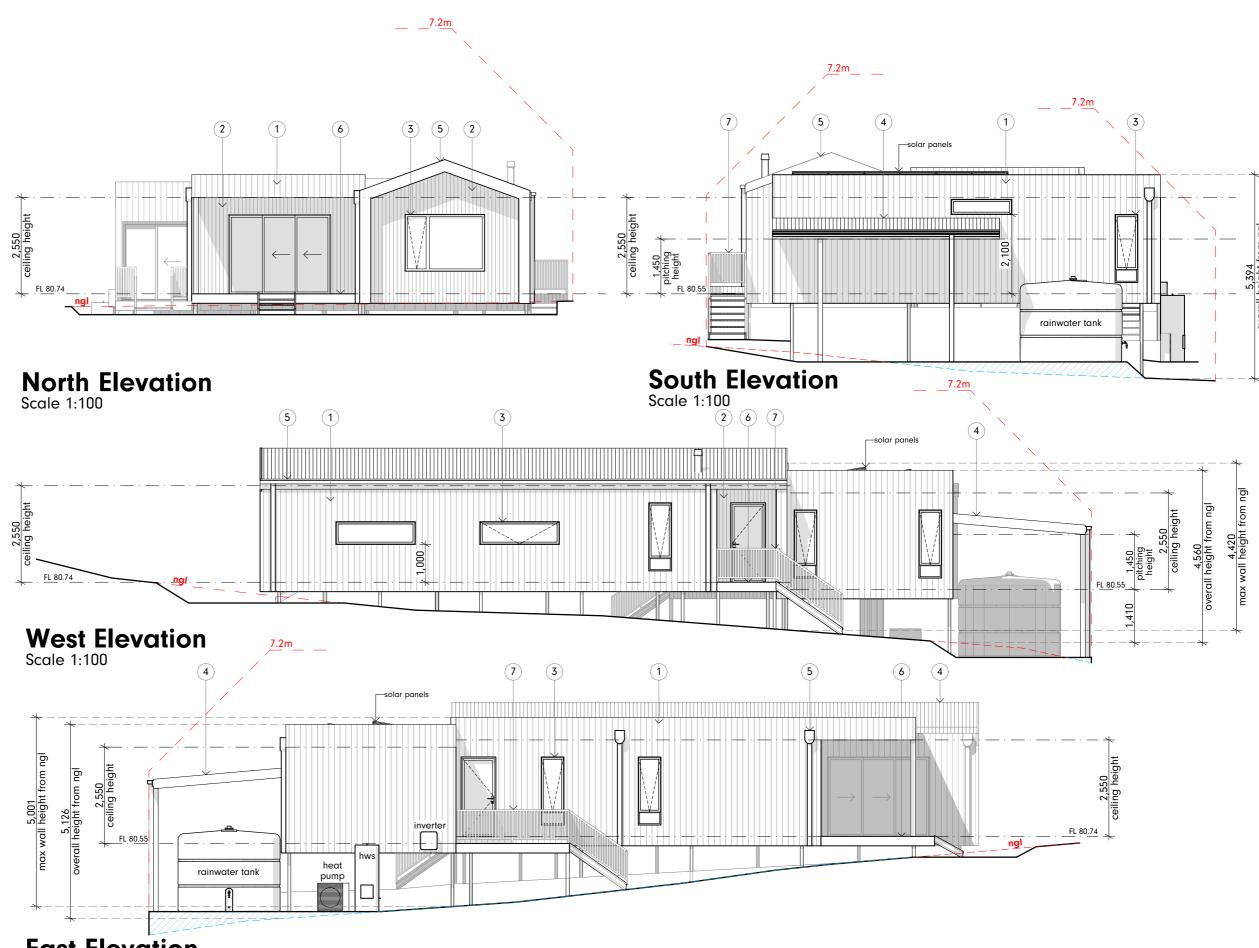

East Elevation

Scale 1:100

ECOLIV

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Development Approval Elevations

Scale: 1:100 @ A3 Drawn By: SW

Job No: 22-02 Project Inclusions: EcoLiving DA₁ Drawing No: 06

roof & stormwater notes

MATERIALS:

Refer to materials schedule on page 05.

METAL ROOFING:


Metal sheet roofing must be protected from corrosion in accordance with table 3.5.1.1a in accordance with AS1397.

All stormwater overflow to be taken to the legal point of discharge to the relevant authorities approval. Gutters and downpipes shall be installed in accordance with National Construction Code Series 2019 Building Code of Australia Volume 2 Part3.5.2 2019. 90 Class 6 UPVC stormwater line laid to a minimum grade of 1:100 and connected to the legal point of stormwater discharge. Provide inspection openings at 9000MM c/c and at each change of direction.

The cover to underground stormwater drains shall be not less than:

- 100mm under soil
- 50mm under concrete or paved areas
- 100mm under unreinforced concrete or paved driveways.
- · 75mm under riinforced concrete or paved driveways.

All downpipes to be connected to the Legal Point of Discharge as determined by the Responsible Authority.

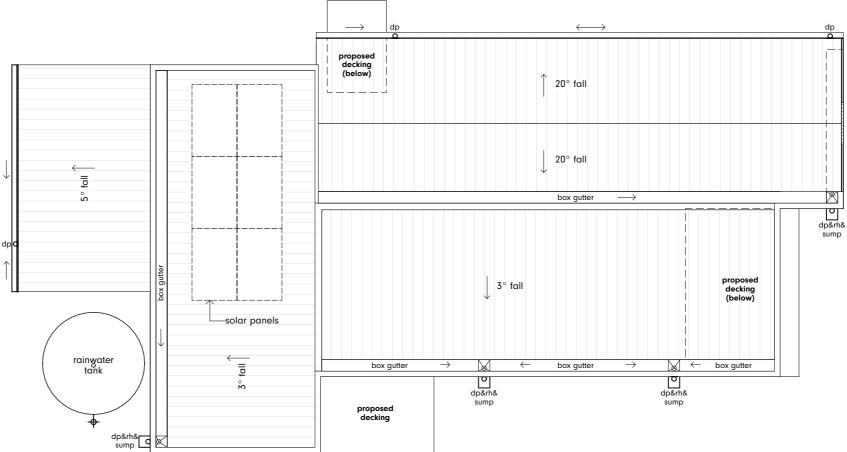

Roof Plan Scale 1:100



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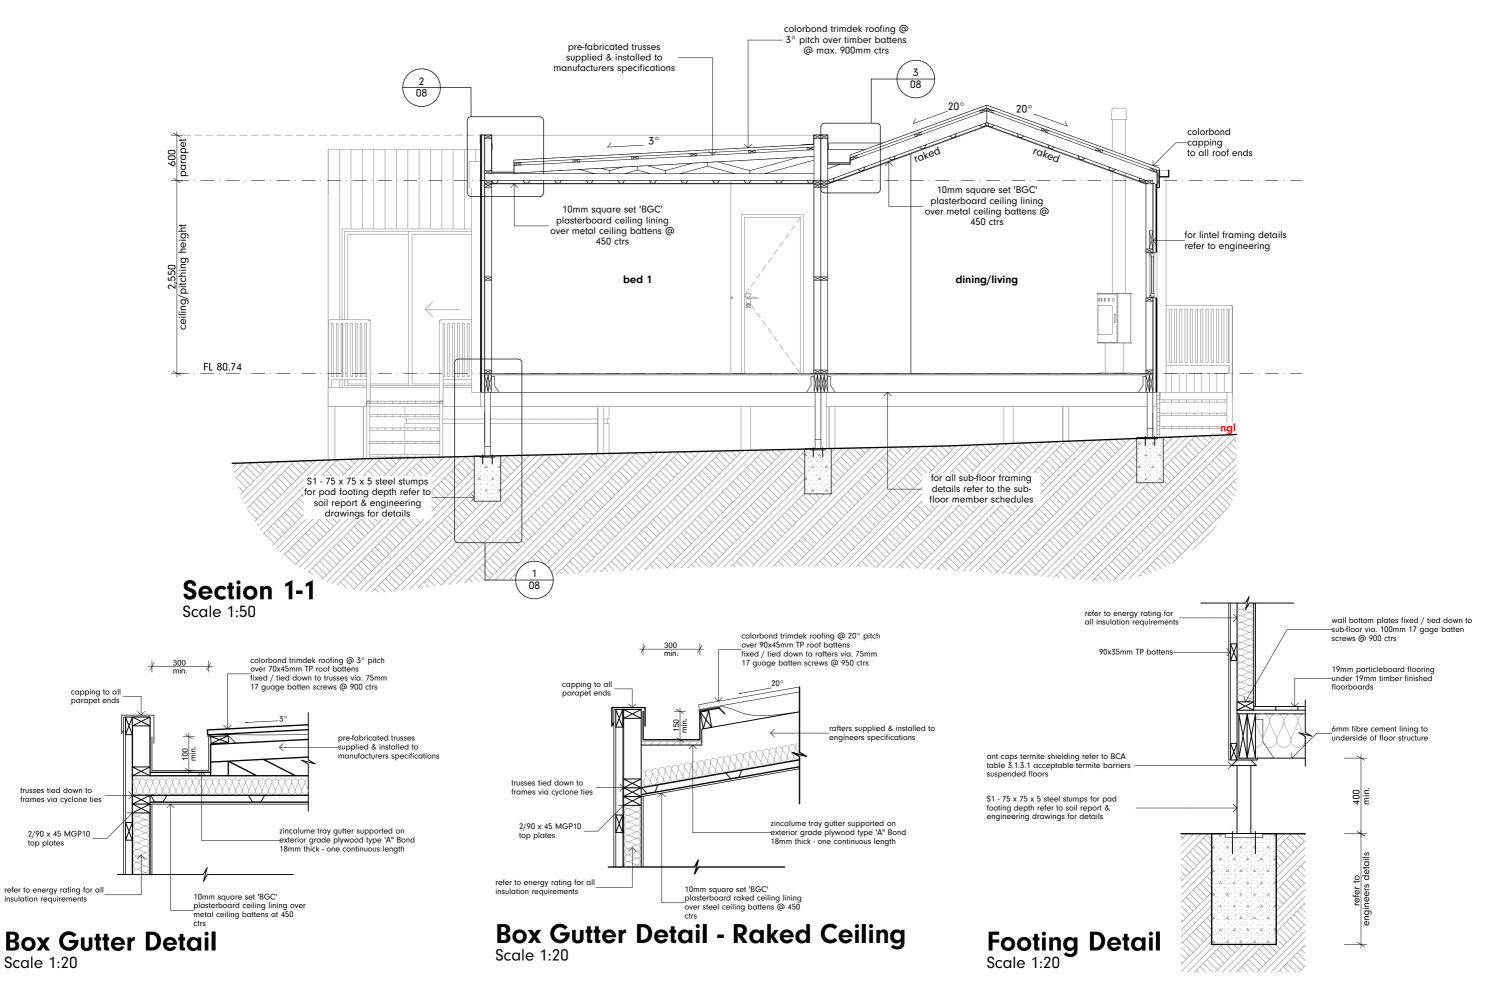
Job No: 22-02

Scale: 1:100 @ A3

Drawn By: SW

Issue: DA₁ Drawing No:

Project Inclusions: EcoLiving





trusses tied down to

2/90 x 45 MGP10

top plates

Scale 1:20

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Scale: 1:50, 1:20 @ A3

Job No: 22-02 Project Inclusions: EcoLiving

DA₁ Drawing No:


Issue:

note

All external steps are pre-fabricated with galvanised steel stringers & hardiedeck treads.

legend

= joins in decking for transportation

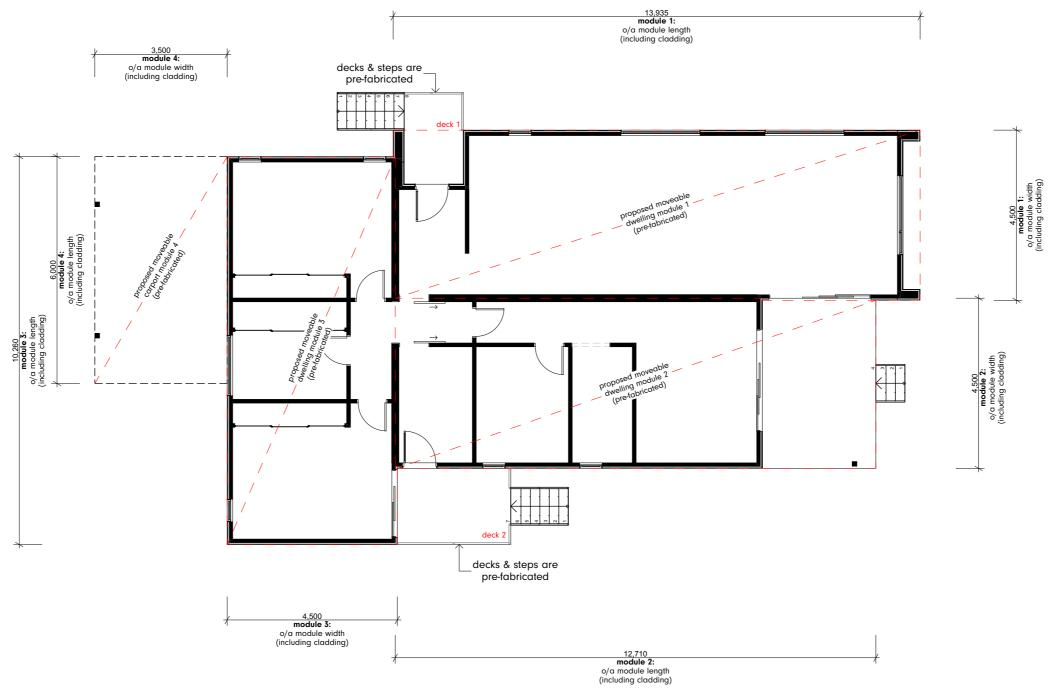

Modular Construction Plan

Scale 1:100



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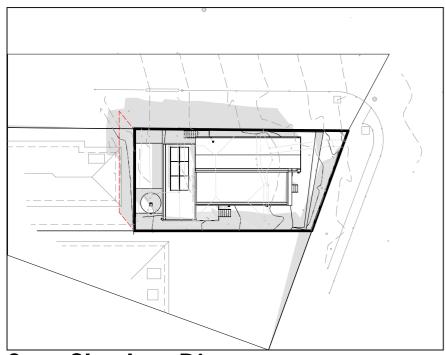
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Development Approval Modular Construction Plan


Drawn By: SW Scale: 1:100 @ A3

Job No: 22-02 Project Inclusions: EcoLiving


Issue: DA₁ Drawing No:



9am Shadow Diagram Scale 1:500

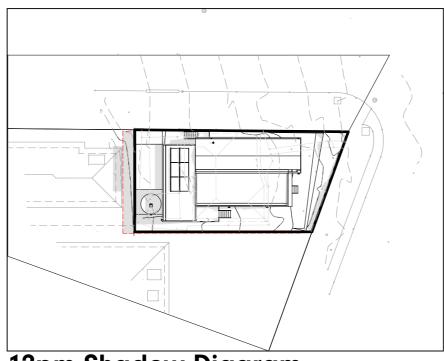

12pm Shadow Diagram
Scale 1:500

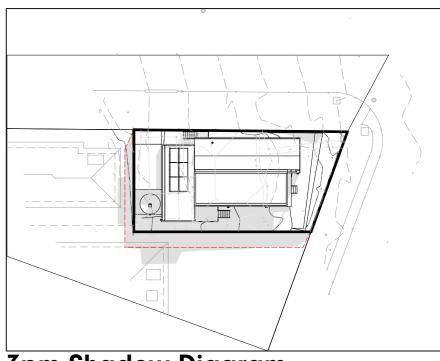

3pm Shadow Diagram Scale 1:500



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Ph: 03 5672 5196

Project: Proposed Moveable Dwelling

Address: Lot 1, 47 Woodbine Street North Balgowlah, NSW, 2093

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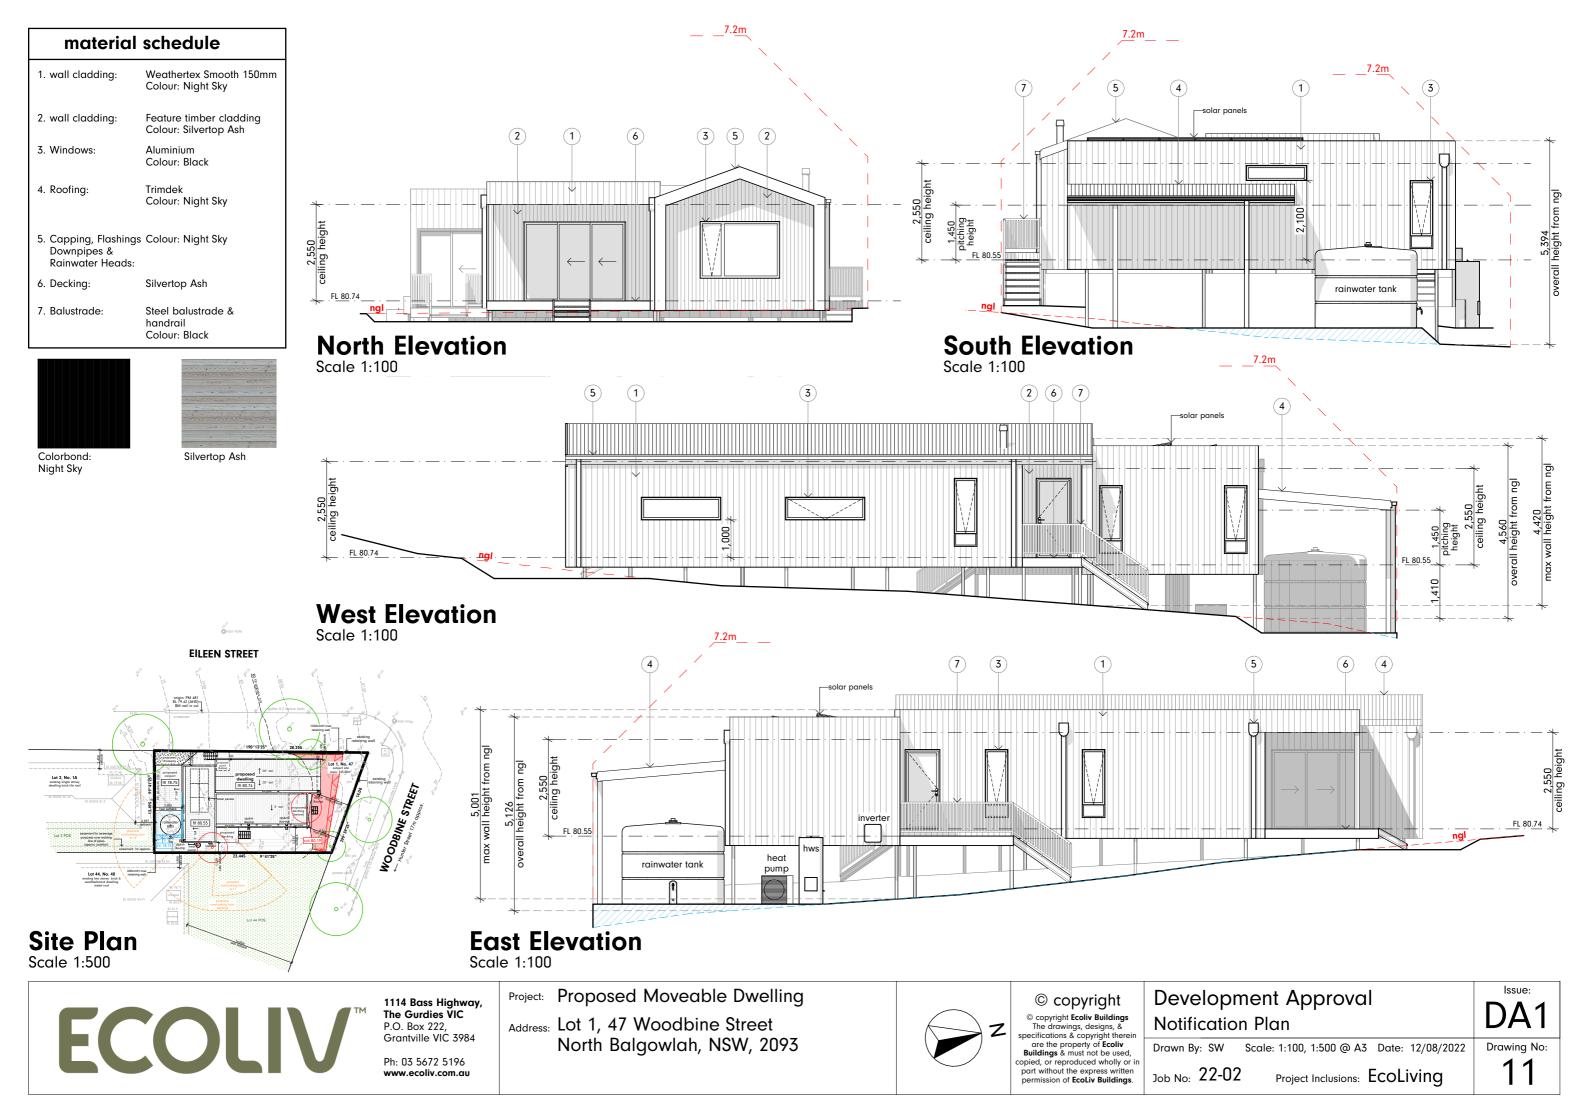
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Drawn By: SW Scale: 1:500 @ A3

Date: 12/08/2022

Job No: 22-02 Project Inclusions: EcoLiving

Issue: DA₁ Drawing No:




LANDSCAPEDA

LOT 1, 47 WOODBINE STREET, NORTH BALGOWLAH, NSW, 2093

Drawing List

Sheet No.	Sheet Name	Sheet Size	Rev. No.	Rev. Date	Project No.
L-01	SITE PLANS	A3	А	21/10/22	1451
L-02	DETAILED PLAN	A3	А	21/10/22	1451
L-03	PLANTING DETAILS	A3	А	21/10/22	1451
I -04	SPECIFICATION	A3	A	21/10/22	1451

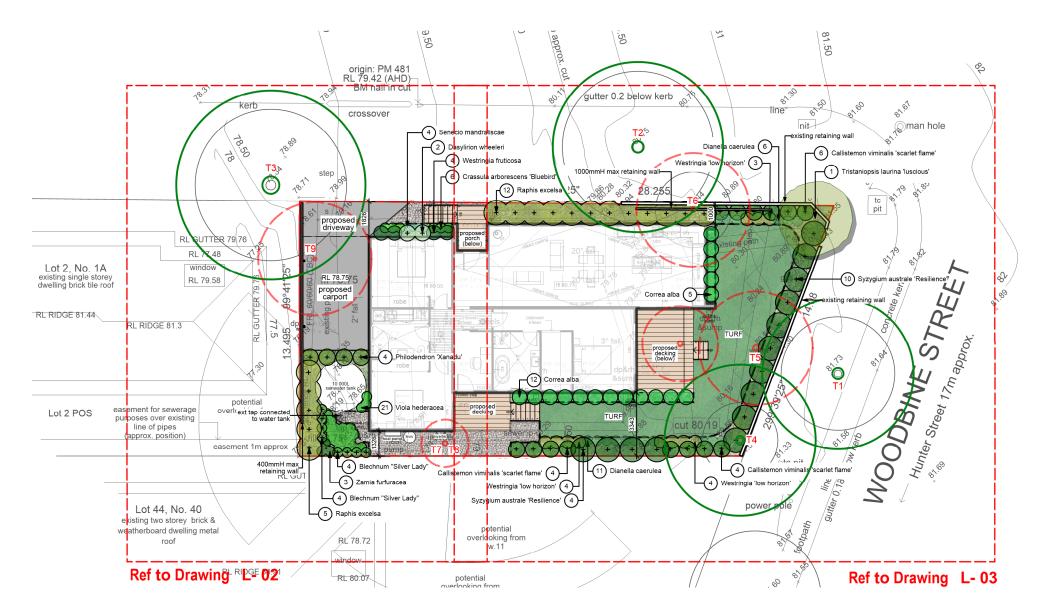

LANDSCAPE MAINTENANCE NOTES

MONTH	MOWING EDGING BLOWING	FERTILISING (SEASOL)	CHECK	HAND WEED REMOVAL	PRUNING	WEED SPARAYING	WATERING/ IRRIGATION	PLANT REPLACEMENT IF REQUIRED
DEC	W	М	М	W	F	М	D	W
JAN	W	М	М	W	F	М	D	W
FEB	W	М	М	W	F	М	D	W
MAR	F	М	М	F	М	М	D	W
APR	F	N/A	М	F	М	М	D	W
MAY	F	N/A	М	M	M	М	D	W
JUNE	М	N/A	М	M	N/A	N/A	2ND D	W
JULY	M	N/A	М	M	N/A	N/A	2ND D	W
AUG	М	N/A	М	M	N/A	N/A	2ND D	W
SEP	М	М	М	М	N/A	N/A	2ND D	W
ост	F	F	М	F	М	М	D	w
NOV	F	F	М	F	М	М	D	W

Lot 1, No. 47 area: 345.80m²

EXISTING TREE LEGEND

TREES TO BE REMOVED



PROPOSED RESIDENCE PROPOSED RESIDENCE

LEGEND

DRIVEWAY

TURF AREAS

DEEP SOIL GARDENS

21/10/22 ISSUE FOR REVIEW ISSUE DATE COMMENT

AMENDMENTS

SITEDESIGN creating places to live in and enjoy

SYDNEY NORTH STUDIO PO Box 265 SEAFORTH NSW 2092 0417685846 p 1300 22 44 55 info@sdstudios.com.au www.sdstudios.com.au

Mitch Hammonday Nt Balgowlah 1451 Project Lot 1, 47 Woodbine Street, North Balgowlah, NSW, 2093 Date 21.10.22 Drawing Title SITE PLANS Scale 1:200@A3

Page L-01

Drawing No.1451

SITEDESIGN creating places to live in and enjoy

SYDNEY NORTH STUDIO PO Box 265 info@sdstudios.com.au www.sdstudios.com.au

Project Mitch Hammonday Nt Balgowlah 1451 Lot 1, 47 Woodbine Street, North Balgowlah, NSW, 2093 Date 21.10.22 Drawing Title **DETAILED PLAN** Scale 1:100@A3 Page L-02

Drawing No.1451

AMENDMENTS

SEAFORTH NSW 2092 0417685846 p 1300 22 44 55

Plant L	ist					
ID	Botanical Name	Common Name	Scheduled Size	Mature Height	Mature Spread	Qty
Trees						
TLaur-lus	Tristaniopsis laurina 'luscious'	Kanooka, Water Gum	45L	5 - 10m	3.5 - 6m	1
Shrubs						
cal vim 'sf'	Callistemon viminalis 'scarlet flame'	Callistemon	200mm	0.6m	1m	14
Cor-alb	Correa alba	White Correa	200mm	0.9 - 1.5m	0.9 - 1.2m	17
das-wh	Dasylirion wheeleri	Desert Spoon	200mm	0.6 - 1m	1m	2
Phi-xan	Philodendron 'Xanadu'	Winterborn Philodendron	200mm	0.9 - 1.5m	0.9 - 1.2m	4
rap-exc	Raphis excelsa	Lady Palm	300mm	3 - 5m	1.0 - 3.5m	17
syz-au're'	Syzygium australe 'Resilience'	Lilly Pilly	200mm	1 - 2.5m	1.5m	14
Wes-fru	Westringia fruticosa	Coastal Rosemary	200mm	0.6m	0.9m	4
Ground (Covers					
Ble-sl	Blechnum "Silver Lady"	Fishbone Water Fern	150mm	0.75 - 0.9m	0.3 - 0.6m	8
Cra-arb	Crassula arborescens 'Bluebird'	'Blue Bird'	150mm	0.0 - 0.3m	0.3 - 0.6m	6
sen-ma	Senecio mandraliscae	Blue Chalk Sticks	150mm	0.15m	0.5m	4
vio-he	Viola hederacea	Native Violet	150mm	0.2m	0.6-0.8m	21
wes-lh'	Westringia 'low horizon'	coastal rosmary	200mm	0.4m	0.8m	11
zam-fu	Zamia furfuracea	Cardboard Plant	150mm	0.5m	0.6 m	3
Dia-cae	Dianella caerulea	Blue Flax-lily	150mm	0.4m	0.6m	17









Tristaniopsis laurina luscious Watergum

Callistemon viminalis 'Scarlet Flame'

Correa alba White correa

Dasylirion wheeleri Desert spoon


Philodendron xanadu







Blechnum 'Silver Lady'

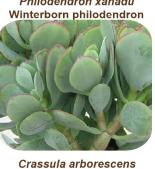

Raphis excelsa . Lady Palm

Syzygium Australe-resilience **Lilly Pilly**

Westringia

Westringia fruiticosa

Fishbone water fern

'Blue Bird'

Senecio mandraliscae **Blue Chalk Stick**


Viola hederacea Native Violet


Westringia low horizon **Coastal rosemary**


SPREAD & RAKE MIN. 100MM LAYER OF TURF

Zamia furfuracea **Cardboard Plant**

Dianella caerulea Flax Lilly

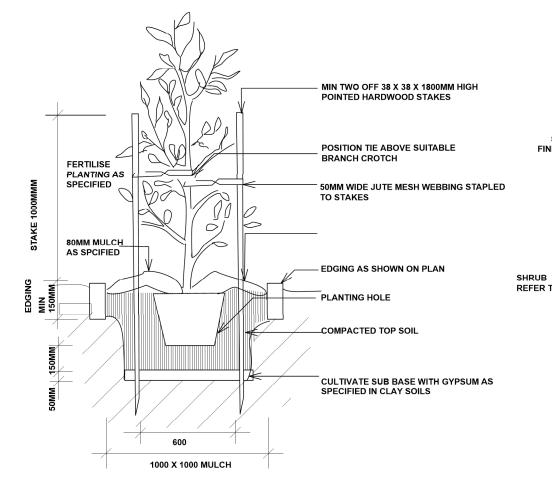

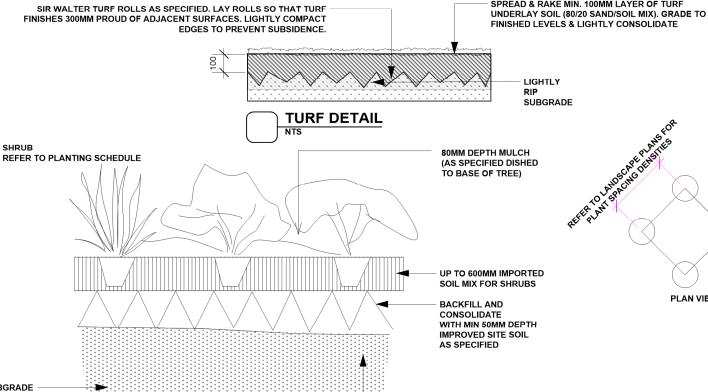

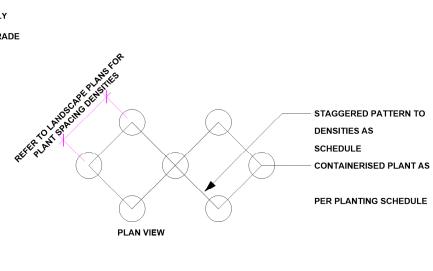

TYPICAL TREE PLANTING DETAIL

TYPICAL SHRUB PLANTING DETAIL

BREAK UP AND CULTIVATE SUBGRADE TO MIN 150MM DEPTH

21/10/22 ISSUE FOR REVIEW ISSUE DATE COMMENT

AMENDMENTS

SITEDESIGN +STUDIOS creating places to live in and enjoy

EXISTING SUBGRADE

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Project Mitch Hammonday Nt Balgowlah 1451

Drawing Title **PLANTING DETAILS**

Lot 1, 47 Woodbine Street, North Balgowlah, NSW, 2093 Address

Scale N.T.S@A3

Date 21.10.22

Page

Drawing No.1451

LANDSCAPE WORK SPECIFICATION

PRELIMINARIES

1.01 GENERAL

The following general conditions should be considered prior to the commencement of landscape works

The landscape plans should be read in conjunction with the architectural plans, hydraulic plans, service plans and survey prepared for the proposed

All services including existing drainage should be accurately located prior to the commencement of landscape installation. Any proposed tree planting which falls close to services will be relocated on site under the instruction of the landscape architect

Installation of conduit for required irrigation, electrical and other services shall be completed prior to the commencement of hardscape works and

All outdoor lighting specified by architect or client to be installed by qualified electrician

Where an Australian Standard applies for any landscape material testing or installation technique, that

standard shall be followed.

1.02 PROTECTION OF ADJACENT FINISHES

The Contractor shall take all precautions to prevent damage to all or any adjacent finishes by providing adequate protection to these areas / surfaces prior

1.03 PROTECTION OF EXISTING TREES

Existing trees identified to be retained shall be done so in accordance with NATSPEC Guide 2 "A Guide to Assessing Tree Quality". Where general works

are occurring around such trees, or pruning is required, a qualified Arborist shall be engaged to oversee such works and manage tree health Existing trees designated on the drawing for retention shall be protected at all times during the construction period. Any soil within the drip-line of existing

trees shall be excavated and removed by hand only. No stockpiling shall occur within the root zone of existing trees to be retained.

Any roots larger in diameter than 50mm shall only be severed under instruction by a qualified arborist. Roots smaller than 50mm diameter shall be cut cleanly with a saw.

Temporary fencing shall be installed around the base of all trees to be retained prior to the commencement of landscape works. Where possible this fencing will be located around the drip line of these trees, or a minimum of 3m from the trunk. The fencing shall be maintained for the full construction period.

The Contractor shall take all proper precautions to prevent the erosion of soil from the subject site. The contractor shall install erosion & sediment control barriers and as required by council, and maintain these barriers throughout the construction period. Note that the sediment control measures adopted

should reflect the soil type and erosion characteristics of the site. Erosion & pollution control measures shall incorporate the following:

- Construction of a sediment trap at the vehicle access point to the subject site
- Sediment fencing using a geotextile filter fabric in the location indicated on the erosion control plan or as instructed on

- Earth banks to prevent scour of stockpiles
- Sandbag kerb sediment traps
- Straw bale & geotextile sediment filter.
- Exposed banks shall be pegged with an approved Jute matting in preparation for mass planting

Refer to "Sitewise Reference Kit" as prepared by DLWC & WSROC (1997) for construction techniques

2.01 MATERIALS

Specified Soil Conditioner (Generally to improve site soil)

The specified soil conditioner for site top-soil improvement shall be an organic mix, equal to "Botany Humus", as supplied by ANL. Note that for sites where soil testing indicates toxins or extremes in pH, or soils that are extremely poor, allow to excavate and supply 300mm of imported soil mix.

New gardens & proposed Planting

New garden and planting areas shall consist of a 50/50 mix of clean site soil (refer d) below) and imported "Organic Garden Mix" as supplied by ANL or approved equal. All mixes are to comply with AS 4419 Soils for landscaping & garden use, & AS 4454 Composts, Soil conditioners & mulches

Specified Soil Mix - Turf

The specified soil mix for all turf areas shall be a min 75mm layer of imported soil mix consisting of 80% washed river sand (reasonably coarse), and 20% composted organic matter equivalent to mushroom compost or soil conditioner, or other approved lawn top dress.

Site topsoil is to be clean and free of unwanted matter such as gravel, cXXIay lumps, grass, weeds, tree roots, sticks, rubbish and plastics, and any deleterious materials and materials toxic to plants. The topsoil must have a pH of between 5.5 and 7. Use 100% imported soil mix when site when site topsoil runs out.

2.02 INSTALLATION

a) Establishing Subgrade Levels

Subgrade levels are defined as the finished base levels prior to the placement of the specified material (i.e. soil conditioner). The following subgrade levels

d out in accordance with the Building Code of Australia, all Local and State Government Ordinances, relevant Australian Standards, Local

work and site drainage to be subject to Engineer's details or certification where required by Council. This shall include r.c. slabs and footings, r.c. an Columns, wind bracing to AS 1170 etc., driveway slabs and drainage to Council's satisfaction. All timbers to be in accordance with SAA Timber foot AN Timber Training Code AS 1684. All work to be carried out in a professional and workman-shiplike manner according to the plate.

IOLE
on ot scale off the drawings unless otherwise stated and use figured dimensions in preference.
Ill dimensions are to be checked and verified on site before the commencement of any work, all dimensions and levels are subject to final survey and set-out to esponsibility will be accepted by Stedesign for any ventations in design. builder's method of construction or materials used, deviation from specification will employ to the property of the property of

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avant Authorities concerned. a subject to Engineer's details or certification where required by Council. This shall include r.c. slabs and footings, r.c. an

Mass Planting Beds - 300mm below existing levels with specified imported soil mix

Turf areas - 100mm below finished surface level

Note that all subgrades shall consist of a relatively free draining natural material, consisting of site topsoil placed previously by the Civil Contractor. No builders waste material shall be acceptable

b) Subgrade Cultivation

Cultivate all subgrades to a minimum depth of 100mm in all planting beds and all turf areas, ensuring a thorough breakup of the subgrade into a reasonably coarse tilth. Grade subgrades to provide falls to surface and subsurface drains, prior to the placement of the final specified soil mix.

c) Drainage Works

Install surface and subsurface drainage where required and as detailed on the drawing. Drain subsurface drains to outlets provided, with a minimum

d) Placement and Preparation of Specified Soil Conditioner & Mixes.

Trees in turf & beds - Holes shall be twice as wide as root ball and minimum 100mm deeper - backfill hole with 50/50 mix of clean site soil and imported "Organic Garden Mix" as supplied by ANL or approved equal.

Place the specified soil conditioner to the required compacted depth and use a rotary hoe to thoroughly mix the conditioner into the top 300mm of garden bed soil. Ensure thorough mixing and the preparation of a reasonably fine tilth and good growing medium in preparation for planting. Turf Areas - Install specified soil mix to a minimum compacted depth of 75mm.

Place the specified soil mix to the required compacted depth and grade to required finished soil levels, in preparation for planting and turfing.

PI ANTING

3.01 MATERIALS

a) Quality and Size of Plant Materia

All trees supplied above a 25L container size must be grown and planted in accordance with Clarke, R 1996 Purchasing Landscape Trees: A guide to assessing tree quality. Natspec Guide No. 2. Certification that trees have been grown to Natspec guidelines is to be provided upon request o Council's Tree Management Officer.

Above - Ground Assessment

The following plant quality assessment criteria should be followed:

Plant true to type, Good vigour and health, free from pest & disease, free from injury, self-supporting, good stem taper, has been pruned correctly, is apically dominant, has even grown symmetry, free from included bark & stem junctions, even trunk position in pot, good stem structure Below - Ground Assessment

Good root division & direction, rootball occupancy, rootball depth, height of crown, non-suckering For further explanation and description of these assessment criteria, refer to Ross Clark's book

All Plant material shall be to the type and size specified. No substitutions of plant material shall be permitted without written prior approval by the Landscape Architect. No plant shall be accepted which does not conform to the standards listed above.

b) Stakes and Ties

Provide min. 2 No. Stakes and ties to all plants identified as trees in the plant schedule. Stakes shall be sound, unpainted, straight hardwood, free of knots and pointed at one end. They shall be 2200mm x 50mm x 50mm Hardwood, or approved alternative. Ties shall be 50mm wide hessian webbing material.

c) Fertilisers

Fertilisers shall be approved slow release fertilisers suitable for the proposed planting types. Note that for native plants. specifically Proteaceae family plants including Grevillea species, low phosphorus fertilizers shall be used

d) Mulch

Mulch shall be an approved equal to "Forest Blend" as supplied by ANL. Mulch shall be completely free from any soil, weeds, rubbish or other debris.

e) Turf

Turf shall be "Sir Walter" Buffalo or equivalent (unless stated otherwise), free from any weeds and other grasses, and be in a healthy growing condition

3.02 INSTALLATION

a) Setting Out

All planting set out shall be in strict accordance with the drawings, or as directed. Note that proposed tree planting located near services should be adjusted at this stage. Notify Landscape Architect for inspection for approval prior to planting. b) Planting

All plant material shall be planted as soon after delivery as possible. Planting holes for trees shall be excavated as detailed and specified. Plant containers shall be removed and discarded, and the outer roots gently teased from the soil mass Immediately set plant in hole and backfill with specified soil mix, incorporating the approved quantity of fertiliser for each plant type. Ensure that plants are set plumb vertically and root balls set to the consolidated finished grades detailed on the drawings. Compact the backfilled soil and saturate by hand watering to expel any remaining air pockets immediately after planting.

c) Staking and Tving

Staking and tying shall be in strict accordance with the drawings and shall occur immediately following plant placement and soil backfilling. All plants identified as "Trees" on the planting schedule shall be staked with a min. 3 stakes.

Mulch should be spread so that a compacted thickness of 75mm is achieved after settlement in all planting beds and around each individual plant. Apply immediately following planting and watering in, ensuring that a 50mm radius is maintained around the trunk of each plant . There shall be no mixing of soil and mulch material.

e) Turfing

Moisten soil prior to the turf being laid. Turf shall be neatly butt jointed and true to grade to finish flush with adjacent surfaces. Incorporate a lawn fertilizer and thoroughly water in. Keep turf moist until roots have taken and sods/rolls cannot be lifted. Keep all traffic off turf until this has occurred. Allow for top dressing of all turf areas. All turf shall be rolled immediately following installation

The Contractor shall install stone edging as shown on the drawings, to all mass planting beds adjoining turf or gravel mulched areas, and where required. The resultant edge shall be true to line and flush with adjacent surfaces

HARDSCAPE WORKS

4.01 GENERAL

The Contractor shall undertake the installation of all hardscape works as detailed on the drawing, or where not detailed, by manufacturers specificatio

Paving - refer to typical details provided, and applicable Australian Standards. Permeable paving may be used as a suitable means of satisfying Council permeable surface requirements, while providing a useable, hardwearing, practical surface. In most instances, the client shall nominate the appropriate paving material to be

Australian Standards shall be adhered to in relation to all concrete, masonry & metal work. Some details are typical and may vary on site. All hardscape works shall be setout as per the drawings, and inspected and approved by the Landscape Architect prior to installation. All workmanship shall be of the highest standard. Any queries or problems that arise from hardscape variations should be bought to the attention of the Landscape Architect.

Your attention is directed to any obligations or responsibilities under the Dividing Fences Act, 1991 in respect of adjoining property owner/s which may arise from this application. Any enquiries in this regard may be made to the Crown Lands Division on (02) 8836 5332

IRRIGATION WORKS

5.01 GENERAL (PERFORMANCE SPECIFICATION)

An automated drip-irrigation system is to be installed to all gardens, planters and lawn areas in accordance with the approved Irrigation Design

This system shall be designed and installed by a qualified and licensed irrigation specialist, to the highest industry standards and to maximise the efficient usage of

The Installer is required to obtain all approvals necessary for the completion of works in accordance with the Laws of Australia, Laws of the State of NSW. Council By-Laws and Ordinances.

Drawings:

- The Landscape Contractor nominated Licensed Irrigation Specialist shall provide irrigation drawings for approval upon engagement.

Design Requirements

The irrigation system shall be installed prior to all planting works. It shall incorporate a commercially available irrigation system, with sub-surface dripper lines to irrigate all gardens, planters and lawn areas.

It shall incorporate a suitable back flow prevention device for the scale of works, an in-line filter, check valves, and suitable high and low density poly hose fittings and PVC piping to achieve flow rates suitable for specified planting.

- The irrigation application rate shall not exceed the infiltration rate of the soil or creates run-off
- The landscape contractor shall check the existing pressure available from the ring mains and size irrigation piping to suit. Supply shall be from local hose cock where
- All piping and fittings shall be buried 50mm below the finished soil levels in garden and lawn areas, and secured in position at 500mm centres with galy wire pins,
- Size of pipes shall be selected to ensure the working pressure at the end of the line does not decrease by more than 5%.

Services Co-ordination

- Co-ordination required by Landscape Contractor or Project Manager to provide required conduit, pipe work and penetration through slabs and planter walls for water and power provision
- The Landscape Contractor shall be engaged with the Irrigation Specialist to co-ordinate with the Project Manager to identify the preferred service and conduit
- Project Manager and Landscape Contractor to establish area suitable for irrigation control system with required area, power provision and water supply.

Upon completion of installation, the system shall be tested, including:

- Main Line Pressure Test: The main line is pressurised to test for leaks. All valves are shut and the pressure is taken over a determined length of time
- Dripper Pressure Test: Measurement at flushing valves are taken and the pressure gauged to make sure it conforms to the manufacturer recommendations. The inlet
- All components are to be satisfactorily functional and operational prior to approval. Should any defect develop, or the capacity or efficiency of the system decline during the agreed maintenance system, then these faults shall be immediately rectified

Warranty

- A full 12 month warranty shall be included to cover labour and all parts

Further Documentation

- On request, a detailed irrigation performance specification report can be issued.

12 MONTH MAINTENANCE

The consolidation and maintenance period shall be 12 months beginning from the approved completion of the specified construction work (Practical Completion). A qualified landscape maintenance contractor shall undertake the required landscape maintenance works. Consolidation and maintenance shall mean the care and naintenance of Contracted works by accepted landscaping or horticultural practices, ensuring that all plants are in optimum growing conditions and appearance at all times, as well as rectifying any defects that become apparent in the contracted works

This shall include, but not be limited to, the following items where and as required: Watering all planting and lawn areas / irrigation maintenance

Clearing litter and other debris from landscaped areas.

Removing weeds, pruning and general plant maintenance

Replacement of damaged, stolen or unhealthy plants. Make good areas of soil subsidence or erosion

Topping up of mulched areas. Spray / treatment for Insect and disease control

Mitch Hammonday Nt Balgowlah 1451

Fertilizing with approved fertilizers at correct rates

Mowing lawns & trimming edges each 14 days in summer or 18 days in winter Adjusting ties to Stakes

Lot 1, 47 Woodbine Street, North Balgowlah, NSW, 2093

Maintenance of all paving, retaining and hardscape elements.

On the completion of the maintenance period, the landscape works shall be inspected and at the satisfaction of the superintendent or landscape architect, the responsibility will be signed over to the client.xx

> 21/10/22 ISSUE FOR REVIEW ISSUE DATE COMMENT

AMENDMENTS

Date 21.10.22

Scale N.T.S@A3

Page

Drawing No.1451

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Drawing Title **SPECIFICATION**

Project