List of Abbreviations

AFFL	Above Finished Floor Level	PB	Plasterboard
AFFL	Agricultural Pipe	PBL.	Plasterboard Pebble Ballast
AG AP	Agricultural Pipe Access panel	PBL	Plasterboard Moisture Resistant
AW	Access panel Awning Window	PBF	
AVV	Awning window		Plasterboard or Fibre Cement Fire Rated Lining to BCA
	Direct	PWC	Plywood Panel Wall Cladding
В	Blind	PD	Planter Drain
BFD	Bifolding Glazed Doors	PL	Planter
BW	Brickwork	P	Painted
BWF	Brick work face	PR	Polycarbonate Roof ing
BWS	Brick work soldier course	PV	Paving concrete
CL	Centre Line	R	Robe
CB	Concrete block reinforced if retaining wall	RH	Rangehood
CBF	Concrete Block facework	RWH	Rainwater Head
CJ	Control Joint	RWO	Rainwater Outlet
cos	Check On Site	RWT	Rainwater Tank
CPT	Carpet	RS	Rain Screen
CR	Cement Render	RTC	Roof Tile - Concrete
CS	Concrete Slab	RTT	Roof Tile - Terracotta
CT	Ceramic Tiling		Trool Tile Tollabora
CW	Casement Window	ST	Stone
cws	Cold Water Service	SD	Smoke Detector
00	0014 11 4151 0011100	SDH	Sashless Double Hung Window
DP	Downpipe	SHR	Shower Head 2000 AFFL unless noted otherwis
DPC	Damp Proof Course	SK	Skirting
DPM	Damp Proof Membrane	SHS	Skylight
DI W	Bamp i roor membrane	SLD	Sliding door
EDB	Electrical Distribution Board	SLS	Sliding Louvre Screen
FGL.	Existing Ground Level	SS	Steel Stainless
EJ	Expansion Joint	S	Steel
EX	Existing	SF	Steel frame
EXT	External	SP	Solar panel
EVI	External	SSW	Sashless Sliding Window
FC	Fibrous Cement	STD	Strip drain
FCP	Fibrous Cement Panel	STP	Strip drain Stormwater Pipe
FD	Floor Drain, cast into concrete	SW	Sandstone Wall
FFL	Finished Floor Level	SWP	Sewer Pipe
FGL	Finished Ground Level	SWF	Sewei Fipe
FG	Fixed Glazing	TBD	Timber Bi-folding Doors
FW	Floor Waste	TD	Timber Framed Doors
F VV	Floor Waste	TDB	Timber Prairied Boors Timber Decking Boards
G	Glass	TW	Timber Decking Boards Timber Framed Windows
G	Glass	TW	Timber Framed Windows Timber wall cladding
HC	Hose cock	TPH	
пС	nose cock	TR	Toilet Paper Holder 500 AFFL Towel Rail 850 AFFL unless noted otherwise
J	Joint	IK	Tower Rail 650 AFFL unless noted otherwise
•	Cont	UC	Universal Steel Column
LS	Louvre Screen	U/S	Underside
LV	Louvre Vent	UG	Underground
		VB	Vapour Barrier
M	Masonry wall	VP	Vent Pipe
MA	Metal Awning		'
MB	Metal Balustrade	WA	Window Awning
MR	Metal Roofing	WC	Water Closet
MS	Mild Steel	WM	Washing Machine
MW	Metal Walling	WPM	Water Proof Membrane
		WRC	Western Red Cedar
OP	Opaque Glazing	WS	Window Sliding
OS	Overf low Spitter	WOV	Wall Oven
OFC	Off Form Concrete	*****	
51 0	o oniordo		



Development Application Issue

for

Alteration & Addition of unit 3 and existing Garage & Strata Lot Subdivision

at

3/153 Balgowlah Rd, Balgowlah NSW

for

Austin Ware & Charlotte Vergnolle




Wall & Floor Legend



Basix commitments



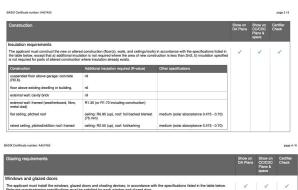

Glazing requirements	Show on DA Plans	Show on CC/CDC Plans & specs	Certifier Check
Windows and glazed doors			
The applicant must install the windows, glazed doors and shading devices, in accordance with the specifications listed in the table below. Relevant overshadowing specifications must be satisfied for each window and glazed door.	1	~	~
The following requirements must also be satisfied in relation to each window and glazed door:		1	~
Each window or glazed door with standard aluminium or timber frames and single clear or toned glass may either match the description, or, have a U-value and a Sider Heat Gain Coefficient (SHGC) no greater than that listed in the table below. Total system U-values and SHGCs must be calculated in accordance with National Feneration Rating Council (NFRC) conditions.		1	1
Each window or placed door with improved framers, or proviptic low- opiess, or clearlist papiciae glazing, or brondair appricise glazing must have a U-value and a South Head Each Coefficient (SHCF) on greater than that little of the table below. Tell opies or Vital system U-values and SHCFG must be calculated in accordance with National Fenetsration Rating Council (NFRC) conditions. The description is provided for information only. Alternative systems with complying U-value and SHCFG may be substituted.		~	~
For projections described in millimetres, the leading edge of each eave, pergola, verandah, balcony or awning must be no more than 500 mm above the head of the window or glazed door and no more than 2400 mm above the sill.	~	~	~
Pergolas with polycarbonate roof or similar translucent material must have a shading coefficient of less than 0.35.		1	1
External louvres and blinds must fully shade the window or glazed door beside which they are situated when fully drawn or closed.		1	1
Pergolas with fixed battens must have battens parallel to the window or glazed door above which they are situated, unless the pergola also shades a perpendicular window. The spacing between battens must not be more than 50 mm.		1	~
Pergolas with adjustable shading may have adjustable blades or removable shade cloth (not less than 80% shading ratio). Adjustable blades must overlap in plan view.		~	~
Overshadowing buildings or vegetation must be of the height and distance from the centre and the base of the window and glazed door, as specified in the 'overshadowing' column in the table below.	~	~	~
Windows and glazed doors glazing requirements			


Glazing requ	irements						Show on DA Plens	Show on CC/CDC Plans & specs	Certifier Check
Window / door	Orientation	Area of	Oversh	adowing	Shading device	Frame and glass type			
		glass inc. frame (m2)	Height (m)	Distance (m)					
W1	s	7	2.5	2.9	pergola (adjustable shade) >=900 mm	standard aluminium, single clear, (or U-value: 7.63, SHGC: 0.75)			
W2	N	2	2.5	2.9	pergola (adjustable shade) >=900 mm	standard aluminium, single clear, (or U-value: 7.63, SHGC: 0.75)			
W3	E	4.6	0	0	external louvre/blind (adjustable)	standard aluminium, single clear, (or U-value: 7.63, SHGC: 0.75)			
W4		1	0	0	eave/verandals/pergola/balcony >=450 mm	standard aluminium, single pyrolytic low-e, (U-value: 5.7, SHGC: 0.47)			
W5	w	10	0	0	esternal louvre/blind (adjustable)	standard aluminium, single clear, (or U-value: 7.63, SHGC: 0.75)			
W6	N	2	2.5	2.9	pergola (adjustable shade) >=900 mm	standard aluminium, single clear, (or U-value: 7.63, SHGC: 0.75)			
W7	s	4	2.5	2.9	pergola (adjustable shade) >=900 mm	standard aluminium, single clear, (or U-value: 7.63, SHGC: 0.75)			
WB	E	5	6	3.6	none	standard aluminium, single clear, (or U-value: 7.63, SHGC: 0.75)			
W9	E	2.5	0	0	eaververandah/pergola/belcony >=450 mm	standard aluminium, single pyrolytic low-e, (U-value: 5.7, SHGC: 0.47)			

Legend	
In these commitments, "appl	cent" meens the person carrying out the development.
	a "_" in the "Show on DA plans" column must be shown on the plans accompanying the development application for the proposed development (if a be lodged for the proposed development).
	a "_" in the "Show on CC/CDC plans & specs" column must be shown in the plans and specifications accompanying the application for a construction present certificate for the proposed development.
Commitments identified with development may be issued	a "v" in the "Certifier check" column must be certified by a certifying authority as having been fulfilled, before a final occupation certificate for the

	Drawing I	ist	_/	
		Y		L
	DA)
(DA00	Cover Page	Е	23.07.2022
>	DA01	Site Analysis	D	11.05.2022
	DA02	Proposed Site Plan	Ε	23.07.2022
	DA03	Ground Floor Proposed plan	Ε	23.07.2022
(DA04	Level 1 proposed plan	D	11.05.2022
	DA05	Sections	E	23.07.2022
(DA06	Street Elevations & Finishes	E	23.07.2022
	DA07	Side Elevations & Finishes	E	23.07.2022
	DA08	Shadow Diagram Plan	D	11.05.2022
	DA09	Shadow Diagram Elevation	D	11.05.2022
	DA10	Landscape Plan	D	11.05.2022
	DA11	Area Calculation	C	11.05.2022
	DA12	Erosion Control Plan	c	11.05.2022
{	DA13	Proposed Subdivision Plan	D	23.07.2022
	DA14	Notification Plan	C	11.05.2022
_	< /			

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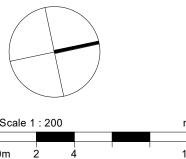
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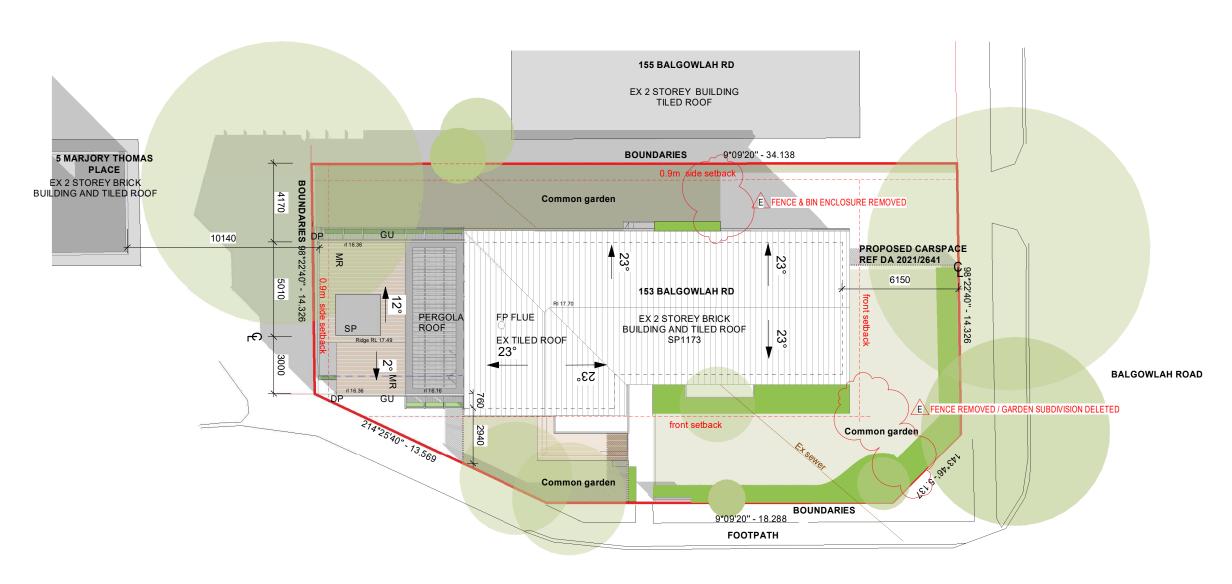


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Drawing Title

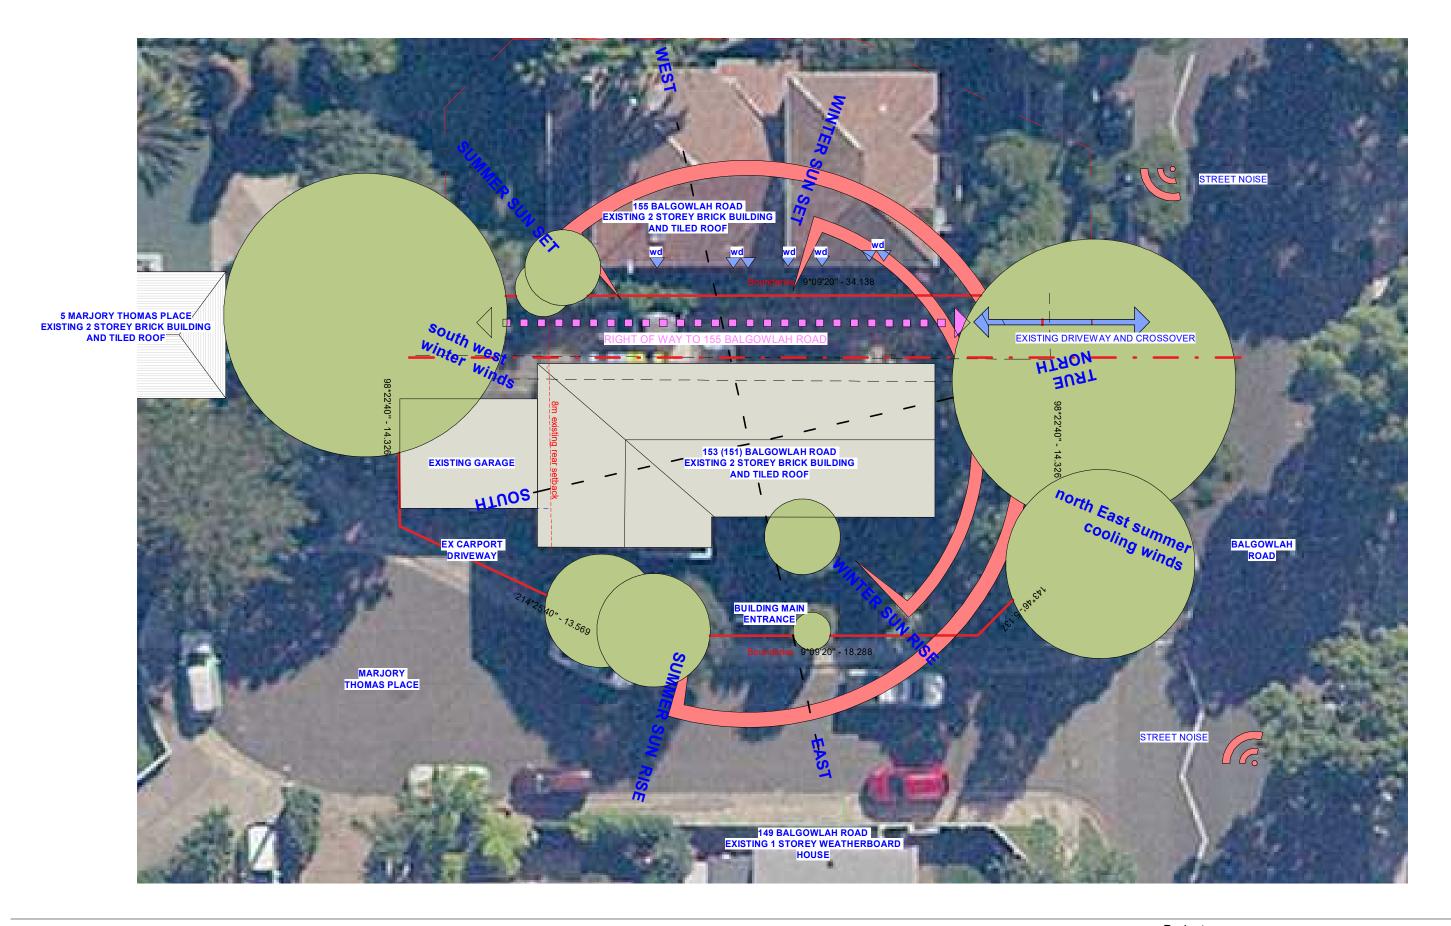Site Analysis

Oile Allary.	313		
Scale at A3			Revision Date.
1:200			11.05.2022
Project No.	Rev No.		Drawing No.
2101		D	DA01



MARJORY THOMAS PLACE

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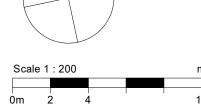
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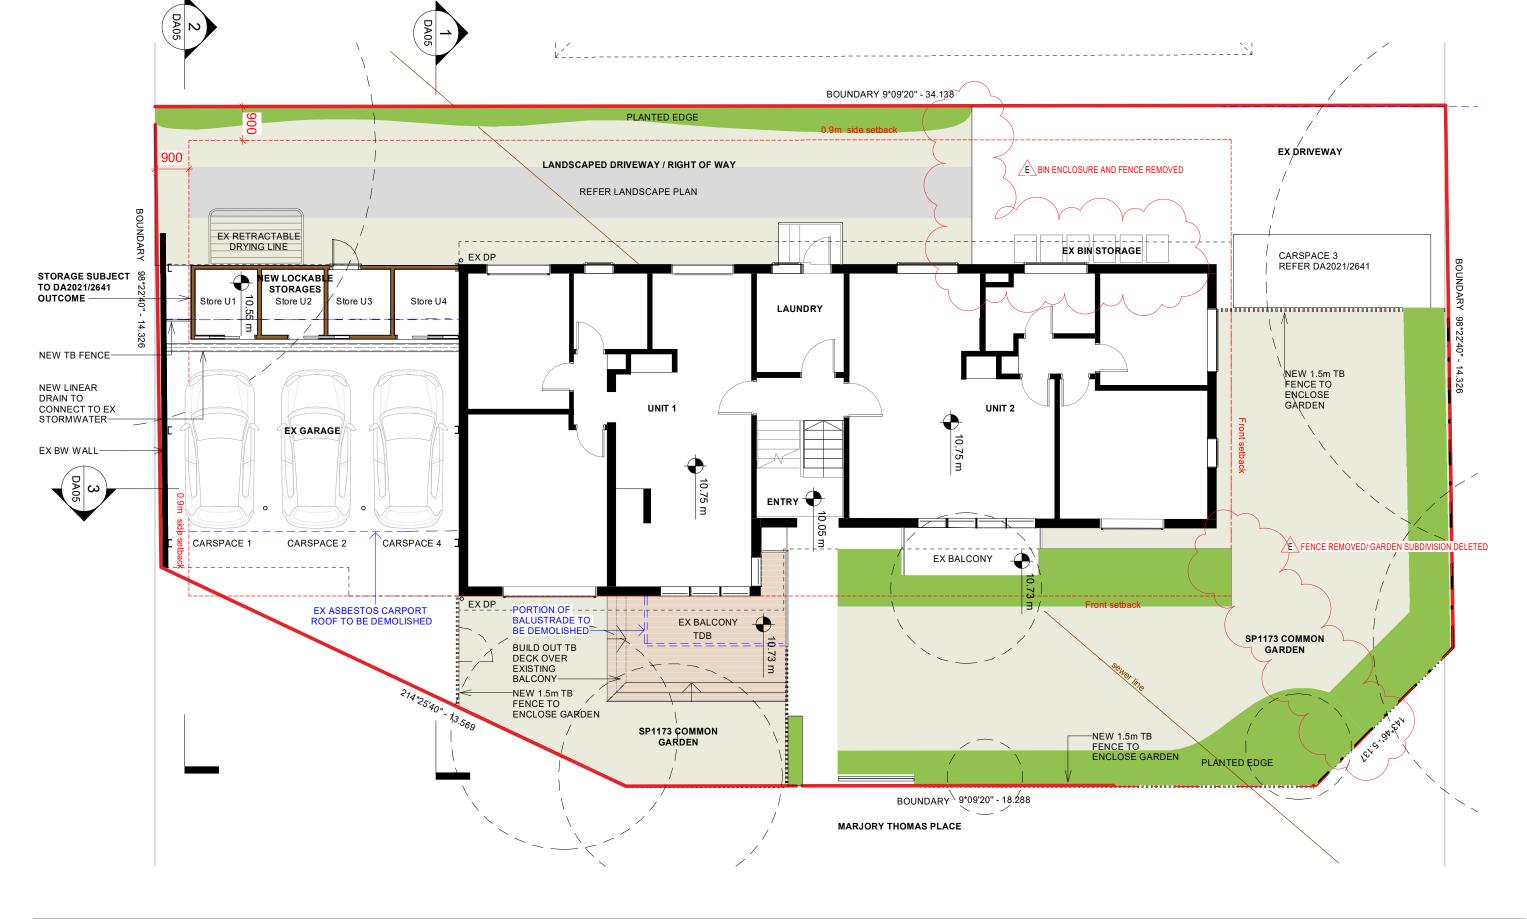
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Proposed Site Plan

	• •	UU	···
Revision Date.			Scale at A3
23.07.2022			1:200
Drawing No.		Rev No.	Project No.
DA02	Ε		2101



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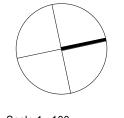
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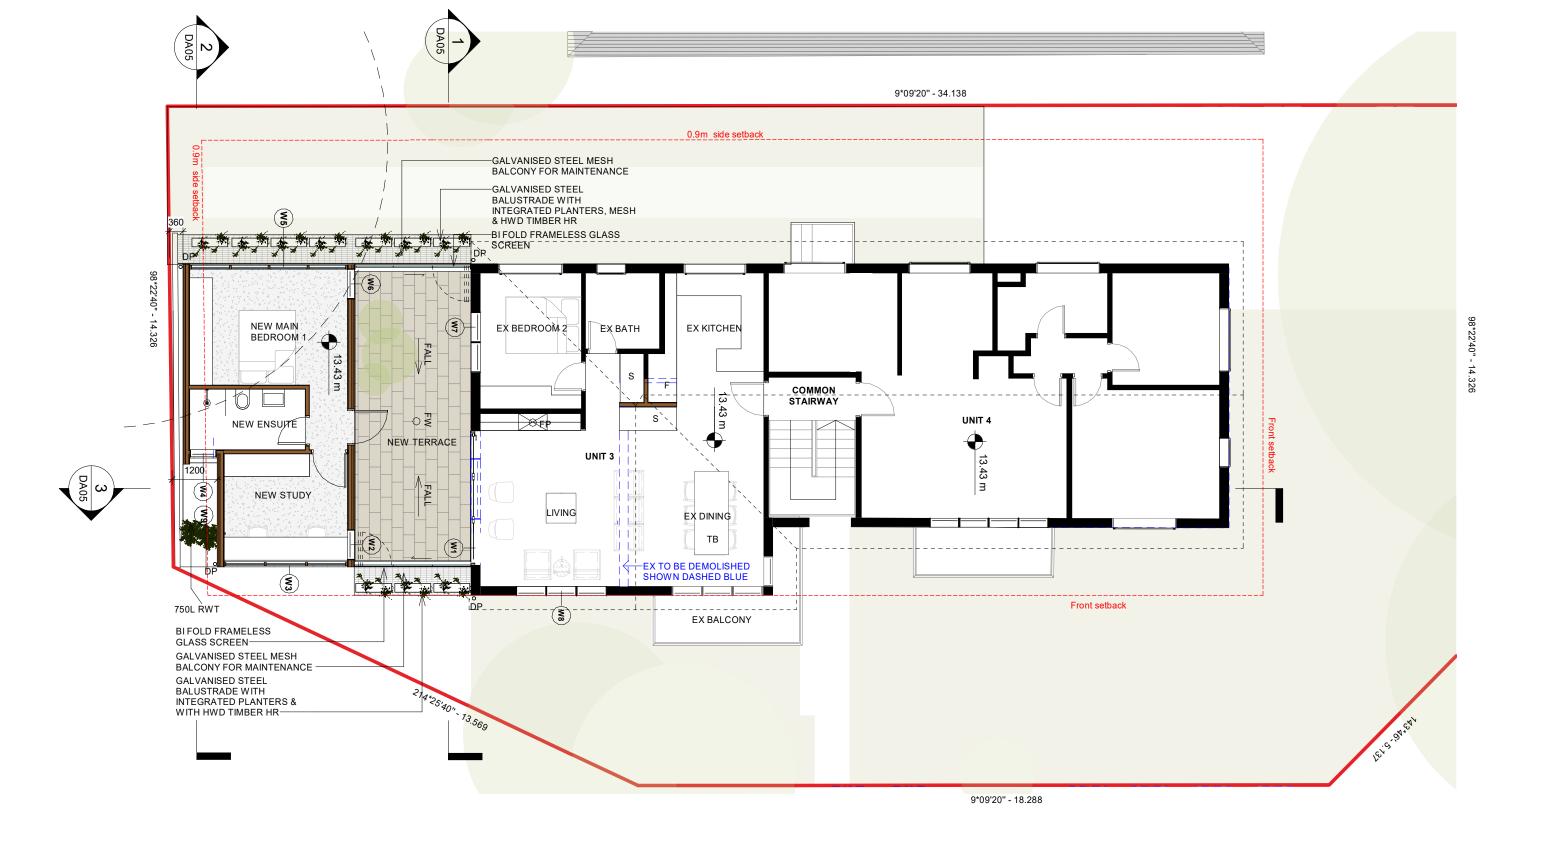
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Ground Floor Proposed plan

Scale at A3 Revision Date. 1:100 23.07.2022 Project No. Rev No. Drawing No. **DA03** 2101




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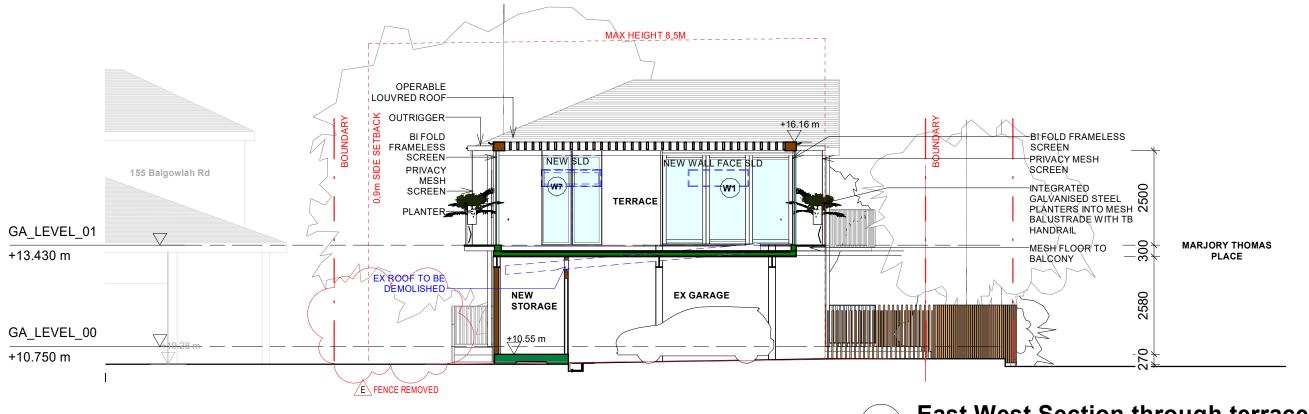
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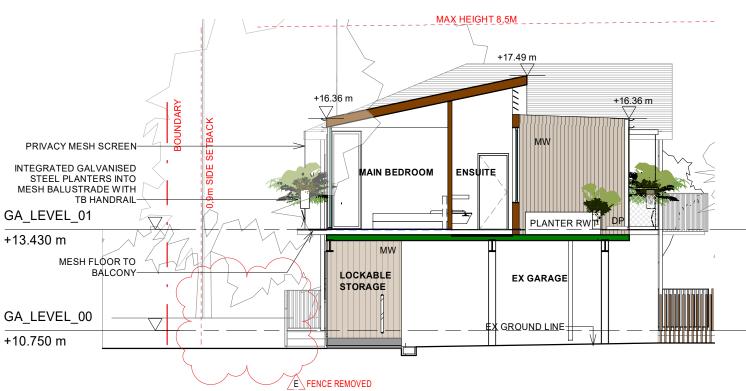
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Level 1 proposed plan Scale at A3 Revision Date. 1:100 11.05.2022 Project No. Rev No. Drawing No.

D



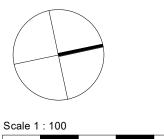

East West Section through terrace

1:100 REF:1/A2000



East West Section through main bed

REF:1/DA03

North South Section 1:100 REF:1/A2000

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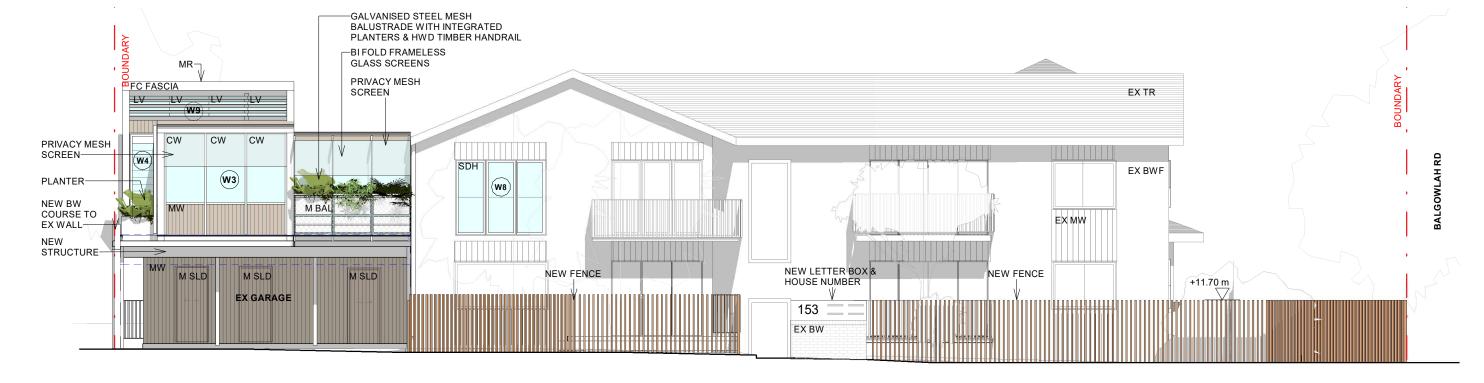
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2101

Sections Scale at A3 Revision Date. 1:100 23.07.2022 Project No. Drawing No. Rev No.



Proposed East Elevation - Marjory Thomas Place

+17.81 m ∇ EX TR **MARJORY THOMAS** EX BWF 155 BALGOWLAH RD EX MW NEW TB FENCE 35X35 E BIN ENCLSURE AND FENCE REMOVED BATTEN @ 90

North Elevation- Balgowlah Road

23.07.2022 Additional information

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23.03.2022 Issue for Information

02.05.2022 Issued for owner consent

Reason For Issue

11.05.2022 Issued for DA

FINISHES





EX BRICKWORK

METAL WALL AND ROOFING



GALVANISED STEEL

GALVANISED STEEL PLANTER



WHITE ALUMINUM WINDOW FC WHITE FINISH

GALVANISED MESH STEEL

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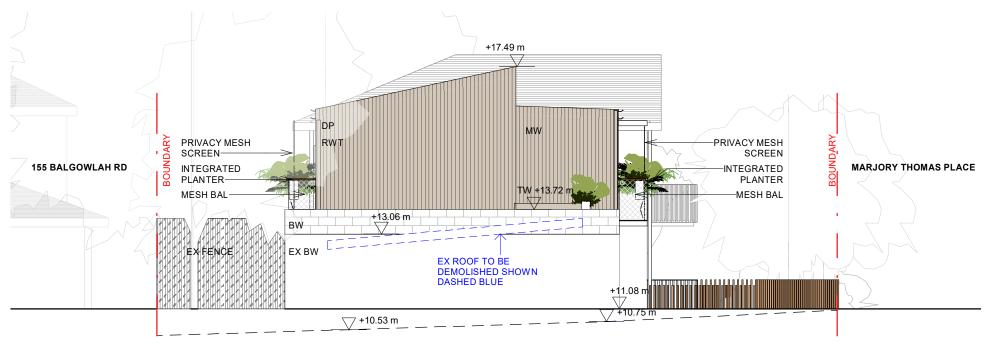
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Street Elevations & Finishes


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Drawing No. **DA06**



South Elevation



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FINISHES

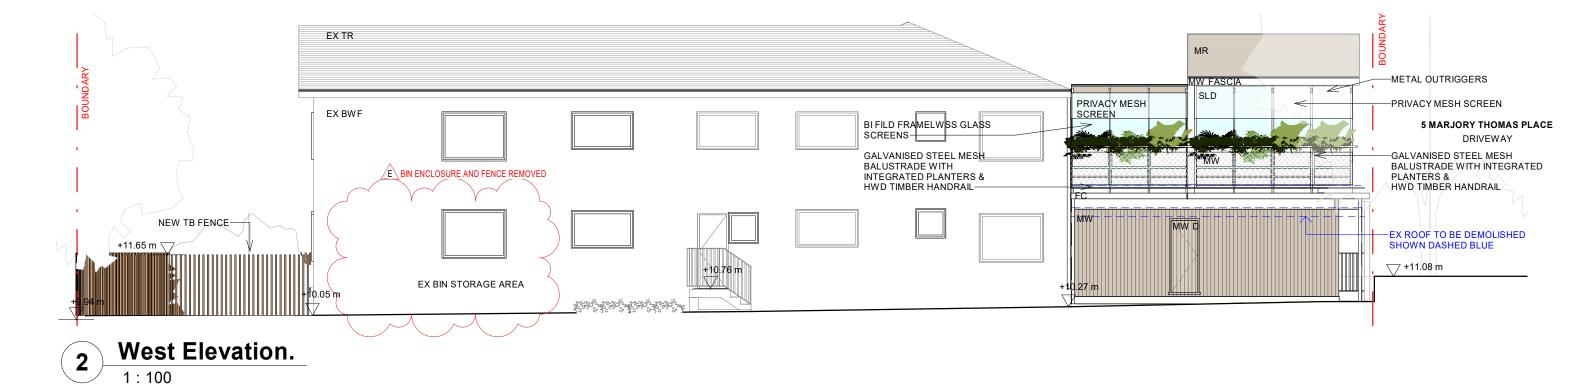EX BRICKWORK

STAINLESS STEEL

WHITE ALUMINUM WINDOW

FC WHITE FINISH

METAL WALL

AND ROOFING

STAINLESS

STEEL PLANTER

WHITE PAINTED TB FENCE


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Side Elevations & Finishes


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DA07


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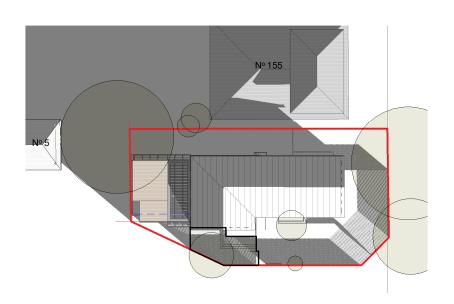
EXISTING PLAN VIEW 9AM WINTER SOLSTICE




EXISTING PLAN VIEW 12PM WINTER SOLSTICE

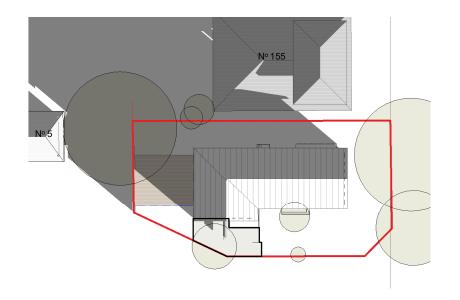

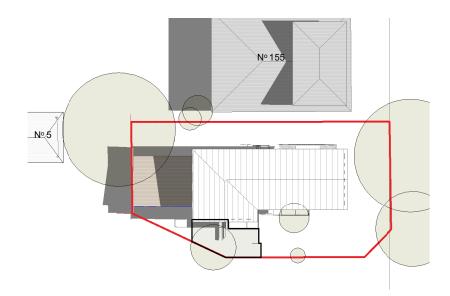
EXISTING PLAN VIEW 3PM WINTER SOLSTICE

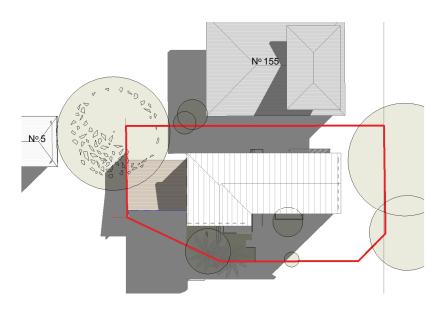

PROPOSED PLAN VIEW 9AM WINTER SOLSTICE

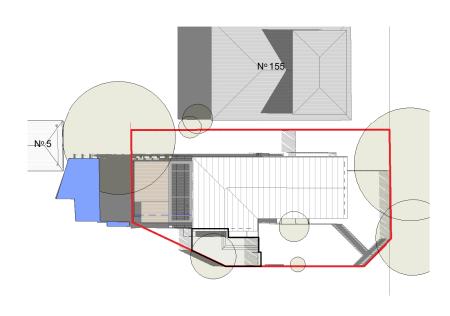

PROPOSED PLAN VIEW 12PM WINTER SOLSTICE

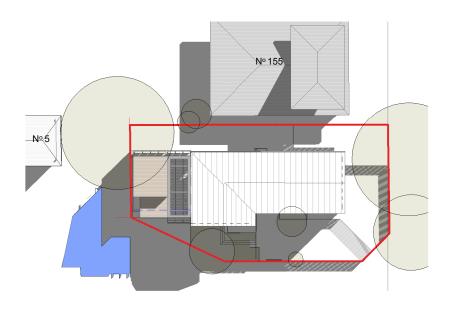

PROPOSED PLAN VIEW 3PM WINTER SOLSTICE

LEGEND



EXISTING SHADOW



ADDITIONAL SHADOW

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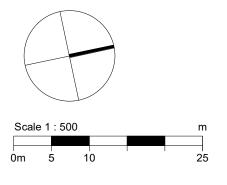
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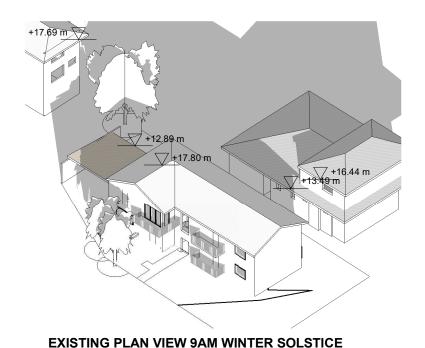
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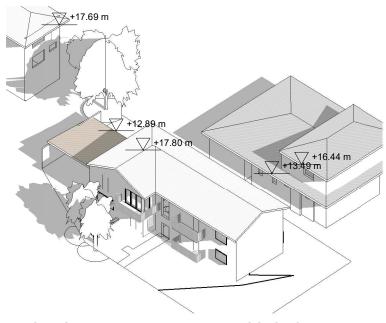
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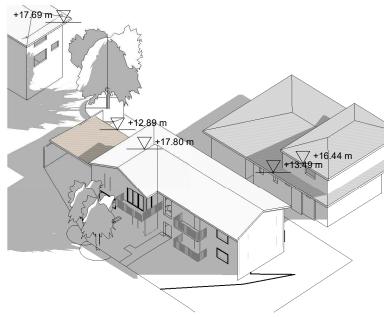
Shadow Diagram Plan

Scale at A3		Rev	ision Date.
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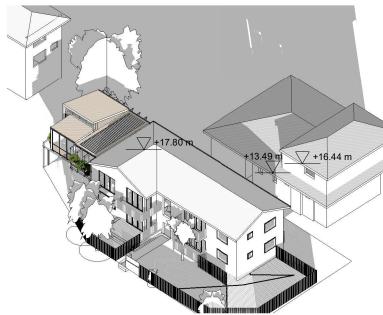








EXISTING PLAN VIEW 12PM WINTER SOLSTICE


EXISTING PLAN VIEW 3PM WINTER SOLSTICE



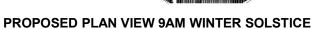

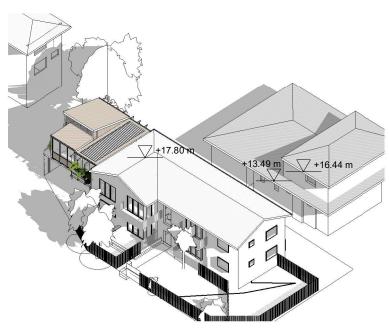

PROPOSED PLAN VIEW 12PM WINTER SOLSTICE

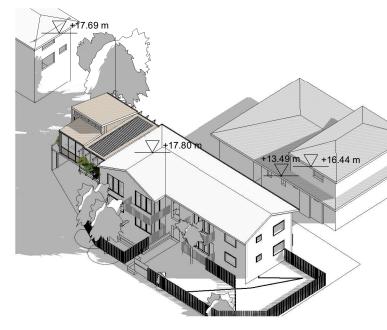

PROPOSED PLAN VIEW 3PM WINTER SOLSTICE

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Shadow Diagram Elevation

Scale at A3

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DA09

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2101 D

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Lomandra longifolia spiny-head mat-rush



2 Concrete



3 Grass pavers



4 Pebbles



5 Anigozanthos Kangaroo paw



6 Banksia integrifolia



Dwarf thrymptomene Payne's Thryptomene




8 Grevillea



9 Crassula Arborescens Silver Dollar Plant



Hardenbergia 10 Happy Wanderer

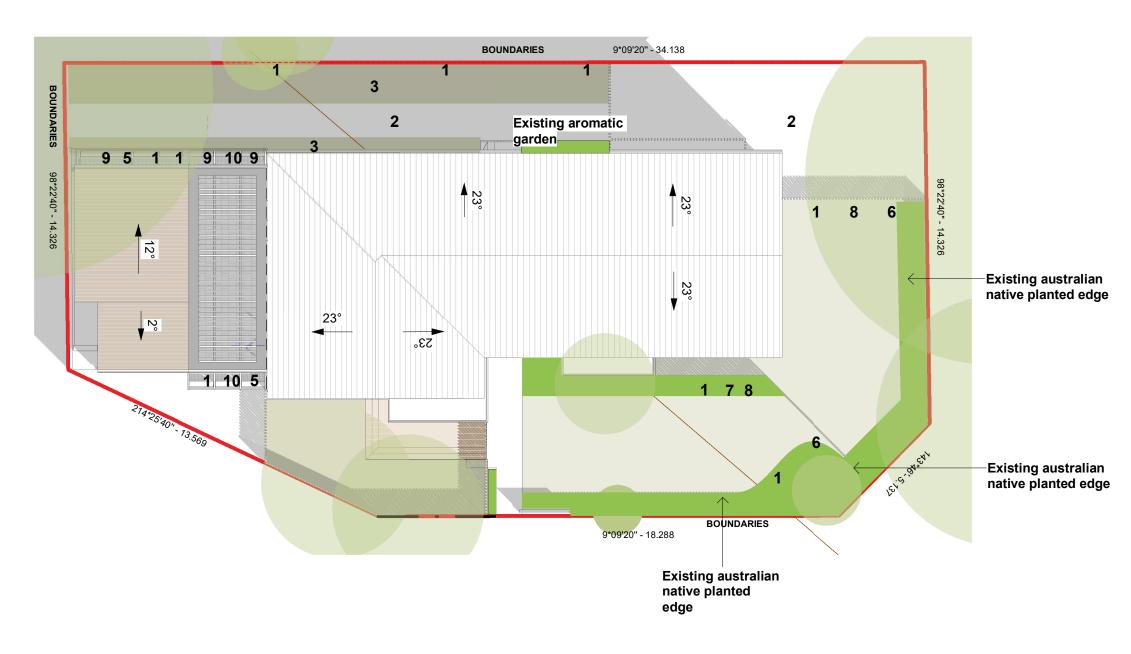

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- Scale 1: 150 1.5

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Drawing Title Landscape Plan

Scale at A3 1:150


Revision Date. 11.05.2022

Project No. Rev No. Drawing No. 2101

DA10

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SEDIMENT AND EROSION CONTROL NOTES

SEDIMENT AND EROSION CONTROL SHALL BE EFFECTIVELY MAINTAINED AT ALL TIMES DURING THE COURSE OF CONSTRUCTION AND SHALL NOT BE REMOVED UNTIL THE SITE HAS BEEN STABILISED OR LANDSCAPED TO THE PRINCIPAL'S SATISFACTION.

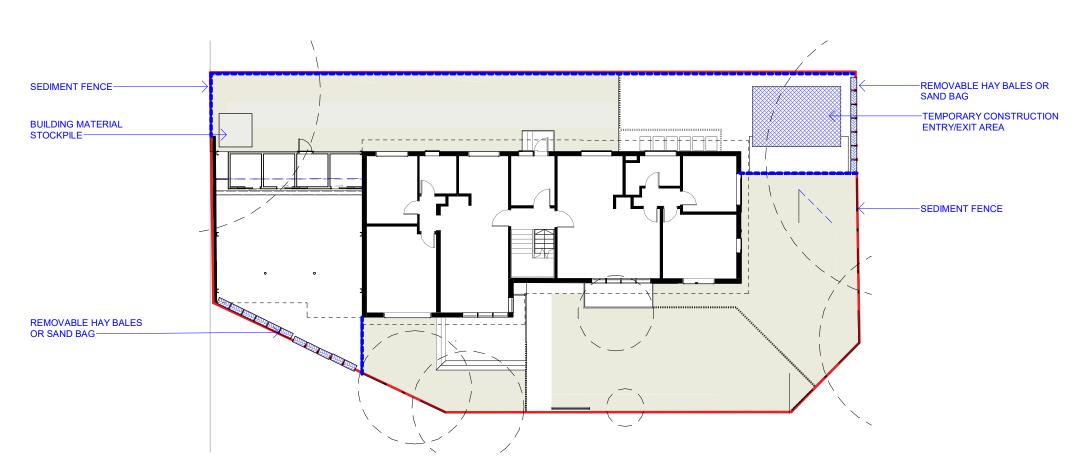A SINGLE ALL WEATHER ACCESS WAY WILL BE PROVIDED WHERE FRONECESSARY CONSISTING OF 50-75 AGGREGATE OR SIMILAR MATERIAL AT A MINIMUM THICKNESS OF 150 LAID OVER NEEDLE-PUNCHED GEOTEXTILE FABRIC AND CONSTRUCTED PRIOR TO COMMENCEMENT OF WORKS.

THE CONTRACTOR SHALL ENSURE THAT NO SPOIL OR FILL ENCROACHES UPON ADJACENT AREAS FOR THE DURATION OF WORKS.

THE CONTRACTOR SHALL ENSURE THAT KERB INLETS AND DRAINS RECEIVING STORMWATER SHALL BE PROTECTED AT ALL TIMES DURING DEVELOPMENT, KERB INLET SEDIMENT TRAPS SHALL BE INSTALLED ALONG THE IMMEDIATE VICINITY ALONG THE STREET FRONTAGE.

SEDIMENT FENCING SHALL BE SECURED BY POST (WHERE METAL STAR PICKETS ARE USED PLASTIC SAFETY CAPS SHALL BE USED) AT 2000 INTERVALS WITH GEOTEXTILE FABRIC EMBEDDED 200 IN SOIL.

ALL TOPSOIL STRIPPED FORM THE SITE AND STOCKPILED DOES NOT INTERFERE WITH DRAINAGE LINES AND STORMWATER INLETS AND WILL BE SUITABLY COVERED WITH AN IMPERVIOUS MEMBRANE MATERIAL AND SCREENED BY SEDIMENT FENCING

SOIL CONSERVATION NOTE:

PRIOR TO COMMENCEMENT OF CONSTRUCTION PROVIDE 'SEDIMENT FENCE," 'SEDIMENT TRAP' AND WASHOUT AREA TO ENSURE THE CAPTURE OF WATER BORNE MATERIAL GENERATED FROM THE SITE.

MAINTAIN THE ABOVE DURING THE COURSE OF CONSTRUCTION, AND CLEAR THE 'SEDIMENT TRAP AFTER EACH STORM.


SEDIMENT TRAP

900 x 900 WIDE 500 DEEP PIT, LOCATED AT THE LOWEST POINT TO THE TRAP SEDIMENT.


TO BE 900 x 900 ALLOCATED FOR THE WASHING OF TOOL & EQUIPMENT.

SANDBAG KERB INLET SEDIMENT TRAP TYPICAL DETAIL

SANDBAG KERB SEDIMENT TRAP IN CERTAIN CIRCUMSTANCES EXTRA SEDIMENT TRAPPING MAY BE NEEDED IN

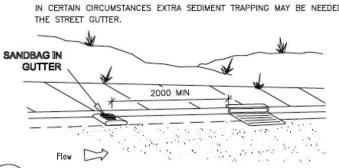


SEDIMENT FENCE **TYPICAL DETAIL**

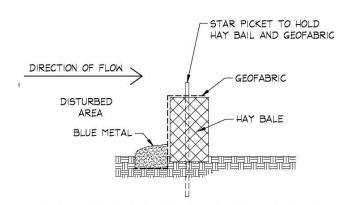

TEMPORARY CONSTRUCTION ENTRY TYPICAL DETAIL

VEHICLE ACCESS TO SITE VEHICLE ACCESS TO THE BUILDING SITE SHOULD BE RESTRICTED TO A SINGLE POINT SO AS TO REDUCE THE AMOUNT OF SOIL DEPOSITED ON THE STREET

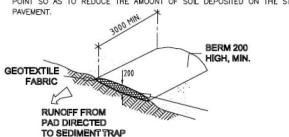

BUILDING MATERIAL STOCKPILES TYPICAL DETAIL

BUILDING MATERIAL STOCKPILES

ALL STOCKPILES OF BUILDING MATERIAL SUCH AS SAND AND SOIL MUST BE PROTECTED TO PREVENT SCOUR AND EROSION.

THE SHOULD NEVER BE PLACED IN THE STREET GUTTER WHERE THEY WILL WASH AWAY WITH THE FIRST RAINSTORM



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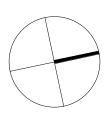
CV

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Scale 1: 200

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Erosion Control Plan

Scale at A3 1:200

2101

Revision Date. 11.05.2022

Project No. Rev No.

C

Drawing No.

DA12


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General Notes

GROUND FLOOR PLAN

Driveway bin storage U3 Carspace Garage & Stairway UNIT 2 UNIT 1 65,40 sqm U1 U2 U4 Carspace Carspace Carspace Balcony Balcony Common garden Common garden D GARDEN SUBDIVISION REMOVED D GARDEN SUBDIVISION REMOVED

FIRST FLOOR PLAN

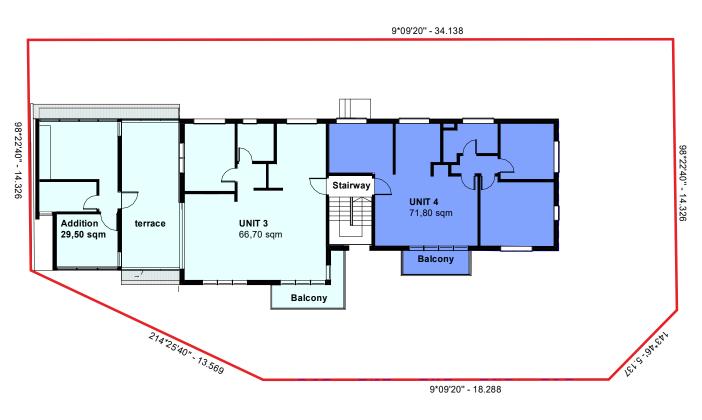

D GARDEN SUBDIVISION REMOVED **UNIT 1 Existing:** 66,70 sqm (718 sq.ft) Balcony: 9,00 sqm Storage: 2,90 sqm TOTAL: 78,60 sqm UNIT 2 Existing: 65,40 sqm (704 sq.ft) Storage: 2,90 sqm TOTAL: 68,30 sqm

UNIT 3

Existing: 66,70 sqm (718 sq.ft) Addition: 29,50 sqm Open space: 33,00 sqm 2,9 qsm

TOTAL: 132,00 sqm


UNIT 4

Existing: 71,80 sqm (773 sq.ft) 56,90 sqm

2,9 qsm Storage:

TOTAL: 131,56 sqm

ROOF ATTIC PLAN

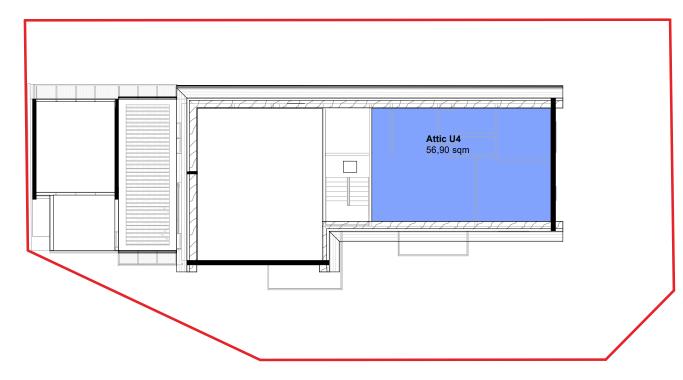

Area Lot Schedule

1:100

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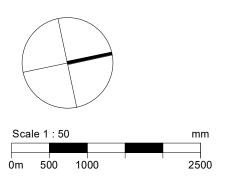
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23.07.2022 Additional information CV С 11.05.2022 Issued for DA CV 02.05.2022 Issued for owner consent CV 27.04.2022 Issued for Information CVΑ REV Date Reason For Issue Chk

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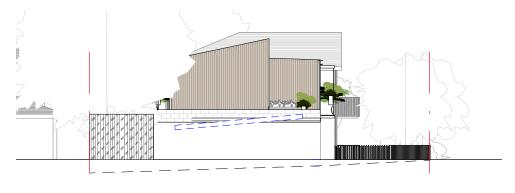
2101

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Proposed Subdivision Plan

Scale at A3 Revision Date. As indicated 23.07.2022 Project No. Rev No. Drawing No.


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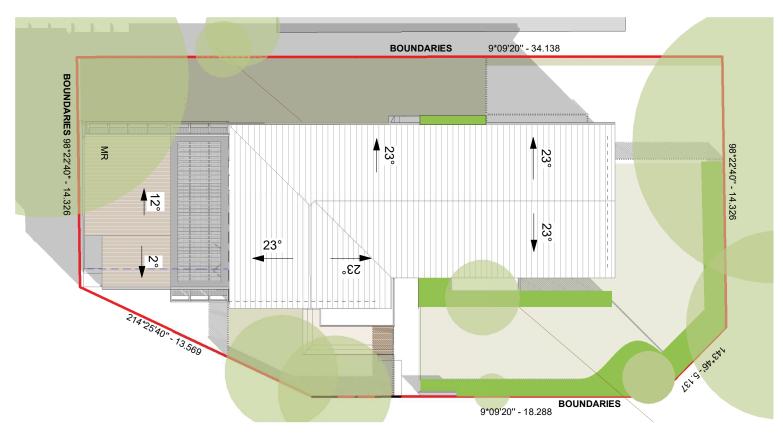
SOUTHERN ELEVATION



NORTH ELEVATION



WESTERN ELEVATION

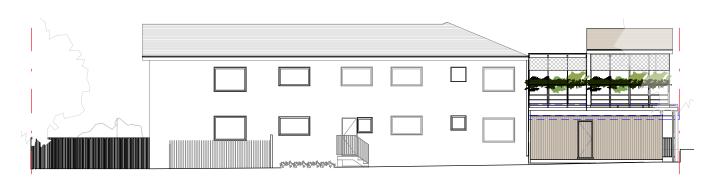

SITE PLAN



EASTERN ELEVATION

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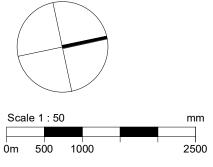
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Notification Plan

Motification Flam					
Scale at A3		Revision Date.			
1:200		11.05.2022			
Project No.	Rev No.	Drawing No.			

