



	SITE DETAILS		
YDRAULIC	LOT NUMBER:	9	
LS	DP NUMBER:	1206507	
	AREAS		
	SITE AREA:	410.08m2	
C	GROUND FLOOR	128.65 m ²	
3	FIRST FLOOR	101.78 m ²	
QUIRED	GARAGE	37.32 m ²	
	PORCH	4.63 m ²	
	Grand total	272.37 m ²	
	DRIVEWAY:	33.37m2	
	SITÉ COVERAGE: PRIVATE OPEN SPACE:	169.86m2 - 41.42% 93.09m2	
	PROJECT DETAILS:		
	GROUND & FIRST FLOOR LIV	ING TOTAL: 230.67m2	
	ROOF AREA: NO, OF BEDROOMS:	199.69m2	
		4	
	LANDSCAPE: TOTAL AREA OF VEGETATION	N: 207.06m2 - 50.49%	
	STORMWATER:		
	RAINWATER TANK SIZE:	= 3000 litre	
	ROOF AREA CONNECTED TO	RAINWATER	
	TANK: (62) % MIN MIN- 12	,	
	RAINWATER USES: GARDEN/TOILET/LAUNDRY		
AHD) FOUND IRRIEWOOD ROAD,	-EXISTING STRUCTURES IN THE PROPOSED BUILDING AREA, TO BE REMOVED BY OWNER -EXISTING FENCING TO BE SECURED BY OWNER, PRIOR TO CONSTRUCTION AND TO REMAIN OUTSIDE OF BUILDING PLATFORM, -EXISTING TREES & VEGETATION TO BE CUT & REMOVED FROM BUILDING AREA PRIOR TO CONSTRUCTION, BY OWNER, -WRITTEN DIMENSIONS TO TAKE PRECEDENCE OVER SCALING, -DIMENSIONS SHOWN ARE TO FRAME, UNDERSIDE OF ROOF TRUSSES AND FROM WINCREST FFL (CONCRETE) TO UNDERSIDE OF FLOOR JOIST -FINISHED OUTLINE OF EXCAVATED AREA IS INDICATIVE ONLY AND WILL VARY ON SITE		
± 0.010m	-ALL RETAINING WALLS ARE BY OWNER U IN THE TENDER - ALL CONSTRUCTION WORK TO		
	AND ALL RELEVANT AUSTRAL	IAN STANDARDS	
	FSR CALCULATIONS		
	SITE AREA:	410.08m2	
	HOUSE AREAS:		
IN	INTERNAL GROUND FLOOR I		
00. _D	INTERNAL TOTAL:	250.16m2	
TAPS.			
	FLOOR SPACE RATIO:	0.61:1	
	NOTE: FSR CALCULATED TO INTER EXTERNAL WALLS AS PER L		
	CASA	BELA INCLUSION	
LOUS	JOB NO: 17398	DATE: 26.09.19	
		CHECKED:	
ROAD		SHEET NO: 01	
	PLEASE DISCARD A		
NCIL			

DO NOT SCALE DRAWING

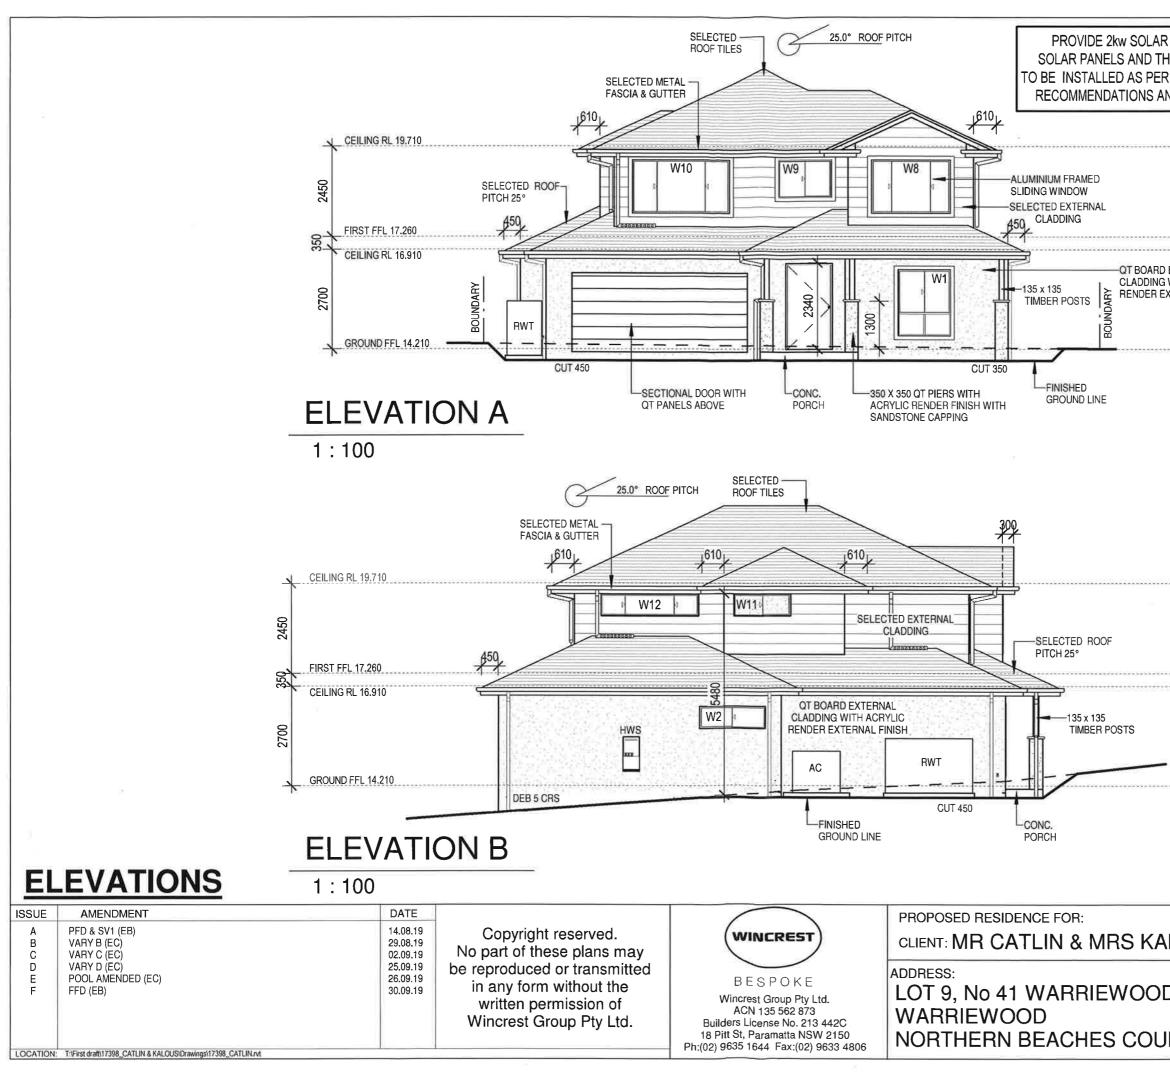


R PV SYSTEM HEIR LOCATIO R MANUFACTU ND GUIDELINE	RES S GROUND FLOC HEIGHT 2166 AS	DR WINDOW HEAD BOVE FFL VALLS @ 45° UNLESS				
EXTERNAL G WITH ACRYLIC EXTERNAL FINISH						
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_		2				
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	CASA	BELA INCLUSIONS				
LOUS	JOB NO: 17398	DATE: 26.09.19				
	DRAWN: EB	CHECKED:				
D ROAD	SCALE: 1:100	SHEET NO: 04				
JNCIL	PLEASE DISCARD	ALL OTHER PLANS				
NOL	DO NOT SCA	LE DRAWING				

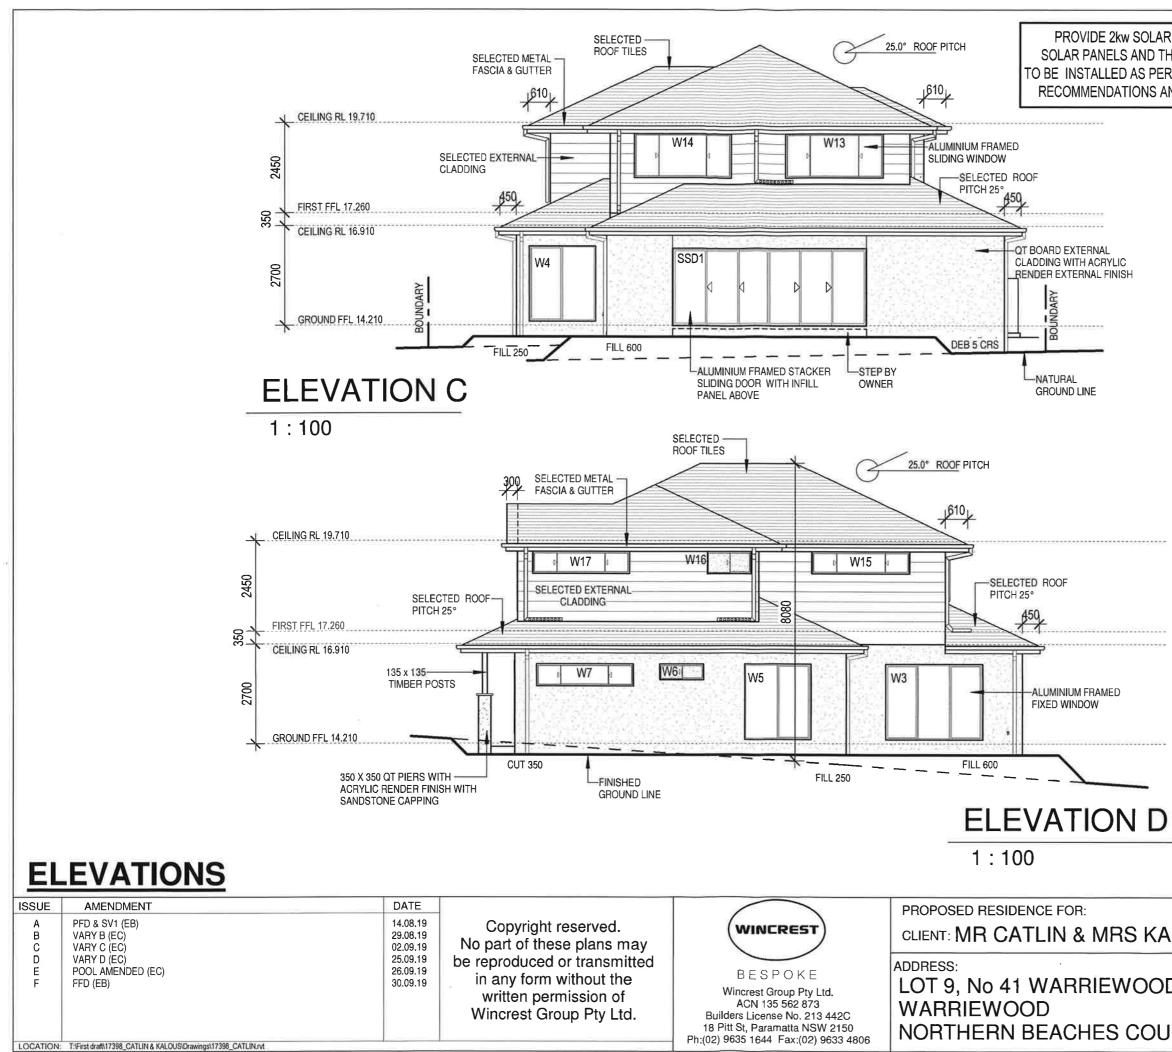


R PV SYSTEM	NOTE:					
HEIR LOCATION R MANUFACTURES ND GUIDELINES	FIRST FLOOR WINDOW HEADS TO BE PLACED DIRECTLY UNDER EAVES OR AT EQUAL HEIGHT					
]	GROUND FLOOR WINDOW HEAD HEIGHT 2166 ABOVE FFL					
	■ALL ANGLED WALLS @ 45° UNLESS NOTED OTHERWISE.					

	CASA BELA INCLUSIONS			
LOUS	JOB NO: 17398	DATE: 26.09.19		
	DRAWN: EB	CHECKED: .		
D ROAD	SCALE: 1 : 100	SHEET NO: 05		
	PLEASE DISCARD ALL OTHER PLANS			
JNCIL	DO NOT SCALE DRAWING			

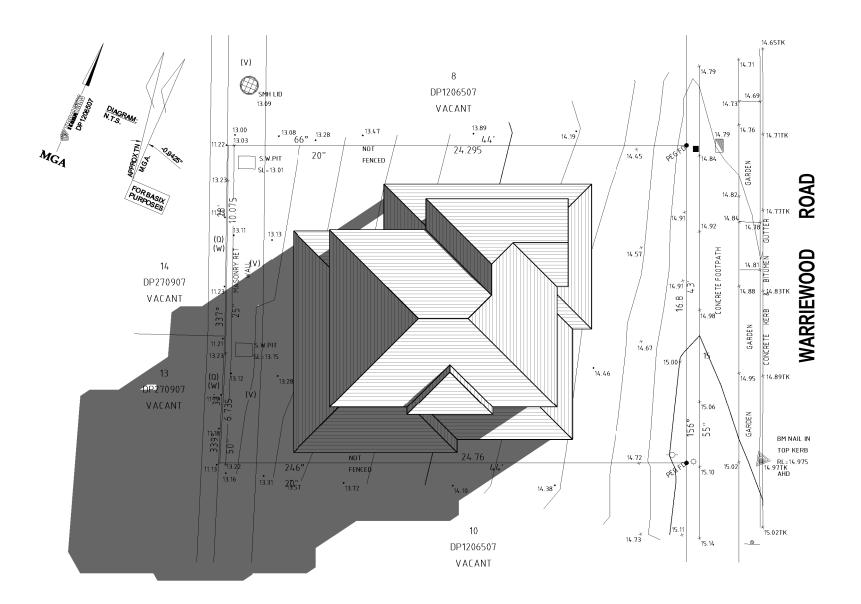


SHADOW DIAGRAM JUNE 21st 9AM

ISSUE	AMENDMENT PFD & SV1 (EB)	DATE 14.08.19	Converse tracer and		PROPOSED RESIDENCE FOR:	CAS/	A BELA INCLUSIONS	
B C	VARY B (EC) VARY C (EC)	29.08.19 02.09.19	Copyright reserved. No part of these plans may	WINCREST	CLIENT: MR CATLIN & MRS KALOUS	JOB NO: 17398	DATE: 26.09.19	
DE	VARY D (EC) POOL AMENDED (EC)	25.09.19 26.09.19	be reproduced or transmitted in any form without the written permission of Wincrest Group Pty Ltd.	in any form without the written permission of Wincrest Group Pty Ltd. Wincrest Group Pty Ltd. Builders License No. 213 442C	BESPOKE		DRAWN: EB	CHECKED: Checker
	FFD (EB)	30.09.19				LOT 9, No 41 WARRIEWOOD ROAD WARRIEWOOD	SCALE: 1 : 200	SHEET NO: 12
					Builders License No. 213 442C 18 Pitt St, Paramatta NSW 2150		PLEASE DISCARD	ALL OTHER PLANS
LOCATION	LOCATION: T:\First draft\17398_CATLIN & KALOUS\Drawings\17398_CATLIN.rvt			Ph:(02) 9635 1644 Fax:(02) 9633 4806	NORTHERN BEACHES COUNCIL	DO NOT SCA	LE DRAWING	

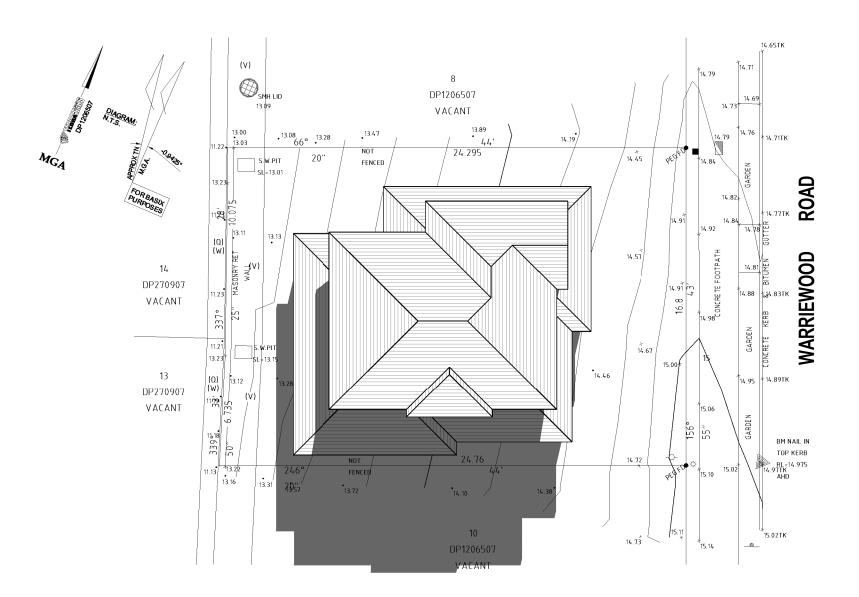


SHADOW DIAGRAM JUNE 21st 12PM

ISSUE	AMENDMENT PFD & SV1 (EB)	DATE 14.08.19	Conversely record		PROPOSED RESIDENCE FOR:	CAS	A BELA INCLUSIONS
BC	VARY B (EC) VARY C (EC)	29.08.19 02.09.19	Copyright reserved. No part of these plans may	WINCREST	CLIENT: MR CATLIN & MRS KALOUS	JOB NO: 17398	DATE: 26.09.19
DE	VARY D (EC) POOL AMENDED (EC)	25.09.19 26.09.19				DRAWN: EB	CHECKED: Checker
	FFD (EB) 30.09.19 Written permission of Wincrest Group Pty Ltd.	Wincrest Group Pty Ltd. ACN 135 562 873	LOT 9, No 41 WARRIEWOOD ROAD WARRIEWOOD	SCALE: 1:200	SHEET NO: 13		
			Builders License No. 213 442C 18 Pitt St. Paramatta NSW 2150		PLEASE DISCARD	ALL OTHER PLANS	
LOCATION:	T:\First draft\17398_CATLIN & KALOUS\Drawings\17398_CATLIN.rvt			Ph:(02) 9635 1644 Fax:(02) 9633 4806	NORTHERN BEACHES COUNCIL	DO NOT SCA	LE DRAWING

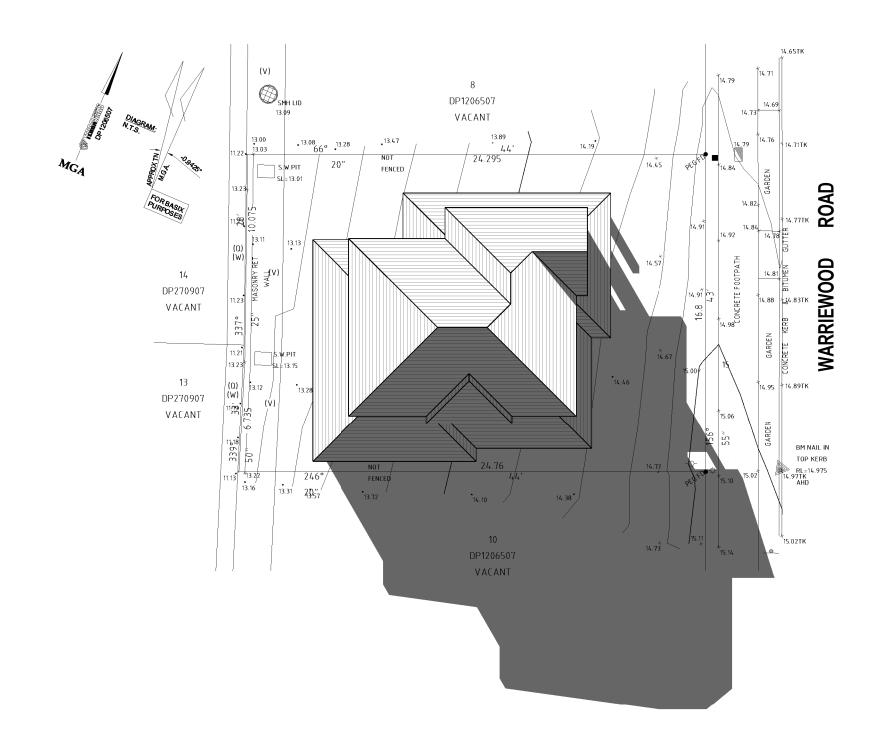

SHADOW DIAGRAM JUNE 21st 3PM

ISSUE	AMENDMENT PFD & SV1 (EB)	DATE 14.08.19	O a municipation and a municipation of the		PROPOSED RESIDENCE FOR:	CAS	A BELA INCLUSIONS		
BC	VARY B (EC) VARY C (EC)	29.08.19 02.09.19	Copyright reserved. No part of these plans may	WINCREST	CLIENT: MR CATLIN & MRS KALOUS	JOB NO: 17398	DATE: 26.09.19		
DE	VARY D (EC) POOL AMENDED (EC)	25.09.19 26.09.19	be reproduced or transmitted in any form without the written permission of	in any form without the written permission of	in any form without the written permission of			DRAWN: EB	CHECKED: Checker
	FFD (EB)	30.09.19				written permission of	written permission of	written permission of	tten permission of Wincrest Group Pty Ltd. ACN 135 562 873
		Wincrest Group Pty Ltd.	t Group Pty Ltd. Builders License No. 213 442C 18 Pitt St. Paramatta NSW 2150		PLEASE DISCARD	ALL OTHER PLANS			
LOCATION:	ON: T:\First draft\17398_CATLIN & KALOUS\Drawings\17398_CATLIN.rvt		Ph:(02) 9635 1644 Fax:(02) 9633 4806	NORTHERN BEACHES COUNCIL	DO NOT SC	ALE DRAWING			

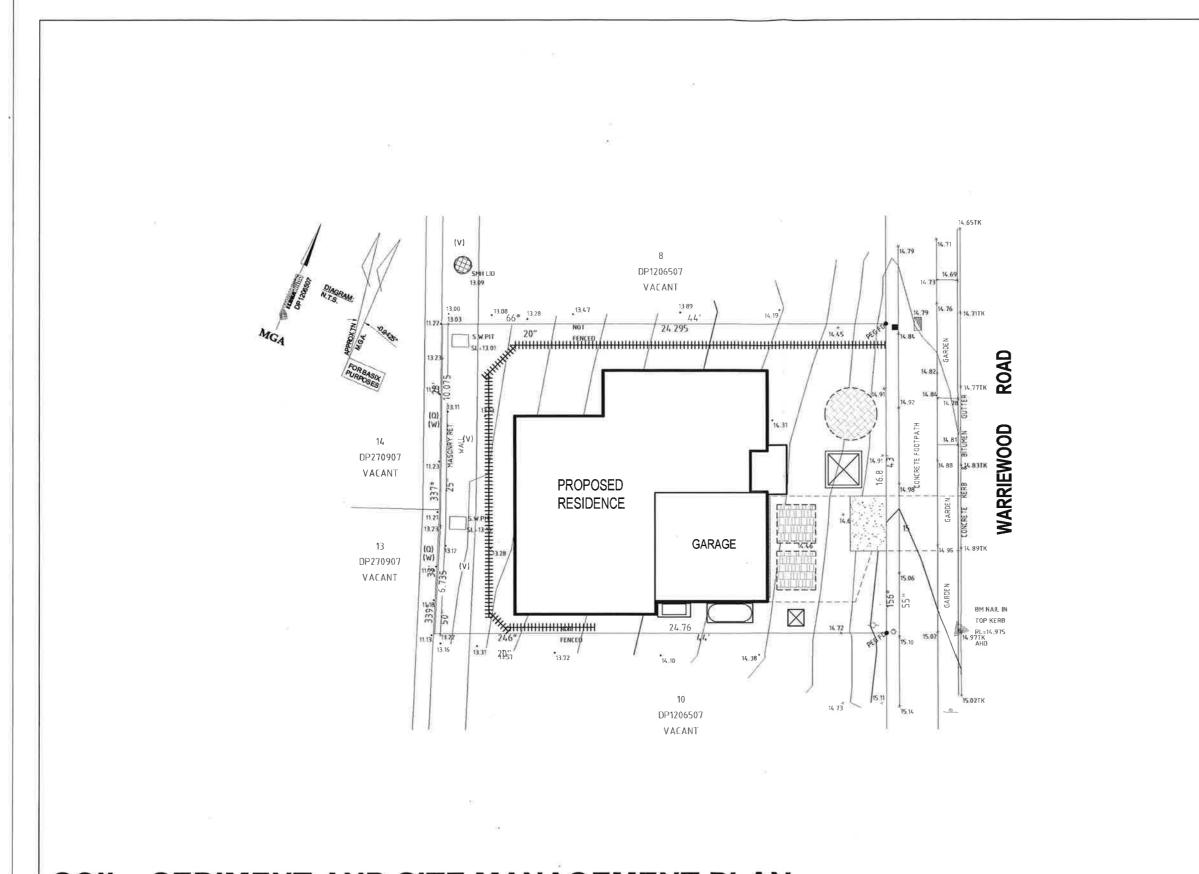

SOIL, SEDIMENT AND SITE MANAGEMENT PLAN

ISSUE	AMENDMENT	DATE			PROPOSED RESIDENCE FOR:	CA	SA BELA INCLUSIONS			
A B C	PFD & SV1 (EB) VARY B (EC) VARY C (EC)	14.08.19 29.08.19 02.09.19	No part of these plans may be reproduced or transmitted	No part of these plans may be reproduced or transmitted in any form without the written permission of		CLIENT: MR CATLIN & MRS KALOUS	JOB NO: 17398	DATE: 26.09.19		
D E	VARY D (EC) POOL AMENDED (EC)	25.09.19 26.09.19			be reproduced or transmitted in any form without the	be reproduced or transmitted in any form without the	be reproduced or transmitted in any form without the written permission of be reproduced or transmitted in any form without the wincrest Group Pty Ltd. BESPOKE Wincrest Group Pty Ltd. ADDRESS: LOT 9, No 41 WARRIEWOOD RO		DRAWN: EB	CHECKED: Checker
F	FFD (EB)	30.09.19							written permission of Wincrest Group Pty Ltd.	
	T:\First draft\1739B_CATLIN & KALOUS\Drawings\1739B_CATLIN.rvt	18	Builders License No. 213 442C 18 Pitt St, Paramatta NSW 2150 Ph:(02) 9635 1644 Fax:(02) 9633 4806	WARRIEWOOD NORTHERN BEACHES COUNCIL	PLEASE DISCARD ALL OTHER PLANS					
LOCATION					DO NOT SO	ALE DRAWING				

LEGEND



Material Stockpile area.



Waste stockpile & material sorting area.



Storage recycling bins for segregated waste.



Chemical toilets.




Temporary builders d/way to E.P.A. requirements.



Fit standard 600 high green silt fence (refer to detail).


Trees to be removed.


NOTE: All waste materials to be taken to an approved waste disposal site.

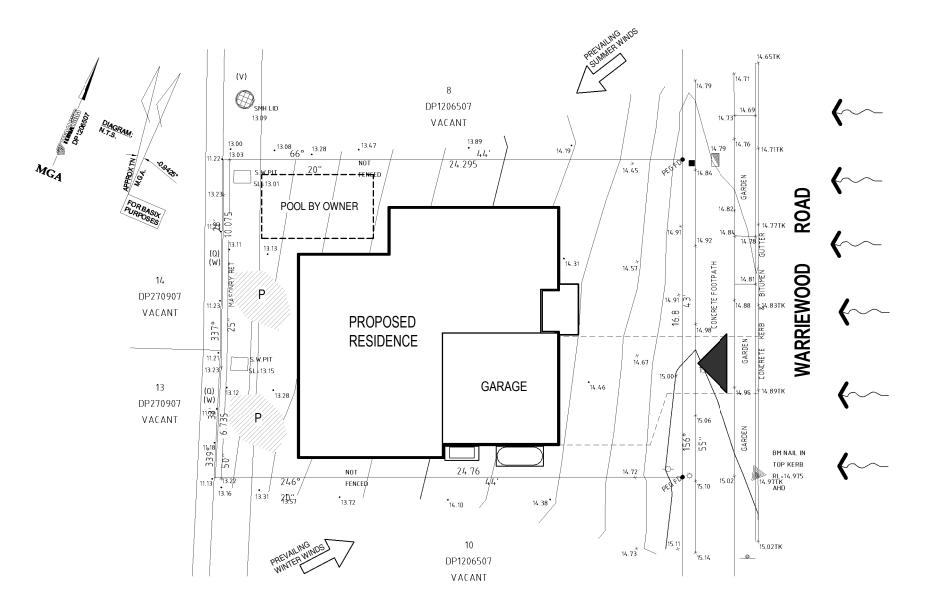


SITE ANALYSIS

	AMENDMENT DATE PFD & SV1 (EB) 14.08.1			PROPOSED RESIDENCE FOR:	CAS	A BELA INCLUSIONS
BC	VARY B (EC) 29.08.1 VARY C (EC) 02.09.1		WINCREST	CLIENT: MR CATLIN & MRS KALOUS	JOB NO: 17398	DATE: 26.09.19
DE	VARY D (EC) 25.09.1 POOL AMENDED (EC) 26.09.1	in any form without the		ADDRESS: LOT 9, No 41 WARRIEWOOD ROAD WARRIEWOOD	DRAWN: EB	CHECKED: Checker
F	FFD (EB) 30.09.1	written permission of	Wincrest Group Pty Ltd. ACN 135 562 873		SCALE: 1:200	SHEET NO: 16
		Wincrest Group Pty Ltd.	Builders License No. 213 442C 18 Pitt St. Paramatta NSW 2150		PLEASE DISCARD	ALL OTHER PLANS
LOCATION:	T:\First draft\17398_CATLIN & KALOUS\Drawings\17398_CATLIN.rvt		Ph:(02) 9635 1644 Fax:(02) 9633 4806	NORTHERN BEACHES COUNCIL	DO NOT SCA	LE DRAWING

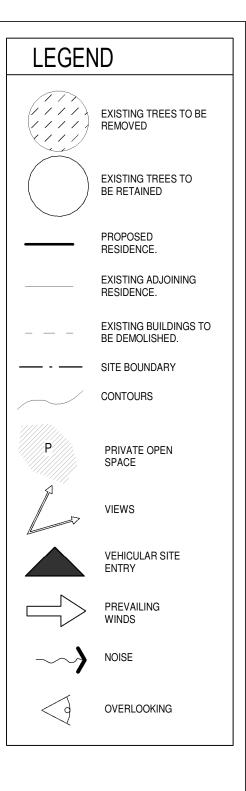


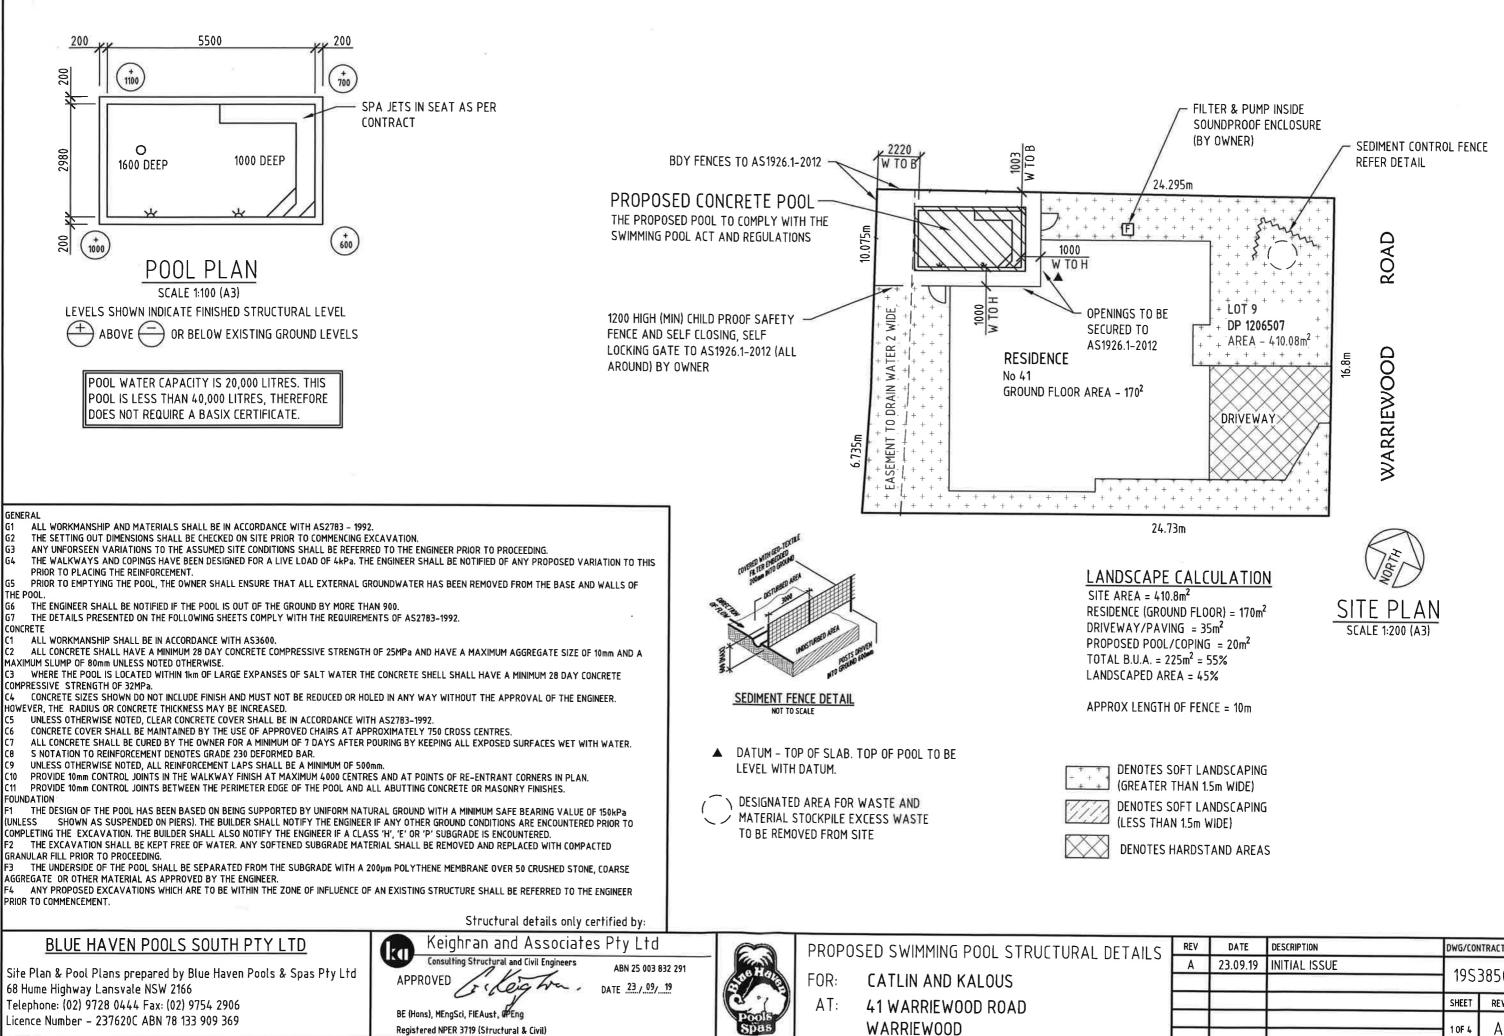

DATE	DESCRIPTION	DWG/COM	NTRACT No
23.09.19	INITIAL ISSUE	195	3850
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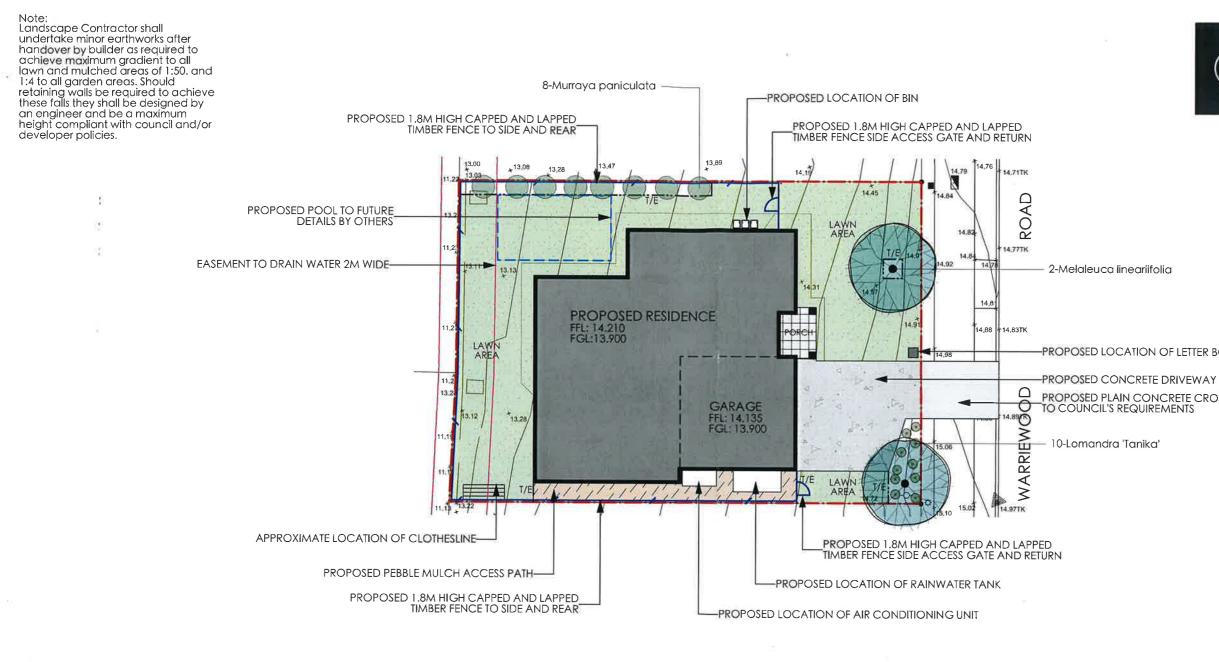
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1	NOTE: THESE DETAILS ARE GENERIC AND DO NOT FORM PART OF YOUR CONTRACT	4	150 Î
	Y ISOU MAX Y ISOU MAX Y	MIN 76¢ SCREW PILE WITH MIN SAFE WORKING LOAD OF 60kN	S12-150 CENTRAL EACH WAY OVER BASE 300 DIA 300
	S12-150 EACH WAY CENTRAL OVER BASE. TERMINATE ALTERNATE BARS 600 UP WALL	S12-150 EACH WAY CENTR BASE. TERMINATE ALTERI 600 UP WALL	
	<u>PART PLAN – OPTION 1</u> 2250 MAX 2250 MAX 2250 MAX	x PART PLAN - OPTION 3	
		S12 DOWEL x 300 LONG	MIN 76Ø SCREW PILE TO BE CERTIFIED BY SUPPLIER FOR A MIN SAFE WORKING LOAD OF 60kN
	ZZ50 MAX	SCREW PIL 1:20	GREASE PLATE
	S12-300 EACH WAY BTM	S12-200 EACH WAY TOP	HYDROSTATIC VALVE 450 DIA PIERS AT MAX 2250 x 2250 CTS ROCK
	<u>PART PLAN - OPTION 2</u> SUSPENDED POOL PLANS	HYDROS	CONCRETE ENCASE SEWER 150 ALL AROUND
	1:50 <u>PIERS</u> F'c = 20 MPa 60 COVER TO REINFORCEMENT UNLESS NOTED OTHERWISE, PIERS TO BE FOUNDED IN UNIFOR BEARING VALUE OF 800 kPa. REFER TO THE ENGINEER IF DEP	VALVE C 1:20 PTH OF PIERS EXCEEDS 3000 Structural details only certified by:	
	BLUE HAVEN POOLS SOUTH PTY LTD Site Plan & Pool Plans prepared by Blue Haven Pools & Spas Pty Ltd 68 Hume Highway Lansvale NSW 2166 Telephone: (02) 9728 0444 Fax: (02) 9754 2906 Licence Number - 237620C ABN 78 133 909 369	Keighran and Associates Pty Ltd Consulting Structural and Civil Engineers ABN 25 003 832 291 APPROVED AFF APPROVED AFF AFF APPROVED AFF APPROVED AFF AFF APPROVED AFF AFF AFF APPROVED AFF AFF APPROVED AFF AFF AFF AFF AFF AFF AFF AFF AFF AF	PROPOSED SWIMMING POOL STRUCTURAL DETAILS FOR: CATLIN AND KALOUS AT: 41 WARRIEWOOD ROAD WARRIEWOOD
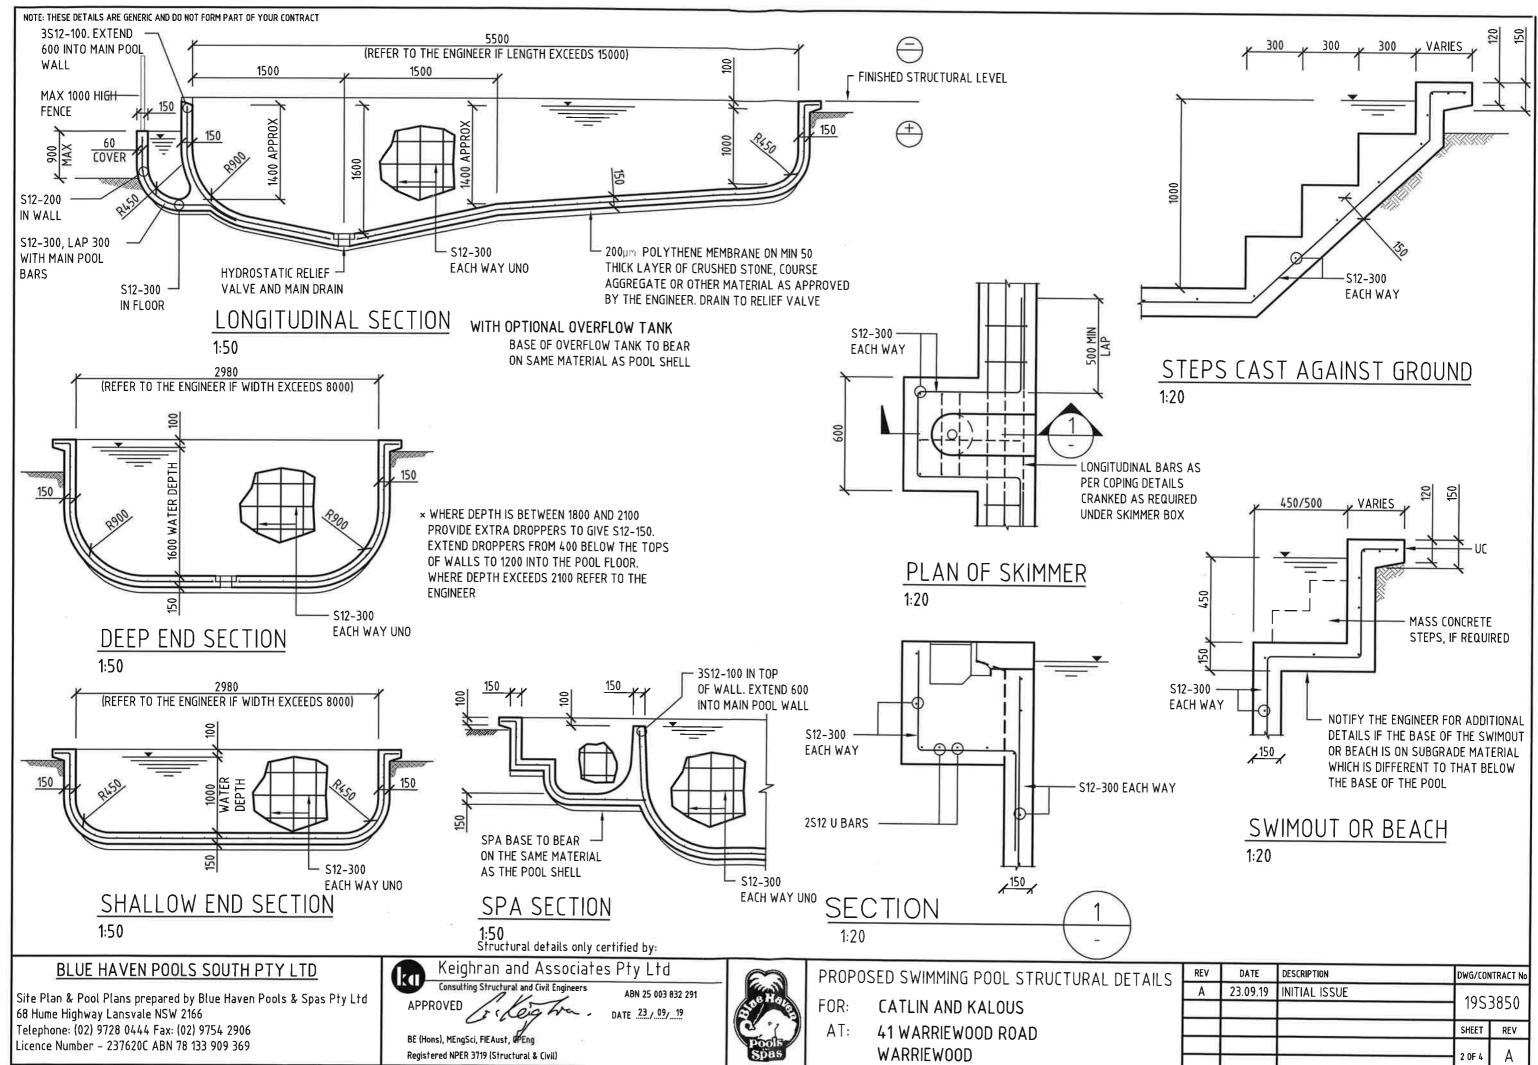
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WA WA		50 DIA PIER EINFORCE WITH 0-200 TIES	1 6S12,		
CTION	(2			
S12 DOWEL × 300 LONG NE LE 1500 MAX	S12-150 CEN EACH WAY OVER BASE	REW PILE			
TION 3					
450 DIA PIERS AT MAX 1200 x 1200 CTS TO CLAY OR SAND ZONE OF INFLUENCE - CLAY 1 ZONE OF INFLUENCE - SAND, FILLED GROUND OR LOAM					
IG OVER SY	<u>'DNEY WA1</u>	ER SEV	WER		
MUM SAFE BEARING VALUE OF 200kPa UM SAFE BEARING VALUE OF 800kPa PER SUSPENDED POOL FOR RELEVANT PIER SPACING					
REV DATE	DESCRIPTION		DWG/COM	ITRACT No	
A 23.09.19	INITIAL ISSUE				
				3850	
			SHEET	REV	
			4 OF 4	A	

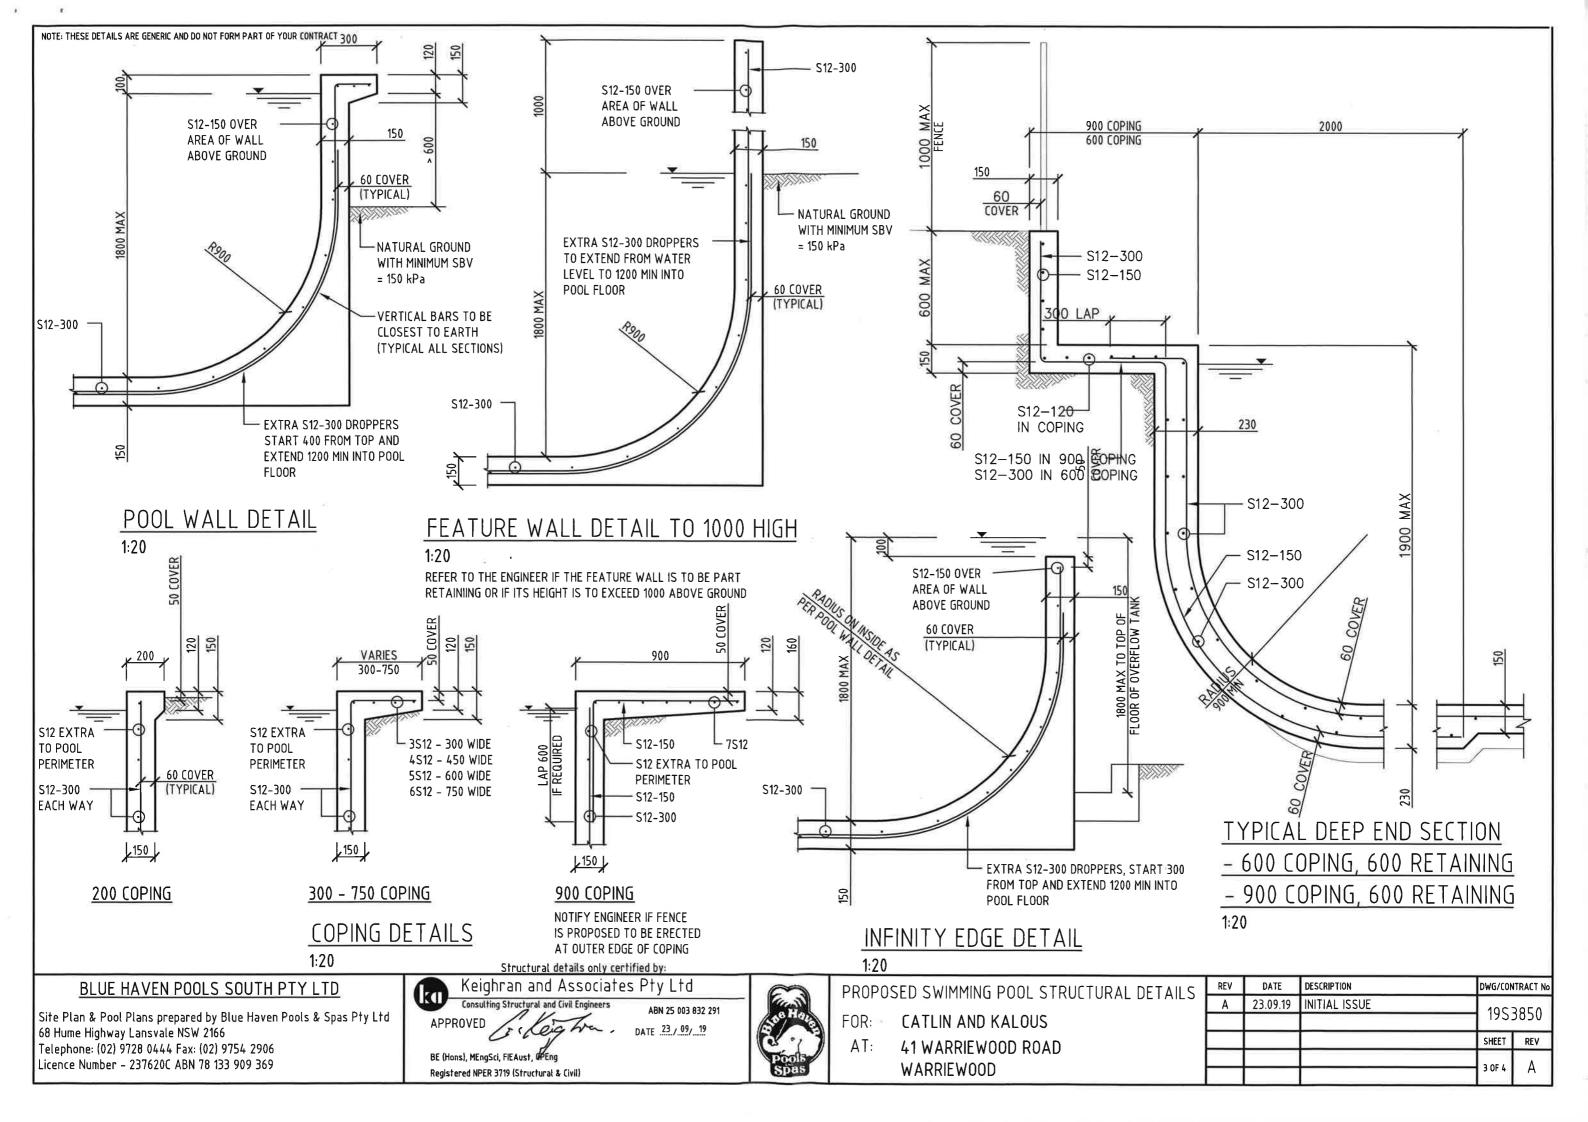

PLANTING SCHEDULE

Latin Name	Common Name	Quantity	Scheduled Size	Spread	Height
Lomandra 'Tanika'	Dwarf Lomandra	10	5lt	500	500
Melaleuca lineariifolia	Snow In Sumer	2	45lt	5000	10000
Murraya paniculata	Orange Jessamine	8	250mm	1200	2500

Legend			Notes	Revision	Description	Date	DATE REVISION
			All dimensions and levels shall be verified by Contractor on site prior to commencement of work.				PROPOSED LANE
	PROPOSED PAVED AREA	PROPOSED 1.8m HIGH CAPPED AND LAPPED TIMBER FENCE	 All detailing of drainage to paved areas shall be by others. All levels shall be determined by others and approved on site by client. 				ADDRESS LOT 9, NO.41 WARRIE
- Angel	PROPOSED LAWN AREA		 Extent, height and position of all retaining walls shall be determined by others and approved on site by client, to Structural Engineers detail. 				
	PROPOSED PEBBLED MULCH ACCESS PATH		5. Do not scale from drawings. 6. If in doubt contact the Landscape Architect. 7. All boundaries shall be surveyed prior to commencement				MR CATLIN & MRS K
	PROPOSED CONCRETE CROSSOVER	SITE BOUNDARY	 All obtained in a single destine year and to commence them in of construction works. This plan is for DA purposes only, it has not been detailed for construction. All dimensions, levels and boundaries are nominal only. 				A Total Concept Landsc Swimming Pool Designers
	PROPOSED CONCRETE DRIVEWAY		 All amensions, levels and boundaries are normal only. This design shall not be copied, utilised or reproduced in any way without prior written permission of A Tatol Concept Landscape Architects. 				65 West Street, North Sydney NSW 2 Tel: (02) 9957 5122 Fx: (02) 9957 592



-PROPOSED LOCATION OF LETTER BOX


PROPOSED PLAIN CONCRETE CROSS-OVER TO COUNCIL'S REQUIREMENTS





IDSCAPE PLAN

PROJECT # WINCREST HOMES RIEWOOD ROAD, WARRIEWOOD DATE # 09/10/19 DWG# KALOUS SCALE @ A3 1:200 L/01 DRAWN SX scape Architects & CHKD JC REVISION W 2060 5922 atc

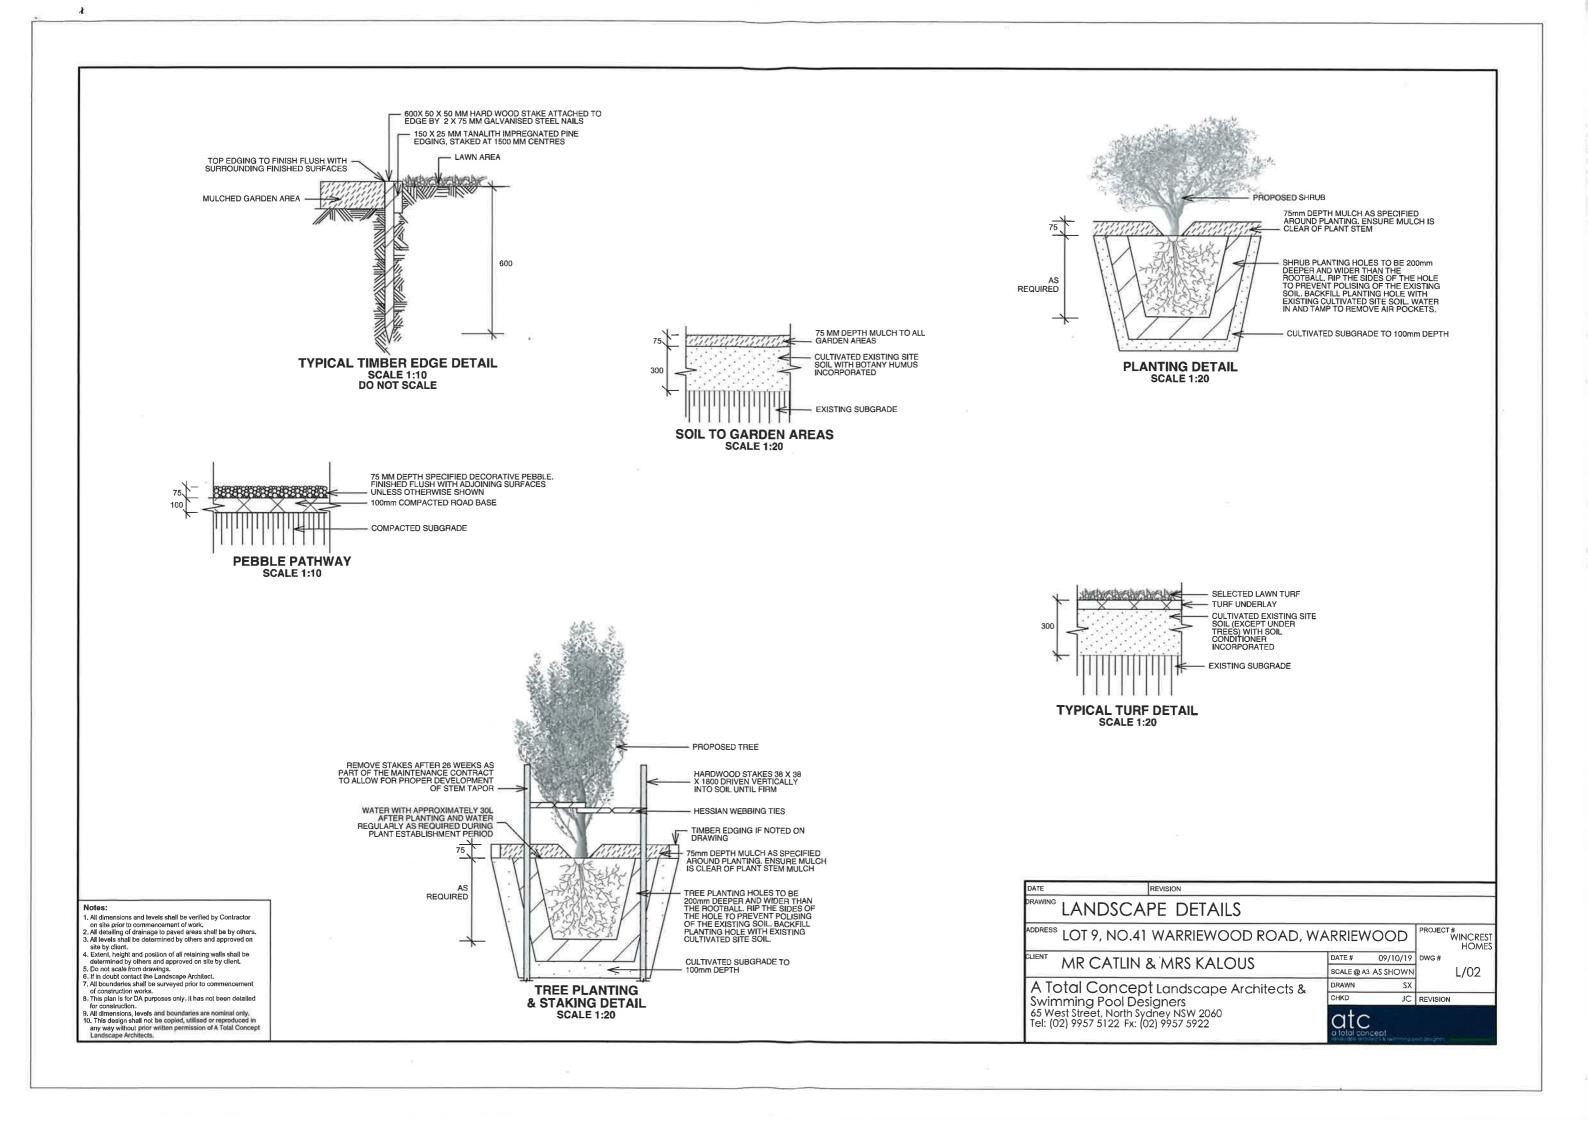

OUTLINE LANDSCAPE SPECIFICATION

d.

Preparation by Builder: Builder shall remove all existing concrete pathways, fences, footings, walls etc. not notated to be retained and complete all necessary excavation work prior to commencement on site by Landscape Contractor (Contractor). Builder shall also install new retaining walls, kerbs, layback kerb, crossover, pathways etc. and make good all existing kerbs, gutters etc. as necessary and to approval of Council. Builder shall ensure that a minimum 450mm of topsoil in garden areas and a minimum 150mm of topsoil in lawn areas exists. Should required depths not exist Builder shall contact Landscape Architect and ask for instructions prior to completion of excavation works. Excavate as necessary, then fill with approved site topsoil to allow for minimum 500mm soil depth in garden areas and 150mm soil depth in lawn areas and to gain required shapes & levels. Ensure all garden and lawn areas drain satisfactorily. All

levels & surface drainage shall be determined by others & approved on site by Head Contractor. Note: Approved imported topsoil mix may be utilised if there is insufficient site topsoil available. State in Tender a m3 rate for additional imported topsoil and the quantities of both site topsoil and imported topsoil allowed for in Tender.

Initial Preparation: Verify all dimensions & levels on site prior to commencement. Do not scale from drawings. Locate all underground & above ground services & ensure no damage occurs to them throughout contract. Spray approved weedicide to all proposed lawn & garden areas to manufacturer's directions. Remove existing concrete pathways, footings, walls etc. not notated to be retained & weeds from site. Levels indicated on Plan are nominal only and are derived from Architectural Plans & Drawings by others. Final structural integrity of all items shall be the sole responsibility of Landscape Contractor.

Tree Protection: Trees to be retained shall be protected during site works and construction by the erection of solid barricades to the specification of Council. Storage of machinery or materials beneath canopy of trees to be retained shall not be permitted. Changes to soil level and cultivation of soil beneath canopy of trees to be retained shall not be permitted unless under direct supervision of Landscape Architect. Existing trees shall be pruned to Landscape Architects on site instructions. permitted. Changes to soil level and cultivation of soil beneath canopy of trees to be retained shall not be permitted unless under direct supervision of Landscape Architect. Existing trees shall be pruned to Landscape Architects onsite instructions. **Soil Preparation:** Cultivate to depth of 300mm all proposed lawn & garden areas incorporating minimum 100mm depth of organic clay breaker into existing site soil. Do not cultivate beneath existing trees to be retained. In areas where excavation is required (if in clay) over excavate as required to to allow for installation of 500mm depth of premium grade topsoil mix to garden areas and 300mm depth of premium grade topsoil mix to lawn areas. Undertake all required action to ensure that no rootballs of proposed plants sit in clay wells and that all garden areas and lawn areas drain satisfactorily. Note it is intended that wherever possible existing levels shall not be altered through garden and lawn areas. It is the Contractors responsibility to ensure that the end result of the project is that all lawn and garden areas drain sufficiently (both surface & subsurface), are at required finished levels and have sufficient soil depths to enable lawn and plants to thrive and grow. Should alternative works to those specified be required to achieve the above result, Contractor shall inform Builder at time of Tender and request instructions. **Lawn Edging and Stepping Stones:**(i) 125 x 25mm approved tanalith impregnated pine edging shall be installed, to lines as indicated on plan and staked with approved stakes at maximum 1500mm centres at ends on edge on a minimum 100mm depth of edging. **(ii)**Contractor shall install approved bricks on edge on a minimum 100mm depth of edging. **(ii)**Contractor shall install approved bricks on edge on a minimum 100mm depth of edging. **(ii)**Contractor shall install approved bricks on edge on a minimum 100mm depth of edging. **(iii)**Contractor shall install approved bricks on edge on a minimum 100mm depth of edging. **(iii)**Contractor shall inst deep x 90mm wide concrete footing with brick tor set in, to lines nominated on plan as brick edging. Bricks shall be laid with a nominal 10mm wide approved coloured mortar joint. Bricks needing to be cut shall be done so with clean sharp cuts. Top of edging shall finish flush with surrounding finished surfaces. Approved sandstone stepping stones shall be positioned as indicated on plan on a 25mm river sand bed. Approved sandstone stepping stones shall be positioned as indicated on plan on a 25mm river sand bed.

Retaining Walls: Positions, detail and heights of retaining walls shall be by others.

Planting: Purchase plants from an approved nursery. Plants to be healthy & true to type & species. Set out plants to positions indicated on plan. Following approval, plant holes shall be dug approximately twice width and to 100mm deeper than plant rootballs that they are to receive. Base and sides of hole shall be further loosened. Fertiliser, followed by 100mm depth of topsoil mix shall then be placed into base of hole and lightly consolidated. Base of hole shall then be watered. Remove plant container and install plant into hole. Rootball shall be backfilled with surrounding topsoil and topsoil firmed into place. An approved shallow dish shall be formed to contain water around base of stem. Base of stem of plant shall finish flush with finished soil level. Once installed plant shall be thoroughly watered and maintained for the duration of the Contract.

Staking: All trees shall be staked using 2 x 38mm x 38mm x 2000mm long hardwood stakes per plant and with hessian webbing ties installed to Landscape Architect's on site instructions. Mulching: Install 75mm depth of 25mm diameter hardwood mulch to all garden areas, coving mulch down around all plant stems & to finish flush with adjacent surfaces.

Turfing: Prepare for, level & lay cultivated Palmetto Buffulo turves to all areas nominated on plan as being lawn. Roll, water, fertilise, mow & maintain lawns as necessary until completion of maintenance period. At same time make good all existing lawn areas using same lawn type. Lawns in shade shall be over sown with an approved seed mix. Allow to retrim and returf councils nature strip as required. Fencing: Retain all existing fences unless advised otherwise by builder. Install timber paling fences to heights indicated on Plan.

Paving: Areas to be paved shall be excavated or filled to allow for installation of bedding materials. Levels and falls shall be as per Plan. Surface drainage on paving shall be towards grated drains with all drains connected to stormwater system and installed by Builder.

Irrigation: Contractor shall supply and install an approved fully automatic, vandal resistant, computerised irrigation system to all garden and lawn areas, excluding council nature strip. Entire system shall be to approval of Water Board and shall utilise pop-up sprinklers and electronic controllers. Contractor shall be responsible to ensure that system is able to satisfactorily operate on available water pressure. Power supply for use by irrigation system shall be provided to an approved location near southwest corner of residence by others and shall consist of an approved weatherproof G.P.O. The irrigation system controller shall be housed in an approved waterproof cabinet mounted to external wall of residence. Clotheslines: Contractor shall allow for all necessary labour and materials and shall install clotheslines to positions as indicated on plan to manufacturer's instructions to approval of Landscape Architect. Clothesline type shall be equal to 'Hills Foldaline'

Completion: Prior to practical completion remove from site all unwanted debris occurring from work. Satisfy Council that all landscaping work has been undertaken in strict accordance with Councils landscape codes & guidelines.

Maintenance Period: A twelve month maintenance period shall be undertaken by owner or owners representative as set out herein. Owner shall have care and maintenance of all work specified under this Contract and shall rectify any defective work for a period of 52 weeks following Practical Completion of Landscape Works. This period shall be herein known as the Maintenance Period. Work shall also include for the care and maintenance of all existing vegetation to be retained and proposed vegetation. Site shall be attended at least weekly and as otherwise required. The following works shall be undertaken during the Maintenance Period.

(a) Recurrent works Undertake recurrent works throughout the Maintenance Period. These works shall include but are not limited to watering, weeding, fertilising, pest and disease control, returfing, staking and tying, replanting, cultivation, pruning, aerating, renovating, top dressing and the like,

(b) Watering Regularly water all plants and lawn areas to maintain optimal growing conditions. Contractor shall adjust the water quantity utilised with regard to climatic conditions prevalent at the time.

(c) Replacements Immediately replace plants which die or fail to thrive (at discretion of Landscape Architect) with plants of same species or variety and of same size and quality unless otherwise specified. Plant replacement shall be at Contractors expense, unless replacement is required due to vandalism or theft, which shall be determined by Landscape Architect. Required replacement of plants due to vandalism or theft shall be undertaken by Contractor and shall be paid for by Client at an agreed predetermined rate.

(d) Mulched surfaces Maintain mulched surfaces in clean, tidy, weed-free condition and shall reinstate mulch as necessary to maintain specified depths.

(e) Stakes & ties Adjust and/or replace stakes and ties as required. Remove stakes and ties at end of Maintenance Period if directed by Landscape Architect.

(f) Lawn areas Lawn areas shall be mown at regular intervals to ensure non heading of lawn with a fine-cutting mulching mower and clippings left on lawn to mulch and self-fertilise lawn areas. Primary cut after laying of lawn by others shall be determined on site taking into consideration season, watering and growth rate of lawn. Following the primary cut all lawns shall be regularly mown as required to ensure a healthy lawn and a neat appearance. Care shall always be taken to ensure that no clippings are left on surrounding roads or garden areas after mowing. Replace lawn areas that fail to thrive at discretion of Landscape Architect. All new and made good lawn areas shall be barricaded off from pedestrian traffic by use of star pickets and brightly coloured plastic safety mesh until establishment of lawn. Barricades shall be removed upon establishment of lawn area.

(g) Weeding Remove by hand, or by carefully supervised use of weedicide, any weed growth that may occur throughout Maintenance Period. This work shall be executed at weekly intervals so that all lawn and garden areas may be observed in a weed-free condition.

(h) Pruning Prune new and existing plants (excluding existing trees) as necessary to maintain dense foliage conditions. Any rogue branches, or branches overhanging or obstructing pathways, roads, doorways, etc., shall be removed by approved horticultural methods.

(i) Spraying Spraying for insect, fungal and disease attack shall be undertaken as required and in accordance with spray manufacturers recommendations at intervals taking into account the season of year during which landscape works are to be implemented.

(j) Tree Care Should any existing trees be damaged during construction works immediately engage an experienced arboriculturist and then undertake any rectification work recommended by arboriculturist.

prawing LANDSCAPE SPE
ADDRESS LOT 9, NO.41 WARRIE
MR CATLIN & MRS K
WIN OF TEILY OF WIND IN
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A Total Concept Lands
Swimming Pool Designers
65 West Street, North Sydney NSW
Tel: (02) 9957 5122 Fx: (02) 9957 59


ECIFICATION

WINCREST EWOOD ROAD, WARRIEWOOD HOME DATE # 09/10/19 DWG # **KALOUS** SCALE @ A3 N/A L/03 RAWN SX Iscape Architects & CHKD JC REVISION W 2060 5922 atc

External Colour Selection Schedule

for: Lot 9, #41 Warriewood Road, Warriewood


WINCREST BESPOKE

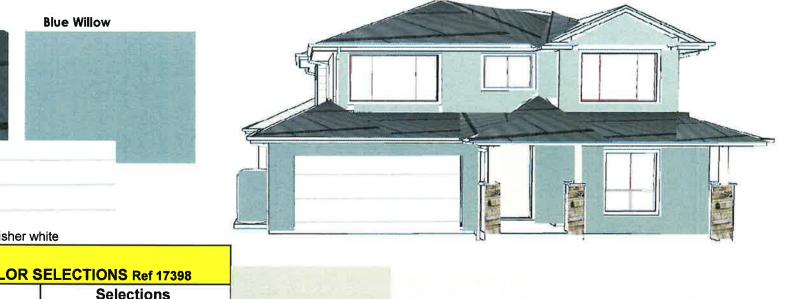

Perisher white

Boral Contour Shale

Details	Selections		
Tiled Roof	Boral Contour Shale		
Fascia/Gutters	Surfmist		
Dowpipes	Blue Willow /Babbling Stream		
Rainwater tank	Blue Willow		
Post & Column	Brilliant white & sandstone		
Garage door	Perisher white		
Front door	Brilliant White		
Cladding	Babbling Stream		
Render	Blue Willow		
Windows	Pearl white		

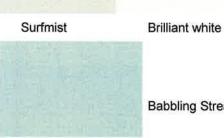



Sandstone

Babbling Stream