

S4.55 LIST OF AMENDMENTS:

1. BUILDING RAISED 170MM TO ALIGN WITH EXISTING RIDGE LEVEL TO INCREASE CEILING HEIGHTS AND IMPROVE AMENITY OF UNITS,

NEGLIGIBLE IMPACTS ON NEIGHBOURS' VIEWS

2. CAR STACKER REMOVED AND REPLACED BY TANDEM CAR SPACES
TO REDUCE EXCAVATION AND IMPACT ON NEIGHBOURS 3. RAMP ADJUSTED TO ADDRESS COUNCIL CONDITION OF EXTENDED MEDIAN STRIP

MEDIAN STRIP.

4, LAY-OUT OF UNIT 1 AMENDED TO SUIT REMOVAL OF CAR STACKER
AND IMPROVE ACCESS TO DAYLIGHT AND NATURAL VENTILATION, RESULTING IN NO INCREASE IN FSR NOR ANY IMPACT TO NEIGHBOURS 5. ENTRY STAIR REALIGNED TO IMPROVE PRIVACY TO UNIT 1,

SUBSEQUENT CHANGES TO BALCONY OF UNIT 1
6. BALCONY SOFFITS LOWERED TO 2400MM ABOVE FFL TO HIDE DRAINAGE AND STRUCTURE

7. ADJUSTMENTS TO EXTERNAL FINISHES AND MINOR ADJUSTMENTS TO WINDOWS


8. CAR PARK EXHAUST REDESIGNED TO BE INCORPORATED IN THE REAR FENCE AS PER COUNCIL'S AND NEIGHBOURS' WISHES 9. CLERESTORY TO UNIT 1 REPLACED BY A SKYLIGHT FOR IMPROVED

10. OSD TANK RELOCATED TO SUIT NEW ENTRY STAIR DESIGN

11. SKY LIGHT ADDED TO ENSUITE ON LEVEL 3

NathERS Thermal Performance Specifications (BASIX Thermal Comfort)
These are the Specifications upon which the Certified Assessment is based. If details included in these Specifications vary from other drawings or written specifications, these Specifications shall take precedence. If only one specification option is detailed for a building element, that specification must apply to all instances of that element for the project.

Windows* Default	Glass Single glazed, low E high solar gain	Frame Aluminium	U va 5.4	lue	SHGC 0.49	Detail Generally for window types: Awning, bi-fold, casement, tilt 'n' turn
Default	Single glazed, low E high solar gain	Aluminium	5.4		0.58	Generally for window types: Sliding window/ door, double hung, fixed, louvre
* The glass type	and frame descriptions are	Indicative only. The	e U-va	ue and		formance figures must be met to achieve compliance.
Skylights	Glass	Frame	U va	lue	SHGC	Detail
Default	Double glazed,	clear Aluminium	4.2		0.72	A l skylights
	Construction	Added Insulation	1	Deta	II	
External walls	Concrete / AFS	R 1.5		For	evels G, 1 ar	nd 2 as per drawlings
	Framed	R 2.5		For	evel 3	
Internal walls	Plasterboard on studs	None		With	n units	
	Concrete	R 1.0		Wall	separating u	units from common lobbies and lift shaft
	Plasterboard on studs	R 1.5		For u	init 01: wall s	separating unit from void space
Floors	Concrete	None		Cove	rings: carpe	t generally; tiles for Living/Dining/Kitchen & wet areas
	Concrete	R 1.0		For u	nit 01: R1.0	for floors over basement
Cellings	Plasterboard	(see roof detail be	low)			
Roofs	Concrete	R 1.0		Cond	rete roofs	
	Metal sheeting	R 3.5		Roof	over level 3	

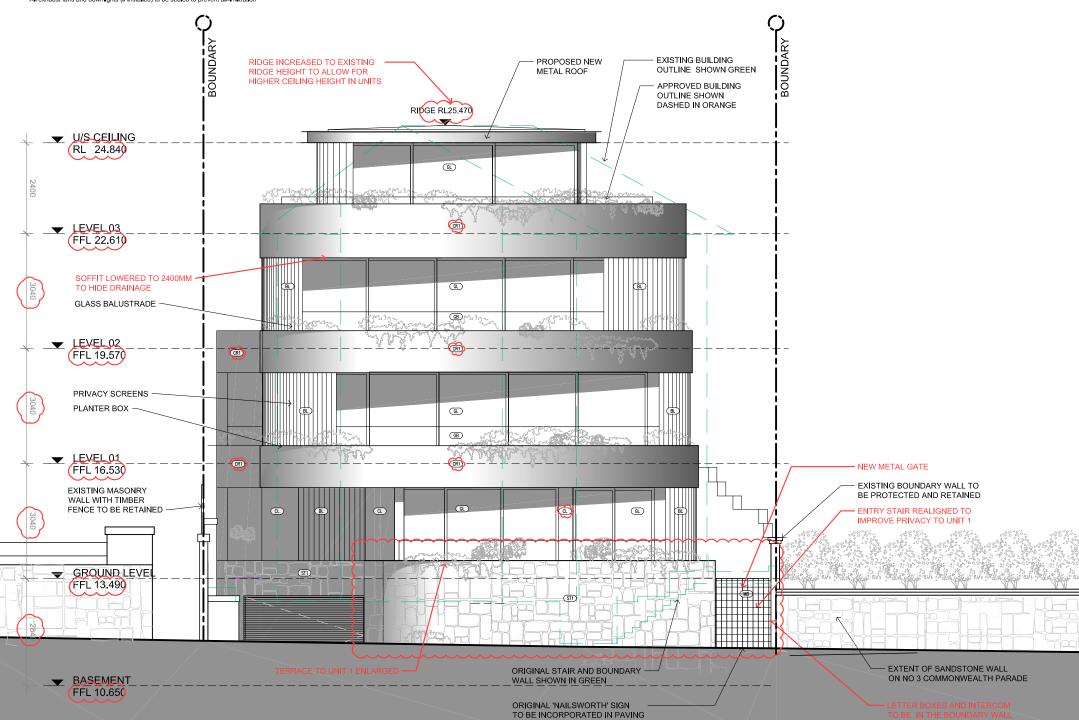

IMPORTANT NOTES:
Do not scale from drawings, use figured dimensions only. Ensure that the drawings used carry the latest revision no, Read in conjunction with consultant engineers drawings - refer contract drawing list.

- All dimensions to be checked on site before commencement of work, All discrepancies to be brought to the attention of the Architect. Larger scale drawings and written dimensions take precedence. The Estuarine Planning Level is min 3,1m AHD, All levels to AHD,

REVISION	DATE	DESCRIPTION	BY	REVISION	DATE	DESCRIPTION	BY	REVISION NOTES
PR	2019.05.16	PRELIMINARY	FB					
PR2	2019.05.16	PRELIMINARY	FB					
PR3	2020.01.17	PRELIMINARY \$4.55	FB					
\$4.55	2020.03.13	s4.55 APPLICATION	FB					








DRAWING TITLE	PROJECT					
EAST ELEVATION (
SCALE	STATUS	NUMBER	REVISION			
1:100 @A3	\$4.55	A2.01	s4.55			

CPM

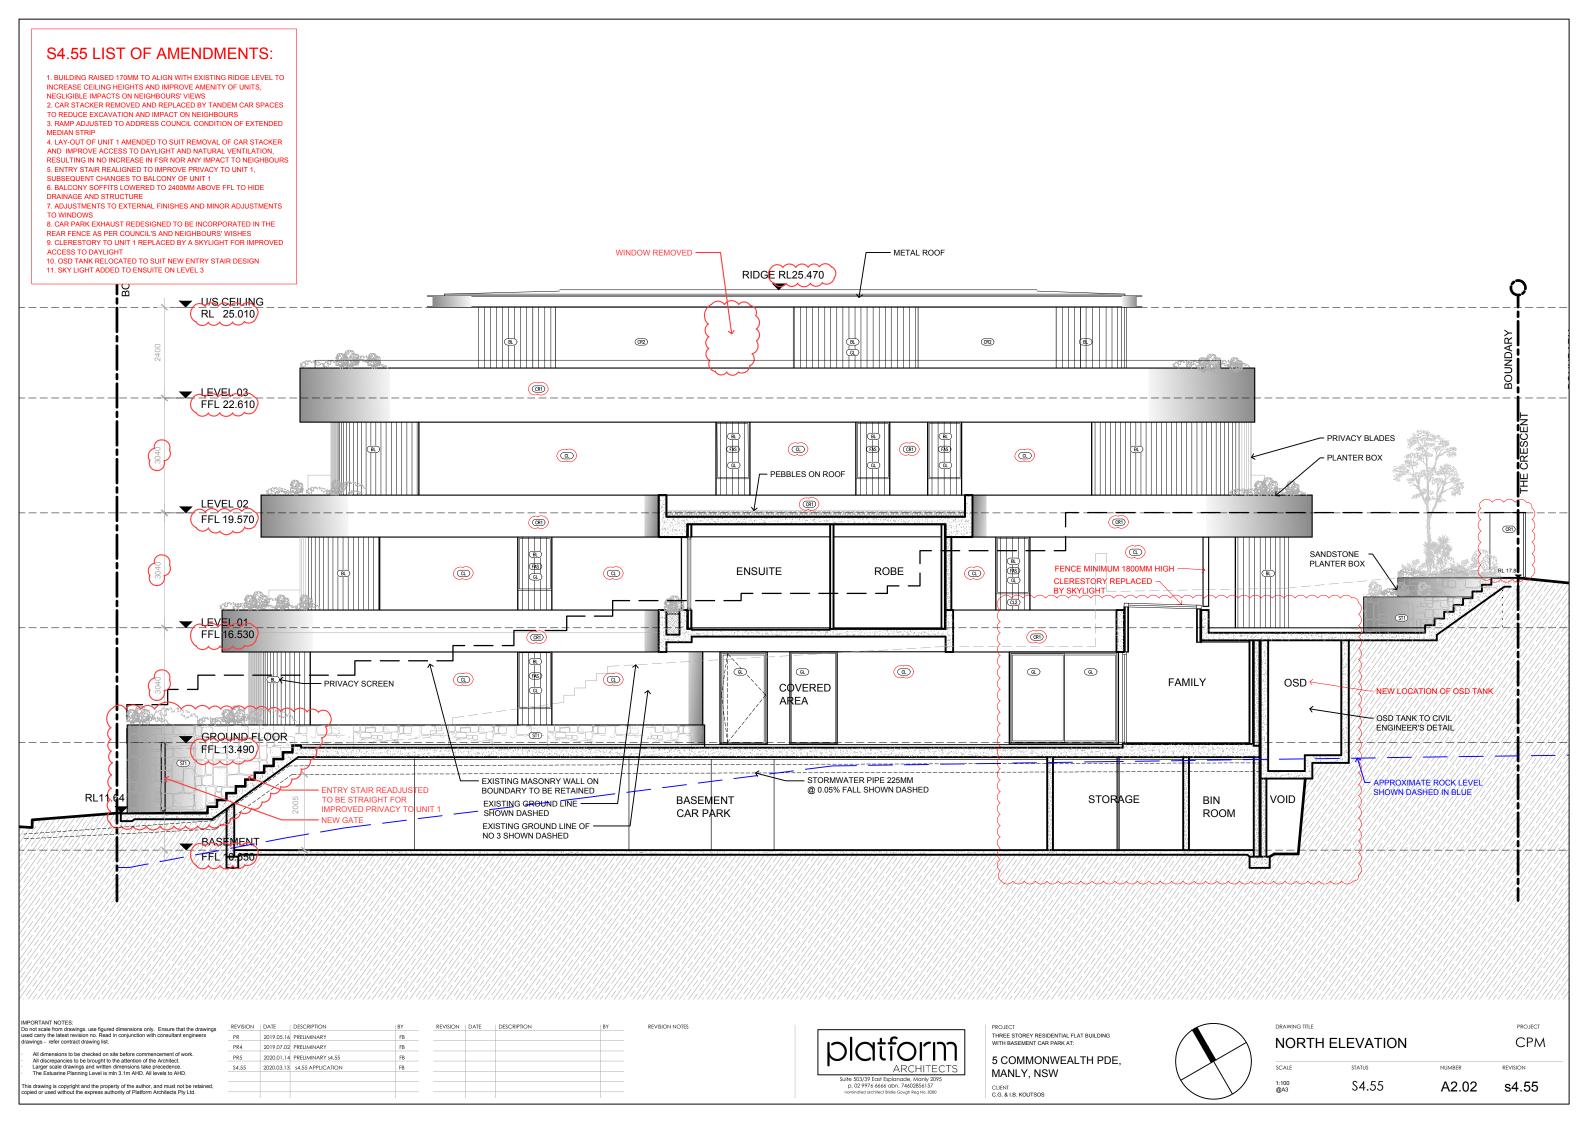

S4.55 LIST OF AMENDMENTS:

BUILDING RAISED 170MM TO ALIGN WITH EXISTING RIDGE LEVEL TO INCREASE CEILING HEIGHTS AND IMPROVE AMENITY OF UNITS, NEGLIGIBLE IMPACTS ON NEIGHBOURS' VIEWS
 CAR STACKER REMOVED AND REPLACED BY TANDEM CAR SPACES TO REDUCE EXCAVATION AND IMPACT ON NEIGHBOURS
 RAMP ADJUSTED TO ADDRESS COUNCIL CONDITION OF EXTENDED MEDIAN STRIP

MEDIAN STRIP

4. LAY-OUT OF UNIT 1 AMENDED TO SUIT REMOVAL OF CAR STACKER
AND IMPROVE ACCESS TO DAYLIGHT AND NATURAL VENTILATION,
RESULTING IN NO INCREASE IN FSR NOR ANY IMPACT TO NEIGHBOURS
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DRAINAGE AND STRUCTURE

7. ADJUSTMENTS TO EXTERNAL FINISHES AND MINOR ADJUSTMENTS TO WINDOWS


TO WINDOWS

8. CAR PARK EXHAUST REDESIGNED TO BE INCORPORATED IN THE REAR FENCE AS PER COUNCIL'S AND NEIGHBOURS' WISHES

9. CLERESTORY TO UNIT 1 REPLACED BY A SKYLIGHT FOR IMPROVED ACCESS TO DAYLIGHT

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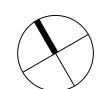
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REVISION	DATE	DESCRIPTION	BY	REVISION	DATE	DESCRIPTION	BY	REVISION NOTES
PR1	2019.07.08	PRELIMINARY	FB					
PR2	2020.01.22	PRELIMINARY s4.55	FB					
\$4.55	2020.03.13	s4.55 APPLICATION	FB					

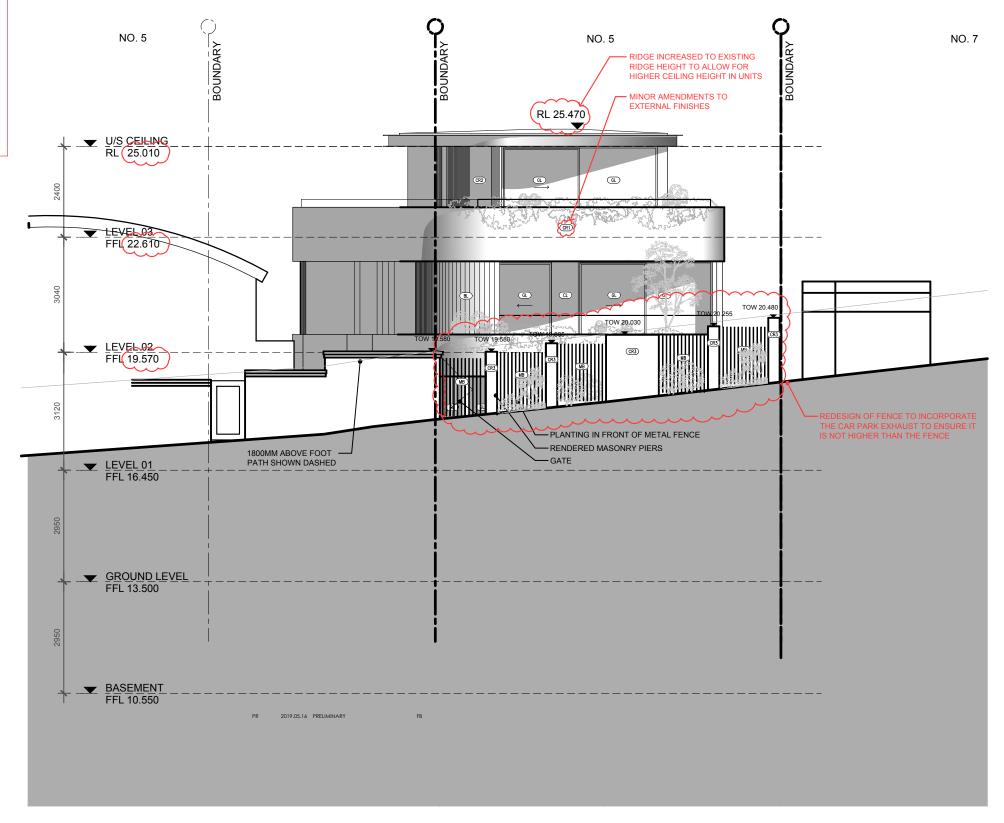



THREE STOREY RESIDENTIAL FLAT BUILDING WITH BASEMENT CAR PARK AT: 5 COMMONWEALTH PDE, MANLY, NSW


CLIENT C.G. & I.B. KOUTSOS



DRAWING TITLE	PROJECT CPM		
SCALE	STATUS	NUMBER	REVISION
1:100 @A3	\$4.55	A2.03	s4.55

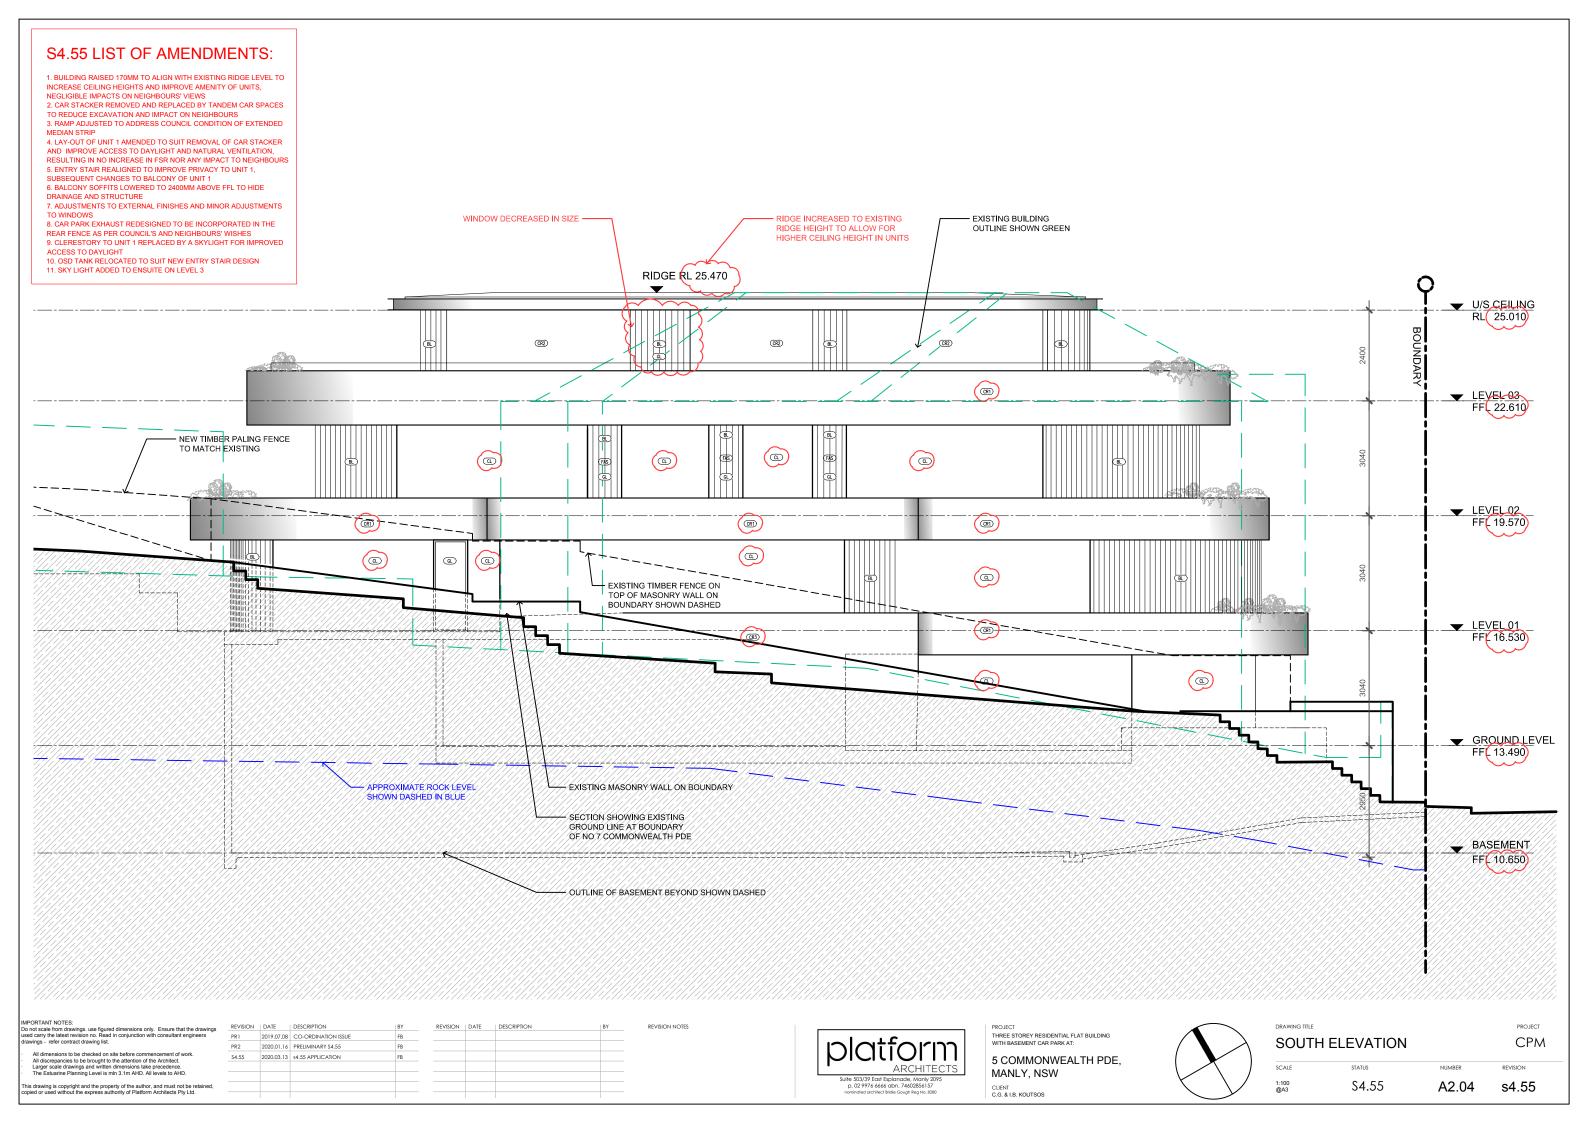

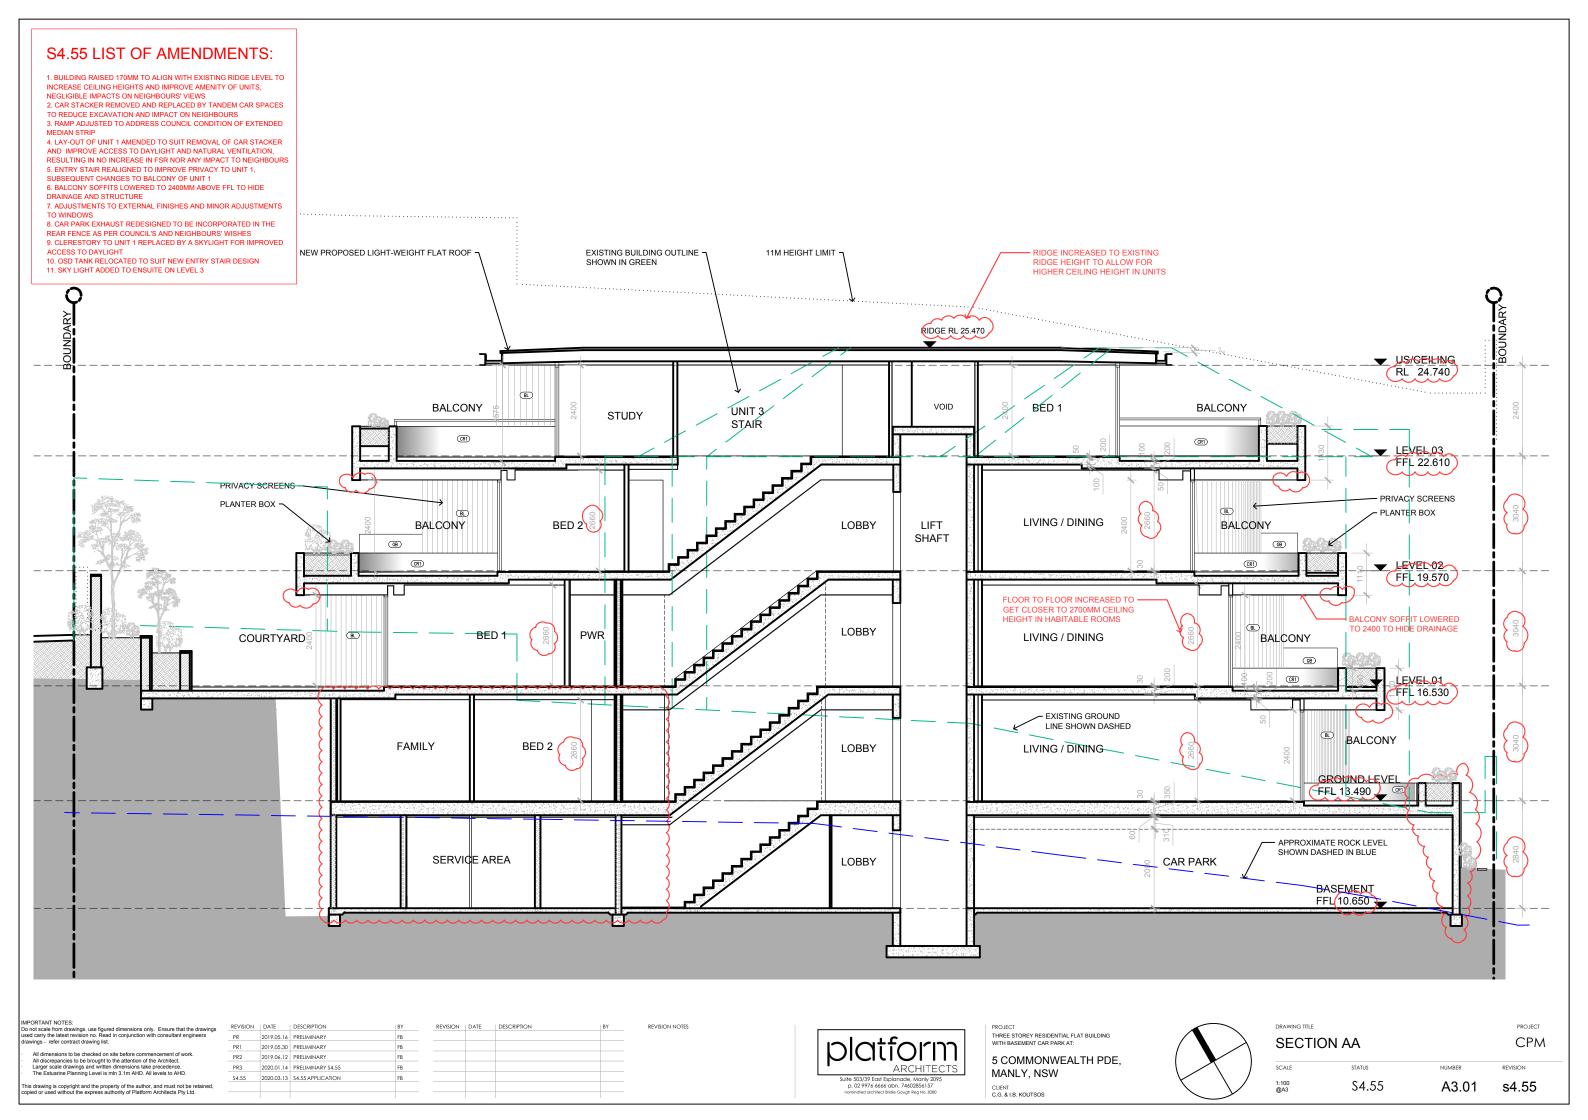

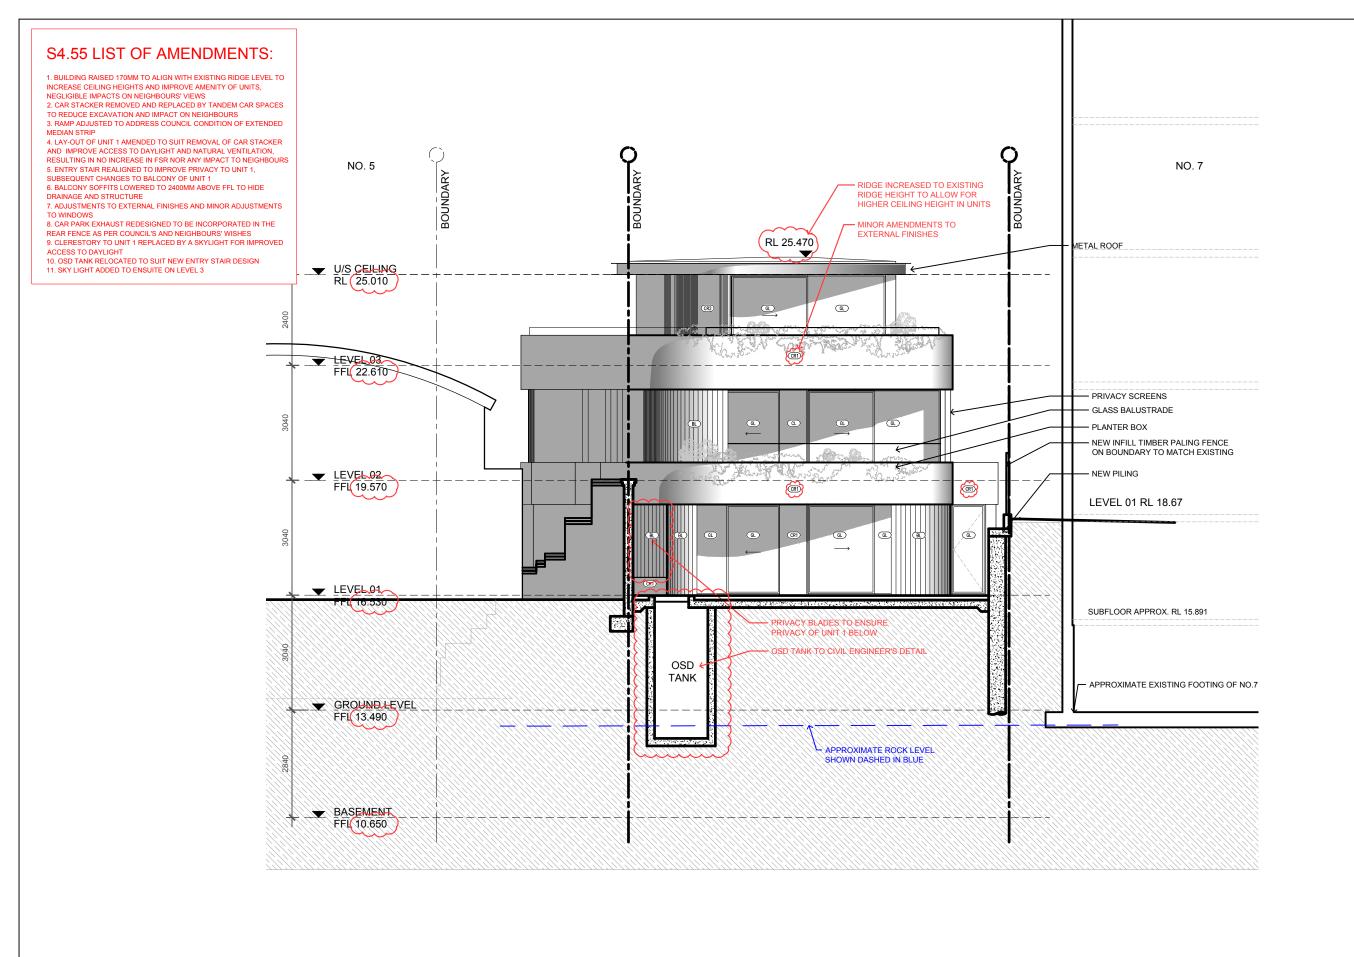

IMPORTANT NOTES:
Do not scale from drawings, use figured dimensions only. Ensure that the drawings used carry the latest revision no. Read in conjunction with consultant engineers drawings - refer contract drawing list.

All dimensions to be checked on site before commencement of work.

All discrepancies to be brought to the attention of the Architect.

Larger scale drawings and written dimensions take precedence.

The FStuarine Planning Level is min 3.1 m AHD. All levels to AHD.

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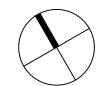
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PR	2019.05.16	PRELIMINARY	FB					
PR2	2019.06.12	PRELIMINARY	FB					
PR3	2020.01.20	PRELIMINARY s4.5	FB					
\$4.55	2020.03.13	\$4.55 APPLICATION	FB					



THREE STOREY RESIDENTIAL FLAT BUILDING WITH BASEMENT CAR PARK AT:

5 COMMONWEALTH PDE, MANLY, NSW

CLIENT C.G. & I.B. KOUTSOS




DRAWING TITLE									
SECTION BB									
SCALE	STATUS	NUMBER							
1:100 @A3	\$4.55	A3.02							

PROJECT

CPM

s4.55

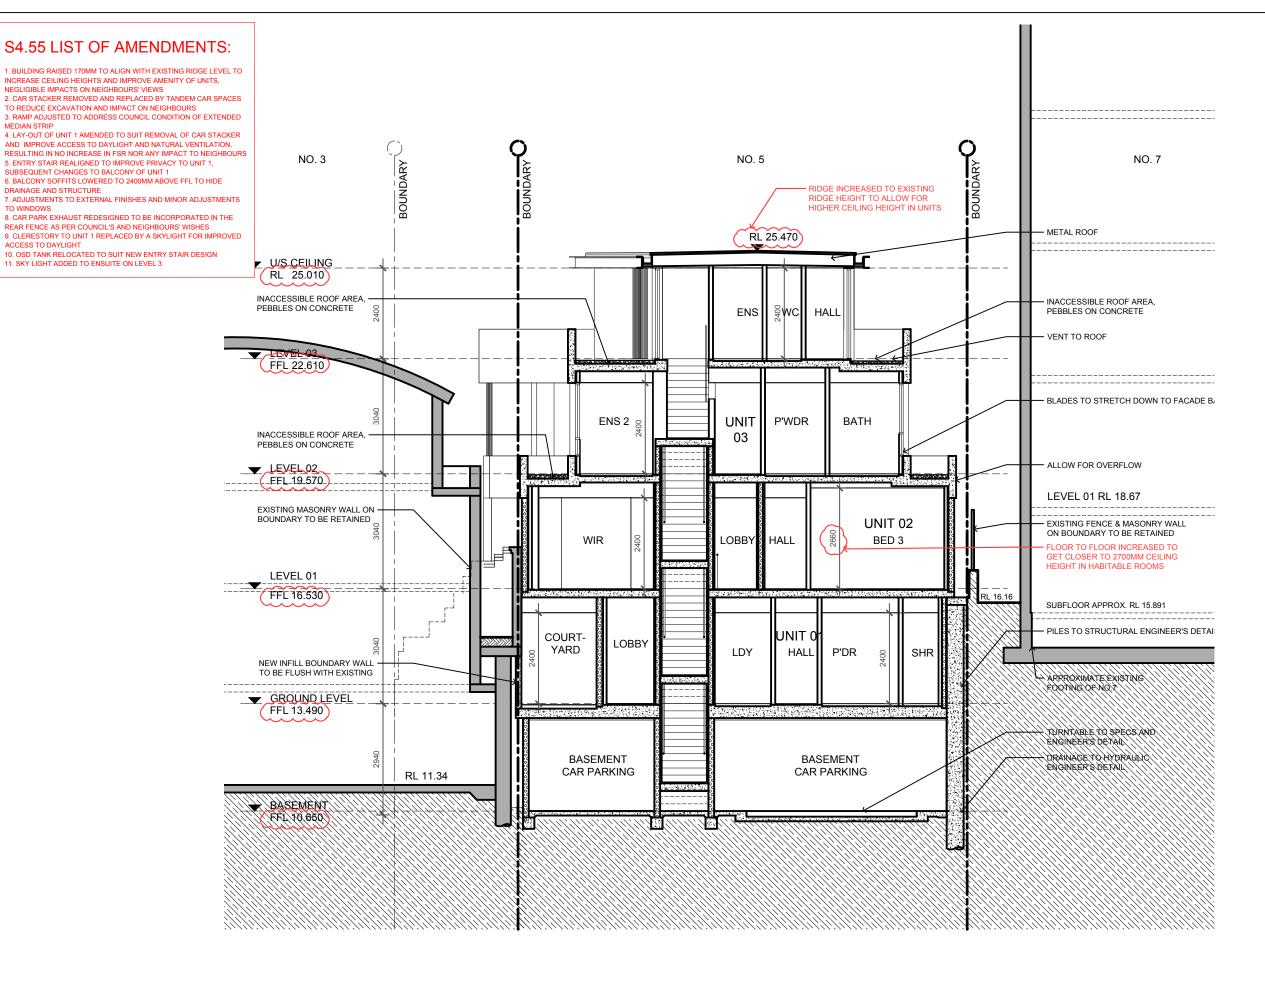

MEDIAN STRIP

ACCESS TO DAYLIGHT

IMPORTANT NOTES:
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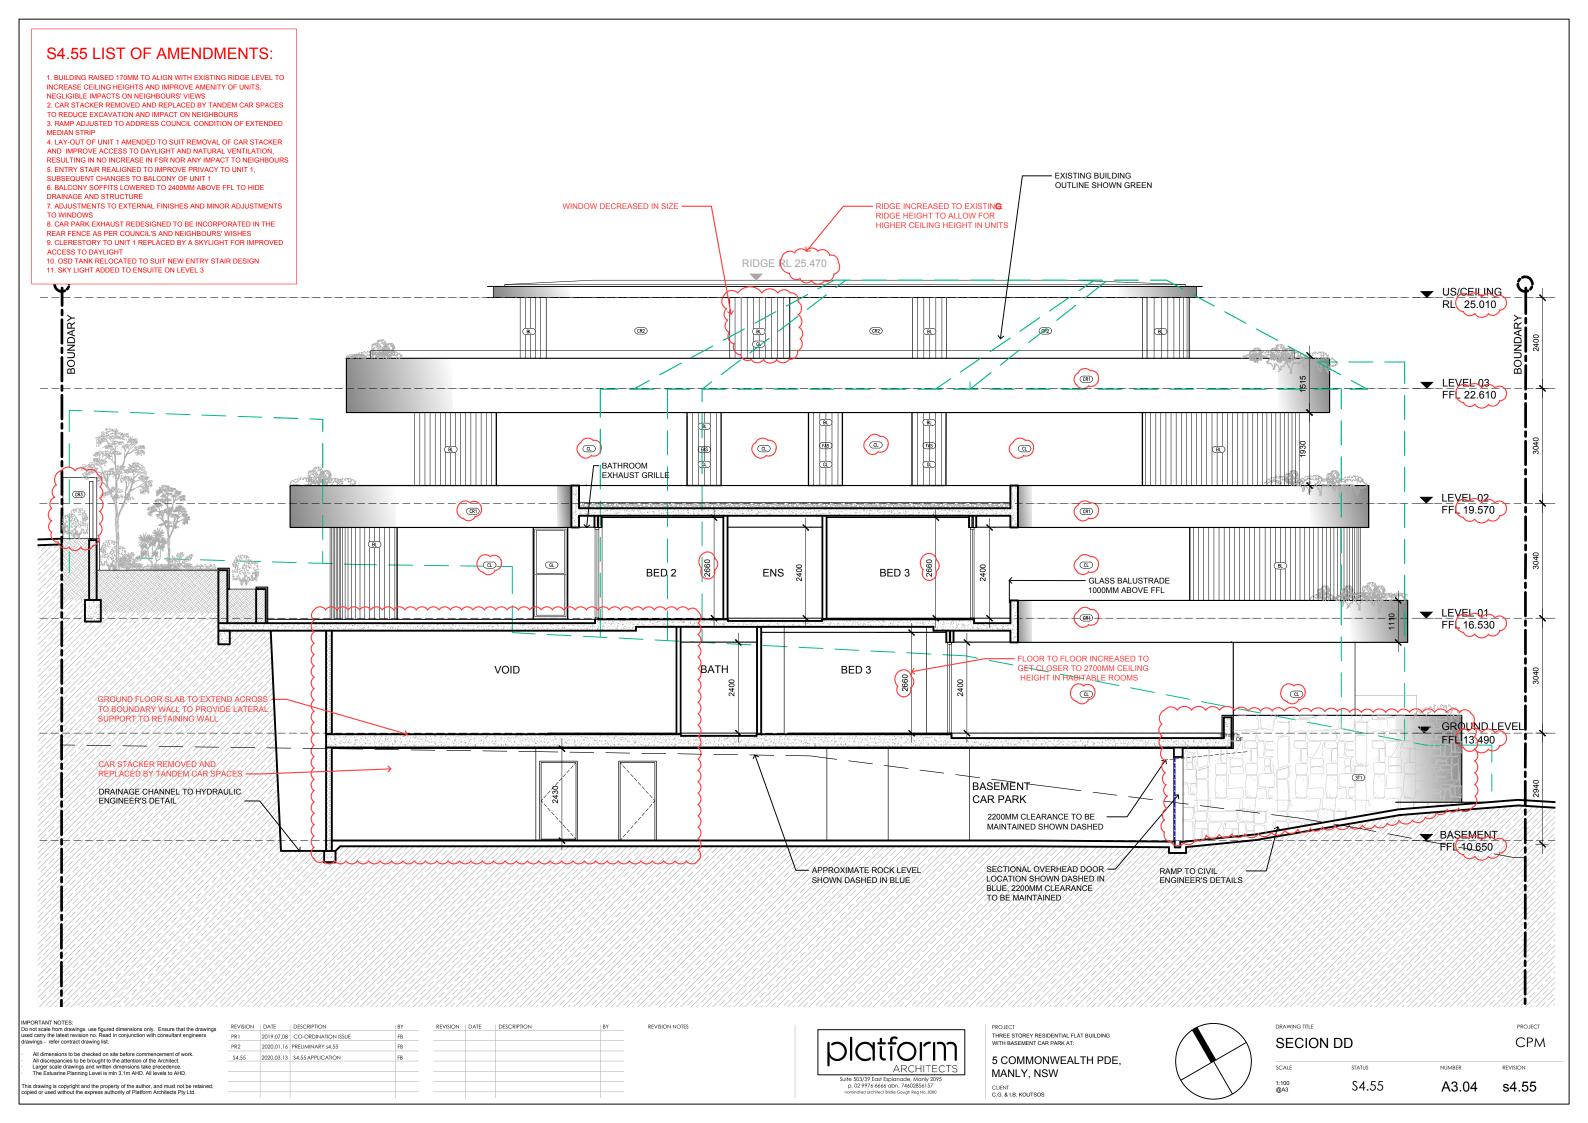
REVISION	DATE	DESCRIPTION	BY	REVISION	DATE	DESCRIPTION	BY	REVISION NOTES
PR	2019.05.16	PRELIMINARY	FB					
PR4	2019.07.02	PRELIMINARY	FB					
PR5	2019.07.04	PRELIMINARY	FB					
PR6	2020.01.20	PRELIMINARY \$4.55	FB					
\$4.55	2020.03.13	\$4.55 APPLICATION	FB					








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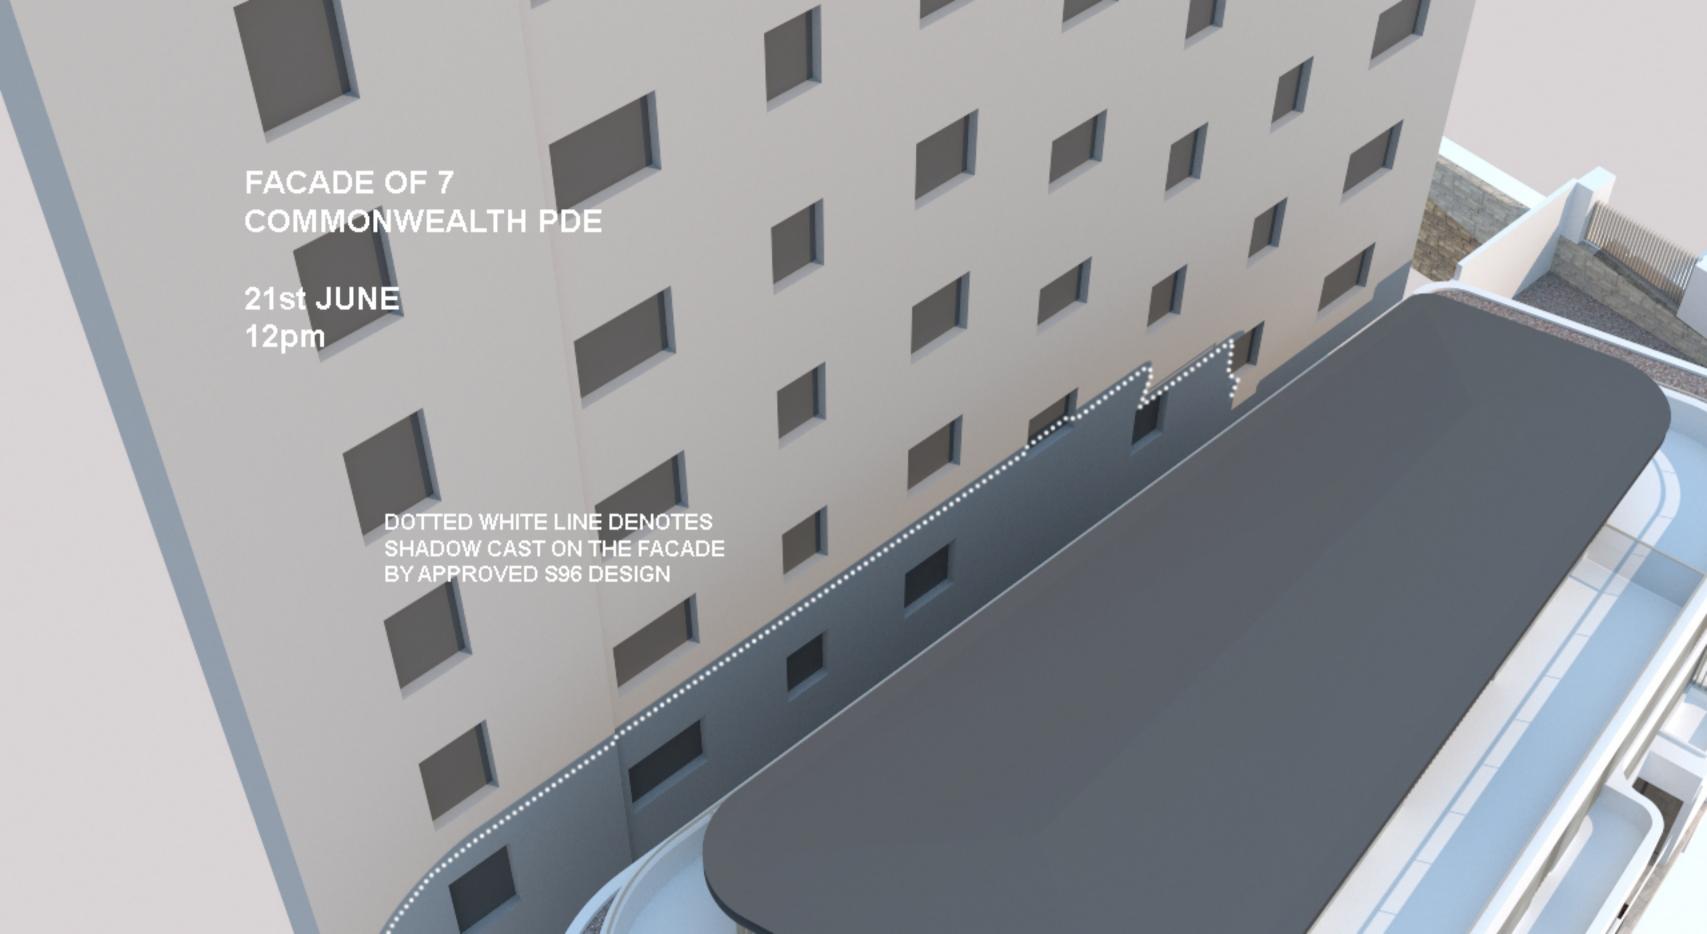
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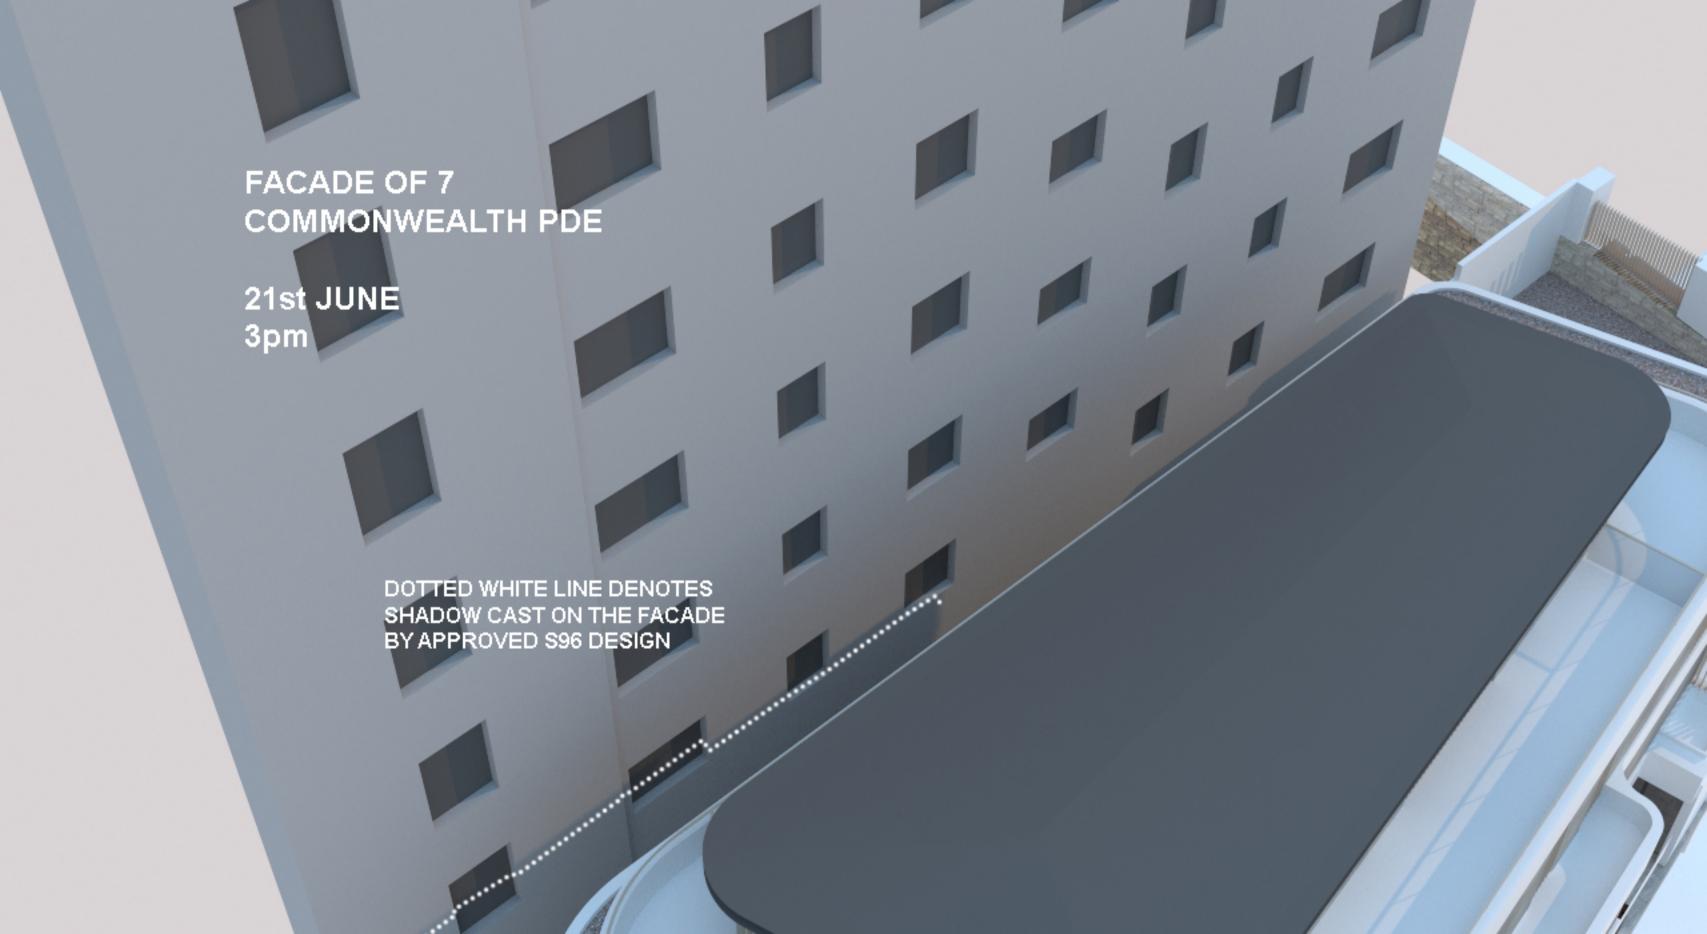






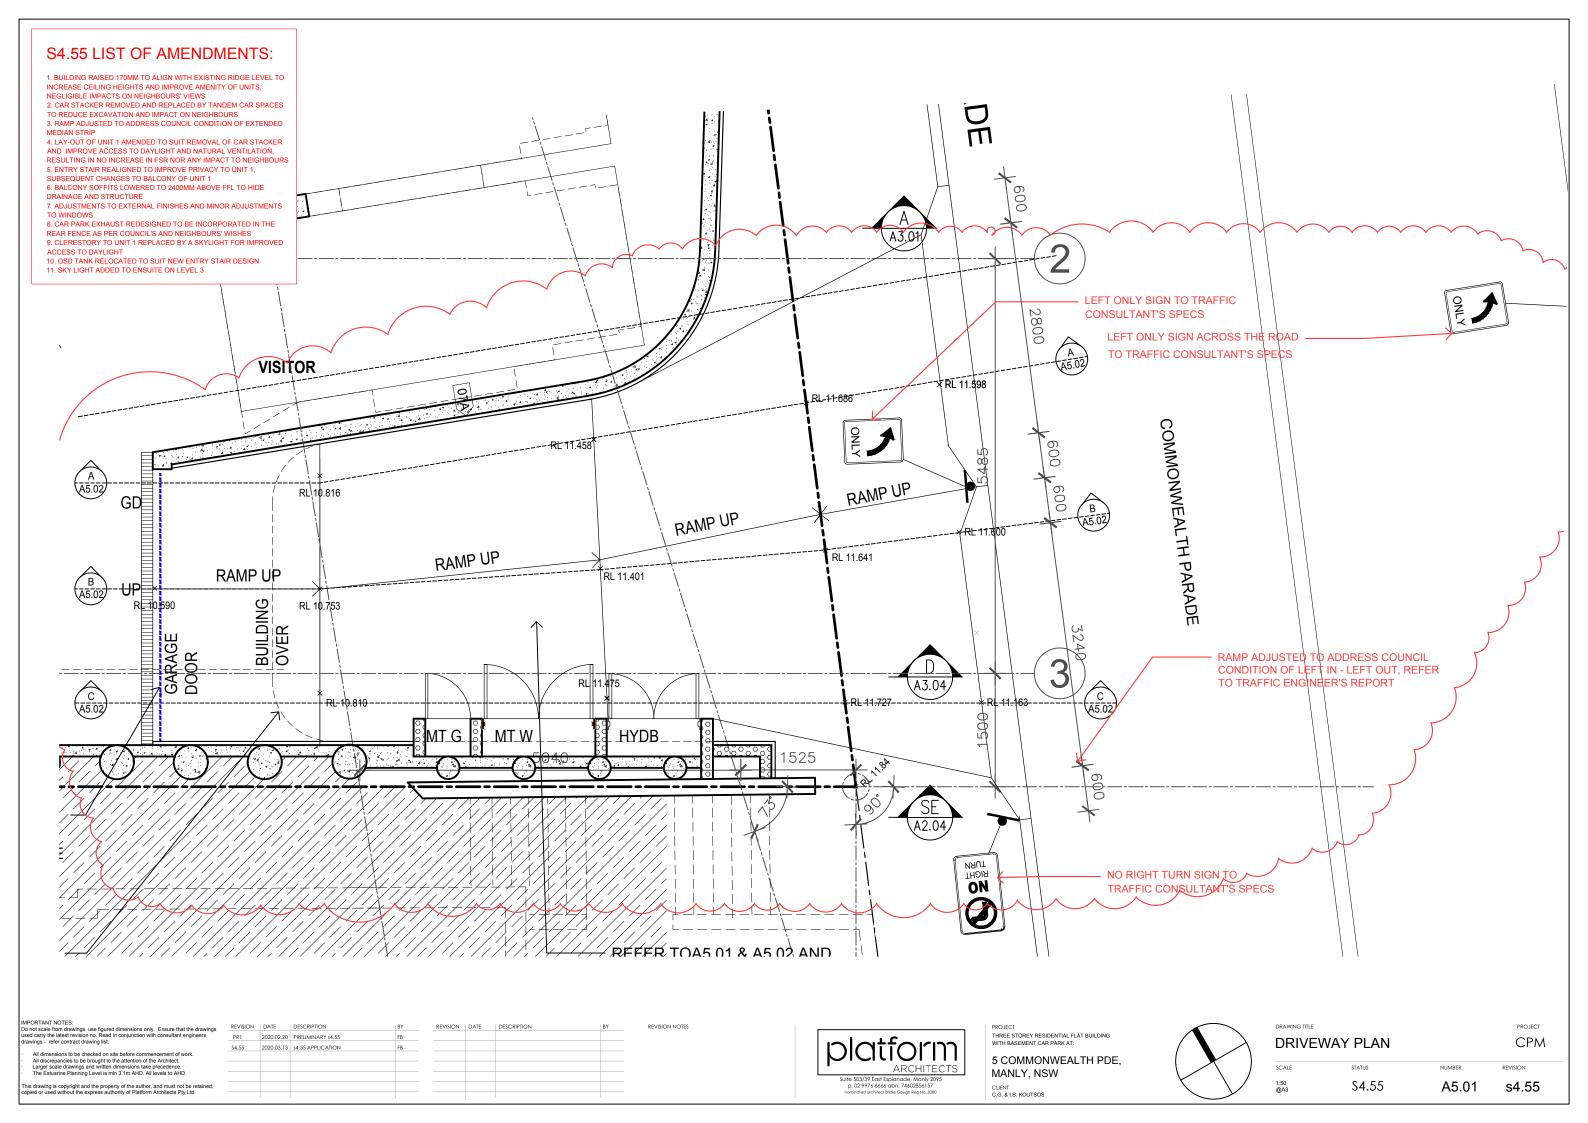

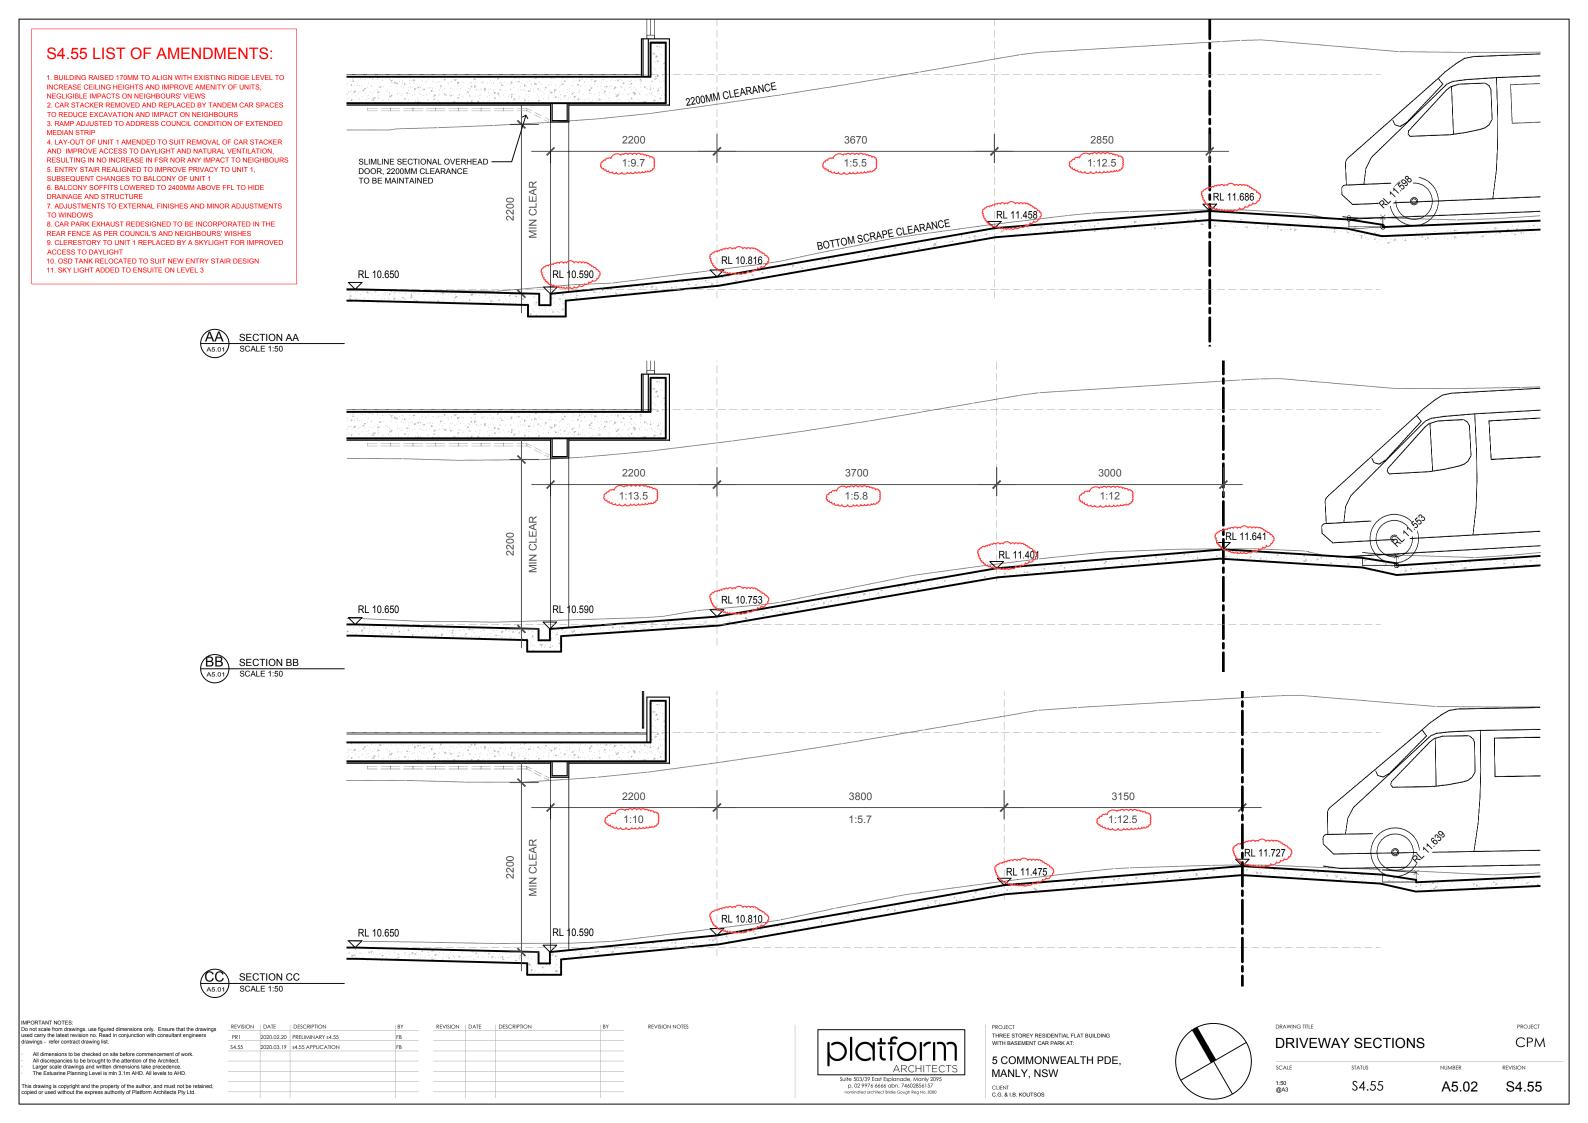

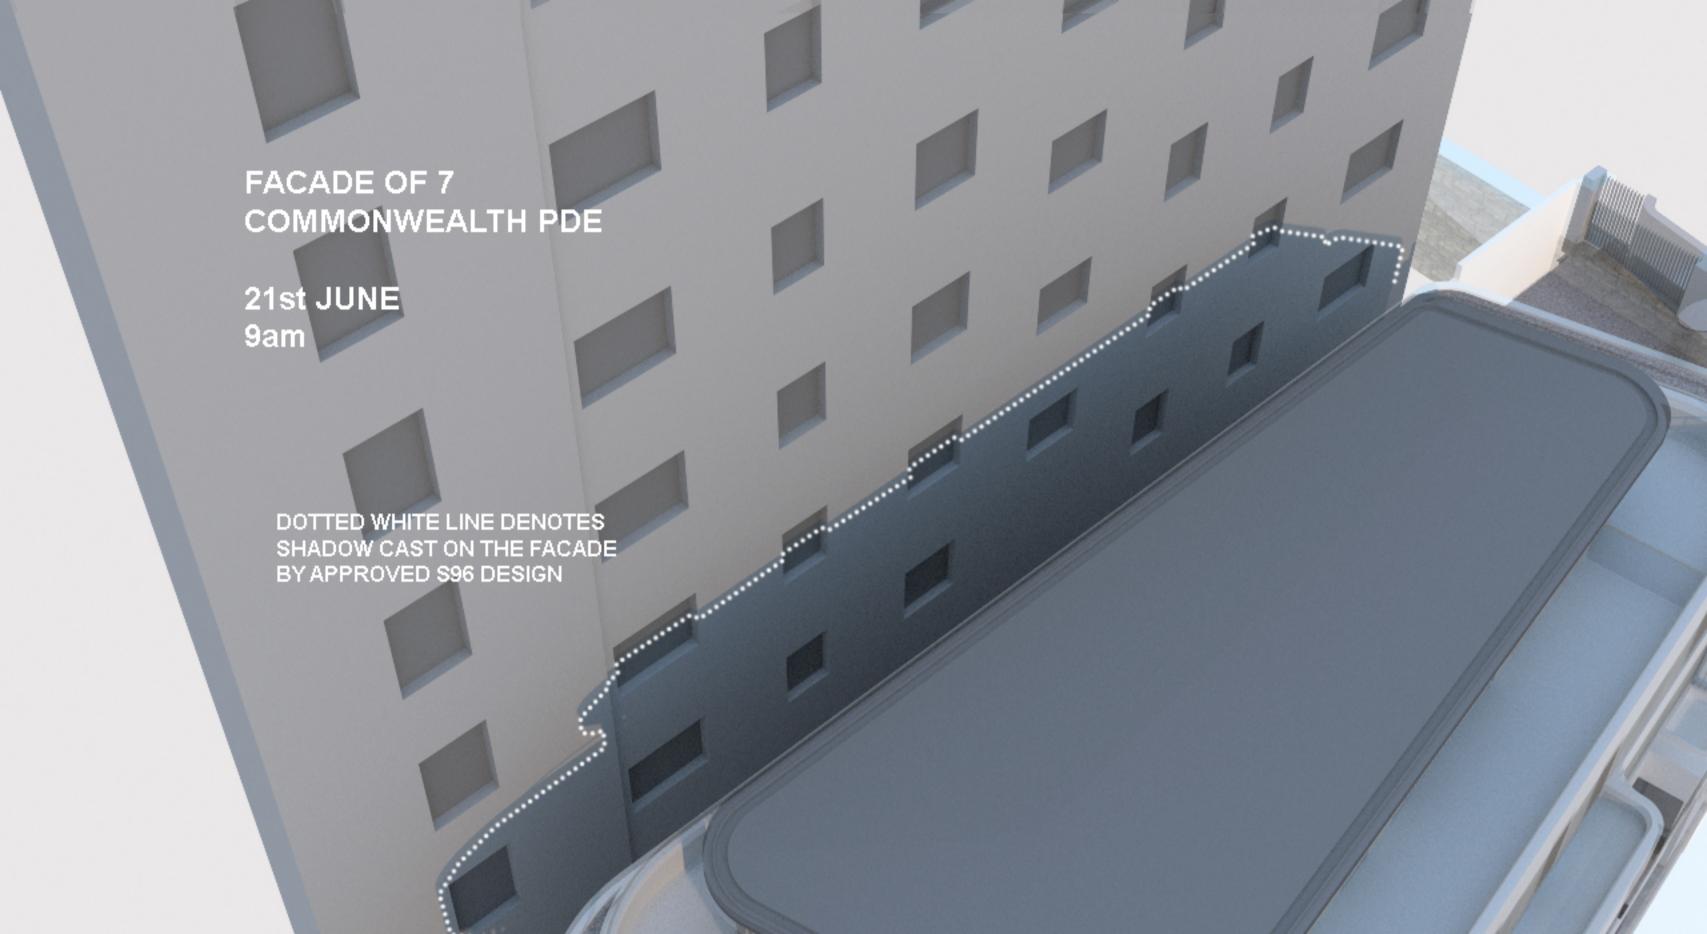

5 COMMONWEALTH PARADE, MANLY NSW 2095


CIVIL WORKS FOR S4.55 SUBMISSION LGA NORTHERN BEACHES COUNCIL





LOCALITY PLAN SCALE 1:1000



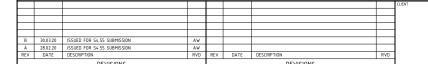







5 COMMONWEALTH PARADE MANLY, NSW 2095

DRAWING INDEX DRAWING No. DESCRIPTION


> COVER SHEET AND LOCALITY PLAN GENERAL ARRANGEMENT PLAN


OSD PLAN AND SECTION


SITEWORKS AND DRAINAGE PLAN SHEET 1 OF 2 SITEWORKS AND DRAINAGE PLAN SHEET 2 OF 2


	GRID	SCALE		PROJECT No.	DRAWING No.	
	SP	SP	AW			
	DESIGNED	CHECKED	APPROVED	AND LOCA	ILII FLAN	
ISSUED FOR APPROVAL NOT TO BE USED FOR CONSTRUCTION				COVER SHEET		
				S	CALE 1:1000 AT A1 SIZE	

AT A1 SIZE \$19156 AHD MGA AS SHOWN

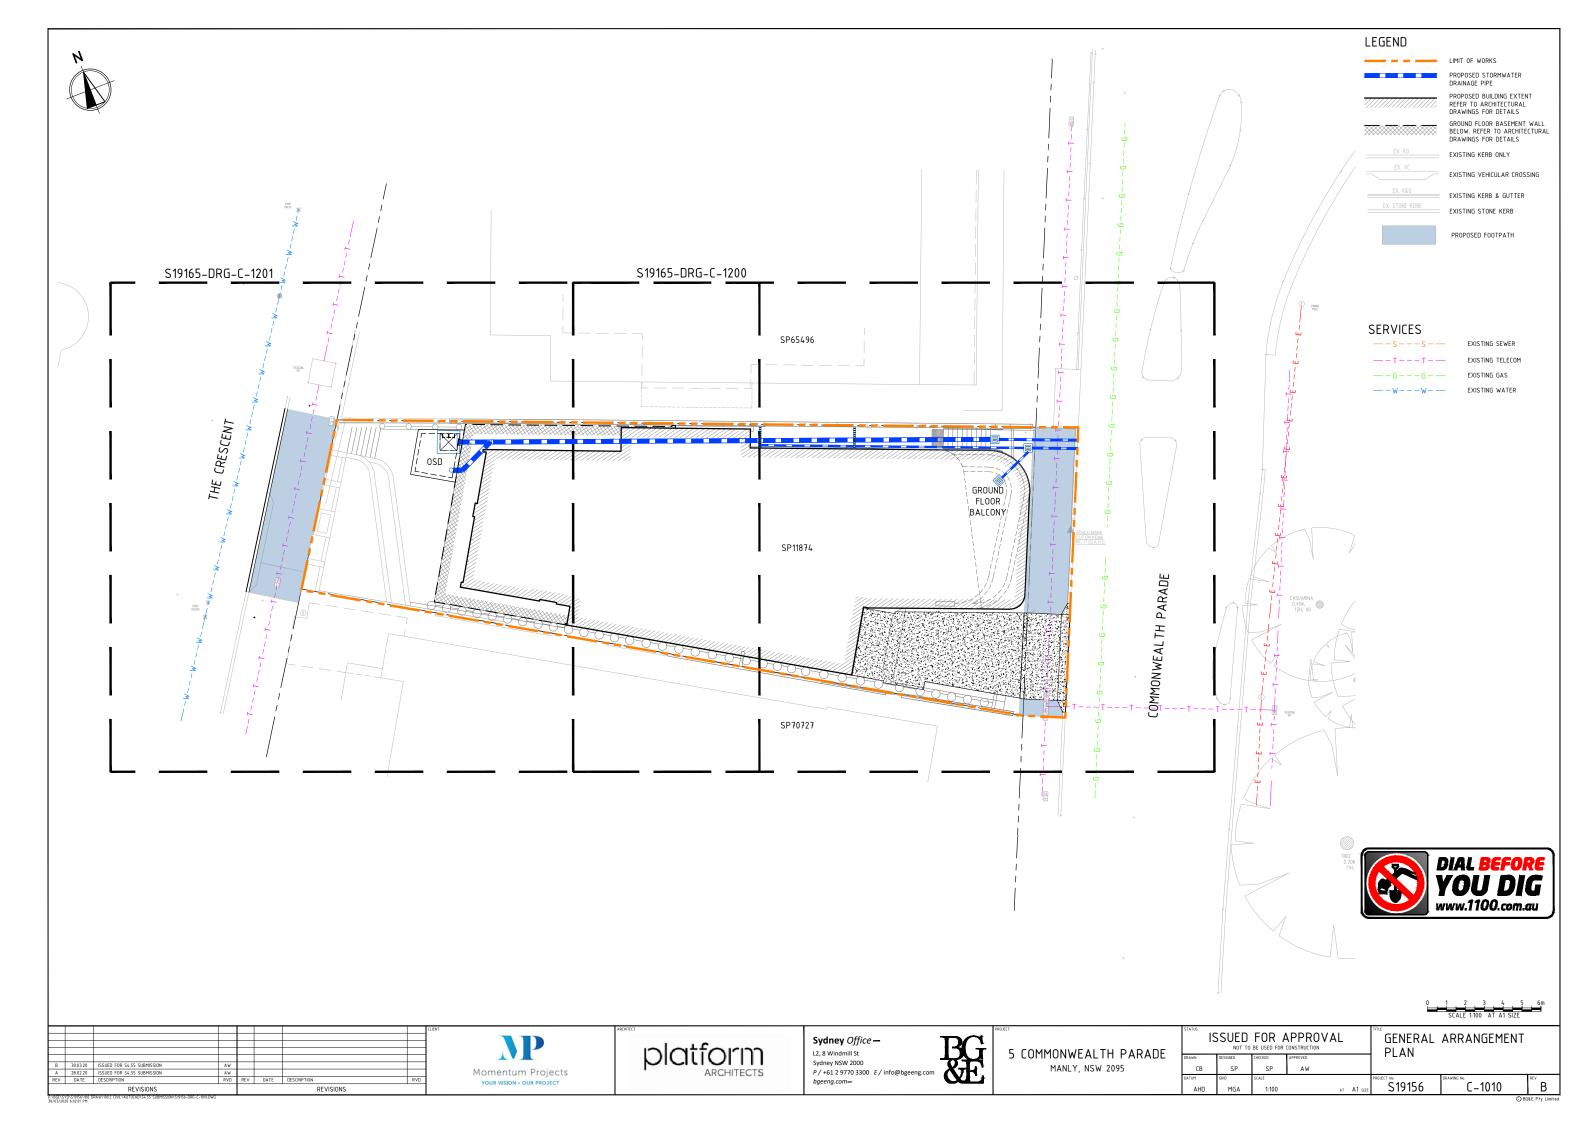

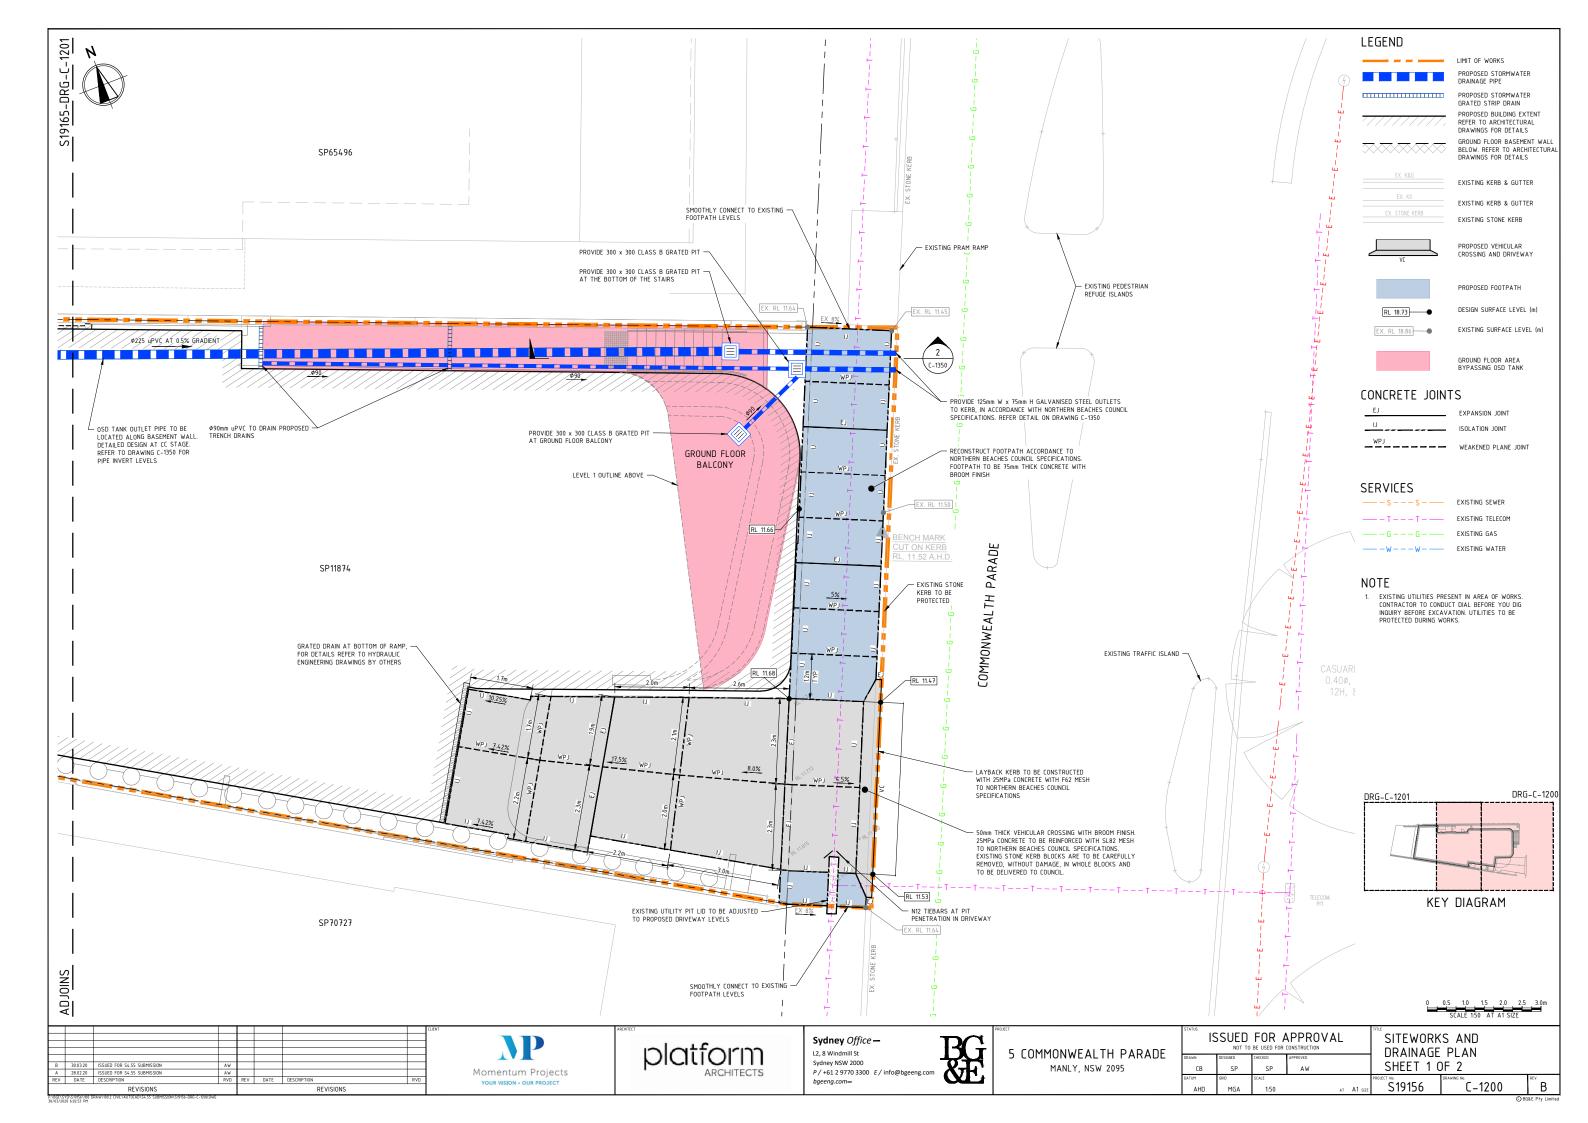

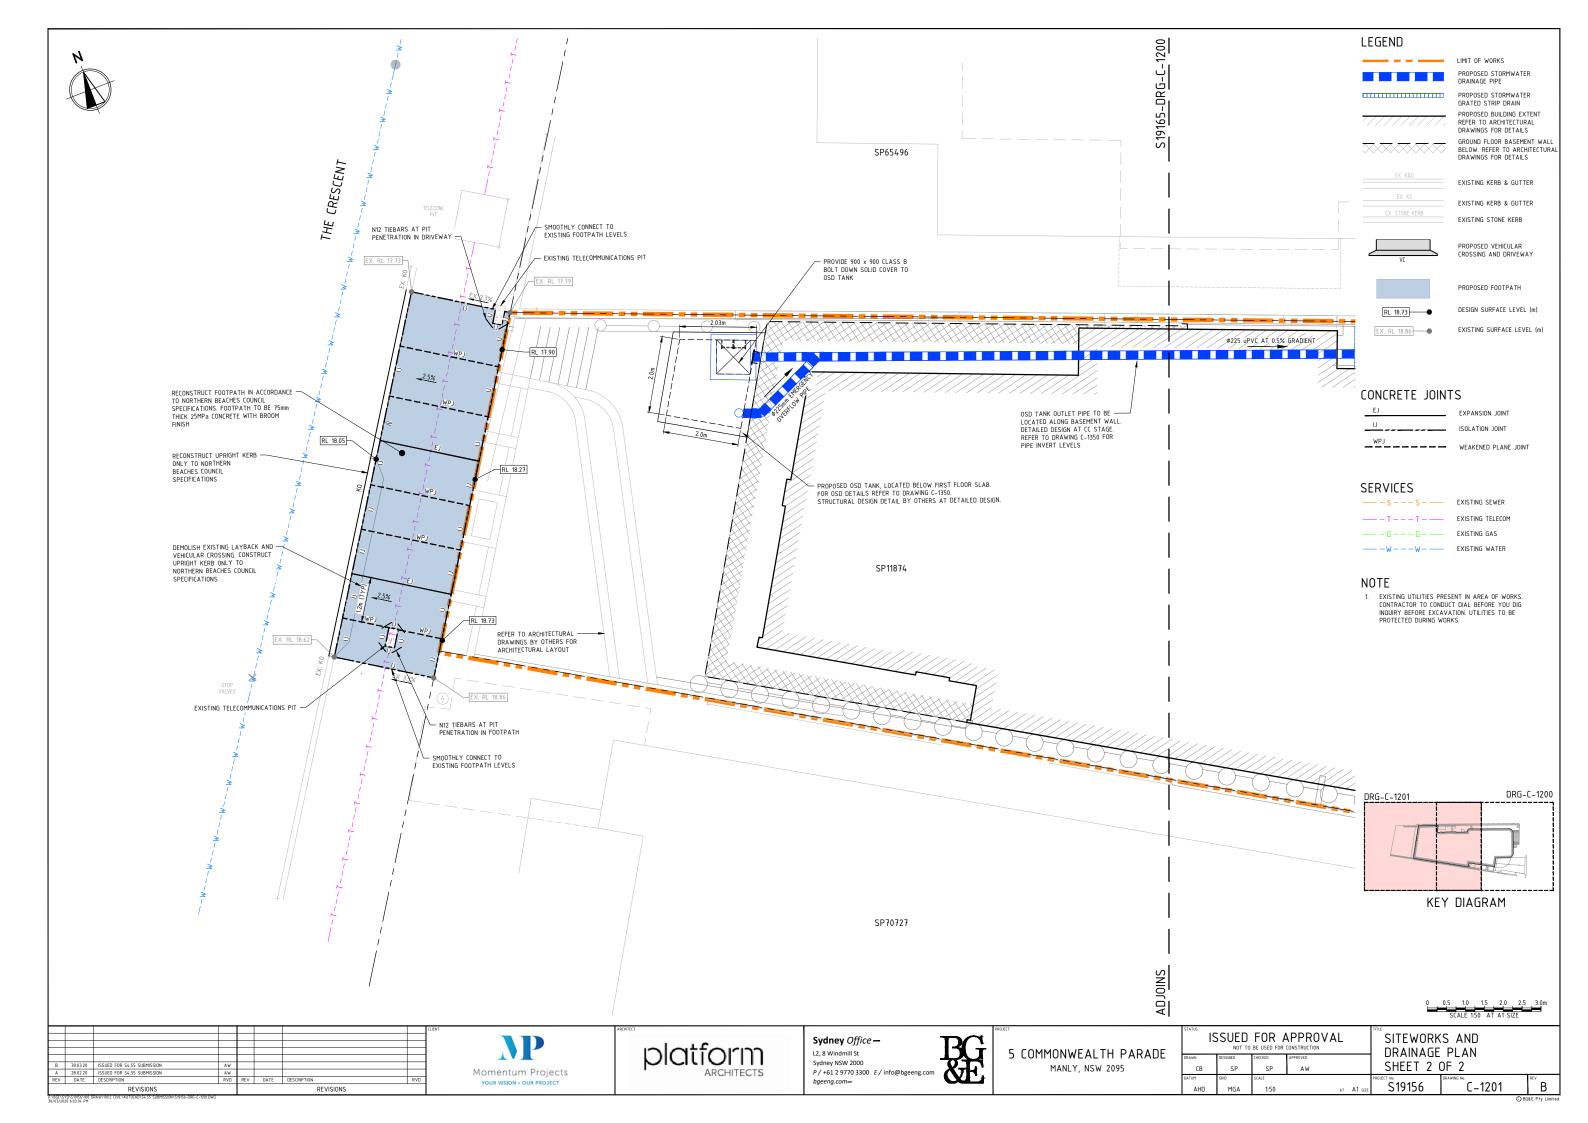

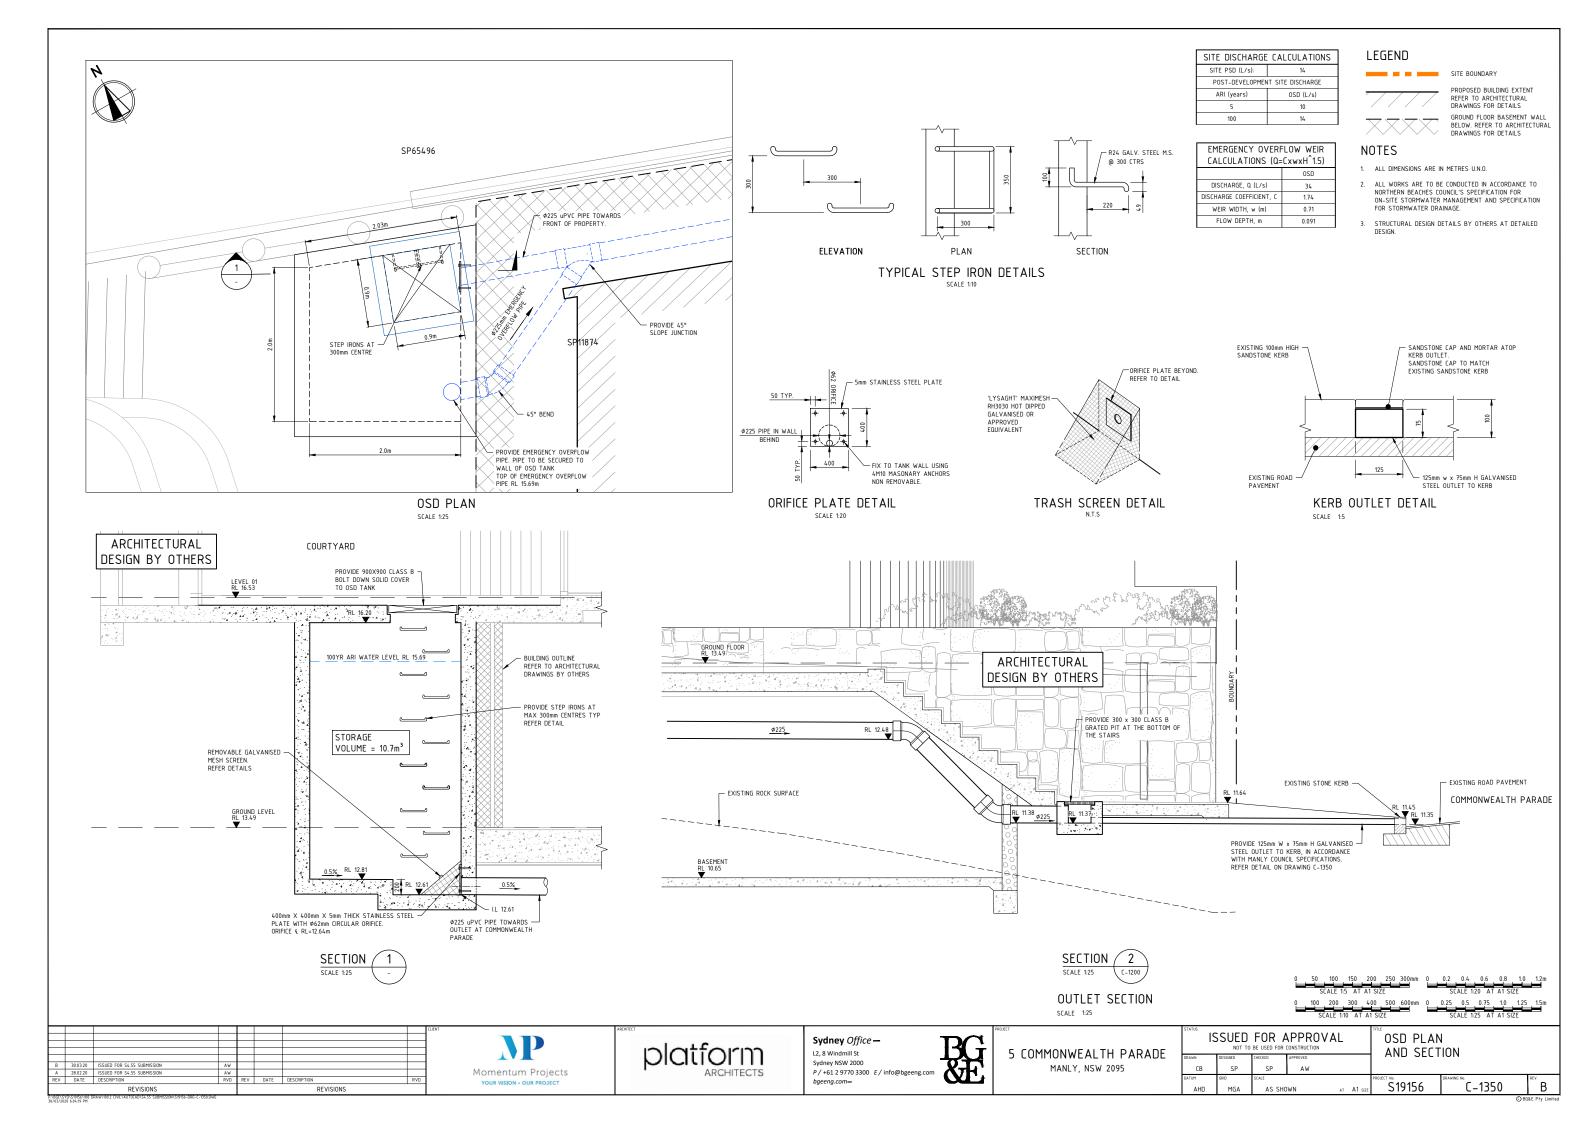



EXTERNAL FINISHES BOARD

5 Commonwealth Parade, Manly **Platform Architects** 2020.03.13

Roof cover ROUNDED PEBBLES



Terrace flooring NATURAL STONE




To lower floors CONCRETE LOOK CLADDING



To upper floor DARK CLADDING



ARTIST'S IMPRESSION

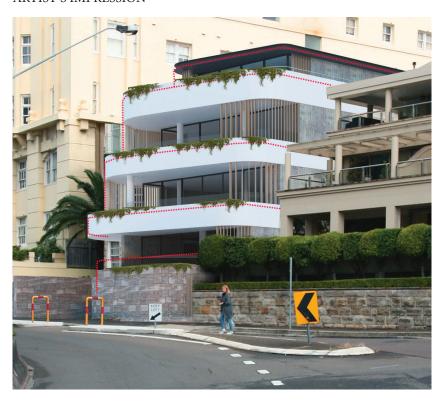

Planters with **CASCADING PLANTS & GREENERY**



Champagne aluminium WINDOW FRAMES



Charcoal **AWNING**



CHAMPAGNE POWDERCOAT

Privacy blades and fencing in



Light-coloured SANDSTONE BASE



Off-white or light grey RENDERED BANDS





EXTERNAL FINISHES BOARD

5 Commonwealth Leade, Manly **Platform Architects** 2018.09.06

Artist impression



Charcoal powdercoated WINDOW FRAMES & ROOF



Planters with

CASCADING





Light-coloured

SANDSTONE BASE

Privacy blades and fencing in REDDISH BROWN METAL or CORTEN





LANTS & GREENERY





Roof cover ROUNDED PEBB





Terrace flooring



To lower floors




To upper floor

LIGHT RENDER DARK RENDER

Off-white or light gre CURVED BRICK ORK OR TILES



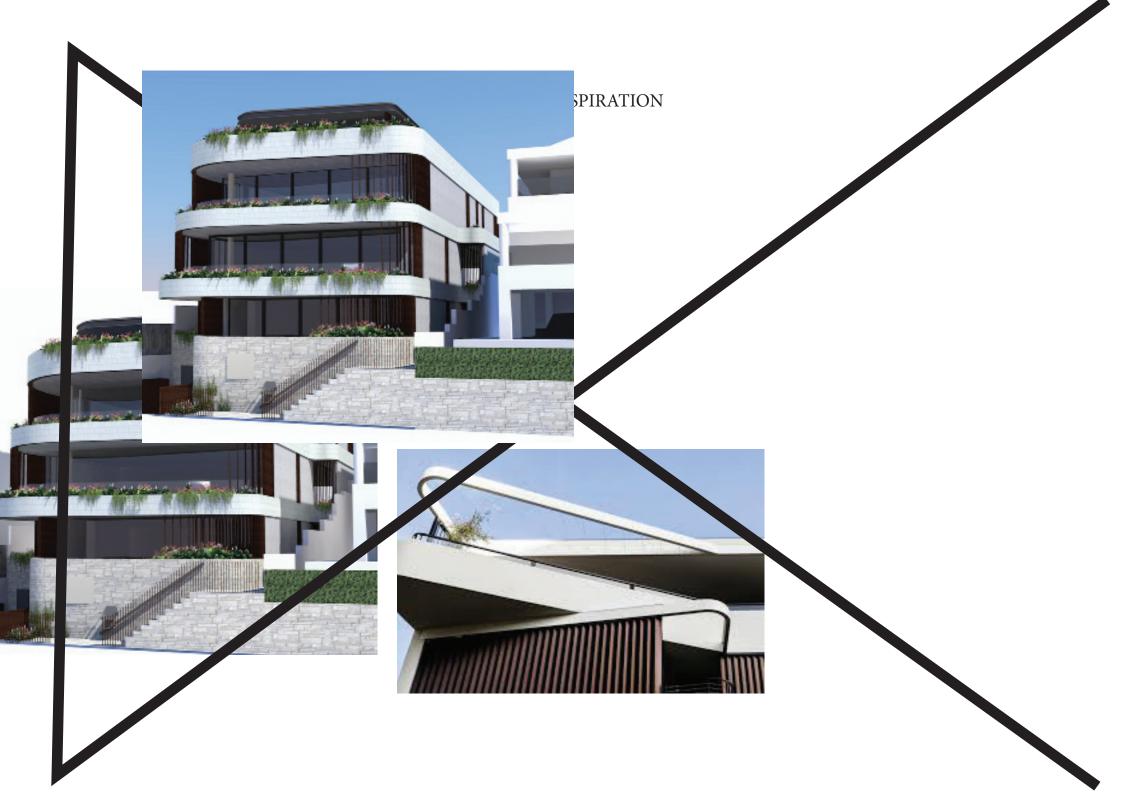

INSPIRATION

EXTERN. FINISHES BOARD

5 Commonwealth a rade, Manly Platform Arc itects 2018.09.06

Soft edge CASCADING LANTING



Reddish brow metal or corten PRIVACY BLA DES & FENCING



Off-white or the grey CURVED BR CK WORK OR TILES



Roof cover **ROUNDED PEBBLES**



light-coloured SANDSTOM



Charcoal METAL ROOF



Flooring NATURAL STONE











Soft edge CASCADING PLANTING



Reddish brown metal or corten PRIVACY BLADES & FENCING



Roof cover ROUNDED PEBBLES



Off-white or light grey CURVED BRICK WORK OR TILES



light-coloured SANDSTONE BASE



Charce ∟ ROOF



Flooring NATURAL STONE



To lower floors LIGHT RENDER



To upper floor DARK RENDER



