

M c C A R R S C R E E K R O A D

PROPOSED SITE PLAN Scale: 1:200

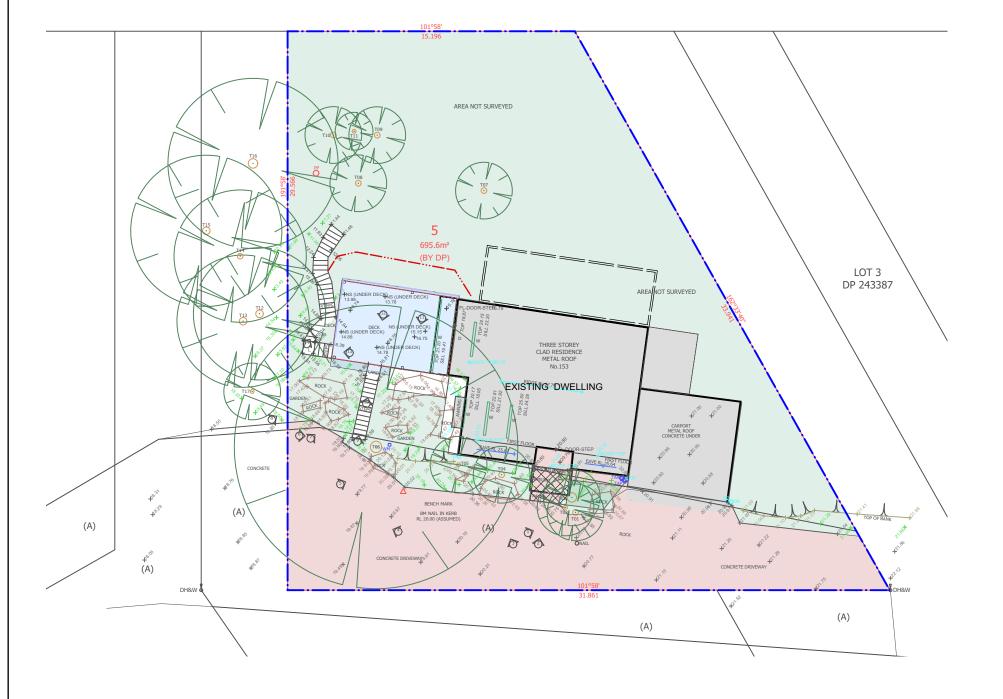

EXISTING SITE CALCULATIONS					
EXISTING ONE OXEGOEX	10110	%	m2		
Site Total Area By D.P	-	100%	695.6		
Soft Landscape Area	-	54.14%	376.60		
Hard Landscape (Decking)	-	6.06%	42.18		
Dwelling/Carport	-	17.74%	123.40		
Driveway	-	22.06%	153.42		

PROPOSED SITE CALCULATIONS								
		%	m2					
Site Total Area By D.P	-	100%	695.6					
Soft Landscape Area	-	54.14%	376.60					
Hard Landscape (Decking)	-	6.06%	42.18					
Dwelling/Carport	-	17.74%	123.40					
Driveway	-	22.06%	153.42					

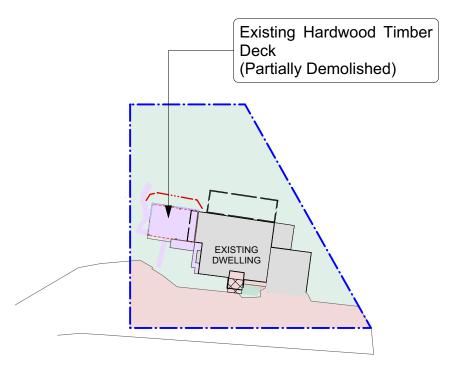

2 EXISTING SITE PLAN
Scale: 1:500

Issue For Development Application

	Notes:		Drawing:		Status	Project No.
	All dimensions and levels shall be verified by Contractor		SITE PLAN)	CL24100
	on site prior to commencement of work	PROPOSED WORKS	Address:		1000 0 40	CL24100
	Do not scale from drawings. If in doubt contact Landscape Architect.	CADASTRAL BOUNDARY	Lot 5, DP 24338, 153 McCarrs Creek Rd, Church Point 2105		SCALE - 1:200 @ A3	•
	4. This design is copyright and shall not be copied, utilised	LANDSCAPE AREA (DEEP SOIL)	Project:	Grant Clement		Drawing No. Rev #
	or reproduced in any way without prior written permission of Grant Clement Landscape Architects.	HARD LANDSCAPE . 0 1 2 3 4 5M	Existing Decking Upgrade		1 1 1 1	e: 30.11.23 DA 002 A
9.11.23 For Development Application GC	This plan has been prepared for Development Application purposes only.	- PRIVATE OPEN SPACE		Landscape Architect & Pool Designers 153 McCarrs Creek Rd, Church Point NSW 2105	Checked By JS Plot Dat	e: OF 8
 Date REVISION By	 All Building Works shall be installed to Structural Engineers detail 		AID O A AIDO ICOLEMENT	T: 0451 545 769 E: grant.clement@outlook.com	CAD File Name CLEM_DA_VER_C.vwx]



Issue For Development Application

Notes:

Legend:

1. All dimensions and levels shall be verified by Controctor on site prior to commencement of voic.


2. Drawing:
DEMOLITION PLAN


Address:
Lot 5, DP 24338, 153 McCarrs Creek Rd, Church Point 2105

SCALE - 1:200 @ A3

CL24 100

CL

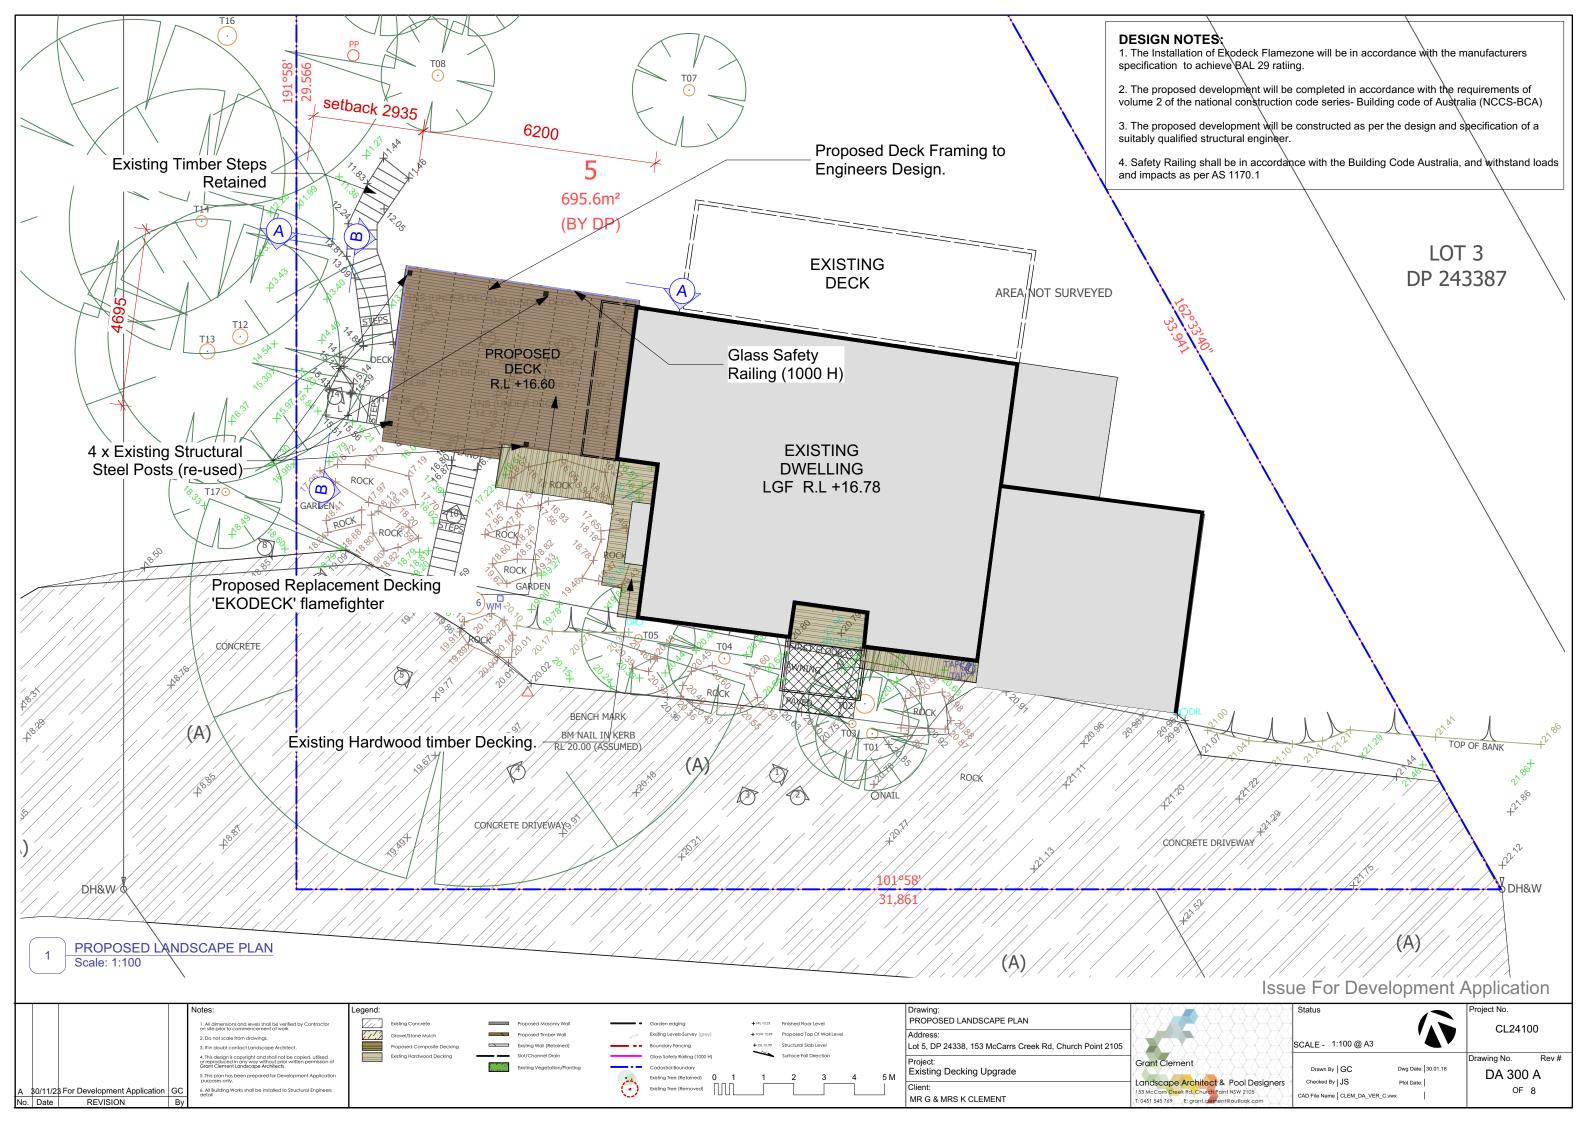

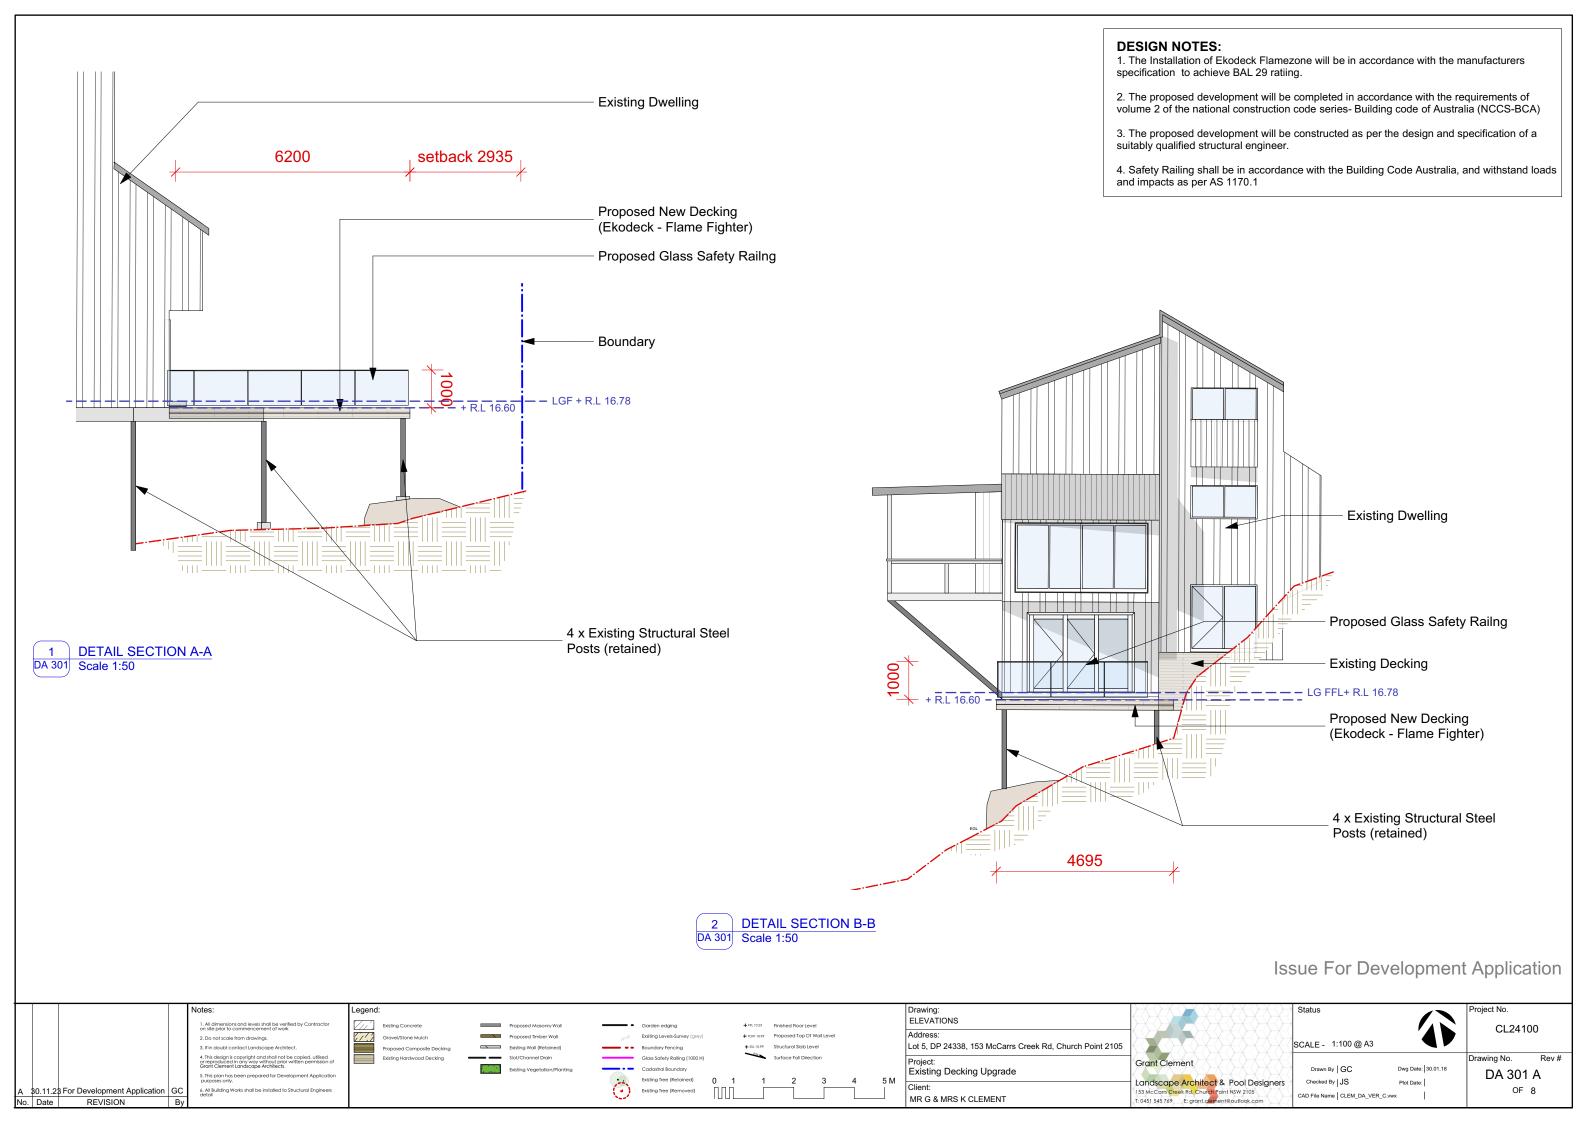

STORMWATER DRAINAGE DESIGN NOTES: 1. EXISTING SURFACE DRAINAGE INLETS SHALL BE UTILISED WHERE AS REQUIRED. 2. ALL PROPOSED PAVING SHALL DRAIN TOWARDS SURROUNDING SOFT LANDSCAPE AREAS, INCLUDING TURF AND GARDEN BEDS. McCARRS CREEK ROADAREA NOT SURVEYED Sediment Fencing - Shall be installed to the lower edge of the work zone as required ,prior to excavation activities. LOT 3 DP 243387 EXISTING DWELLING STRAW BALE AND GEOTEXTILE SEDIMENT FILTER STRING GAUGE WIRE TAUTLY SETWEEN STAKES & FIX WITH STAFLE. FIX MEMBRANE TO STAKES WITH CLOUDS, TURN DOWN SERVIN OVER TOP STRAND AND FIX WITH COUNTINUOUS TIE WIRE LOOPED AT 100 CENTRES. (A) (A) (A) SANDBAG SEDIMENT TRAP FOR KERB INLET ON GRADE SEDIMENT FENCE SITE PLAN **DETAIL - TYPICAL EROSION SEDIMENT CONTROL** Scale 1:200 Issue For Development Application Drawing: SEDIMENT CONTROL PLAN Address: CADASTRAL BOUNDARY SCALE - 1:200 @ A3 2. Do not scale from drawings. Lot 5, DP 24338, 153 McCarrs Creek Rd, Church Point 2105 LANDSCAPE AREA (DEEP SOIL) Orawing No. Project: Existing Decking Upgrade Drawn By | GC DA 302 A Landscape Architect & Pool Designers Checked By | JS

MR G & MRS K CLEMENT

30.11.23 For Development Application GC

6. All Building Works shall be installed to Strudetail

A \$0.11.2\$ For Development A

No. Date REVISION

CL24100

OF 8

CAD File Name | CLEM_DA_VER_C.vwx