Certificate number: 1065350S


Water Commitments		Show on DA plans	Show on CC/CDC plans & specs	Certifier check
Fixtures The applicant must install showerheads with a minimum rating of 3 star (> 7.5 but <= 9 ⊔/min) in	all showers in the development		1	
The applicant must install a toilet flushing system with a minimum rating of 4 star in each toilet in			~	~
The applicant must install taps with a minimum rating of 4 star in the kitchen in the development			~	~
The applicant must install basin taps with a minimum rating of 4 star in each bathroom in the de			~	
Alternative water			×	
Rainwater tank				
The applicant must install a rainwater tank of at least 3000 litres on the site. This rainwater tank accordance with, the requirements of all applicable regulatory authorities.	must meet, and be installed in	~	~	~
The applicant must configure the rainwater tank to collect rain runoff from at least 176 square m development (excluding the area of the roof which drains to any stormwater tank or private dam	etres of the roof area of the	2	~	~
The applicant must connect the rainwater tank to: • all toilets in the development				
the cold water tap that supplies each clothes washer in the development			×	~
at least one outdoor tap in the development (Note: NSW Health does not recommend that ra	inwater be used for human		~	~
consumption in areas with potable water supply.)		1 See 1	×	~
Thermal Comfort Commitments		Show on DA plans	Show on CC/CDC plans & specs	Certifie check
Simulation Method The applicant must attach the certificate referred to under "Assessor Details" on the front page Certificate" to the development application and construction certificate application for the propo	of this BASIX certificate (the "Assest	sor		
applying for a complying development certificate for the proposed development, to that applicati Assessor Certificate to the application for an occupation certificate for the proposed development	on). The applicant must also attach			
The Assessor Certificate must have been issued by an Accredited Assessor in accordance with The details of the proposed development on the Assessor Certificate must be consistent with the				
certificate, including the Cooling and Heating loads shown on the front page of this certificate.		the		-
Assessor Certificate requires to be shown on those plans. Those plans must bear a stamp of er Assessor to certify that this is the case. The applicant must show on the plans accompanying th certificate (or complying development certificate, if applicable), all thermal performance specific: Certificate, and all aspects of the proposed development which were used to calculate those sp	dorsement from the Accredited e application for a construction ations set out in the Assessor	✓	~	~
The applicant must construct the development in accordance with all thermal performance spec Certificate, and in accordance with those aspects of the development application or application which were used to calculate those specifications.	fications set out in the Assessor	ate	~	~
The applicant must construct the floors and walls of the dwelling in accordance with the specific	ations listed in the table below.	~	~	~
Floor and wall construction				
		s		
floor - suspended floor above garage	ment (Note: NSW Health does not recommend that rainwater be used for human ater supply.) Show on CCCCD plans & specs eferred to under "Assessor Details" on the front page of this BASIX certificate (the "Assessor in and construction certificate application. To the proposed development, to it is plans at the head of the proposed development. To that application. The applicant must also attach the an occupation certificate must be consistent with the details shown in this BASIX ing loads shown on the front page of this certificate. Image: Certificate must be consistent with the details shown in this BASIX ing loads shown on the front page of this certificate. Image: Certificate must be consistent with the details shown in this BASIX ing loads shown on the front page of this certificate. Image: Certificate must be consistent with the details shown in this BASIX ing loads shown on the front page of this certificate. Image: Certificate must be consistent with the details shown in the BASIX ing loads shown on the front page of this certificate. Image: Certificate must be consistent with the details shown in the BASIX ing loads shown on the front page of this certificate. Image: Certificate must be consistent with the details shown in the Assessor development application or application for a construction of a construction of a construction for a construction of a construction of a construction development application or applications set out in the Assessor development application or applications are accurate must be a specifications. Image: Certificate Ce		Ĩ.	
Energy Commitments Hot water			Show on CC/CDC plans & specs	Certifier check
The applicant must install the following hot water system in the development, or a system with a instantaneous with a performance of 6 stars.	higher energy rating: gas			
Cooling system				
The applicant must install the following cooling system, or a system with a higher energy rating, airconditioning; Energy rating: EER 3.0 - 3.5	in at least 1 living area: 3-phase		~	~
The applicant must install the following cooling system, or a system with a higher energy rating, airconditioning; Energy rating: EER 3.0 - 3.5	in at least 1 bedroom: 3-phase		~	~
The cooling system must provide for day/night zoning between living areas and bedrooms.			~	~
Heating system				
The applicant must install the following heating system, or a system with a higher energy rating, airconditioning; Energy rating: EER 3.0 - 3.5	in at least 1 living area: 3-phase		~	~
The applicant must install the following heating system, or a system with a higher energy rating, airconditioning; Energy rating: EER 3.0 - 3.5	in at least 1 bedroom: 3-phase		~	~
The heating system must provide for day/night zoning between living areas and bedrooms.			~	~
Ventilation				
The applicant must install the following exhaust systems in the development: At least 1 Bathroom: individual fan, not ducted; Operation control: manual switch on/off				
Kitchen: individual fan, ducted to façade or roof; Operation control: manual switch on/off				1
Laundry: natural ventilation only, or no laundry; Operation control: n/a			Č.	ľ.
Artificial lighting			×	· ·
The applicant must ensure that the "primary type of artificial lighting" is fluorescent or light emitti following rooms, and where the word "dedicated" appears, the fittings for those lights must only	ng diode (LED) lighting in each of th	e or		
 initial of the best of the be		ende		
			~	×
Energy Commitments		Show on DA plans	Show on CC/CDC plans & specs	Certifier check
at least 4 of the living / dining rooms;			~	~
the kitchen;			~	-
			22	~
all bathrooms/toilets;			 	
				~
 all bathrooms/toilets; 			~	~
 all bathrooms/toilets; the laundry; all hallways; Natural lighting 				
 all bathrooms/toilets; the laundry; all hallways; Natural lighting The applicant must install a window and/or skylight in the kitchen of the dwelling for natural light 		~	· ·  all bathrooms/toilets; the laundry; all hallways; Natural lighting 		> > >	• • • •	· · · · · · · · · · · · · · · · · · ·
 all bathrooms/toilets; the laundry; all hallways; Natural lighting The applicant must install a window and/or skylight in the kitchen of the dwelling for natural light The applicant must install a window and/or skylight in 3 bathroom(s)/toilet(s) in the development Other		> > > >	· · all bathrooms/toilets; the laundry; all hallways; Natural lighting The applicant must install a window and/or skylight in the kitchen of the dwelling for natural light The applicant must install a window and/or skylight in 3 bathroom(s)/toilet(s) in the development Other The applicant must install a gas cooktop & electric oven in the kitchen of the dwelling.		> > 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all bathrooms/toilets; the laundry; all hallways; Natural lighting The applicant must install a window and/or skylight in the kitchen of the dwelling for natural light The applicant must install a window and/or skylight in 3 bathroom(s)/toilet(s) in the development Other The applicant must install a gas cooktop & electric oven in the kitchen of the dwelling.	for natural lighting.	V		· · ·
 all bathrooms/toilets; the laundry; all hallways; Natural lighting The applicant must install a window and/or skylight in the kitchen of the dwelling for natural light The applicant must install a window and/or skylight in 3 bathroom(s)/toilet(s) in the development Other The applicant must install a gas cooktop & electric oven in the kitchen of the dwelling. The applicant must install a fixed outdoor clothes drying line as part of the development.	for natural lighting.	V		
all bathrooms/toilets; the laundry; all hallways; Matural lighting The applicant must install a window and/or skylight in the kitchen of the dwelling for natural light The applicant must install a window and/or skylight in 3 bathroom(s)/toilet(s) in the development Other The applicant must install a gas cooktop & electric oven in the kitchen of the dwelling. The applicant must install a fixed outdoor clothes drying line as part of the development. QUOTE DATE QUOTE	for natural lighting.	V		



AREAS	
SITE:	344.10 m ²
GROUND FLOOR:	96.13 m ²
FIRST FLOOR:	109.58 m ²
GARAGE:	33.18 m ²
PORCH:	8.00 m ²
BALCONY:	5.80 m ²
ALFRESCO:	25.98 m ²
	m²
TOTAL:	278.67 m ²

2.5	SITE COVERAGE & LANDSCAPE
2.4	NEIGHBOUR NOTIFICATION PLAN
2.3	SHADOW DIAGRAM
2.2	SITE ANALYSIS PLAN
2.1	CONSTRUCTION MANAGEMENT

	TILES			-							
	CARPET			-							
	ZURCORP			-						10	WET AREA DETAILS
	EHI			-	G	12.02.20	HYDRAULICS CO-ORDINA	TED	M.H.	9	WET AREA DETAILS
	AIR CONDITIONING			-	F	10.02.20	SPREADEDR DELETED, D	P'S ADDED	M.H.	8	ELECTRICAL LAYOUT
	STAIRS			-	Е	02.01.20	DA DRAWINGS		PG/mh	7	SECTION
	LANDSCAPE				D	11.12.19	BASIX AMENDMENTS		M.H.	6	ELEVATIONS
	HYDRAULICS				С	05.12.19	POST CONTRACT VARIAT	TION # 1	MCA	5	ELEVATIONS
	ENGINEER				В	26.11.19	CONTRACT DRAWINGS		PG.	4	FIRST FLOOR PLAN
	PEG OUT			-	А	11.11.19	TENDER		BG	3	GROUND FLOOR PLAN
					REV	DATE	AMENDMENTS		BY	2	SITE PLAN
•									<u> </u>	1	COVER SHEET
LIENT	T'S SIGNATURE:		DATE:		_					SHEET	DESCRIPTION
	larendonHo	mes	© ALL RIGHTS RESER				26	CLIENT: Mr. CARRAGHER			DA DRAWINGS
BL No. 2 ABN 18 (2298C 003 892 706		Any copying or altering of the drawing shall not b undertaken without writte permission from CLARENDON HOMES (be en	Har R/H	nptons I Garage		Mrs. CARRAGHER SITE ADDRESS: Lot 3 No.73, D.P: 270907		DRAWN: PG. RATIO @ N\A	DATE: 26.11.19 @ A3: CHECKED: J.S
21 So	ndon Homes (NSW) P/L blent Circuit, Baulkham Hills NSW 2153 2) 8851 5300		# ALL DIMENSIONS TO STI ELEMENTS. DIMENSIONS T IN PREFERENCE TO SCAL	RUCTURA	Sap	phire Spe r Issued: 22.08.	ecification 19 Revision: B	Lorikeet Grove WARRIEWOOD 2102		SHEET:	1 ^{JOB NO:} 29913970 NSW

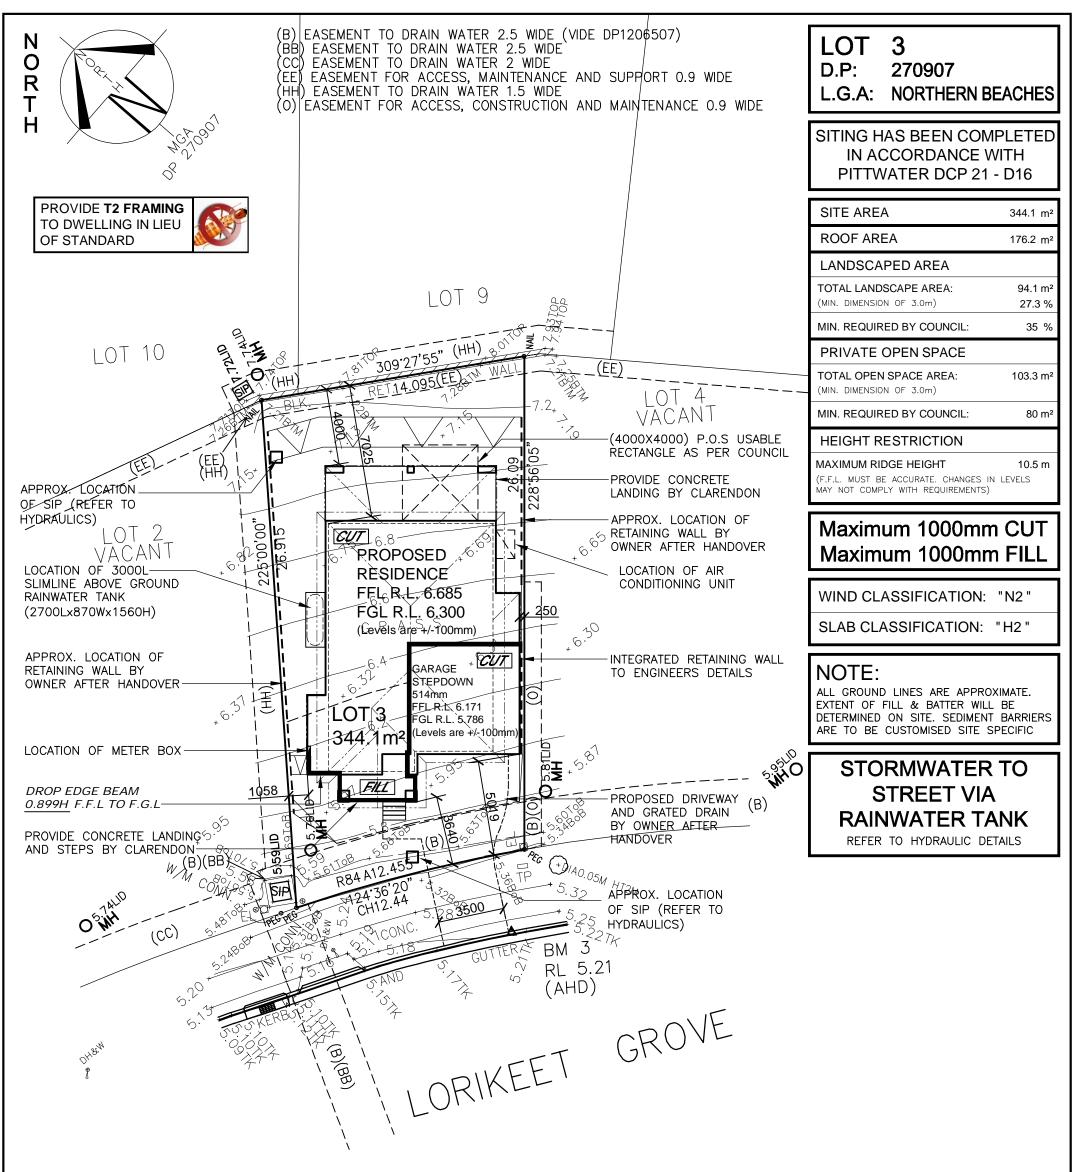

SITE PLAN

OHSIM

1


SCALE 1:200


GENERAL NOTES


 A) THIS SURVEY IS SPECIFICALLY FOR CONTOUR PURPOSES ONLY. THE BOUNDARIES OF THE SUBJECT PROPERTY HAVE NOT BEEN INVESTIGATED
 B) AREAS AND DIMENSIONS ARE SUBJECT TO SURVEY
 C) SERVICES SHOWN HAVE BEEN DERIVED FROM VISUAL EVIDENCE APPARENT AT THE TIME OF SURVEY. THE RELEVANT SERVICE AUTHORITY SHALL BE CONTACTED TO VERIFY THE EXISTENCE AND POSITION OF ALL SERVICES PRIOR TO THE COMMENCEMENT OF ANY CONSTRUCTION OR EXCAVATION
 D) CONTOURS ARE INDICATIVE OF SURFACE TOPOGRAPHY ONLY. SURVEYED SPOT LEVELS ARE THE ONLY VALUES TO BE RELIED ON FOR REDUCED LEVELS ON PARTICULAR FEATURES.

BOUNDARY R.L. 5.282 5.612 STREET R 5.921 <u>WALL</u> 5 빙 ند| لار Ľ. <u>ب</u>ـ۱ **Å**R ľ GARAGE FLOOR LEVEL 12.5% 22.5% FFL RL6.17 6 16.5% EXISTING GRADE (4%) RL5.180 LEVEL WITH T.K T.K. RL5.180 3800 2000 1370 2000 TRANSITION VARIABLE TRANSITION 4250 5370 EXISTING CROSSOVER SETBACK TO GARAGE DRIVEWAY GRADIENT PROFILE SCALE-1:100


CLIENT'S SIGNATURE:	DATE:					
ClarendonHomes	© ALL RIGHTS RESERVED This plan is the property of CLARENDON HOMES (NSW) P/L	PRODUCT: BRONTE 26	CLIENT: Mr. CARRAGHER		DA DRAWINGS	
	Any copying or altering of the drawing shall not be	Hamptons	Mrs. CARRAGHER	DRAWN:	DATE:	Rev:
BL No. 2298C ABN 18 003 892 706	undertaken without written permission from	R/H Garage	site address: Lot 3 No.73, D.P: 270907	BG RATIO @ A3: 1:200	11.11.19 CHECKED: BG	G
Clarendon Homes (NSW) P/L 21 Solent Circuit, Baulkham Hills NSW 2153 T: (02) 8851 5300	CLARENDON HOMES (NSW) P/L # ALL DIMENSIONS TO STRUCTURAL ELEMENTS. DIMENSIONS TO BE READ IN PREFERENCE TO SCALING.	Sapphire Specification	Lorikeet Grove WARRIEWOOD 2102	SHEET:	JOB No: 29913970	NSW

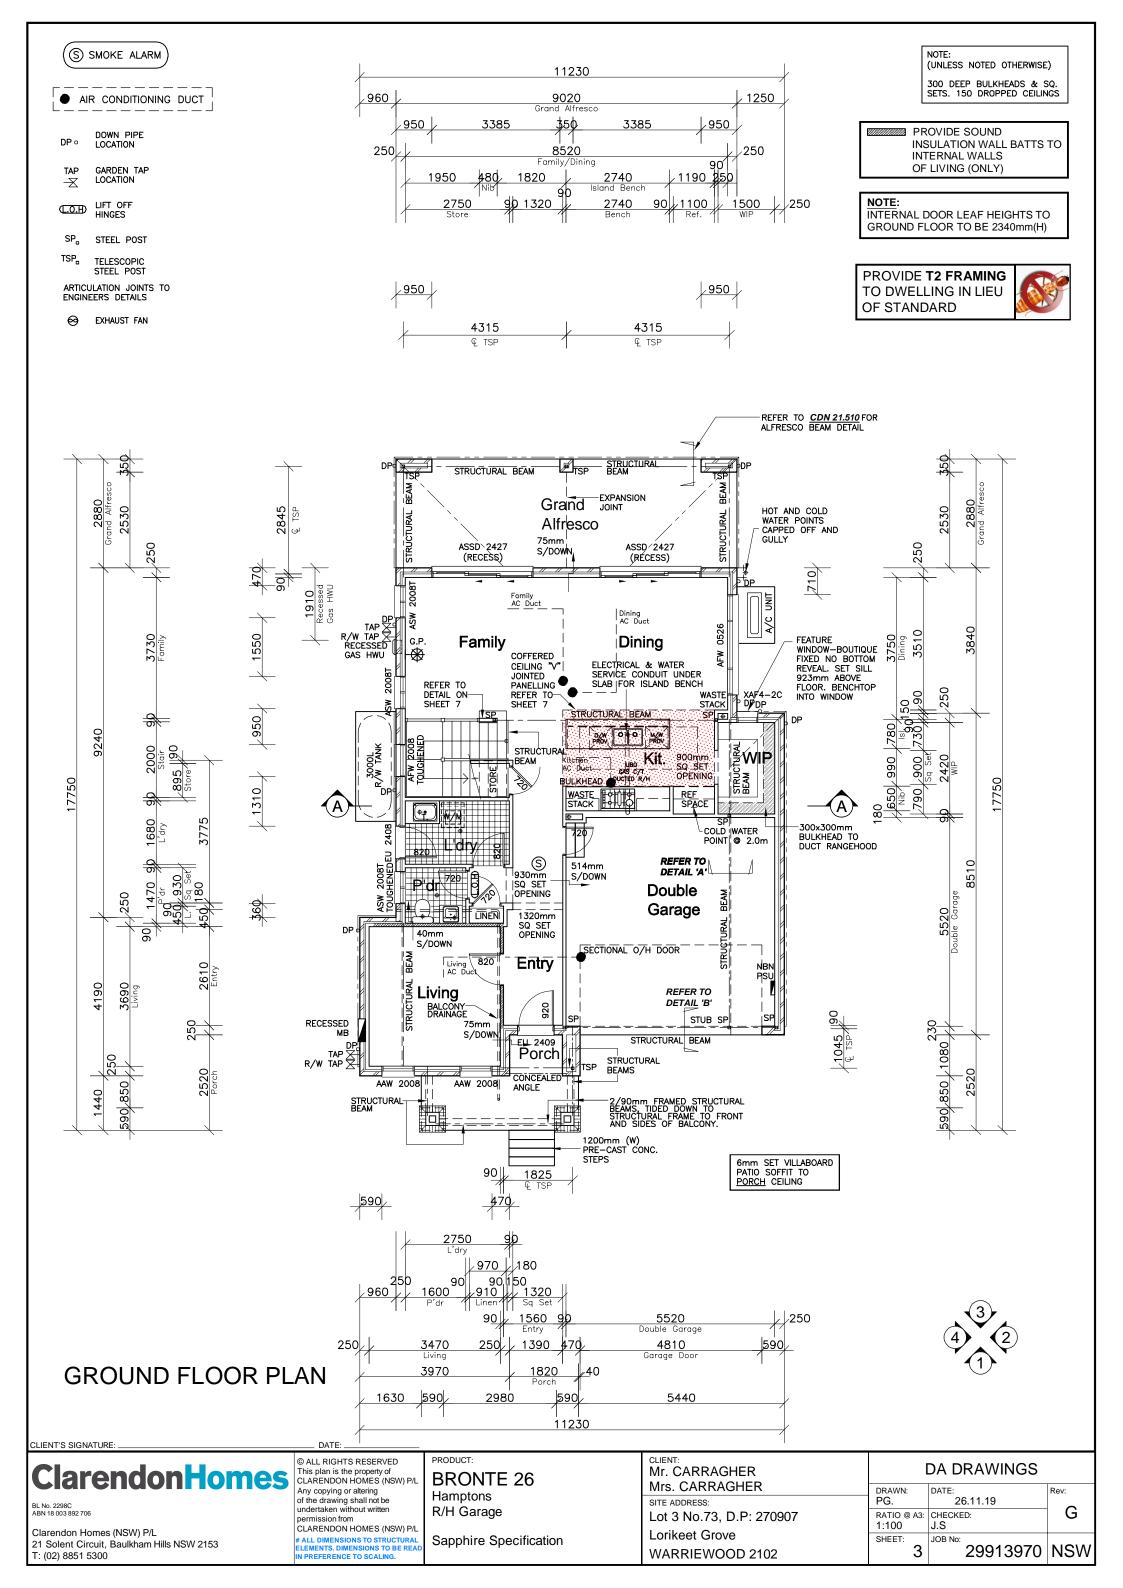

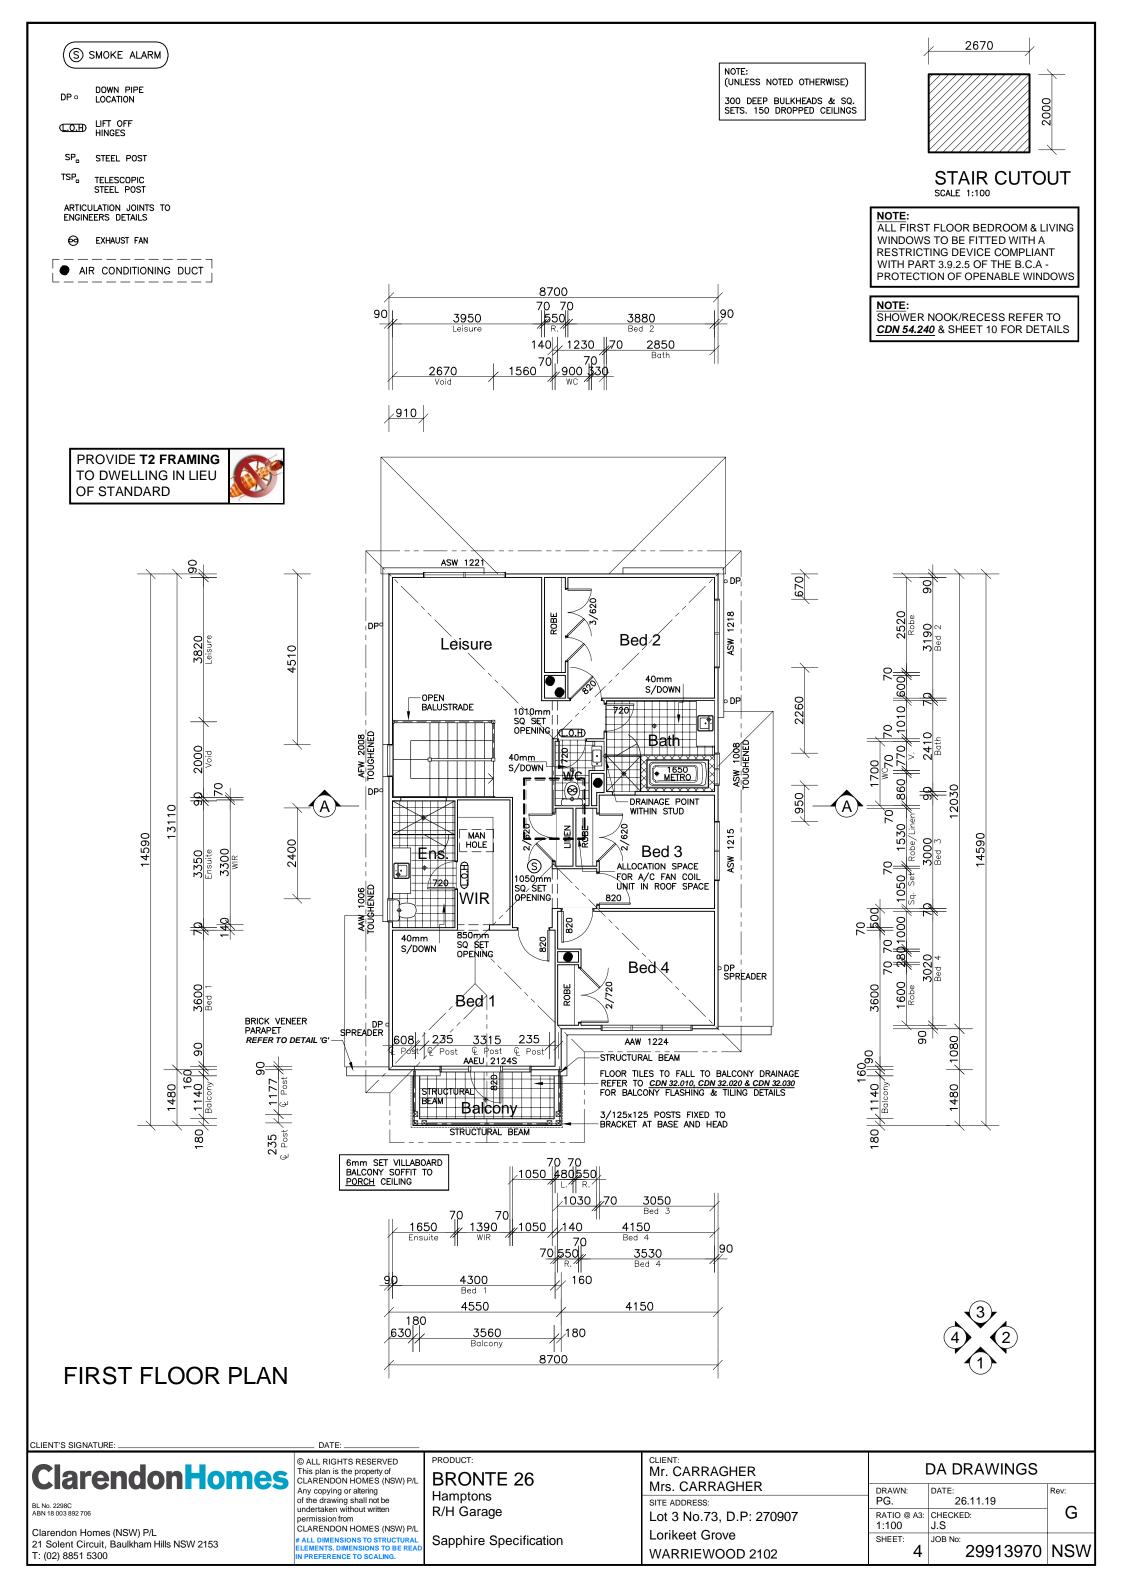


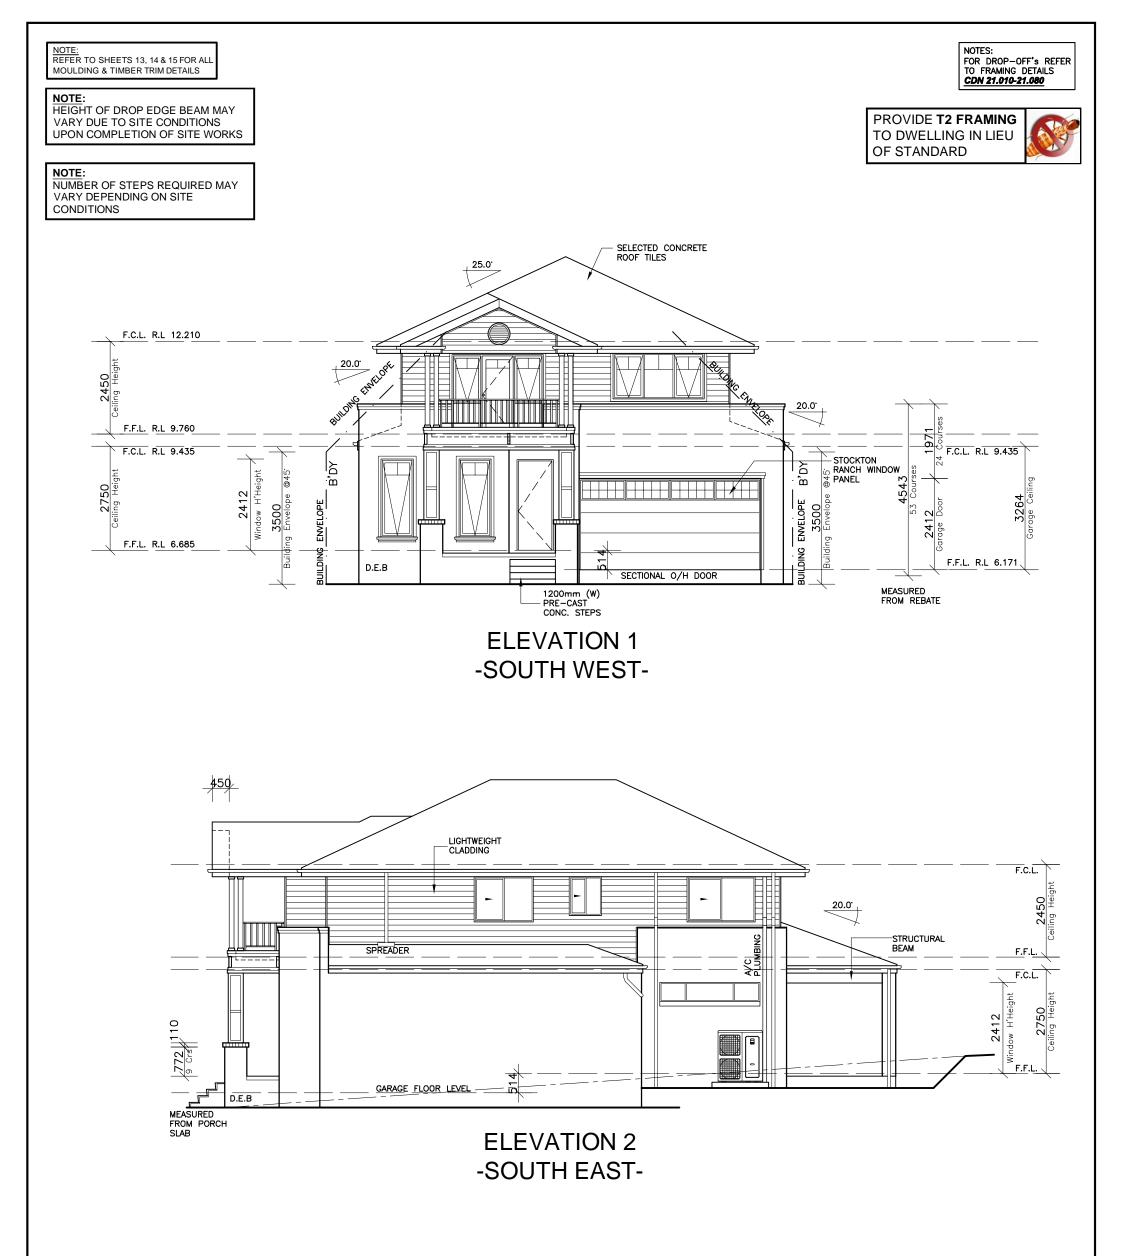

CLIENT'S SIGNATURE:	DATE:					
ClarendonHomes	© ALL RIGHTS RESERVED This plan is the property of CLARENDON HOMES (NSW) P/L	PRODUCT: BRONTE 26	CLIENT: Mr. CARRAGHER		DA DRAWINGS	
BL No. 2298C ABN 18 003 892 706	Any copying or altering of the drawing shall not be undertaken without written permission from CLARENDON HOMES (NSW) P/L	Hamptons R/H Garage	Mrs. CARRAGHER SITE ADDRESS: Lot 3 No.73, D.P: 270907	DRAWN: PG. RATIO @ A3: 1:100	26.11.19	Rev:
Clarendon Homes (NSW) P/L 21 Solent Circuit, Baulkham Hills NSW 2153 T: (02) 8851 5300	# ALL DIMENSIONS TO STRUCTURAL ELEMENTS. DIMENSIONS TO BE READ IN PREFERENCE TO SCALING.	Sapphire Specification	Lorikeet Grove WARRIEWOOD 2102	SHEET: 5	JOB No: 29913970	NSW

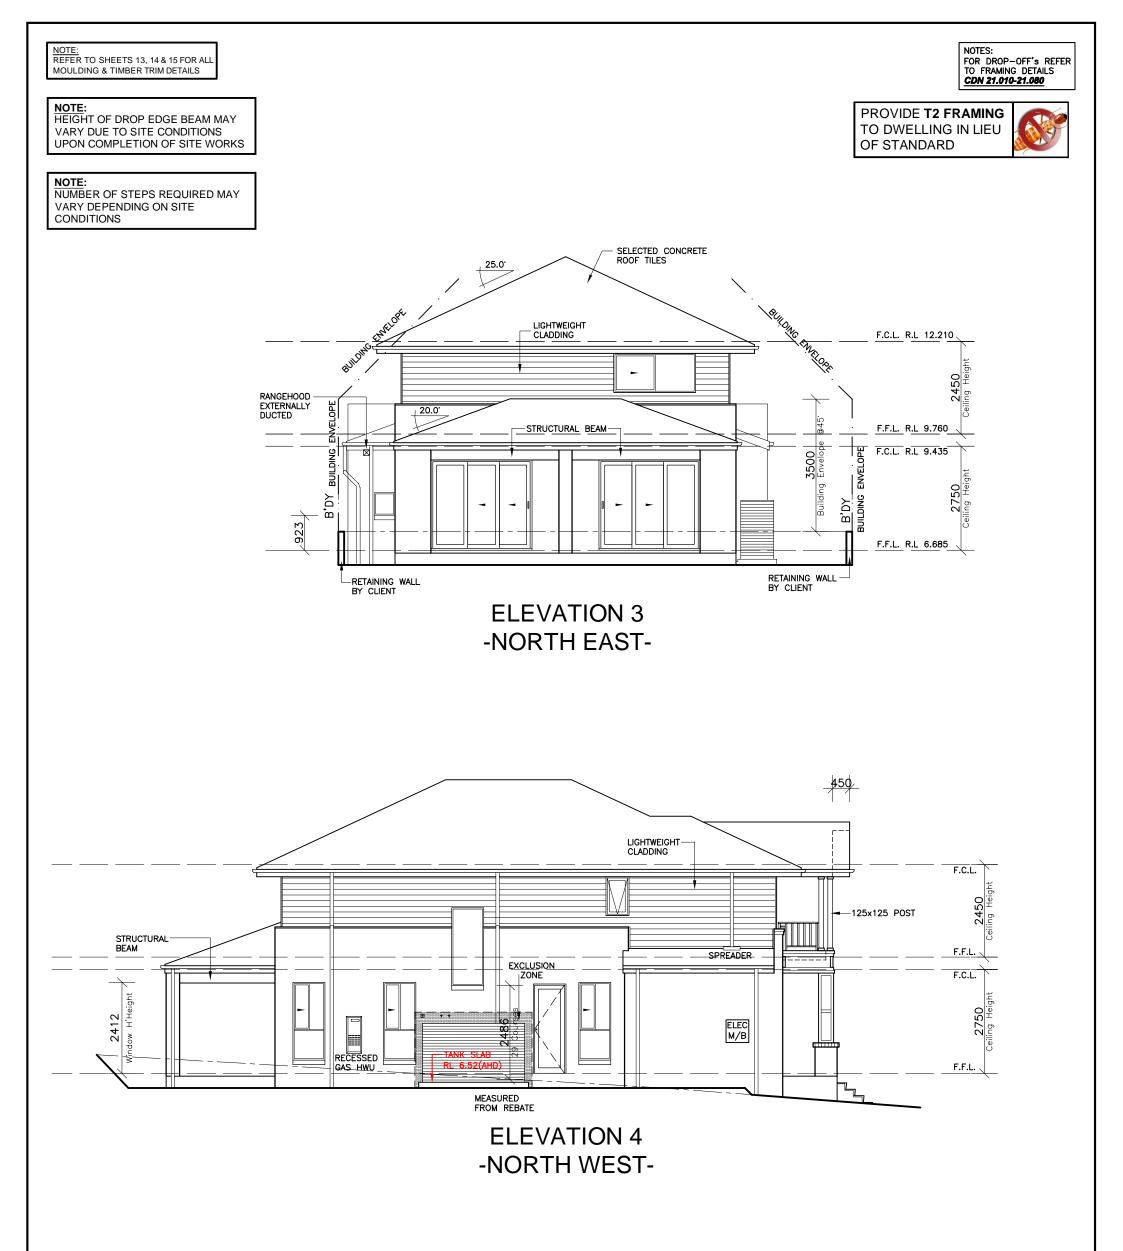

CLIENT'S SIGNATURE:	DATE:					
ClarendonHomes	© ALL RIGHTS RESERVED This plan is the property of CLARENDON HOMES (NSW) P/L	PRODUCT: BRONTE 26	CLIENT: Mr. CARRAGHER	l	DA DRAWINGS	
BL No. 2298C ABN 18 003 892 706	Any copying or altering of the drawing shall not be undertaken without written permission from CLARENDON HOMES (NSW) P/L	Hamptons R/H Garage	Mrs. CARRAGHER SITE ADDRESS: Lot 3 No.73, D.P: 270907	PG. RATIO @ A3:	26.11.19	Rev:
Clarendon Homes (NSW) P/L 21 Solent Circuit, Baulkham Hills NSW 2153 T: (02) 8851 5300	# ALL DIMENSIONS TO STRUCTURAL ELEMENTS. DIMENSIONS TO BE READ IN PREFERENCE TO SCALING.	Sapphire Specification	Lorikeet Grove WARRIEWOOD 2102	SHEET: 6	^{JOB No:} 29913970	NSW

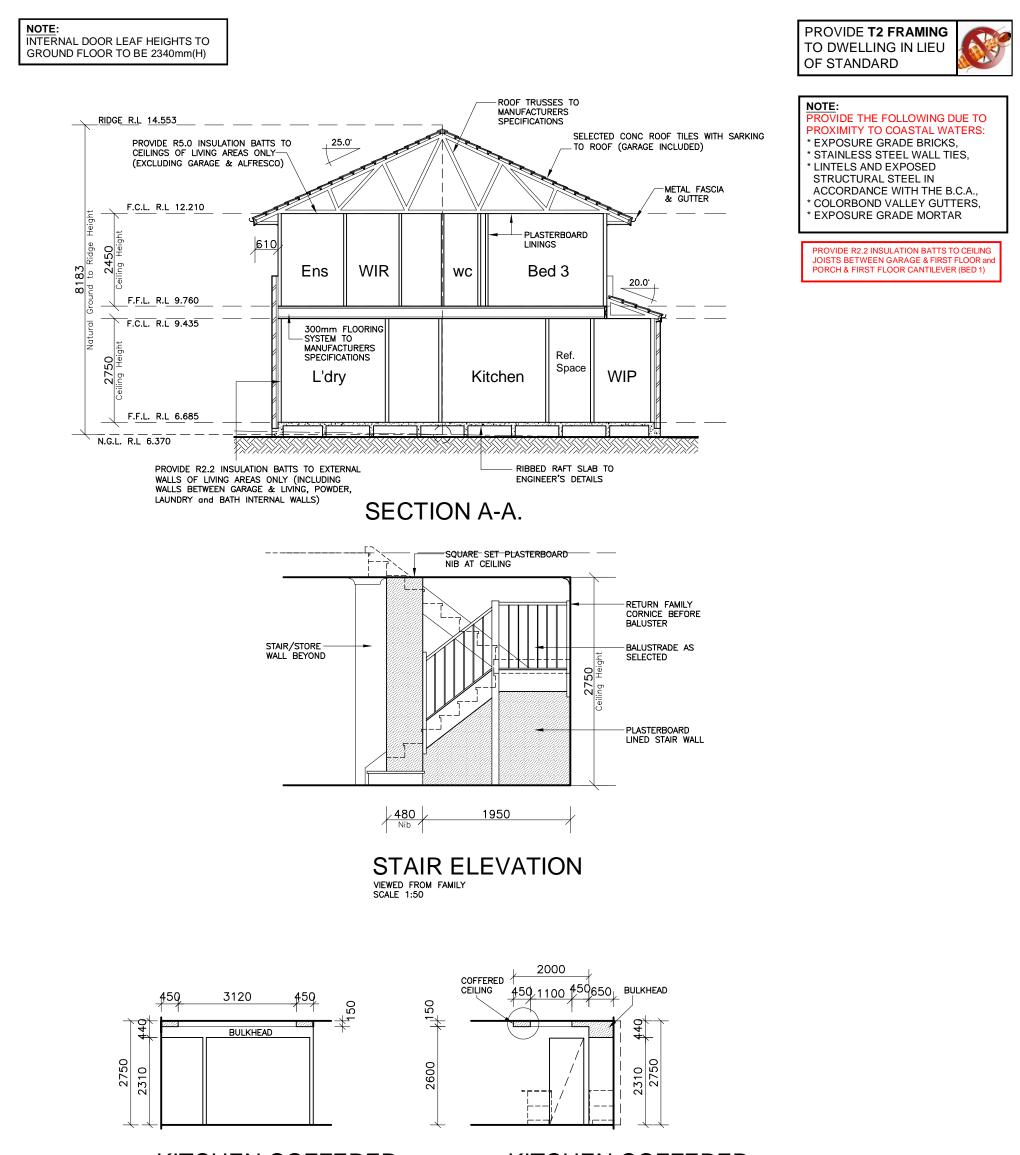

KITCHEN COFFERED


KITCHEN COFFERED

CEILING DETAIL VIEWED FROM MEALS RM


CEILING DETAIL

VIEWED FROM FAMILY RM

CLIENT'S SIGNATURE:	DATE:					
ClarendonHomes	© ALL RIGHTS RESERVED This plan is the property of CLARENDON HOMES (NSW) P/L	PRODUCT: BRONTE 26	CLIENT: Mr. CARRAGHER		DA DRAWINGS	
BL No. 2298C ABN 18 003 892 706	Any copying or altering of the drawing shall not be undertaken without written permission from	Hamptons R/H Garage	Mrs. CARRAGHER SITE ADDRESS: Lot 3 No.73, D.P: 270907	DRAWN: PG. RATIO @ A3:	26.11.19	Rev:
Clarendon Homes (NSW) P/L 21 Solent Circuit, Baulkham Hills NSW 2153 T: (02) 8851 5300	CLARENDON HOMES (NSW) P/L # ALL DIMENSIONS TO STRUCTURAL ELEMENTS. DIMENSIONS TO BE READ IN PREFERENCE TO SCALING.	Sapphire Specification	Lorikeet Grove WARRIEWOOD 2102	1:100 SHEET: 7	J.S ^{JOB No:} 29913970	NSW

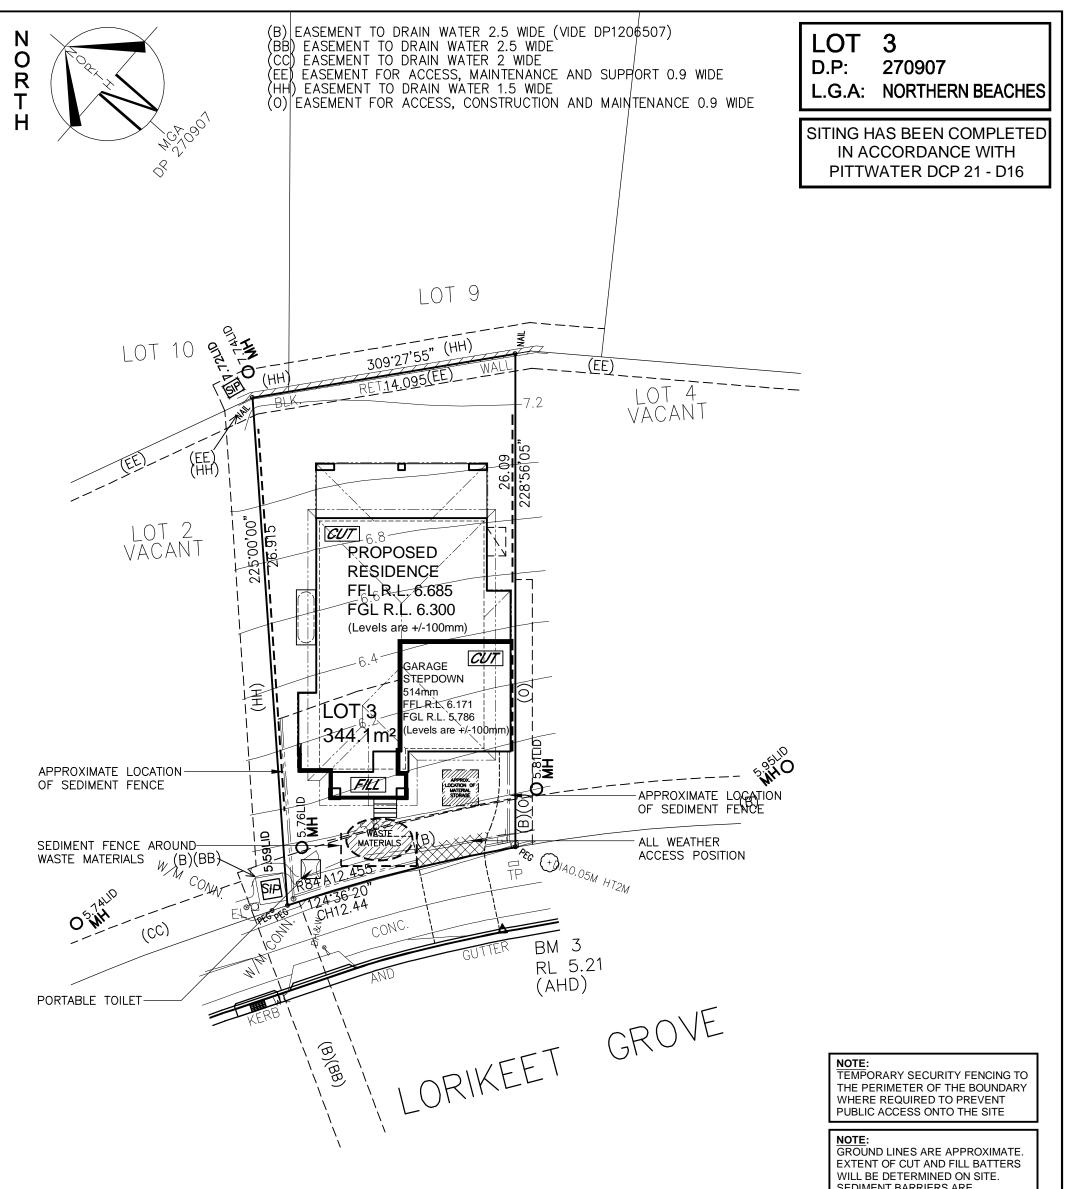



CUSTOMISED TO SITE CONDITIONS

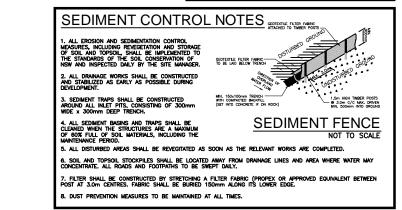


CONSTRUCTION MANAGEMENT PLAN
EROSION AND SEDIMENT CONTROL PLAN

CLIENT'S SIGNATURE:	DATE:					
ClarendonHomes	© ALL RIGHTS RESERVED This plan is the property of CLARENDON HOMES (NSW) P/L	PRODUCT: BRONTE 26	CLIENT: Mr. CARRAGHER		DA DRAWINGS	
BL No. 2298C	of the drawing shall not be	Hamptons	Mrs. CARRAGHER SITE ADDRESS:	DRAWN: PG.	DATE: 26.11.19	Rev:
ABN 18 003 892 706 Clarendon Homes (NSW) P/L	undertaken without written permission from CLARENDON HOMES (NSW) P/L	R/H Garage	Lot 3 No.73, D.P: 270907	RATIO @ A3: 1:200	CHECKED: J.S	G
21 Salant Circuit, Doubleam Hills NSW 2152	# ALL DIMENSIONS TO STRUCTURAL ELEMENTS. DIMENSIONS TO BE READ IN PREFERENCE TO SCALING.	Sapphire Specification	Lorikeet Grove WARRIEWOOD 2102	SHEET: 2.1	JOB No: 29913970	NSW

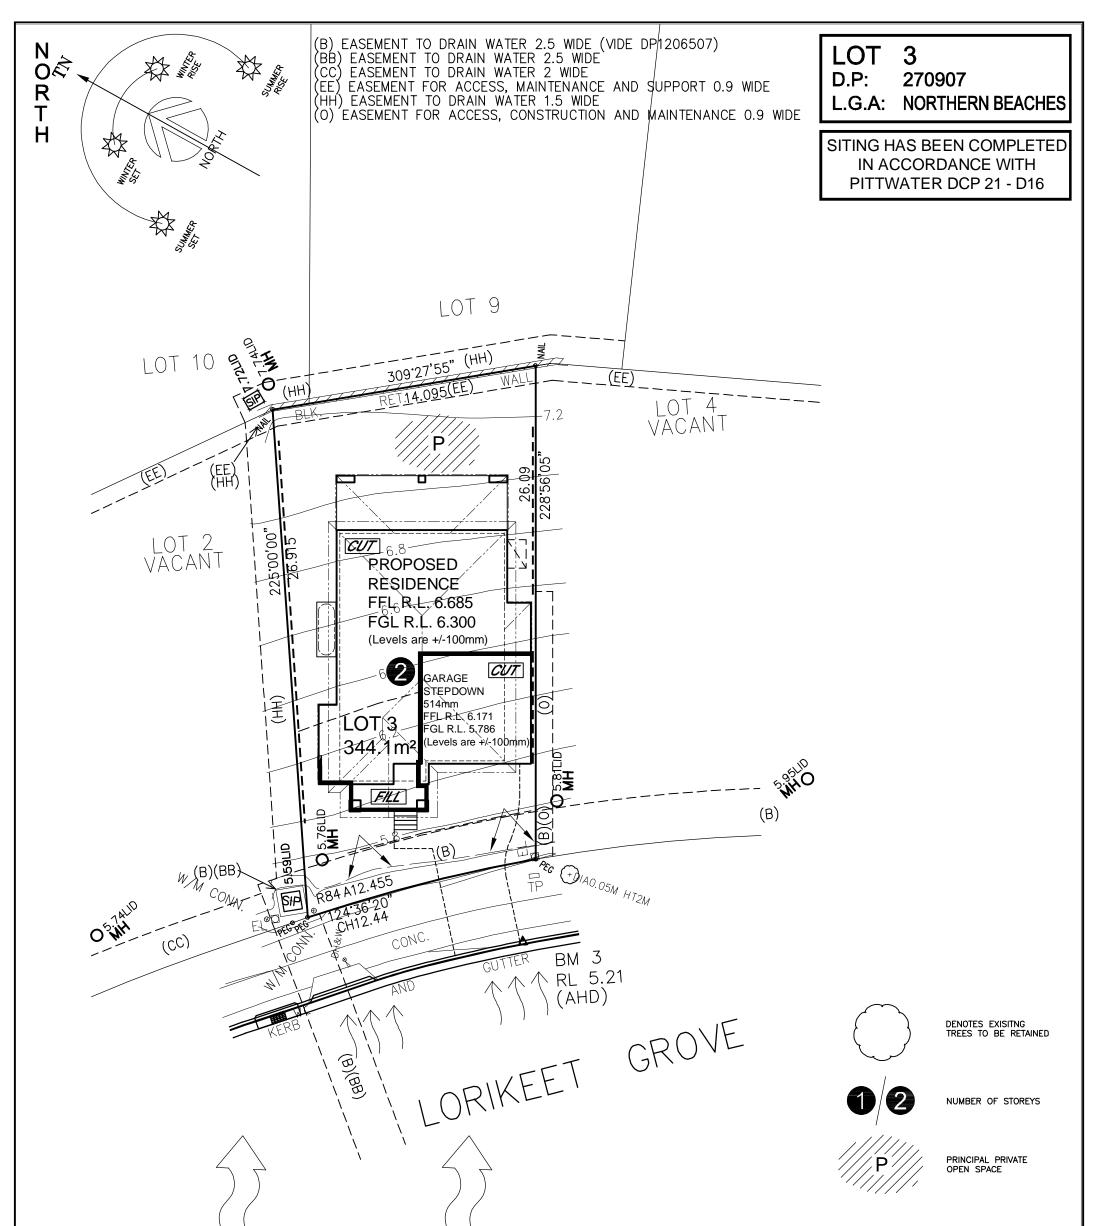


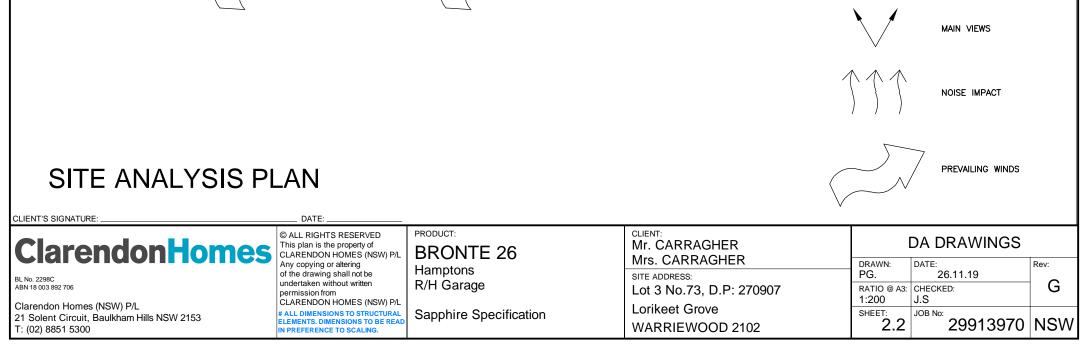

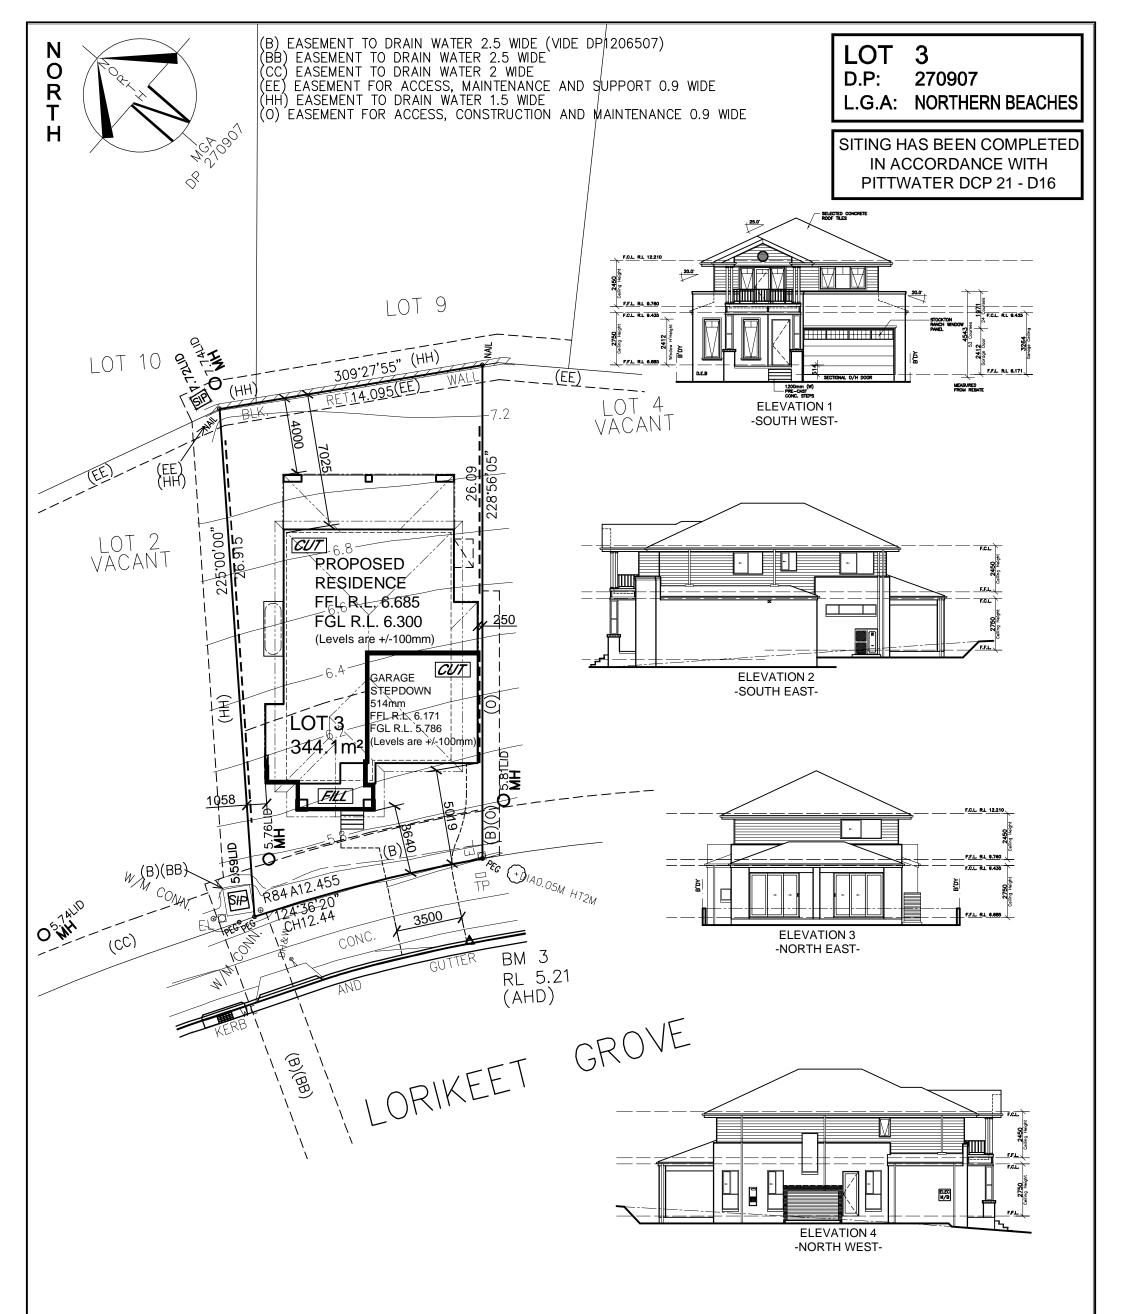


NEIGHBOUR NOTIFICATION PLAN

CLIENT'S SIGNATURE:	DATE:					
ClarendonHomes	© ALL RIGHTS RESERVED This plan is the property of CLARENDON HOMES (NSW) P/L	PRODUCT: BRONTE 26	CLIENT: Mr. CARRAGHER	I	DA DRAWINGS	
	Any copying or altering of the drawing shall not be	Hamptons	Mrs. CARRAGHER	DRAWN: PG.	DATE: 26.11.19	Rev:
BL No. 2298C ABN 18 003 892 706	undertaken without written permission from	R/H Garage	SITE ADDRESS: Lot 3 No.73, D.P: 270907	RATIO @ A3:		G
Clarendon Homes (NSW) P/L 21 Solent Circuit, Baulkham Hills NSW 2153 T: (02) 8851 5300	CLARENDON HOMES (NSW) P/L # ALL DIMENSIONS TO STRUCTURAL ELEMENTS. DIMENSIONS TO BE READ IN PREFERENCE TO SCALING.	Sapphire Specification	Lorikeet Grove WARRIEWOOD 2102		J.S JOB No: 29913970	NSW

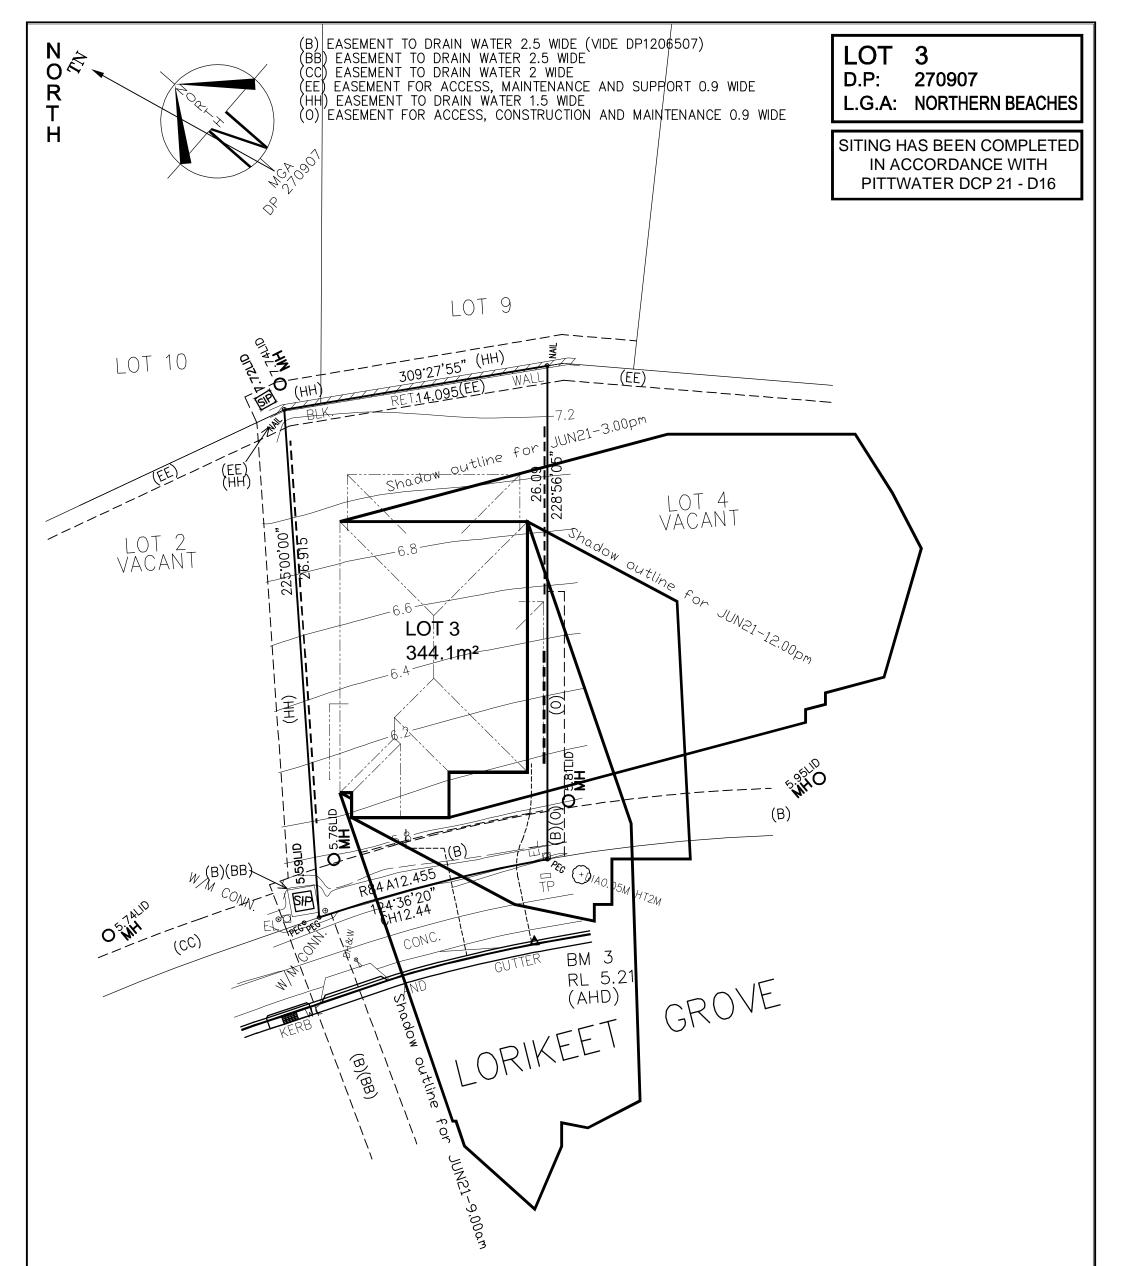

SHADOW DIAGRA	.M @ 21st J	IUNE		0 5 5	HADOW CAST AT 9.0 N JUNE 21st HADOW CAST AT 12. N JUNE 21st HADOW CAST AT 3.0 N JUNE 21st	00pm
Clarendon Homes	© ALL RIGHTS RESERVED This plan is the property of CLARENDON HOMES (NSW) P/L Any copying or altering of the drawing shall not be undertaken without written permission from CLARENDON HOMES (NSW) P/L	PRODUCT: BRONTE 26 Hamptons R/H Garage	CLIENT: Mr. CARRAGHER Mrs. CARRAGHER SITE ADDRESS: Lot 3 No.73, D.P: 270907	DRAWN: PG. RATIO @ A3: 1:200	DA DRAWINGS	Rev:
Clarendon Homes (NSW) P/L 21 Solent Circuit, Baulkham Hills NSW 2153 T: (02) 8851 5300	# ALL DIMENSIONS TO STRUCTURAL ELEMENTS. DIMENSIONS TO BE READ IN PREFERENCE TO SCALING.	Sapphire Specification	Lorikeet Grove WARRIEWOOD 2102	SHEET: 2.4	Јов №: 29913970	NSW

SHADOW

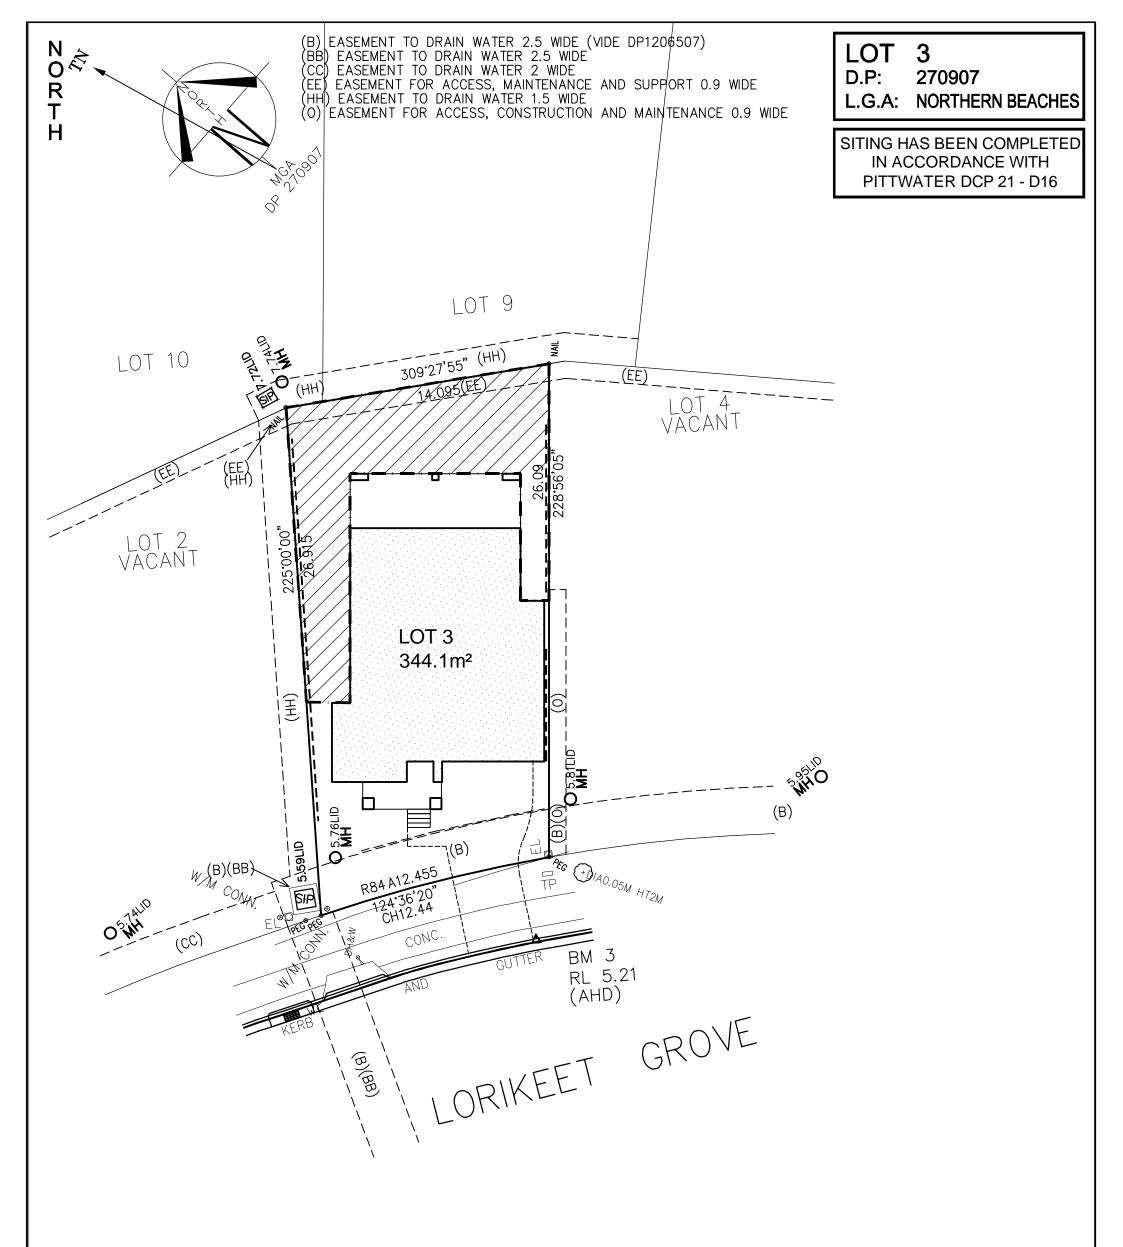


SITE COVERAGE & LANDSCAPE PLAN

CLIENT'S SIGNATURE:	DATE:						
ClarendonHomes	© ALL RIGHTS RESERVED This plan is the property of CLARENDON HOMES (NSW) P/L	PRODUCT: BRONTE 26	CLIENT: Mr. CARRAGHER	DA DRAWINGS			
BL No. 2298C	Any copying or altering of the drawing shall not be	Hamptons	Mrs. CARRAGHER	DRAWN: PG.	DATE: 26.11.19	Rev:	
ABN 18 003 892 706	undertaken without written permission from	R/H Garage	Lot 3 No.73, D.P: 270907	RATIO @ A3: 1:200	CHECKED: J.S	G	
Clarendon Homes (NSW) P/L 21 Solent Circuit, Baulkham Hills NSW 2153 T: (02) 8851 5300	CLARENDON HOMES (NSW) P/L # ALL DIMENSIONS TO STRUCTURAL ELEMENTS. DIMENSIONS TO BE READ IN PREFERENCE TO SCALING.		Lorikeet Grove WARRIEWOOD 2102	SHEET: 2.5	JOB No: 29913970	NSW	

PRIVATE OPEN SPACE AREA = 107.30m² LANDSCAPE AREA = $97.30m^2$

SITE COVERAGE AREA = 129.82m²



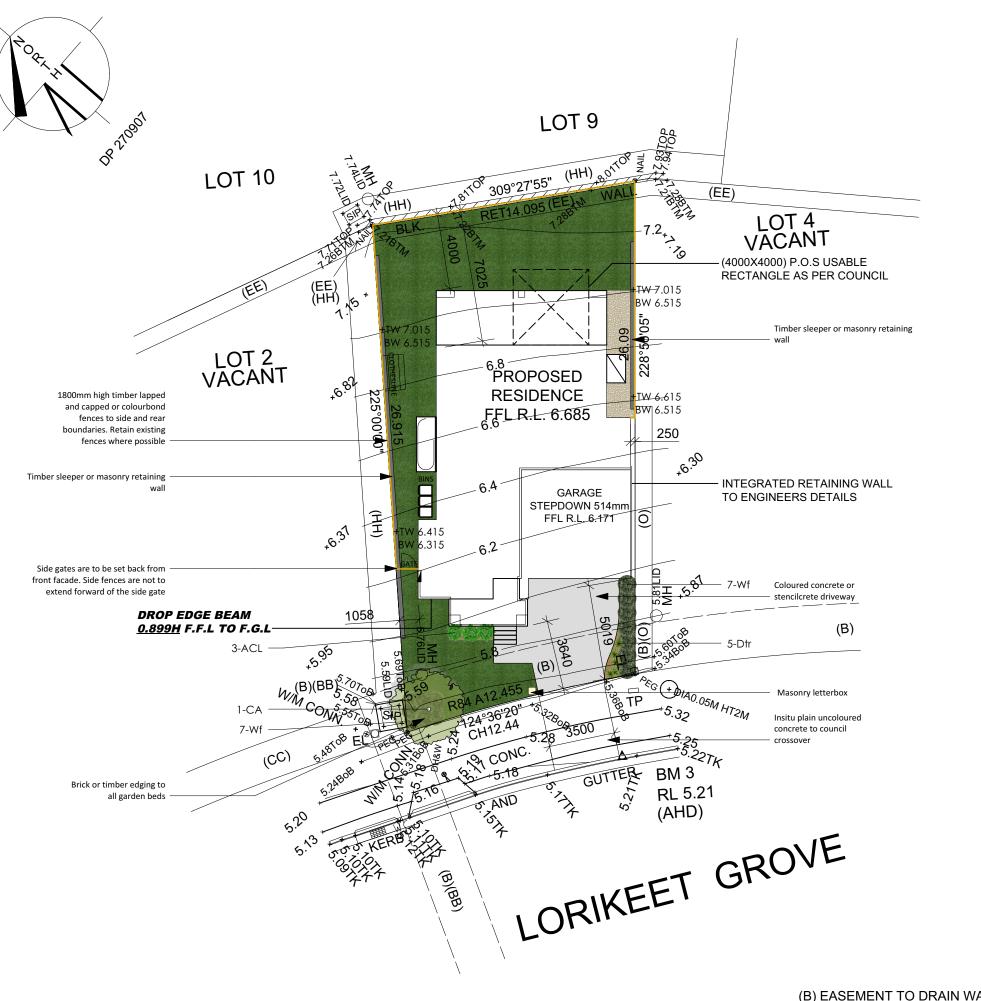

Any existing trees are to be protected in accordance with councils Tree Protection Detail

Click Here to View C

Legend

(B) EASEMENT TO DRAIN WATER 2.5 WIDE (VIDE DP1206 (BB) EASEMENT TO DRAIN WATER 2.5 WIDE (CC) EASEMENT TO DRAIN WATER 2 WIDE ÈEÉ) EASEMENT FOR ACCESS, MAINTENANCE AND SUPI (HH) EASEMENT TO DRAIN WATER 1.5 WIDE

(O) EASEMENT FOR ACCESS, CONSTRUCTION AND MAIL

	Revisi					
Colour / Stencil Concrete	lssue:	Descripti	on:	By:	Date:	
Pebbles / Decorative Gravel Areas	А	Submission	Plan	JS	09/12/19	
Planting Areas Lawn Areas						
Retaining Wall						
1800mm High Boundary Fencing						
	Drafte	-	Scal	e: 1:2	00 зм	
		JS				
	Sheet:					
	1	1 of 4 LP 01				
	Designed by:					
	Julian Saw Diploma of Horticulture (Landscape Design)					
	General Notes: 1. See Architects drawings for site levels, setbacks and extent of cut and fill. 2. This plan shall be read in conjunction with the Hydraulic Engineers drawings. 3. All relevant australian standards are to be adhered to. 4. Any structural items are to be installed as per the manufacturer/engineers specifications. 5. This plan is indicative only and not for construction purpose					
	SITE CALCULATIONS					
	LOT AREA	OT AREA 344.1 sq m				
	LANDSCAF	ED AREA TOTAL	94.1 sq	m 2	7.345%	
	Click H	ere to View	Our Pla	ant Pro	ofiles!	
	Client:	ent: Mr Carragher Mrs Carragher				
	Client	nt Signatures:				
	1.					
	2.					
	Job No	19043	3			
	Drawir	Orawing: Landscape Plan Address: Lot 3, No.73 Lorikeet Gro Warriewood				
	Addre					
	Counc	il: North	ern E	Beach	nes	
View Our Plant Profiles! DP1206507)	Do	apple	De	síg	ns	
ND SUPPORT 0.9 WIDE						
ND MAINTENANCE 0.9 WIDE	www	Ph: 0437 .dappled				

LANDSCAPE SPECIFICATION

SITE ESTABLISHMENT

ALL RUBBISH, DEBRIS, FALLEN BRANCHES SHALL BE CLEARED FROM LANDSCAPED AREAS AND DISPOSED OF USING SKIP BINS ONSITE OR BY TRANSPORTING TO THE LOCAL WASTE MANANAGEMENT FACILITY. ANY UNUSED BRICKS, CONCRETE BLOCKS OR TIMBER SHOULD BE EITHER RE-USED ONSITE WHERE POSSIBLE OR RECYCLED AT THE LOCAL WASTE MANANAGEMENT FACILITY.

TREE PROTECTION

TREES TO BE RETAINED SHALL BE PROTECTED DURING SITE WORKS AND TREE PROTECTION BARRIERS INSTALLED ACCORDING TO TREE PROTECTION DETAILS. NO EXCAVATION OR CHANGE IN SOIL LEVEL SHOULD TAKE PLACE AROUND THE BASE OF SUCH TREES. ANY ARBORIST REPORT MUST BE ADHERED TO AND TREE PROTECTION ZONES MAINTAINEDWHERE APPLICABLE.

WEED ERADICATION

AREAS TO BE LANDSCAPED ARE TO BE SPRAYED WITH GLYPHOSATE AT THE RECOMMENDED RATE AT LEAST 1 WEEK PRIOR TO ANY LANDSCAPE WORKS TAKING PLACE IN ORDER TO ALLOW WEEDS TO DIE OFF. CARE IS TO BE TAKEN TO PROTECT REMAINING VEGETATION FROM THE HERBICIDE APPLICATION AND SHOULD ONLY BE UNDERTAKEN IN STILL WEATHER. ALL WEEDS ARE THEN TO BE DISPOSED OF APPROPRIATELY AT THE LOCAL WASTE MANANAGEMENT FACILITY.

GARDEN BED PREPERATION

ENSURE ALL GARDEN BEDS HAVE BEEN EXCAVATED TO 250MM BELOW FINISHED LEVELS. RIP THE SUBGRADE A FURTHER 100MM IN DEPTH. INSTALL PREMIUM GARDEN SOIL OR MIX NATURAL TOP SOIL WITH IMPORTED SOIL TO A DEPTH OF 250MM. INSTALL 75MM DEPTH OF LEAF LITTER MULCH FROM ANL LANDSCAPE SUPPLIES OR EQUIVALENT.

LAWN AREA PREPERATION

EXCAVATE LAWN AREAS TO A DEPTH OF 100MM BELOW REQUIRED FINISHED LEVELS. DO NOT EXCAVATE WITHIN WITHIN TREE PROTECTION ZONES WHERE APPLICABLE OR WITHIN 1500MM OF THE TRUNK OF ANY EXISTING TREES TO BE RETAINED. ENSURE THAT ALL SURFACE WATER IS DIRECTED TOWARD ANY DRAINAGE PITS, KERBS AND AWAY FROM ANY BUILDINGS. SUBGRADE IS TO BE RIPPED TO A DEPTH OF 150MM AND A 50MM DEEP LAYER OF TURF UNDERLAY INSTALLED ON TOP. LAWNS SHOULD HAVE AN EVEN GRADE SO THAT NO PONDING OR POOLING OCCURS. 'SIR LAUNCHER' FERTILISER OR EQUIVELANT SHOULD BE SPREAD OVER LAWN AREAS PRIOR TO LAYING TURF. LAY 'SIR WALTER BUFFALO' TURF ROLLS CLOSELY BUTTED ENSURING NO GAPS BETWEEN ARE PRESENT. ROLL AND WATER THOROUGHLY AFTER LAYING.

PLANTING

PLANTS ARE TO BE HEALTHY, FREE OF PEST/DISEASES AND TRUE TO TYPE & SPECIES, REFER TO LANDSCAPE PLAN FOR LOCATION AND SPACING. ALL PLANTS SHOULD BE PLACED IN A HOLE DUG TWICE THE SIZE OF THE POT. GENTLY TEESE THE ROOTS OF ANY POT BOUND PLANTS. THE BASE OF THE TRUNK SHOULD BE INSTALLED LEVEL WITH THE SURFACE OF THE GROUND AND DISH CREATED AROUND THE BASE OF EACH PLANT TO AID WITH WATER RETENTION. WATER THOROUGHLY AFTER PLANTING.

PLANT LIST SYMBOL BOTANIC NAME COMMON NAME MATURE HEIGHT X WIDTH NATIVE? TYPE QTY POT SIZE TREES TUCKEROO YES 45LTR CA CUPANIOPSIS ANACARDIOIDES 8M X 4M SHRUBS Acl ACACIA 'LIMELIGHT' LIMELIGHT 1M X 1M YES 3 200MM Wf WESTRINGIA FRUITICOSA COASTAL ROSEMARY UP TO 1.5M TRIMMED YES 14 200MM **GRASSES & STRAP** LEAF PLANTS Dtr DIANELLA TASMANICA 'TAS RED' TAS RED DIANELLA 0.45M X 0.45M YES 5 140MM

STAKING

ALL TREES AND TOP HEAVY SCREENING SHRUBS SHOULD BE STAKED WITH 2 X 25MM X 25MM LONG TIM PER PLANT. LENGTH OF STAKES IS DEPENDENT ON THE HEIGHT AND STABILITY OF THE TREE/SHRUB. ST SHOULD BE FIRMLY POSITIONED. HESSIAN TAPE IS TO BE PLACED AROUND THE TREE AND STAKES ALLO MOVEMENT IN ORDER TO ALLOW THE TRUNK TO DEVELOP STRENGTH OVERTIME.

GARDEN EDGING

USE EITHER 'HAVEN' BRICK EDGING OR SIMILAR LAID ON A 50MM THICK BED OF MORTAR, OR TREATED EDGING SECURED WITH INGROUND TIMBER STAKES. ALL GARDENS ARE TO HAVE EDGING INSTALLED A INSTALLED AS PER PLAN.

RETAINING WALLS

REFER TO MANUFACTURERS INSTRUCTIONS FOR CONSTRUCTION OF RETAINING WALLS. DETAILS ON TH A GUIDE ONLY.

COMPLETION

SITE IS TO BE CLEARED OF ANY SURPLUS MATERIALS AND DEBRIS PRIOR TO PRACTICAL COMPLETION. BE COMPLETED TO THE SATISFACTION OF COUNCILS GUIDELINES AND ANY DA CONDITIONS

MAINTENANCE PERIOD

A 12 MONTH MAINTENANCE PERIOD FROM THE DATE OF PRACTICAL COMPLETION WILL APPLY. DURING OWNER IS RESPONSIBLE FOR RECTIFYING ANY DEFECTIVE WORK, DURING THE MAINTENACE PERIOD TH FOLLOWING ACTIVITIES ARE

TO BE UNDERTAKEN

a) REPLACEMENTS: ANY PLANTS/TREES THAT HAVE DIED SHALL BE REPLACED WITH THE SAME SPECIES INDICATED ON THIS PLAN. THE SPECIMENS MUST BE IN GOOD HEALTH AND FREE FROM PESTS AND DISE b) WATERING: REGULAR WATERING OF PLANTS IS REQUIRED. PLANTS SHOULD BE WATERED TWICE A W THE FIRST

2 MONTHS OF PLANTING AND AND DURING DRY PERIODS. LESS FREQUENT WATERING IS REQUIRED ON ARE ESTABLISHED AND DURING PERIODS OF RAIN. THE CONTRACTOR/OWNER SHOULD USE THEIR DISC c) GARDEN BEDS: GARDEN AREAS SHOULD BE REGULARLY WEEDED AND MULCH TOPPED UP IF REQUIR SOIL IS TO BE PRESENT AND SPECIFIED DEPTHS MAINTAINED.


d) LAWN AREAS: LAWN AREAS SHALL BE MOWN REGULARLY (AT LEAST ONCE A WEEK IN GROWING SEA ORDER TO PROMOTE A THICK LAWN THAT OUTCOMPETES ANY WEEDS. LAWN CLIPPINGS ARE NOT TO BE OVER GARDEN AREAS. ANY DEAD AREAS OF LAWN OCCURING THE MAINTENANCE PERIOD, ARE TO BE F THE TURF VARIETY SPECIFED IN THE PLAN.

e) PRUNING: ADEQUATE HORTICULTURAL PRUNING METHODS SHOULD BE USED ON PLANTS AS BECOME NECESSARY. ANY HEDGES ARE TO BE TRIMMED REGULARLY, DEAD AND DANGEROUS TREE BRANCHES LIGHT PRUNING OF SHRUBS TO PROMOTE THICK FOLIAGE COVER.

f) FERTILISING: 'ORGANIC LIFE' FERTILISER OR EQUIVELANT SHALL BE APPLIED AS PER MANUFACTURER INSTRUCTIONS TO ALL GARDEN BEDS ONCE PER MONTH. DYNAMIC LIFTER OR SIMILAR SHOULD BE APPI LAWN AREAS TWICE A YEAR, ONCE IN MID SPRING AND ONCE IN EARLY SUMMER. WATER THOROUGHLY APPLICATION OF FERTILISER.

	Revision Schedule						
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	Click Here to View Our Plant Profiles!						
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- 1. SPECIMENS ARE TO BE IN GOOD HEALTH AND FREE FROM PESTS AND DISEASES
- 2. WATER THROUROUGHLY AFTER PLANTING
- LETTERBOX DETAIL SCALE 1:40

2. ENSURE THAT NO CEMENT OR RENDER IS LEFT ON THE BRICKWORK OR LETTERBOX OPENING

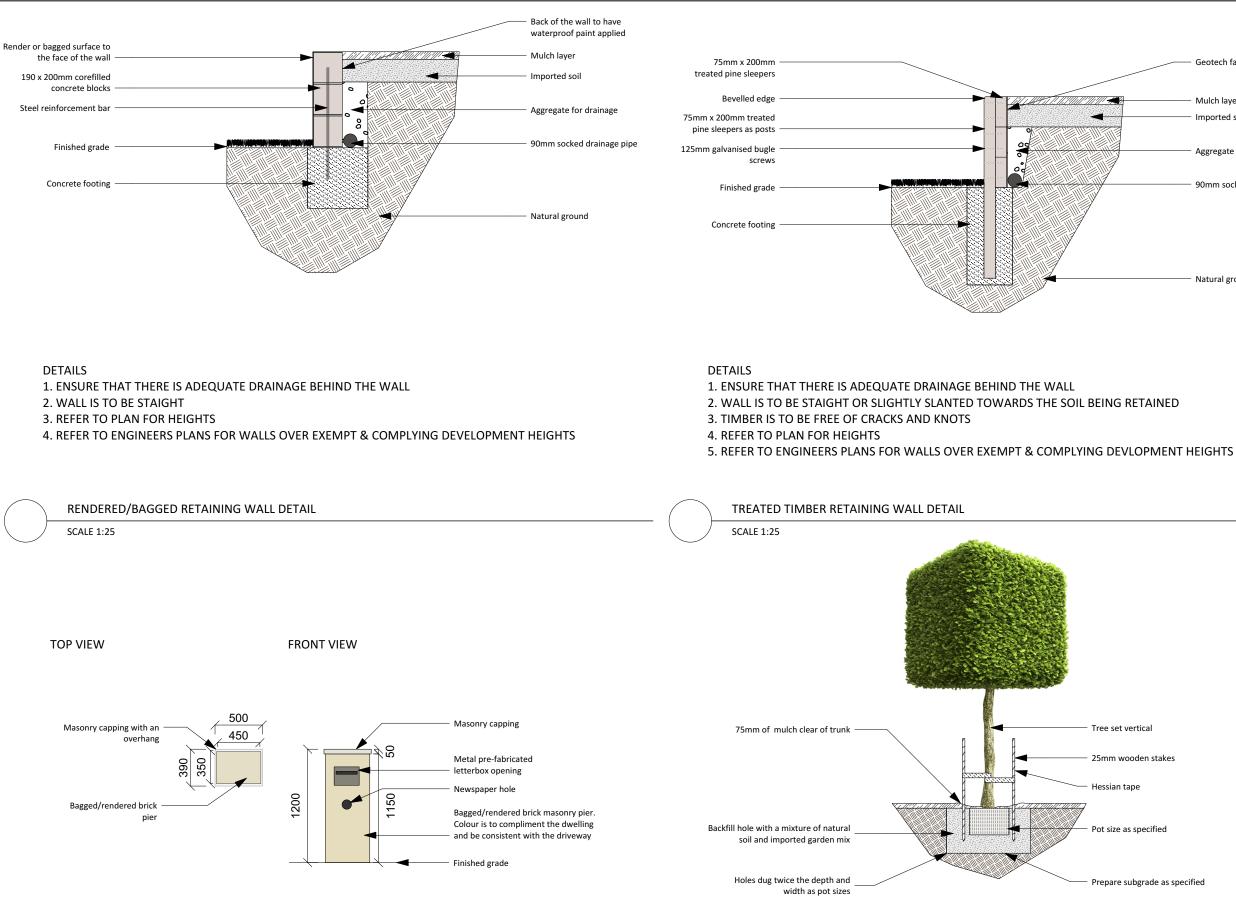TREE PLANTING DETAIL

SCALE 1:40


DETAILS

1. COLOUR CHOSEN IS TO COMPLIMENT THE DWELLING

3. BRICK PIER IS TO LEVEL AND STRAIGHT

DETAILS

Revision Schedule By: Date: Issue: Description: Geotech fabrio **Submission Plan** JS 09/12/19 Α Mulch layer Imported soil Aggregate for drainage Drafted: Scale: 1:200 90mm socked drainage pipe JS Sheet: Reference: 3 of 4 LP 01 Natural ground Designed by: Julian Saw **Diploma of Horticulture** (Landscape Design) General Notes: 1. See Architects drawings for site levels, setbacks and extent of cut and fill. 2. This plan shall be read in conjunction with the Hydraulic Engineers drawings 3. All relevant australian standards are to be adhered to. 4. Any structural items are to be installed as per the manufacturer/engineers specifications. 5. This plan is indicative only and not for construction purpose SITE CALCULATIONS LOT AREA 344.1 sq m LANDSCAPED AREA TOTAL 94.1 sq m 27.345% **Click Here to View Our Plant Profiles!** Mr Carragher Client: Mrs Carragher **Client Signatures:** 1. 2. Job No. 190433 Drawing: Construction Details Address: Lot 3, No.73 Lorikeet Grove Warriewood Council: **Northern Beaches** DappleDesigns Ph: 0437 043 112 www.dappledesigns.com.au

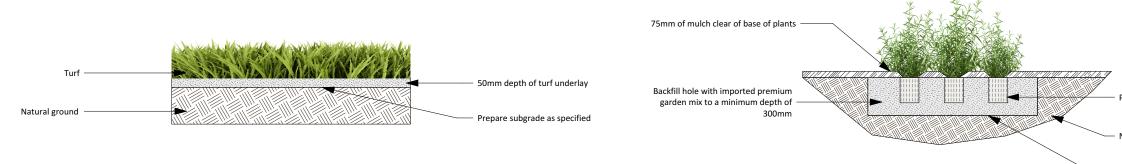

DETAILS

1. TURF ROLLS ARE TO BE IN GOOD HEALTH, FREE FROM PESTS AND DISEASES AND WITHOUT HOLES

2. APPLY WATER SAVING CRYSTALS TO THE GROUND PRIOR TO LAYING

3. BUT ROLLS CLOSELY TOGETHER TO AVOID GAPS AND DIEBACK

4. WATER THROUROUGHLY AFTER PLANTING AND REGULARLY UNTIL ESTABLISHED

TURF LAYING DETAIL

SCALE 1:20

DETAILS

SPECIMENS ARE TO BE IN GOOD HEALTH AND FREE FROM PESTS AND DISEASES
 GENTLY LOOSEN ROOTS IF REQUIRED, PRIOR TO PLANTING
 WATER THROUROUGHLY AFTER PLANTING

4. REFER TO PLAN FOR QUANTITIES AND SPACING

SHRUB & GROUNDCOVER PLANTING DETAIL

SCALE 1:30

	Revision Schedule						
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	Sheet: 4 of 4 Designed by: Julian Saw Diploma of Horticulture (Landscape Design)						
Pot size as specified	General Notes: 1. See Architects drawings for site levels, setbacks and extent of cut and fill. 2. This plan shall be read in conjunction with the Hydraulic Engineers drawings. 3. All relevant australian standards are to be adhered to. 4. Any structural items are to be installed as per the manufacturer/engineers specifications.						
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