

Site Calculations				
	Existing	Proposed		
Site Area	418.30sqm			
Ex Ground Floor Area	82.75sqm	82.75sqm		
Ex First Floor Area	64.09sqm	99.79sqm		
total gross floor area:	146.84sqm	182.54sqm		
Landscape Area Required: 40% 167.32sqm	54.52sqm	68.50sqm		

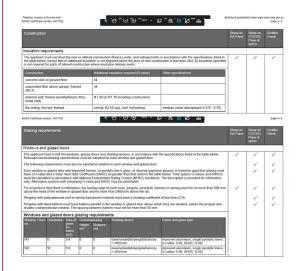

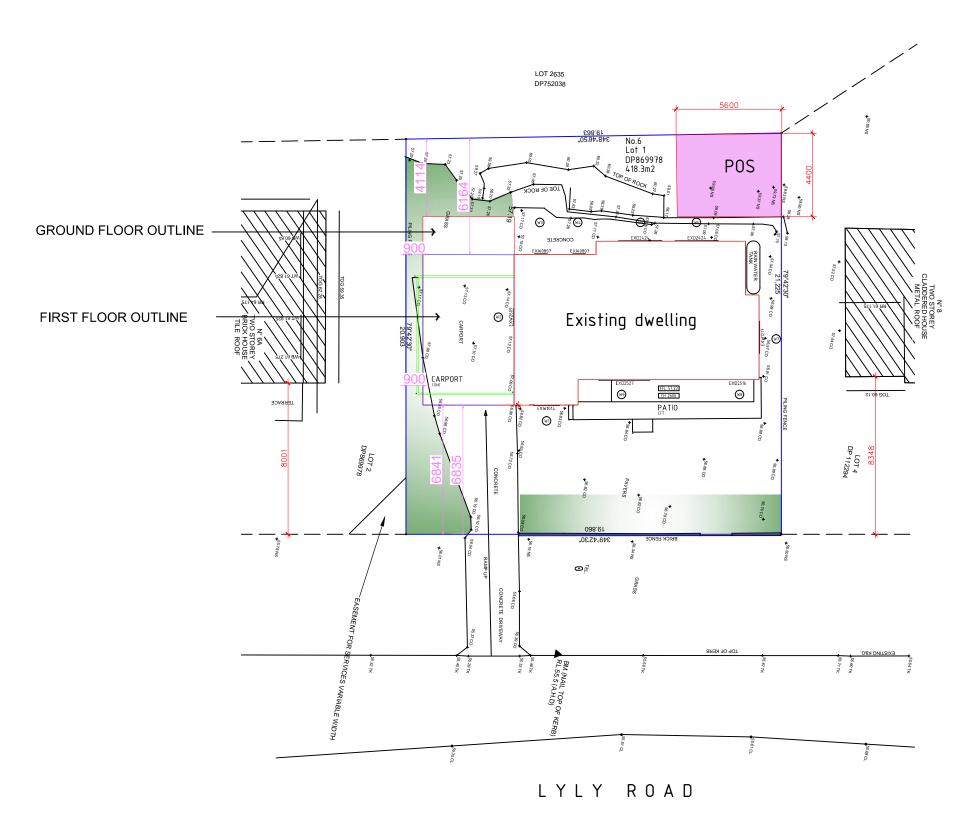






# EXISTING WINDOW/DOOR SCHEDULE

WIN. NO.	HEIGHT(mm)	WIDTH (mm)	ACTION
W1	1000	1400	SLIDING
W2	2600	900	FIXED
W3	800	700	SLIDING
W4	800	700	SLIDING
W5	2400	2400	SLIDING DOOR
W6	2400	2400	SLIDING DOOR
W7	1200	1700	SLIDING
W8	2500	1600	HINGED GLAZED
W9	2500	2700	DOOR UNIT WITH WINDOW
W10	2100	1800	SLIDING
W11	800	700	SLIDING
W12	800	700	SLIDING
W13	1400	1600	SLIDING
W14	2100	3900	SLIDING DOOR
W15	2100	2700	SLIDING DOOR
W16	2100	1400	HINGED GLAZED
W17	1500	2400	SLIDING
W18	1500	2400	SLIDING

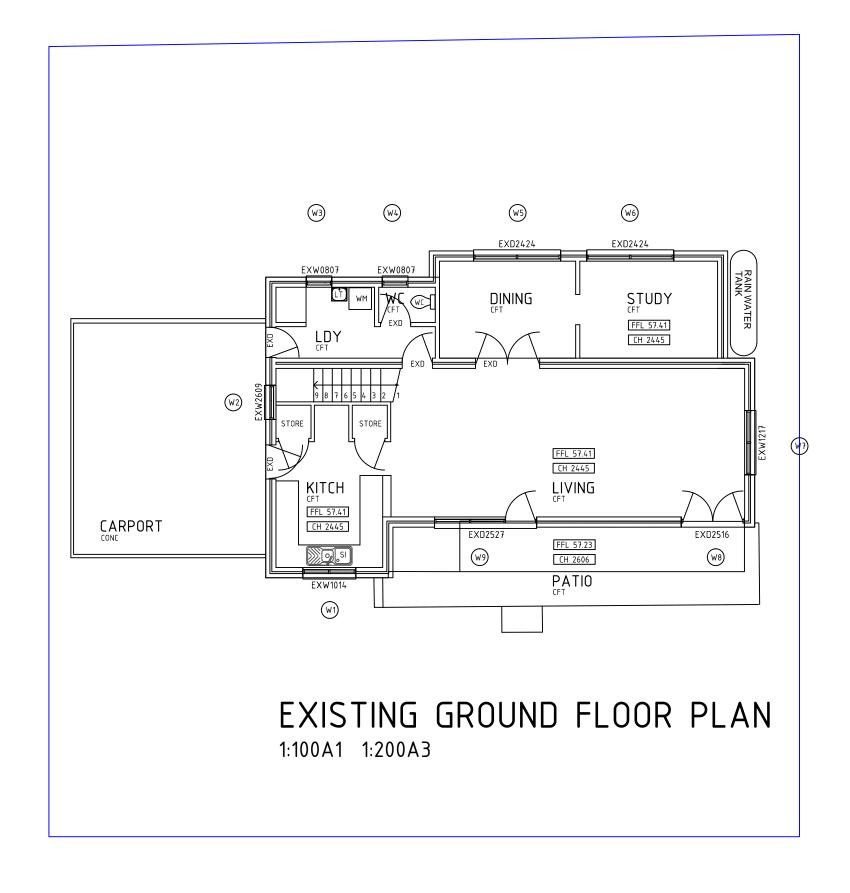

# Designs by Anastasia & Nikolina m 0406 775 265 e anastasia@dban.com.au w www.dban.com.au w www.dban.com.au Date 3/03/2021 The preliminary Date 3/03/2021 Amendment preliminary Project:Big 8 group Address: 6 Lyly Road, Allambie Heights Scale: 1:100 Sheet Title: EXISTING GROUND FLOOR PLAN File Name: 6 LYLY RD, ALLAMBIE HEIGHTS\_RECOVER.DWG Date: May 2021

# LEGEND:

VOS VERIFY ON SITE ΕX **EXISTING** EXISTING WALLS

EXISTING WINDOW EXW EXISTING DOOR EXD

ALUMINIUM SLIDING WINDOW ASW ALUMINIUM DOUBLE HUNG WINDOW ADH

ASD ALUMINIUM SLIDING DOOR

DP DOWNPIPE

0G OBSCURE GLAZING SMOKE ALARM FLOOR WASTE FP FIREPLACE FG FIXED GLASS SI SINK

REFRIGERATOR  $\mathsf{CT}$ COOKTOP CUPBOARD CPD

EMR EXISTING METAL ROOF NMR NEW METAL ROOF SL SIDE LIGHT SK SKYLIGHT


ASW WINDOW HEIGHT X WIDTH ASD DOOR HEIGHT X WIDTH W12 WINDOW NUMBER

FFL 22.95 FINISHED FLOOR LEVEL

CH 2850 FINISHED CEILING HEIGHT (MM)

E18.6 EXISTING GROUND RELATIVE LEVEL 9.819 PROPOSED GROUND RELATIVE LEVEL

**⊕**( COLUMN ROOF FALL

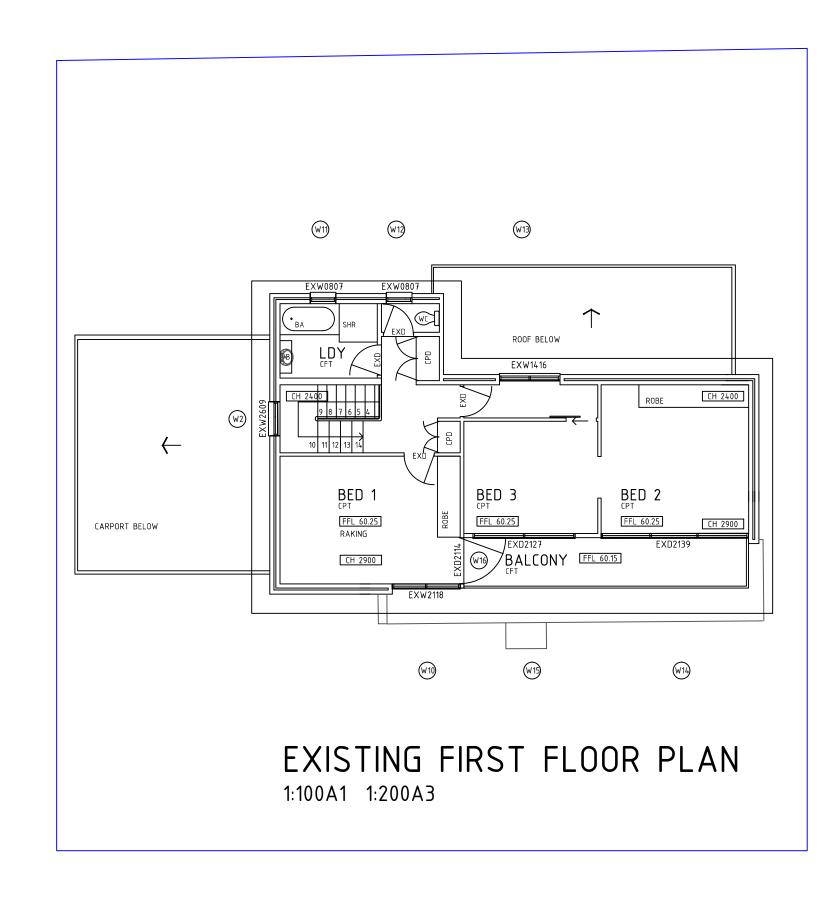


## Designs by Anastasia & Nikolina

e anastasia@dban.com.au

m 0406 775 265 w www.dban.com.au 3/03/2021

Amendment preliminary

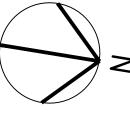


Project:Big 8 group

Address: 6 Lyly Road, Allambie Heights

Scale: 1:100

Sheet Title: EXISTING FIRST FLOOR PLAN

File Name: 6 LYLY RD, ALLAMBIE HEIGHTS\_RECOVER.DWG

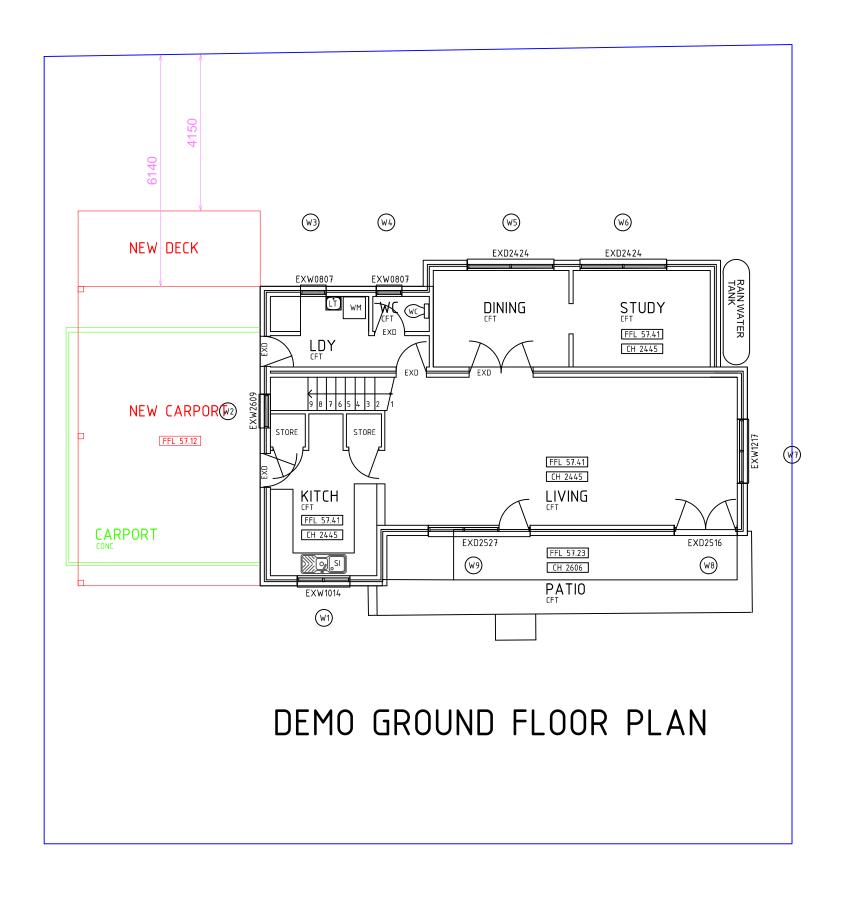

# Designs by Anastasia & Nikolina


m 0406 775 265

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Date Is: 3/03/2021

Amendment preliminary




Project:Big 8 group

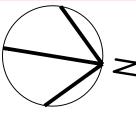Address: 6 Lyly Road, Allambie Heights

Scale: 1:100

Sheet Title: DEMO GROUND FLOOR PLAN

File Name: 6 LYLY RD, ALLAMBIE HEIGHTS\_RECOVER.DWG

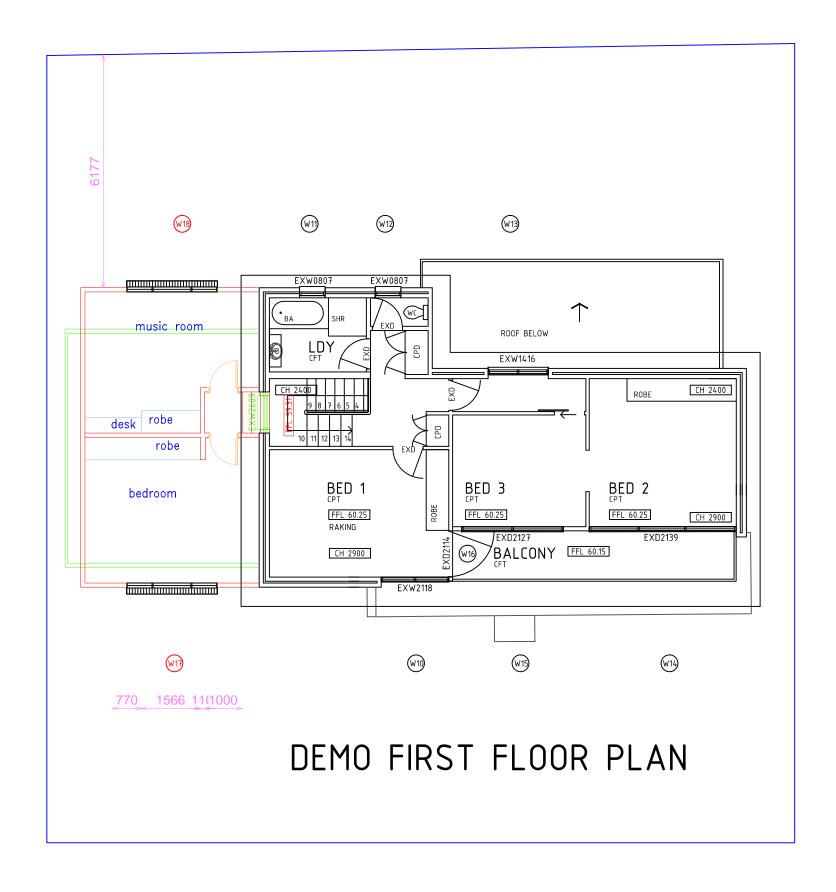

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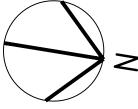
m 0406 775 265

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Date Is 3/03/2021

Amendment preliminary




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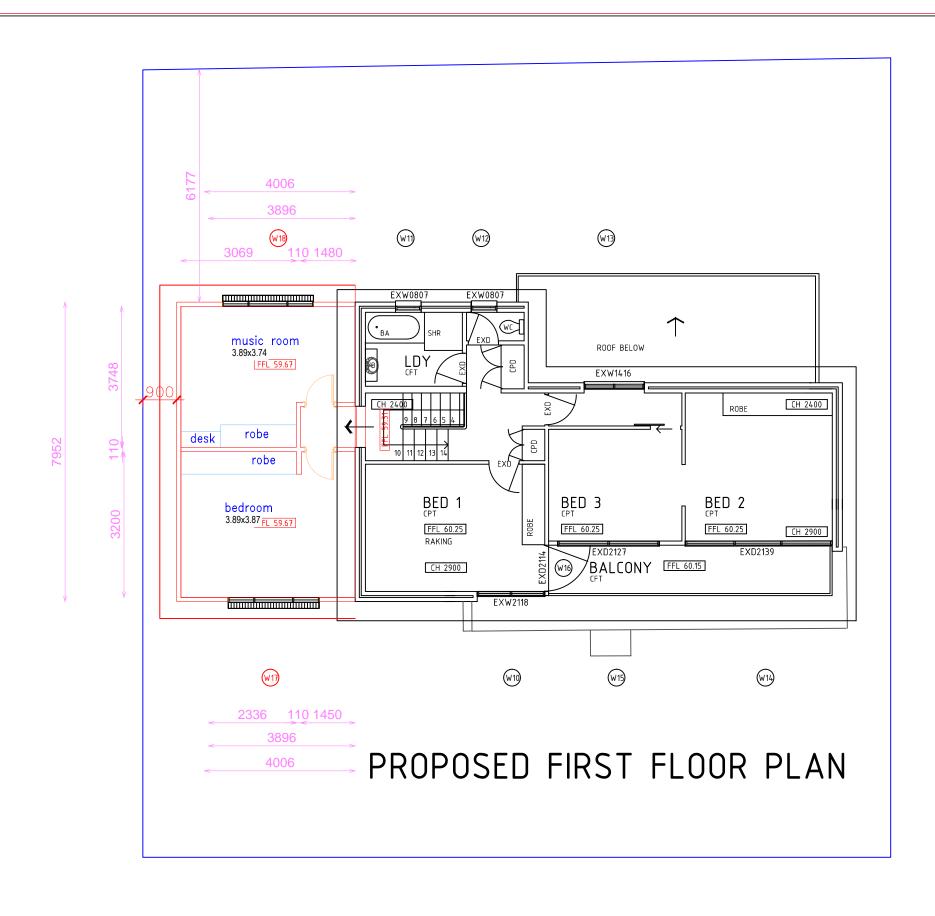
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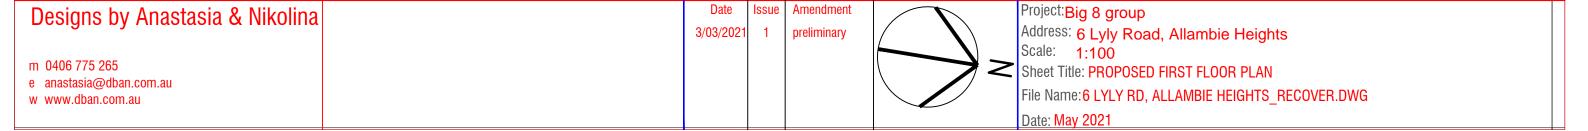
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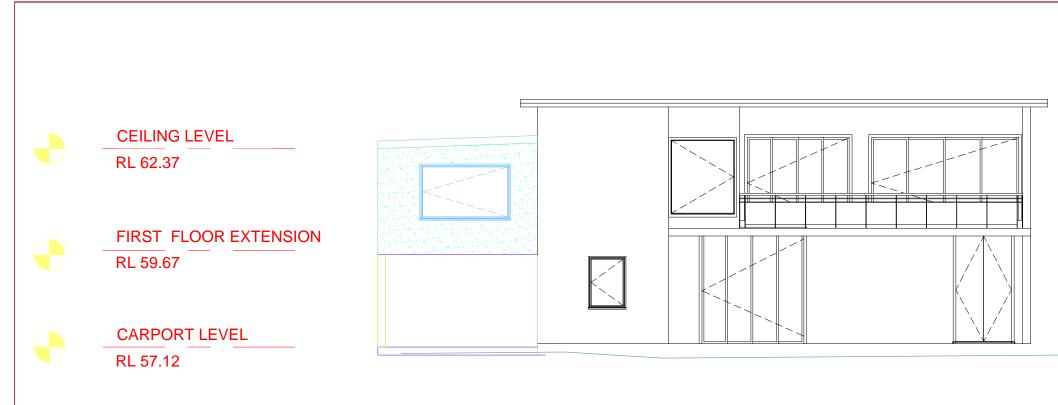





Designs by Anastasia & Nikolina






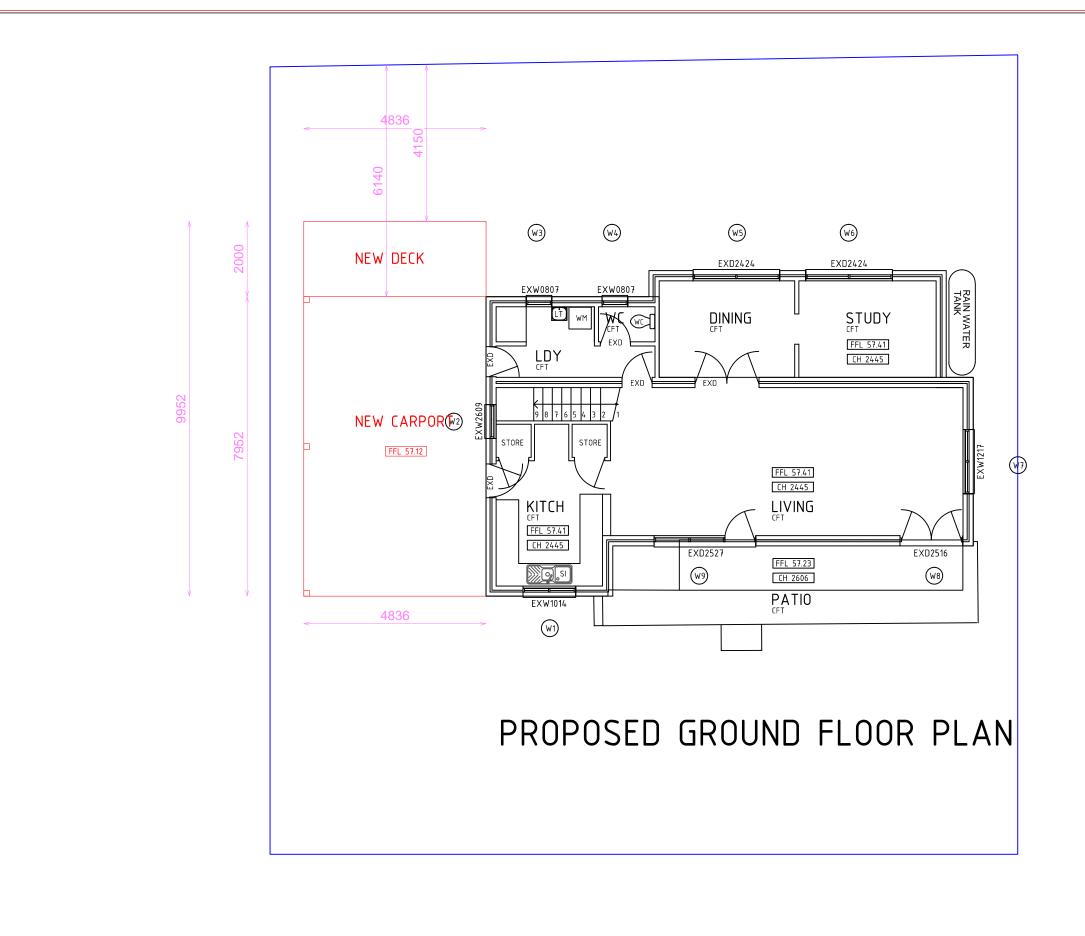


# EAST ELEVATION

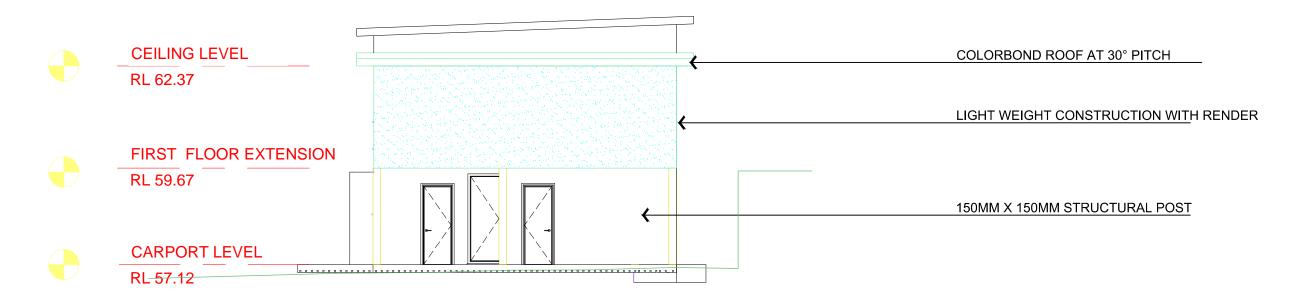


# SOUTH ELEVATION

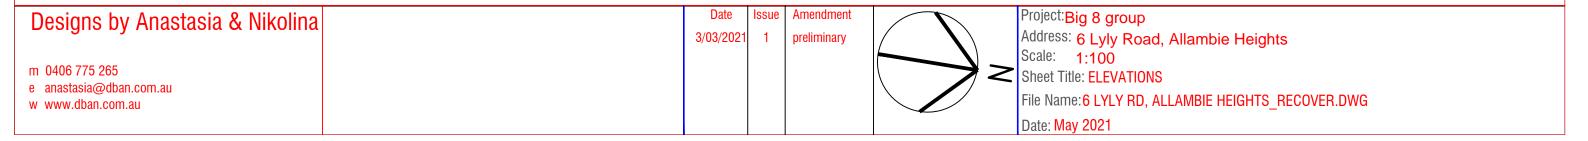

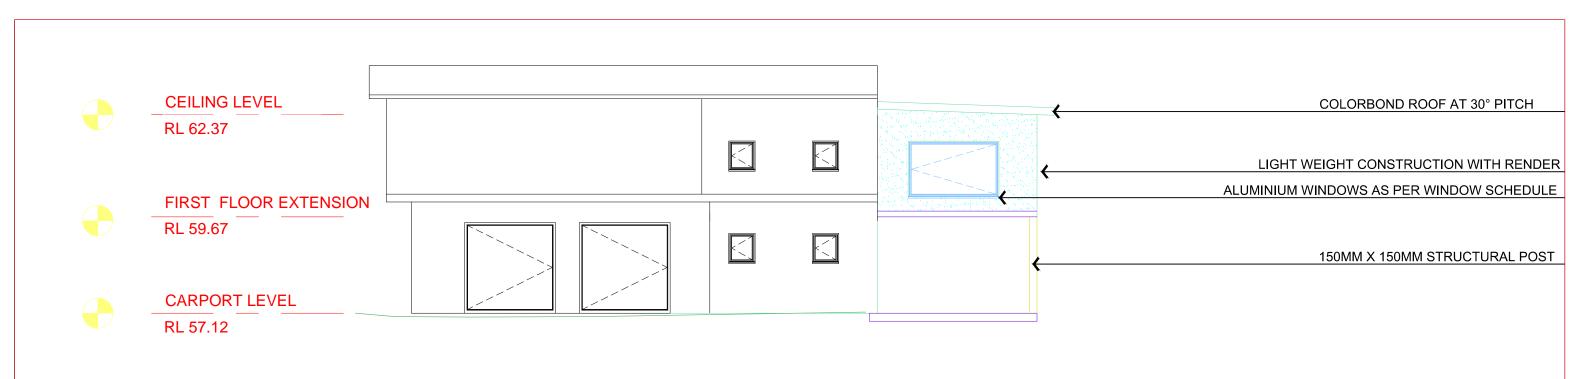

## WEST ELEVATION

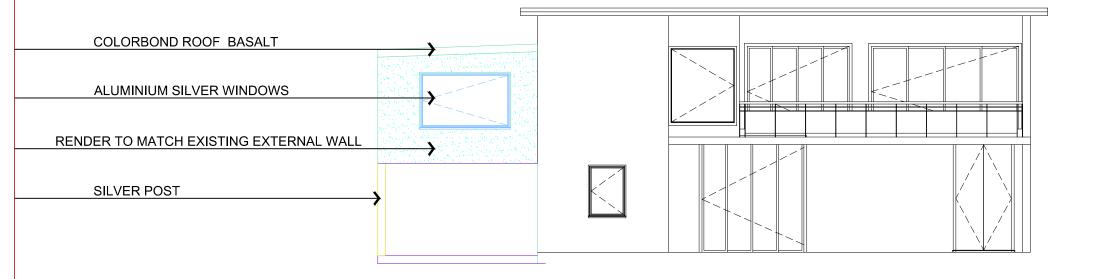


# SCHEDULE OF COLOURS & FINISHES





FIRST FLOOR EXTENSION
RL 59.67

CARPORT LEVEL
RL 57.12

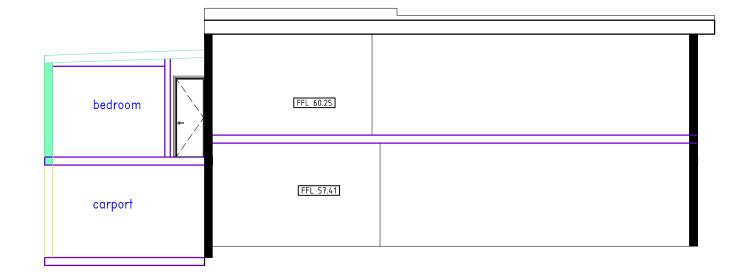


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Date Issue Amendment
3/03/2021 1 preliminary




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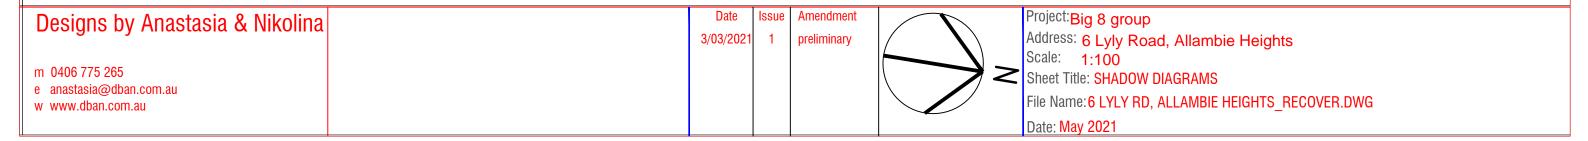
Address: 6 Lyly Road, Allambie Heights


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Sheet Title: SECTION

File Name: 6 LYLY RD, ALLAMBIE HEIGHTS\_RECOVER.DWG

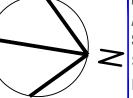



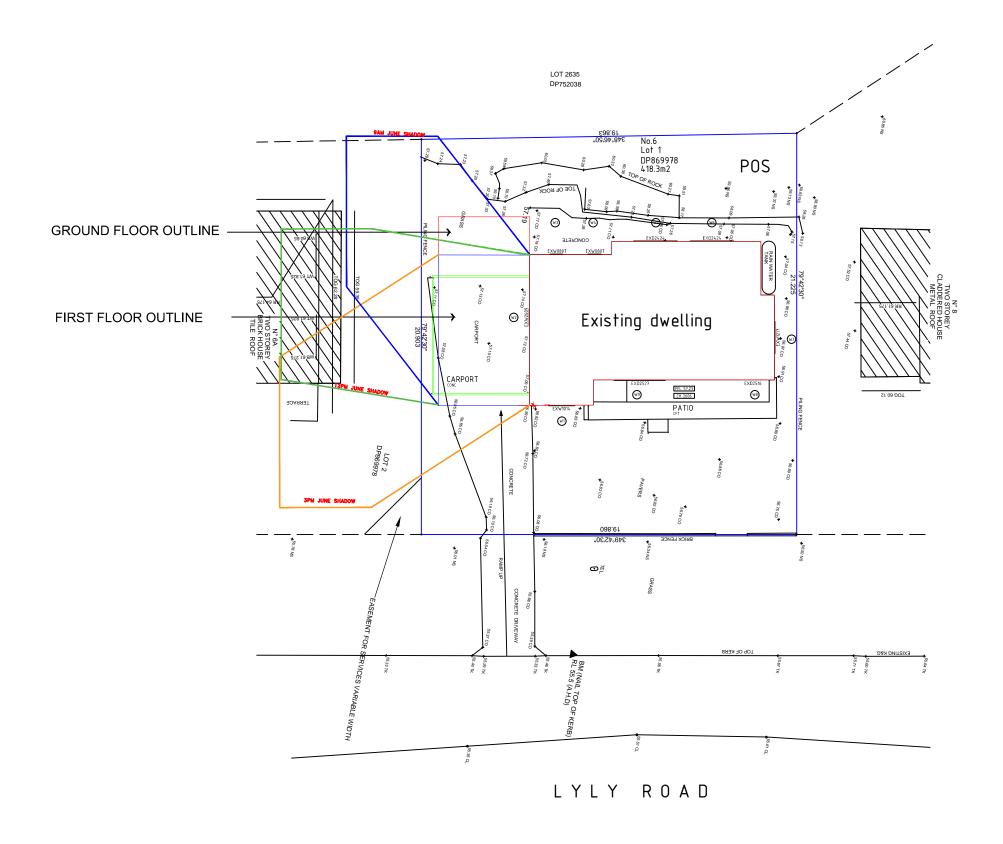
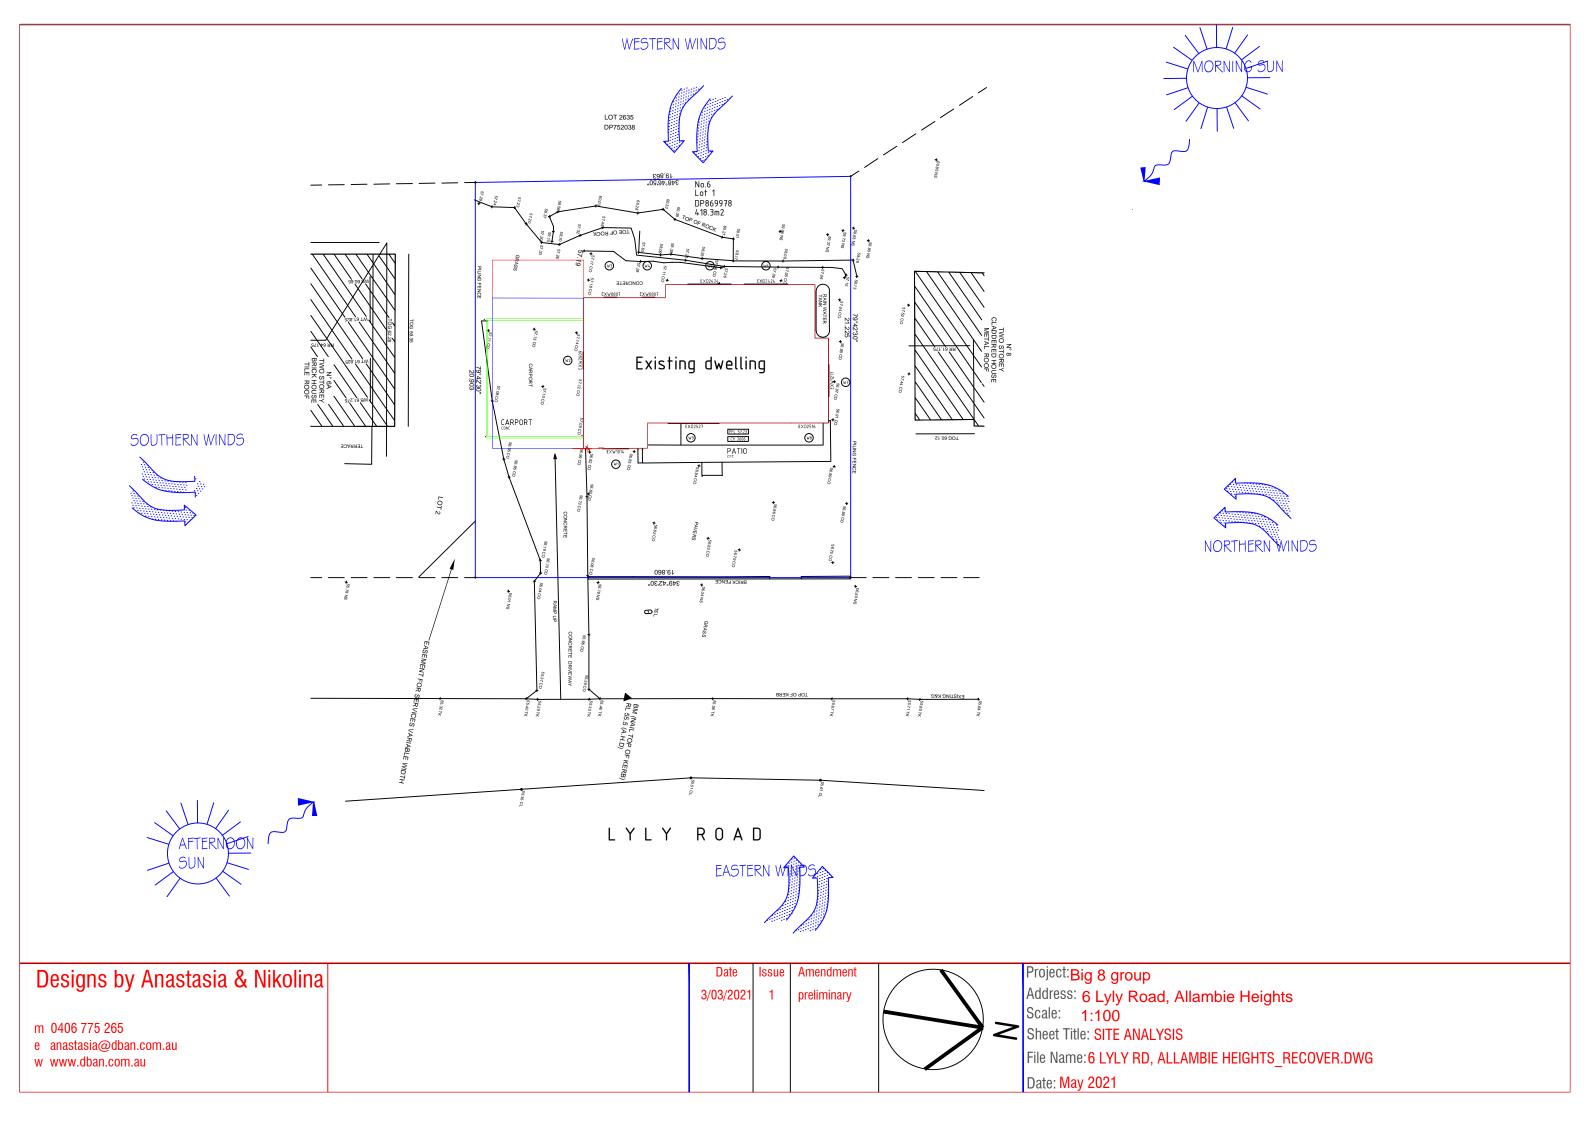
## **Construction Management Plan**

The following Construction Management Plan will highlights the following:

- Location of material storage.

- Location of any plant & equipment (cranes, hoists etc)

  Maximum intended weight and size of construction and delivery vehicles

  How vehicles will access and egress the site.
- How material storage (loading / unloading) will be carried out on site without blocking access to adjoining
- rlow internal studies (usualing vinulous) and emergency vehicles.

  Intended timing of deliveries to site.

  Contact details for of person with authority to respond to any construction related access issues.
- Intended communication of construction details to adjoining residents
- Details of any signage to be erected on the site

## Location of material storage

Materials will be store on site in locations marked "A", "B" and "C" as shown on associated plans.

Location "A" - Driveway - heavy / bulky materials such as bricks / steel / roof tiles etc will be stored on the driveway under the carport and on adjacent paving area in order to allow lifting off delivery truck and placement for storage without "double handling" of materials. Fragile materials such as tiles, plumbing fittings and fixtures etc will also be stored here so as to minimize possibility of damage and to novide security asainst theff

of damage and to provide security against theft.

Location "B" - Lawn - timber / prefabricated frames and trusses etc will be stored on the front lawn. These materials are generally of longer lengths and light enough to allow manual handling from delivery truck to storage area.

NOTE - Material deliveries are to be timed so that only materials required for the scope of works to be carried out at that stage are on site n order to ensure the site is not cluttered and to allow easy access for trades / residents to and from the site

## Location of any plant & equipment

Plant and equipment (cranes, hoists, rubbish bins etc) will be located in Location "A" (same as for material storage) to avoid damage to existing established landscaping.

NOTE - Use of plant & equipment is to be timed so that material storage does not interfere with locating plant or equipment in the

## Construction and delivery vehicles

Construction vehicles will generally take the shape of trade utes / vans. Delivery vehicles are to be of fixed tray type with maximum weight of 3 tones. Concrete delivery is to be in the form of mini-mix vehicle. Rubbish bins are to be limited to 4 cubic meter bins during demolition stage and reduced to 3 cubic meter bins for general site cleaning as necessary.

Vehicle access and egress

Construction vehicles (utes / vans) can access and egress the site without any special requirements. Delivery trucks are not to enter the site and must stay on the public road to avoid damage to road crossing, footpath and or driveway.

## Material delivery and handling

Materials delivered to site are to be unloaded from delivery truck on site wherever possible and stored in appropriate locations as specified immediately. Where unloading is not possible on site materials are to be unloaded at street level and manually carried onto site and stored in appropriate locations as specified immediately.

NOTE - At no time are materials to be stored on the road, access handle, nature strip or adjoining properties.

HOURS OF WORK
ALL CONSTRUCTION/DEMOLITION WORK RELATING TO THE DEVELOPMENT CONSENT WITHIN THE RESIDENTIAL AMENTLY WORK CARRIED OUT ONLY
BETWEEN THE RESIDENCED HOURS OF 7.00AM TO 5.30PM MONDAYS TO FRIDAYS AND 8.00AM TO 12.00 NOOM ON SATURDAY. NO MORK IS TO BE DONE.

MATERIAL DELIVERIES WILL GENERALLY TAKE PLACE BETWEEN 8.00AM AND 3.00PM THE DAY BEFORE THE MATERIALS WILL BE REQUIRED ON SITE.

CONTACT DETAILS

A CONSTRUCTION SUPERVISOR WILL BE APPOINTED UPON RECEIPT OF THE REQUIRED CONSTRUCTION CERTIFICATE. THE SUPERVISORS DETAILS INCLIDING MEMBER AND MOBILE CONTACT NUMBER WILL BE PROVIDED TO THE ADJOINING RESIDENTS. EMERGENCY CONTACT DETAILS (NAME & CONTACT NUMBER) WILL ALSO BE PROVIDED IN THE EVENT THAT THE SUPERVISOR IS NOT CONTACTABLE. THE OFFICE NUMBER FOR CONTACT DURING NORMAL BUSINESS HOURS WILL BE DISPLAYED ON SIGNAGE TO BE ERECTED ON THE SUBJECT SITE (TO IDENTIFY THE SITE TO TRADES AND MATERIAL DELIVERIES).

NOTE - THESE DETAILS CANNOT BE PROVIDED AT THIS TIME AS WORK IS ALLOCATED TO ONE OF FIVE SUPERVISORS PENDING CURRENT WORKLOAD AT

COMMUNICATION WITH ADJOINING RESIDENTS

UPON RECEIPT OF THE CONSTRUCTION CERTIFICATE THE ADJOINING RESIDENTS WILL BE NOTIFIED THAT WORKS ARE BEING ARRANGED TO BEGIN. THIS WILL PROVIDE APPROXIMATELY 3 WEEKS NOTICE IN THIS REGARD. THIS NOTIFICATION WILL INCLUDE ALL CONTACT DETAILS FER ABOVE. FURTHER TO THIS THE CONSTRUCTION SUPERVISOR WILL INTRODUCE HIMSELF TO THESE RESIDENTS A MINIMUM OF 48 HOURS PRIOR TO COMPRICEMENT.

SIGNACE IN THE FORM OF A SITE SIGN TO IDENTIFY THE BUILDER'S NAME AND CONTACT DETAILS AND THE PRINCIPAL CERTIFYING AUTHORITY WILL BE REQUIRED ON SITE. THE LOCATION OF THIS SIGNAGE IS SHOWN ON THE ASSOCIATED PLANS.

SOIL & WATER MANAGEMENT PLAN
ALL SEDMENT CONTROLS ARE TO BE INSTALLED BEFORE WORK COMMENCES
ANY AREAS OF EXPOSED SOIL ARE TO BE MINIMISED
ALL TOP-SOIL IS TO BE RETAINED ON SITE FOR RE-USE

ALL TOW-SUIL IS TO BE HETAINED UNITY FOR HEADS

MATRIALA, BOLL STOCKPILES ARE TO BE AS INDICATED BY SEDMENT FENCING

STOCKPILES B. WORK AREAS ARE TO BE AS INDICATED BY THE CONSTRUCTION MANAGEMENT PLAN TO PRESERVE EXISTING VEGETATION

SURFACE WATER FLOW DURING LOSSTRUCTION ARE TO BE CONSTRUCTED AS FOLLOWS;

- CLEAN RUN OFF, IS TO BE DIVERTED AROUND DISTURBED AREAS;

- SLOPE GRADIENT B FLOW DISTURCE ARE TO BE MINIMED; WITHIN DISTURBED AREAS

- DISTURBED AREAS ARE TO BE PROMPILLY REMAINITATED

SEDMENT FENCE ARE TO BE REGULARLY MONITORED B. MAINTAINED DURING CONSTRUCTION

## Construction Noise & Vibration Management Plan

The following actions will be implemented to keep the noise  $\mbox{\it \$}$  vibration to a minimum:

## Location of any plant & equipment

Plant and equipment (cranes, hoists, etc) will be located in the front yard facing the street

The most commonly used equipment will be nail guns, electric saw's \$ hammers, which will be done during the day time.

NOTE - Use of plant # equipment will be timed so that material storage does not interfere with locating plant or equipment in the

oliltion work relating to the Development Consent within the residential amentiv work carried out only between the restricted hours of 7.00am to 5.30pm Mondays to Fridays and 8.00am to 12.00 noon on Saturday. No work is to be done or



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