STANDARD CONSTRUCTION NOTES

WALL FRAMING

 WRITTEN DIMENSIONS TAKE PRECEDENCE OVER SCALE. ALL STRUCTURAL TIMBER FRAMING SIZES TO BE IN ACCORDANCE WITH

AS 1684:2010 NATIONAL TIMBER FRAMING CODE AND ENGINEER'S STRUCTURAL COMPUTATIONS.

- WALL BRACING, FIXING, TIE DOWNS, DURABILITY NOTES & ANY ADDITIONAL ENGINEERING REQUIREMENTS TO BE AS PER ENGINEER'S DETAILS. FLOOR PLAN DIMENSIONS ARE TO FRAME SIZE ONLY.
- ALL WATER CLOSET DOORS TO BE REMOVABLE IN
- ACCORDANCE WITH N.C.C. 3.8.3.3 CENTRE ALL WINDOWS & DOORS INTERNALLY TO
- ROOM UNLESS DIMENSIONED OTHERWISE
- PROVIDE 2No. 90mm x 45mm JAMB STUDS TO ALL INTERNAL DOOR OPENINGS AND ALL SLIDING ROBE DOOR OPENINGS AS PER DETAIL S-TYP-DOOR-01

ROOF FRAMING

- GARAGE ROOF TO BE TIED DOWN MIN. 1200mm INTO BRICKWORK WITH HOOP IRON STRAPS.
- PREFABRICATED ROOF TRUSSES TO MANUFACTURER'S SPECIFICATIONS. PITCH AS SHOWN ON ELEVATIONS.

EXTERNAL WALLS

 ALL PARAPET WALLS TO BE PROVIDED WITH COLORBOND METAL CAPPING/FLASHING (50mm MIN. OVERLAP TO ALL JOINTS WITH CONTINUOUS SILICONE SEALANT BETWEEN & 30mm MIN. VERTICAL OVERHANG).

SLAB AND FOOTINGS

- REINFORCED CONCRETE SLAB AND ASSOCIATED FOOTINGS IN ACCORDANCE WITH ENGINEER'S DETAILS.
- SUB-FLOOR VENTILATION IN ACCORDANCE WITH N.C.C. 3.4.1. TO BE PROVIDED TO SUSPENDED TIMBER FLOOR WHERE APPLICABLE.

PLUMBING AND DRAINAGE

 ALL PLUMBING, DRAINAGE & ASSOCIATED WORKS TO COMPLY WITH THE PLUMBING CODE OF AUSTRALIA, N.C.C. & AS 3500 - PLUMBING AND DRAINAGE.

TERMITE PROTECTION

PROVIDE TERMITE MANAGEMENT SYSTEM AS PER: AS 3660.1:2014 - TERMITE MANAGEMENT

- WINDOWS TO SIDE AND REAR ELEVATIONS ARE ALUMINIUM SLIDING (UNLESS NOTED OTHERWISE).
- WINDOW SIZES ARE NOMINATED AS GENERIC CODES: FIRST TWO NUMBERS REFER TO HEIGHT & SECOND TWO REFER TO WIDTH.
- WINDOW SUPPLIER TO PROVIDE COVER BOARDS TO ALL CORNER WINDOWS UNLESS NOTED OTHERWISE.
- ALL GLAZING TO COMPLY WITH; AS 1288:2006 GLASS IN BUILDINGS
- AS 4055:2012 WIND LOADS FOR HOUSING WINDOW HEAD HEIGHT DIMENSIONS TO BE TAKEN TO THE NEAREST CORRESPONDING BRICK COURSE.
- PROTECTION OF OPENABLE WINDOWS TO BE PROVIDED IN ACCORDANCE WITH N.C.C. 3.9.2.5

STEPS, STAIRS & BALUSTRADES

- ALL STEPS & STAIRS TO HAVE; 240mm MIN. & 355nm MAX. TREAD DEPTH AND 115mm MIN. & 190mm MAX. RISER HEIGHT IN ACCORDANCE WITH N.C.C. 3.9.1.
- BALUSTRADE IN ACCORDANCE WITH N.C.C. 3.9.2. TO BE INSTALLED WHERE INTERNAL & EXTERNAL LANDINGS EXCEED 1000mm ABOVE GROUND LEVEL.
- PROVIDE SLIP RESISTANCE IN ACCORDANCE WITH N.C.C. 3.9.1.4 AND AS 4586:2013 SLIP RESISTANCE.

WATERPROOFING

- PROVIDE CAVITY FLASHING & WEEP HOLES ABOVE LOWER STOREY OPENINGS
- WATERPROOFING OF WET AREAS TO COMPLY WITH: AS 3740:2010 WATERPROOFING OF DOMESTIC WET AREAS &/OR N.C.C. 3.8.1

INTERNAL ELEVATIONS

- TILE & CUPBOARD DIMENSIONS ARE APPROXIMATE ONLY & MAY BE ALTERED TO SUIT MODULAR SIZES.
- DIMENSIONS INDICATED TAKEN FROM PLASTER.
- ALL DIMENSIONS ARE SUBJECT TO SITE MEASURE.
- SHOWER SCREEN HEIGHTS ARE INDICATIVE ONLY AND WILL ALTER DEPENDING ON SHOWER BASE CONSTRUCTION METHODS

BASIX COMMITMENTS

Certificate No.: 1225207S Date of Issue: 21.07.2021

WATER COMMITMENTS

FIXTURES

- 3 STAR RATED SHOWERHEADS >7.5 BUT <9L/MIN.
- 3 STAR RATED TOILET FLUSHING SYSTEMS . 3 STAR RATED KITCHEN TAPS
- 3 STAR RATED BASIN TAPS

ALTERNATIVE WATER

- PROVIDE A RAINWATER TANK OF AT LEAST 3000L TANK MUST BE CONFIGURED TO COLLECT RAIN
- RUNOFF FROM THE 161.71 SQM OF THE ROOF AREA.
- TANK MUST BE CONNECTED TO;
- •• WASHING MACHINE COLD WATER TAP
- •• AT LEAST ONE OUTDOOR TAP

ENERGY COMMITMENTS

HOT WATER

6 STAR RATED ELECTRIC HEAT PUMP WITH A PERFORMANCE OF 26 TO 30STCs OR BETTER.

COOLING SYSTEM

- 1-PHASE AIR COND. TO AT LEAST 1 LIVING AREA WITH A MIN. ENERGY RATING OF **EER 2.5-3.0**
- 1-PHASE AIR COND. TO AT LEAST 1 BEDROOM AREA WITH A MIN. ENERGY RATING OF EER 2.5-3.0
- SYSTEM MUST PROVIDE FOR DAY/NIGHT ZONING BETWEEN LIVING AREAS AND BEDROOMS

HEATING SYSTEM

- 1-PHASE AIR COND. TO AT LEAST 1 LIVING AREA WITH A MIN. ENERGY RATING OF EER 2.5-3.0
- 1-PHASE AIR COND. TO AT LEAST 1 BEDROOM AREA WITH A MIN. ENERGY RATING OF EER 2.5-3.0
- SYSTEM MUST PROVIDE FOR DAY/NIGHT ZONING BETWEEN LIVING AREAS AND BEDROOMS

- PROVIDE EXTERNALLY DUCTED EXHAUST FANS TO: •• AT LEAST 1 BATHROOM
- THE KITCHEN
- THE LAUNDRY

NATURAL LIGHTING

- PROVIDE A WINDOW/SKYLIGHT IN THE KITCHEN OF THE DWELLING FOR NATURAL LIGHTING
- PROVIDE A WINDOW/SKYLIGHT IN AT LEAST 3 BATHROOMS/TOILET FOR NATURAL LIGHTING

ALTERNATIVE ENERGY

INSTALL A PHOTOVOLTAIC SYSTEM WITH THE CAPACITY TO GENERATE ATLEAST 1 PEAK KILOWATTS OF

OTHER COMMITMENTS

- INSTALL A GAS COOKTOP & ELECTRIC OVEN
- PROVIDE A WELL VENTILATED FRIDGE SPACE PROVIDE A FIXED OUTDOOR CLOTHESLINE



PROVIDE AIR-CONDITIONING DUCTS AND OUTLETS FOR AIR-CONDITIONING BY METRICON

CLASS SLAB

PROVIDE ELECTRIC SOLAR POWER SYSTEM



OR RENDERED LIGHTWEIGHT SUBSTRATE CLADDING ABOVE LOWER ROOFS WHERE APPLICABLE

TAE	BLE OF			
REV.	EV. DATE REVISION DESCRIPTION		DRAWN	CHECKED
Α	17.02.2021	PRELIMINARY CONTRACT PLANS	CM8	
В	07.05.21	PRELIMINARY CONTRACT VARIATION	JF9	XX
С	19.07.21	VARIATION OO1	O5A	
D	06.08.21	VARIATION 002	A90	XX
E	11.08.21	LODGEMENT PLANS	503	
F	DD.MM.YY	DESCRIPTION	XX	XX
G	DD.MM.YY	DESCRIPTION	XX	XX
Н	DD.MM.YY	DE5CRIPTION	XX	XX
1	DD.MM.YY	DESCRIPTION	XX	XX
J	DD.MM.YY	DESCRIPTION	XX	XX

DESIGN: TRENTHAM 30

FACADE: **PLANTATION** CEILING: 25. L

GARAGE: DOUBLE LOCATION: F

COVER SHEET

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FREEDOM

OWNER: MR & MRS HODGES LOT 7. NO 45 WARRIEWOOD ROAD WARRIEWOOD


BY METRICON


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JOB No: **720385** DATE: 17.02.2021 FC DATE: DD.MM.YYYY MST VER: 16.02.2017 REVISION: SCALE: DRAWN: CM8 CHECK: XX SHEET: COVER






(G) EASEMENT FOR ELECTRICITY PURPOSES 3.3 WIDE (G) (DP 1206507) (L) EASEMENT FOR WATER SUPPLY PURPOSES 2.5 WIDE (L) (DP 1206507)

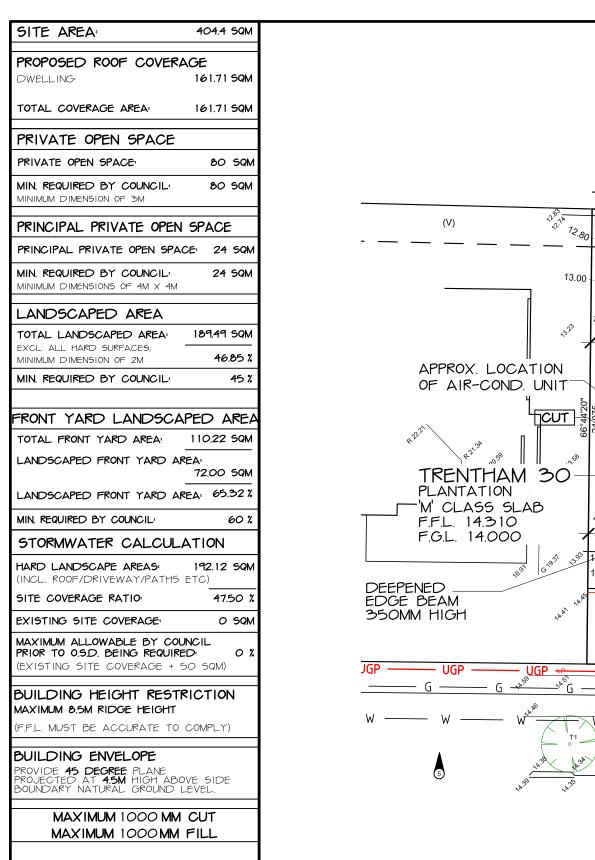(M) EASEMENT FOR ACCESS & DRAINAGE PURPOSES 2.5 WIDE (M) (DP 1206507)

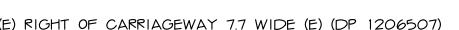(N) EASEMENT FOR ELECTRICITY PURPOSES VARIABLE WIDTH (N) (DP 1206507)

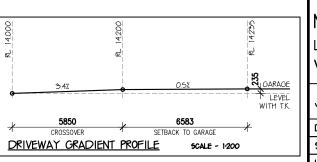

W NATURAL GREY

BY METRICON

CONCRETE CROSSOVER

(V)

MGA

LOT NO: LOT 7.

DEPOSITED PLAN:

DP 1206507. COUNCIL / LGA:

NORTHERN BEACHES

М SLAB CLASS:

N2

WIND SPEED:

EXCAVATION NOTES 50MM (+/-) TOLERANCE TO NOMINATED R.L.'S

EXCAVATE APPROX. OMM ON R.L. 14,000 AND FILL APPROX. 600MM WITHIN DEB

LOWER LEVEL EXCAVATE APPROX. 200MM ON R.L. 13,656 AND FILL APPROX. 756MM

EXCAVATIONS ARE TO START A MINIMUM OF 1000MM FROM THE EDGE OF THE BUILDING AND ARE TO BE BATTERED BACK TO SUIT IT IS THE RESPONSIBILITY OF THE OWNER TO PROVIDE A GRATED DRAIN ACROSS GARAGE OPENINGS (IF REQUIRED) DUE TO CONSTRUCTION OF DRIVEWAY

MPORTANT NOTES

ITE CUTS ARE SUBJECT TO COUNCIL APPROVAL NOT TO BE USED BY ANY OTHER CONTRACTORS OTHER THAN METRICON HOMES PTY LTD

STORMWATER TO DRAIN TO EASEMENT VIA ON-SITE DETENTION AND RAINWATER TANK(S)

REFER TO HYDRAULIC ENGINEER'S DETAILS

TEMPORARY SITE FENCING

METRICON TO PROVIDE FENCING TO ANY UNFENCED BOUNDARIES (AS REQUIRED)

ALL WEATHER ACCESS:

METRICON TO SUPPLY UP TO 5M SUITABLE ALL WEATHER ACCESS TO BUILDING PLATFORM DURING CONSTRUCTION

SURVEY LEGEND

S W T T T

GAS MARKER

OHYD HYDRANT

— OHP — GROUND GAS MAINS O'HEAD POWER SUPPLY L'GROUND POWER SUPPL

OP OF KERB EDGE OF BITUMEN

PP POWER POLE Y SV STOP VALVE O SMH SEWER MAINTENANCE HOLE SEWER INSPECTION OPENING SP SERVICE POLE TELECOMMUNICATIO LP LIGHT POLE

GRATED STORMWATER F

WM WATER METER KERB INLET STORMWATER INTRAX SURVEY DATE: 19.01.2021

CONTOUR INTERVALS 200 MM

LEVELS TO AHD

SITE PLAN




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IMR & MRS HODGES LOT 7, NO 45 WARRIEWOOD ROAD WARRIEWOOD

JOB No. 720385

DATE: 17.02.2021 DRAWN: CM8 SCALE: 1:200 SHEET: 1 OF 11 UBD REF. SYD XX XX



(P) EASEMENT FOR ELECTRICITY & OTHER PURPOSES 4.5 WIDE (P) (DP 1206507) (V) EASEMENT TO DRAIN WATER 2 WIDE (V) (DP 1206507)

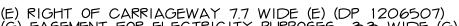CONTOURS ARE INDICATIVE OF SURFACE TOPOGRAPHY ONLY SURVEYED SPOT LEVELS ARE THE ONLY VALUES TO BE RELIED ON FOR REDUCED LEVELS ON PARTICULAR FEATURES.

CONSTRUCTION OR EXCAVATION.

THIS SURVEY IS SPECIFICALLY FOR CONTOUR PURPOSES ONLY. THE BOUNDARIES OF THE SUBJECT PROPERTY HAVE NOT BEEN INVESTIGATED AND THE POSITION SHOWN IS APPROXIMATE ONLY.

AREAS AND DIMENSIONS ARE SUBJECT TO SURVEY.

SERVICES SHOWN HAVE BEEN DERIVED FROM VISUAL EVIDENCE APPARENT AT THE TIME OF SURVEY. THE RELEVANT SERVICE AUTHORITY SHALL BE CONTACTED TO VERIFY THE EXISTENCE AND POSITION OF ALL SERVICES PRIOR TO THE COMMENCEMENT OF ANY

SURVEYORS NOTES

œί 60 13.00 12.60 6 DEEPENED EDGE BEAM 1000MM HIGH 13.73° 3375 1250 344 MM STEPDOWN FILL. 6 F.F.L. 13.966 F.G.L. 13.656 13:4Q APPROX. LOCATION OF HOT WATER UNIT Y(E) PREFERRED LOCATION OF GARAGE 13.60-FUTURE SLIMLINE ABOVE 75 MM FILL STEPDOWN GROUND RAINWATER TANK (P) F.F.L. 14.235 (SUBJECT TO BASIX & F.G.L. 14.000 .557 HYDRAULIC ASSESSMENTS) 33377 (E) 1383 INTEGRATED BRICK RETAINING WALL TO 4.20 FILL DRIVEWAY BY METRICON (G) (REFER TO ENGINEER'S DETAILS) 5000 ON FR Ö COLOUR THROUGH CONCRETE DRIVEWAY AND ENTRY PATH BY METRICON (EXCLUDING COUNCIL CROSSOVER) 16.995

337°28'25"

(E) (V)

≥

(M)(V)

(L)

330°48'05"\

(V)

(P)

12.60 2


(P) (V) (P) (E)

5

(N)



- 1. ALL EROSION AND SEDIMENTATION CONTROL MEASURES, INCLUDING REVEGETATION AND STORAGE OF SOIL AND TOPSOIL, SHALL BE IMPLEMENTED TO THE STANDARDS OF THE SOIL CONSERVATION OF NSW AND INSPECTED REGULARLY BY THE SITE MANAGER.
- 2. ALL DRAINAGE WORKS SHALL BE CONSTRUCTED AND STABILIZED AS EARLY AS POSSIBLE DURING DEVELOPMENT.
- 3. SEDIMENT TRAPS SHALL BE CONSTRUCTED AROUND ALL INLET PITS, CONSISTING OF 300MM WIDE X 300MM
- 4. ALL SEDIMENT BASINS AND TRAPS SHALL BE CLEANED WHEN THE STRUCTURES ARE A MAXIMUM OF 60% FULL OF SOIL MATERIALS, INCLUDING THE MAINTENANCE PERIOD
- 5. SOIL AND TOPSOIL STOCKPILES SHALL BE LOCATED AWAY FROM DRAINAGE LINES AND AREA WHERE WATER MAY CONCENTRATE. ALL ROADS AND FOOTPATHS TO BE SWEPT DAILY.
- 6. FILTER SHALL BE CONSTRUCTED BY STRETCHING A FILTER FADRIC (PROPEX OR APPROVED EQUIVALENT DETWEEN POST AT 3.0M CENTRES, FADRIC SHALL BE BURIED ISOMM ALONG ITS LOWER EDGE.
- 7. DUST PREVENTION MEASURES TO BE MAINTAINED AT ALL TIMES.

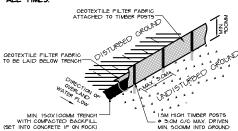

SEDIMENT FENCE DETAIL

NOT TO SCALE

TEMPORARY SECURITY FENCING

TEMPORARY SECURITY FENCING TO THE PERIMETER OF BOUNDARY WHERE REQUIRED TO PREVENT PUBLIC ACCESS ONTO SITE.

CUT & FILL BATTERS

ALL GROUND LINES ARE APPROXIMATE. EXTENT OF CUT AND FILL BATTERS WILL BE DETERMINED ON SITE. SEDIMENT BARRIERS ARE TO BE CUSTOMISED SITE SPECIFIC

SEDIMENT = = = = = = = = **FENCE**

WASTE STORAGE AREA



MATERIAL STORAGE AREA




PORTABLE TOILET



ALL WEATHER ACCESS POSITION



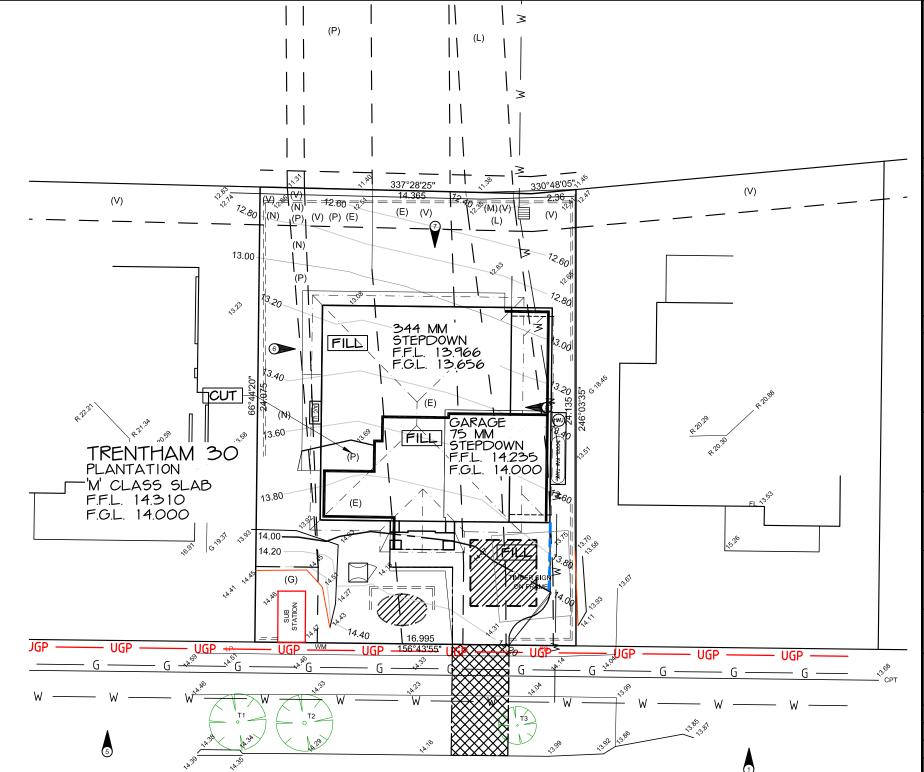


RIGHT OF CARRIAGEWAY 7.7 WIDE (E) (DP 1206507)

(G) EASEMENT FOR ELECTRICITY PURPOSES 3.3 WIDE (G) (DP 1206507) (L) EASEMENT FOR WATER SUPPLY PURPOSES 2.5 WIDE (L) (DP 1206507)

(M) EASEMENT FOR ACCESS & DRAINAGE PURPOSES 2.5 WIDE (M) (DP 1206507)

(N) EASEMENT FOR ELECTRICITY PURPOSES VARIABLE WIDTH (N) (DP 1206507) (P) EASEMENT FOR ELECTRICITY & OTHER PURPOSES 4.5 WIDE (P) (DP 1206507) (V) EASEMENT TO DRAIN WATER 2 WIDE (V) (DP 1206507)

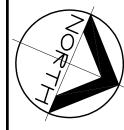

LOT NO: LOT 7.

DEPOSITED PLAN: DP 1206507.

COUNCIL / LGA:

NORTHERN BEACHES

SLAB CLASS:

N2

MGA

WIND SPEED:

SURVEY LEGEND

GROUND SEWER MAINS U'GROUND WATER MAINS U'GROUND TELECOM, LII GROUND GAS MAINS O'HEAD POWER SUPPLY U'GROUND POWER SUPPL TOP OF KERB EDGE OF BITUMEN

PP POWER POLE PB POWER BOX OSP SERVICE POLE LIGHT POLE O HYD HYDRANT

X SV STOP VALVE OSMH SEWER MAINTENANCE
HOLE
SEWER INSPECTION
OPENING
TELECOMMUNICATIONS
PIT GAS MARKER WM WATER METER STORMWATER PI

GRATED STORMWATER △ BENCHMARK

TREE

EROSION & SEDIMENT CONTROL PLAN

CONSTRUCTION PLAN

TEMPORARY FENCING:

BUILDER TO PROVIDE FENCING TO ANY UNFENCED BOUNDARIES (LOCAL AUTH.

ALL WEATHER ACCESS

METRICON TO SUPPLY UP TO 5M SUITABLE ALL WEATHER ACCESS TO BUILDING PLATFORM DURING CONSTRUCTION

INTRAX SURVEY DATE: 19.01.2021

CONTOUR INTERVALS 200 MM

LEVELS TO AHD



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MR & MRS HODGES LOT 7, NO 45 WARRIEWOOD ROAD WARRIEWOOD

JOB No. 720385

DATE: 11.08.2021 DRAWN: 503 SCALE: 1:200 SHEET: 1A OF 11 UBD REF. SYD XX XX



MAIN VIEWS



PRIVATE OPEN SPACE




NUMBER OF STOREYS



NOISE SOURCE



PREVAILING WINDS FROM SOUTH-WEST

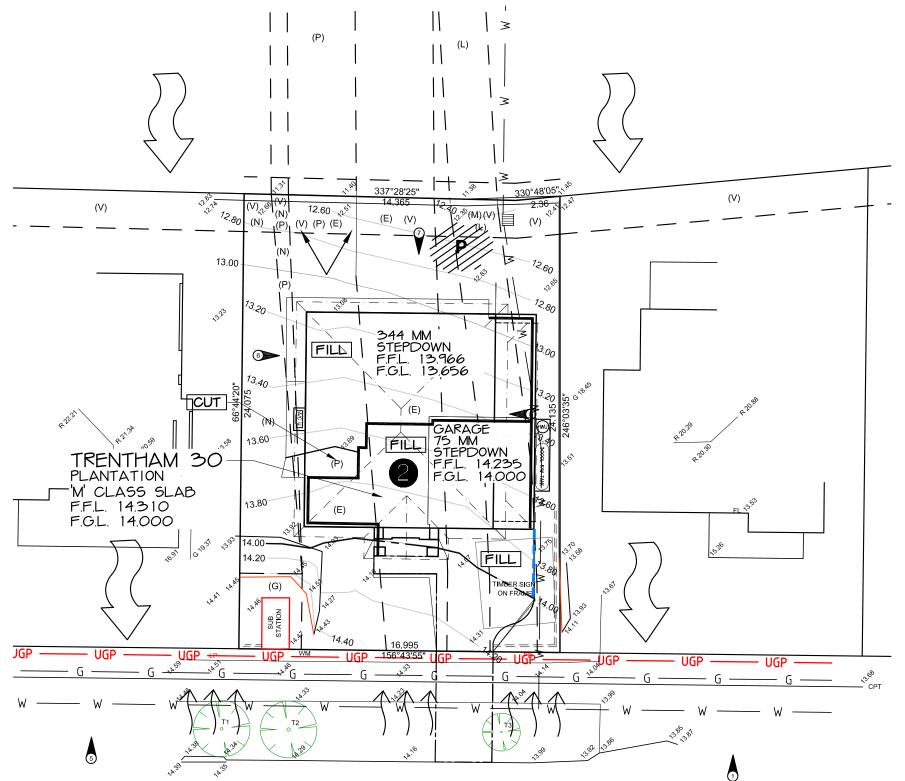



LOT NO: LOT 7. DEPOSITED PLAN: DP 1206507.


COUNCIL / LGA: NORTHERN BEACHES

SLAB CLASS:

N2

MGA

WIND SPEED:

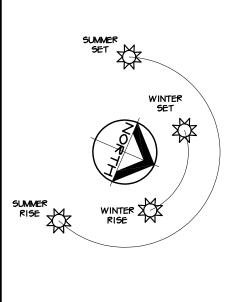

SITE ANALYSIS PLAN

TEMPORARY FENCING:

BUILDER TO PROVIDE FENCING TO ANY UNFENCED BOUNDARIES (LOCAL AUTH.

ALL WEATHER ACCESS

METRICON TO SUPPLY UP TO 5M SUITABLE ALL WEATHER ACCESS TO BUILDING PLATFORM DURING CONSTRUCTION

INTRAX SURVEY DATE: 19.01.2021

CONTOUR INTERVALS 200 MM

LEVELS TO: AHD




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MR & MRS HODGES LOT 7, NO 45 WARRIEWOOD ROAD WARRIEWOOD

JOB No. 720385

DATE: 11.08.2021 DRAWN 503 SCALE: 1:200 SHEET: 1B OF 11 UBD REF. SYD XX XX



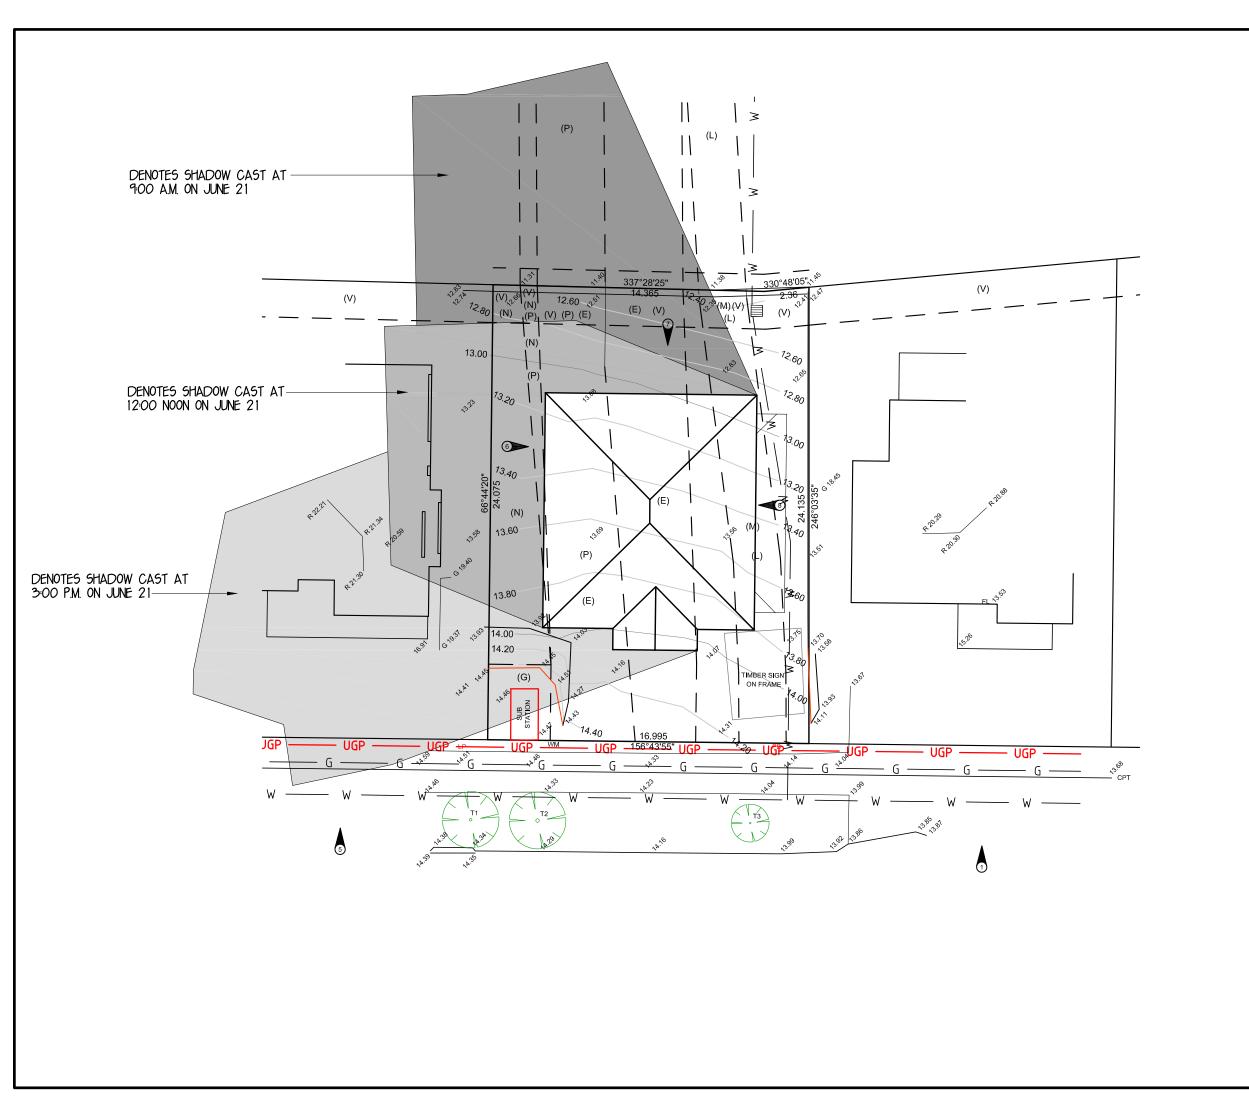


LOT NO: LOT 7. DEPOSITED PLAN: DP 1206507.

COUNCIL / LGA: NORTHERN BEACHES

SLAB CLASS:

N2

WIND SPEED: MGA

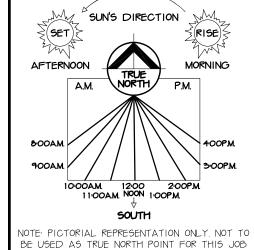

SHADOW TIME OF DAY LOCATION

9:00 A.M. JUNE 21 12:00 NOON JUNE 21

3:00 P.M. JUNE 21

TIME SHADOW LENGTH RATIO (METRES)		ALTITUDE (DEGREES)	AZIMUTH (DEGREES)
8:00 AM	5.82	9.76	53.12
9:00 AM	2.91	18.96	42.59
10:00 AM	2.02	26.33	30.01
11:00 AM	1.66	31.14	15.3
12:00 PM	1.56	32.72	359.19
1:00 PM	1.68	30.8	343.16
2:00 PM	2.08	25.7	328.65
3:00 PM	3.06	18.11	316.28
4:00 PM	6.48	8.77	305.94

INTRAX SURVEY DATE: 19.01.2021

CONTOUR INTERVALS 200 MM

LEVELS TO AHD

SHADOW DIAGRAM @ JUNE 21



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MR & MRS HODGES LOT 7, NO 45 WARRIEWOOD ROAD WARRIEWOOD


JOB No. 720385

DATE: 11.08.2021 DRAWN 503 SCALE: 1:200 SHEET: 10 OF 11

UBD REF. SYD XX XX

PROVIDE 2340MM (H) INTERNAL DOORS TO THE GROUND FLOOR ONLY UNLESS OTHERWISE NOTED (EXCLUDES SLIDING ROBE DOORS)



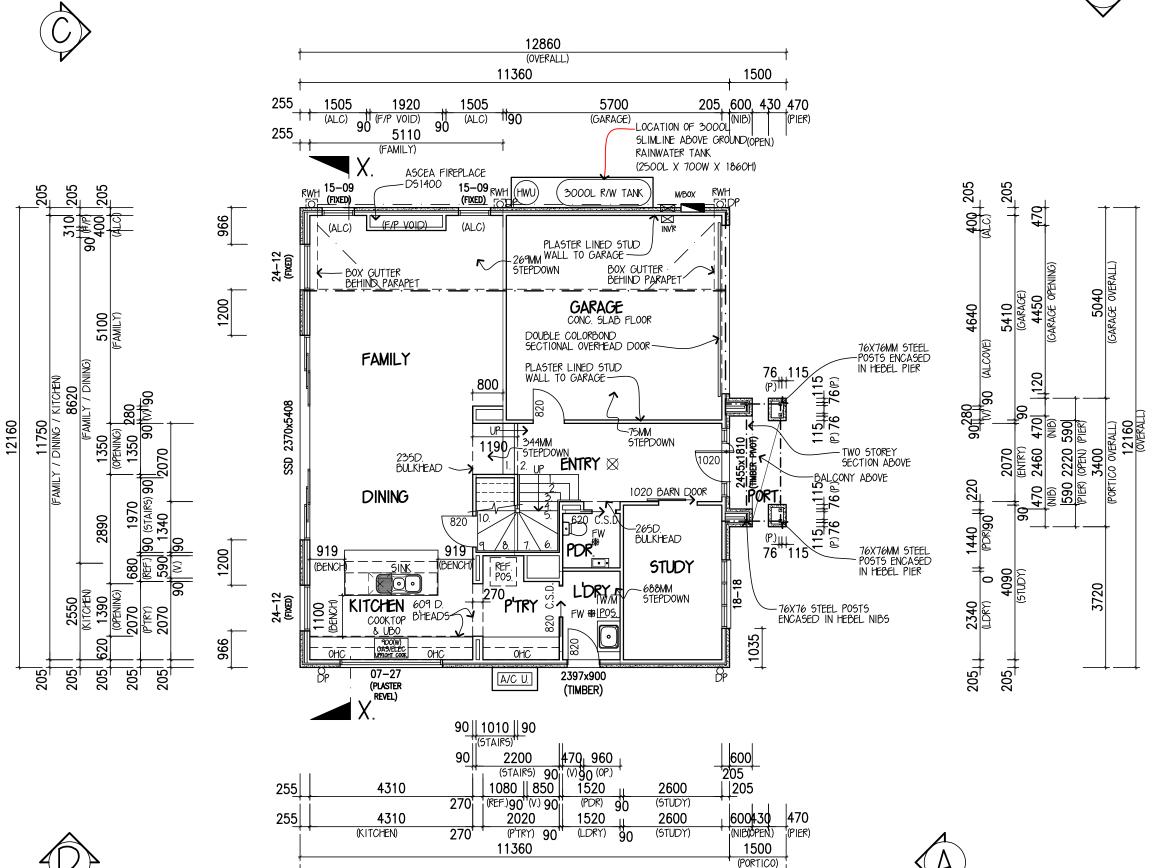

12860 (OVERALL)

SYMBOL LEGEND

FRAMING LEGEND

LOAD BEARING WALL

DOWNPIPE 90mm ROUND PVC

70mm STUD WALL

DOWNPIPE 100x50mm RECT. C/BOND 120mm STUD WALL

DOWNPIPE DP+SPR WITH SPREADER

DOWNPIPE WITH RAINWATER HEAD **X**-GARDEN TAP

APPROX. POSITION INSTALLED
AS PER N.C.C. 3.7.2. & TO
COMPLY WITH AS 3786. SMOKE

4 GAS BAYONET

COLD WATER POINT EXHAUST FAN. CC INSTALLED AS PER B.C.A. 3.8.5. & TO COMPLY WITH A.S.1668.2.

FW⊕

FLOOR WASTE ELEC. METERBOX 600x600 RECESSED AIR COND. UNIT

A/C U. МН

MANHOLE FOR CEILING ACCESS



ARTICULATION JOINT WHERE ARTICULATION JOINTS ARE NOT SHOWN REFER TO STRUCTURAL ENGINEER'S DETAILS

AREAS:		GARAGE:	33.14 SQM
GRD FLR:	105.00 SQM	PORTICO:	5.10 SQM
FIRST FLR:	115.53 SQM	BALCONY:	2.81 SQM
SUBTOTAL:	220.53 SQM	TOTAL:	261.58 SQM
	23.74 SQR		28.16 SQR
		•	

DESIGN: TRENTHAM 30

FACADE: **PLANTATION** CEILING: 25, L

GARAGE: **DOUBLE**

LOCATION: F

GROUND FLOOR PLAN

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m metricon

BY METRICON

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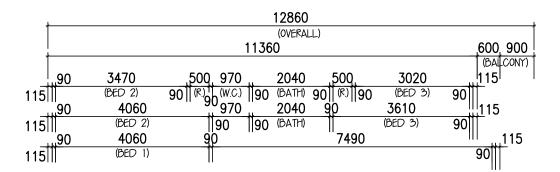
OWNER: MR & MRS HODGES LOT 7 . NO 45 WARRIEWOOD ROAD WARRIEWOOD


	JOB No: 720385 FC DATE: DD.MM.YYYY SCALE: 1:100 ON A3 S		85	DATE:	17.02.2021
			MST VE	R: 16.02.2017	
			ON A3 SI	HEET	REVISION: E
	DRAWN:	CM8	CHECK:	XX	SHEET: 2 of 11




3150 (BED 2)

10120 (OVERALL)



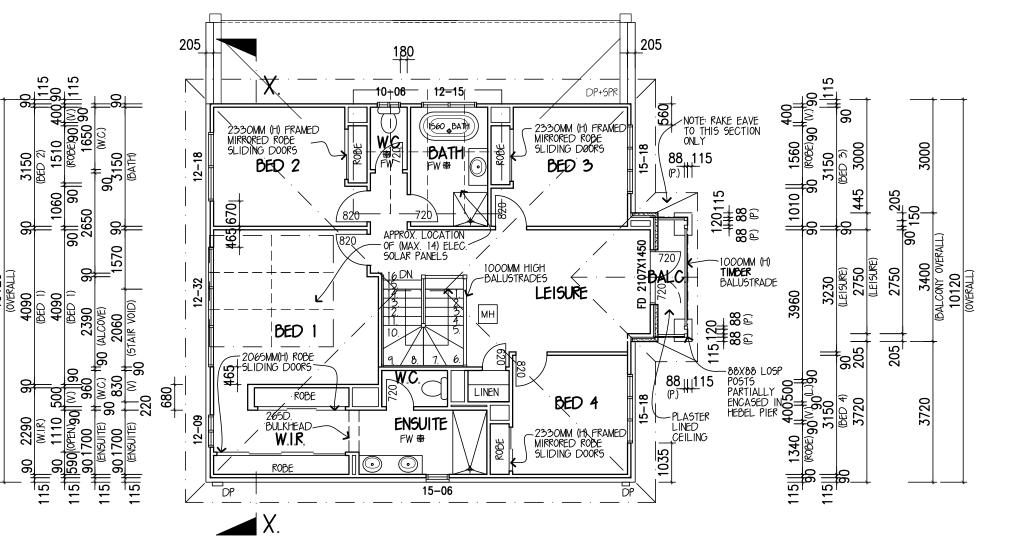

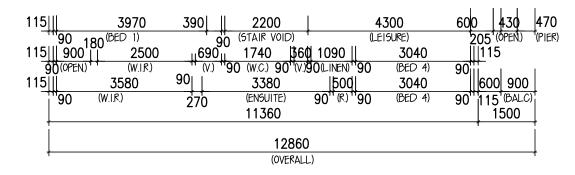



SYMBOL LEGEND

FRAMING LEGEND DOWNPIPE

90mm ROUND PVC

LOAD BEARING WALL 70mm STUD WALL

DOWNPIPE

DOWNPIPE DP+SPR WITH SPREADER

DOWNPIPE WITH RAINWATER HEAD **X**-GARDEN TAP

APPROX. POSITION INSTALLED AS PER N.C.C. 3.7.2. & TO COMPLY WITH AS 3786. SMOKE ALARMS TO BE INTERCONNECTE

4 GAS BAYONET

COLD WATER POINT EXHAUST FAN. $\mathfrak C$ INSTALLED AS PER B.C.A. 3.8.5. & TO COMPLY WITH A.S.1668.2. FLOOR WASTE

FW⊕

ELEC. METERBOX 600x600 RECESSED

A/C U.

AIR COND. UNIT

мн

MANHOLE FOR CEILING ACCESS

ARTICULATION JOINT WHERE ARTICULATION JOINTS ARE NOT SHOWN REFER TO STRUCTURAL ENGINEER'S DETAILS

AREAS:		GARAGE:	38.94 SQN
GRD FLR:	118.01 SQM	PORTICO:	7.49 SQN
FIRST FLR:	120.78 SQM	OUTDOOR:	0.00 50 N
SUBTOTAL:	238.79 SQM	TOTAL:	285.22 5 0N
	25.70 SQR		30.70 SQF
SUBTOTAL:		TOTAL:	

DESIGN: TRENTHAM 30

FACADE: **PLANTATION** CEILING: **25**, **L**

GARAGE: **DOUBLE**

LOCATION: F

FIRST FLOOR PLAN

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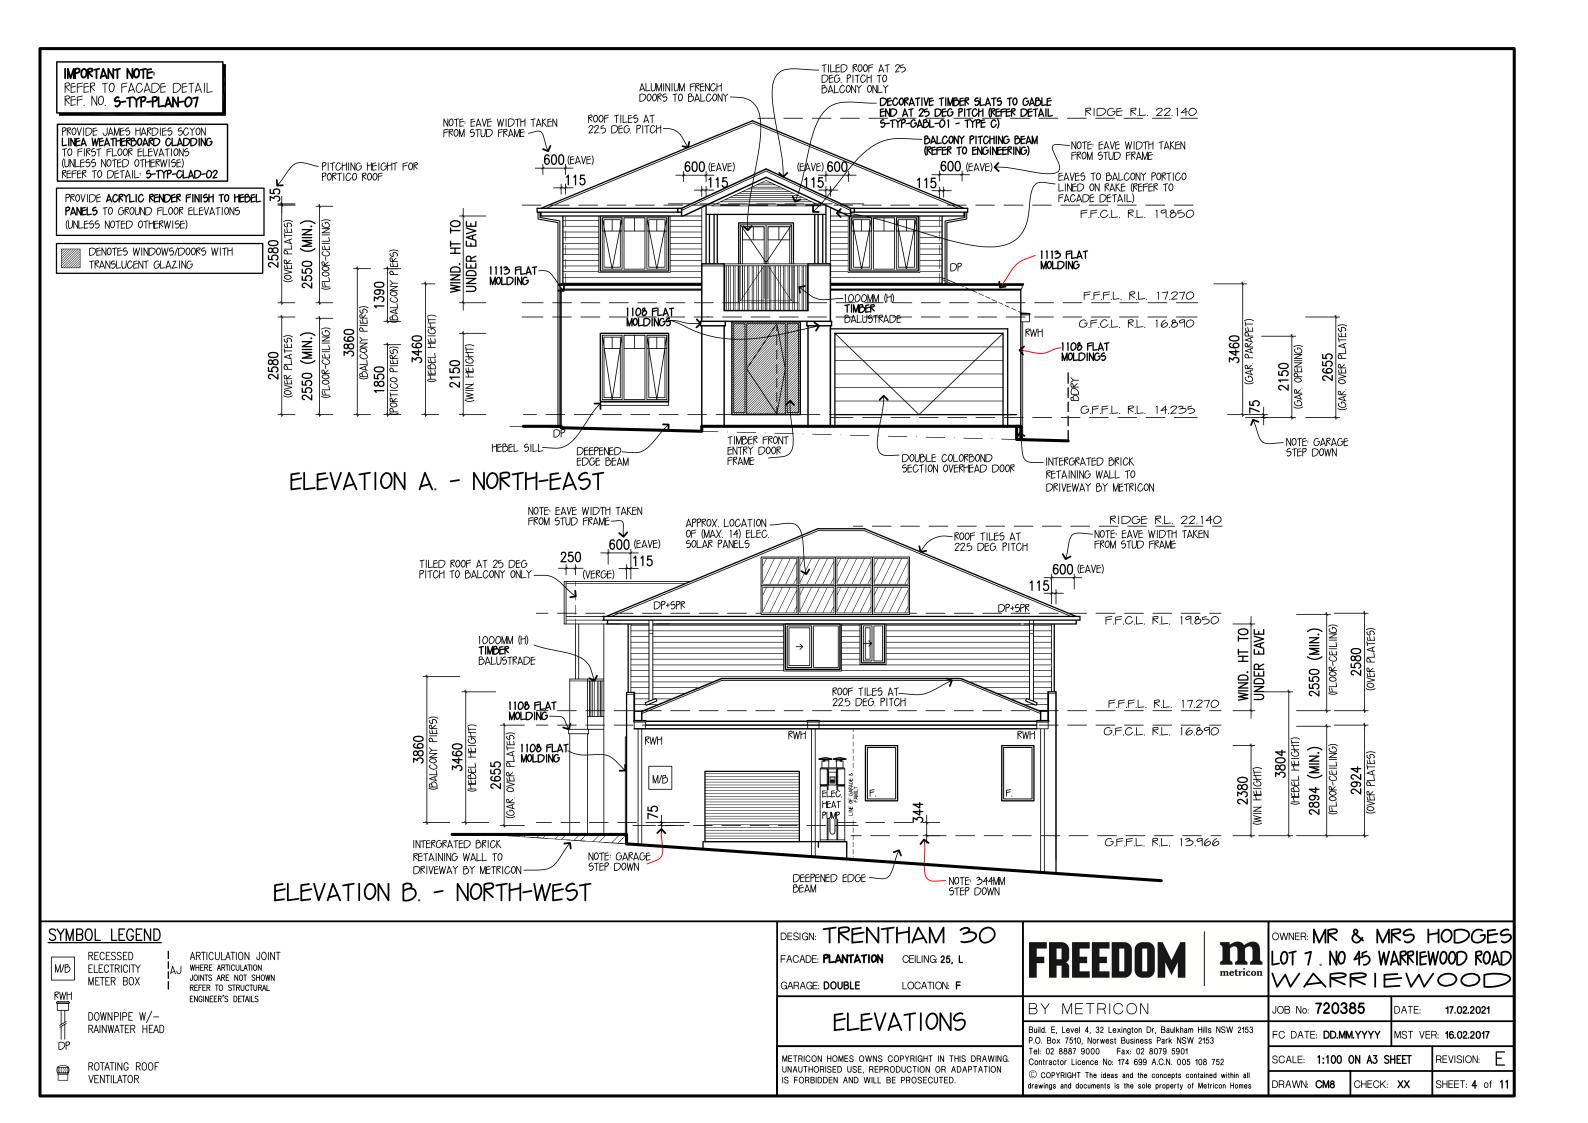
Build. E, Level 4, 32 Lexington Dr, Baulkham Hills NSW 2153 P.O. Box 7510, Norwest Business Park NSW 2153 Tel: 02 8887 9000 Fax: 02 8079 5901 Contractor Licence No: 174 699 A.C.N. 005 108 752 $\ensuremath{\mathbb{C}}$ COPYRIGHT The ideas and the concepts contained within all drawings and documents is the sole property of Metricon Homes


OWNER: MR & MRS HODGES LOT 7 . NO 45 WARRIEWOOD ROAD WARRIEWOOD


JOB No: 720385 FC DATE: DD.MM.YYYY SCALE: 1:100 ON A3 \$	DATE:	17.02.2021		
FC DATE: DD.MM.YYYY		1.YYYY	MST VE	R: 16.02.2017
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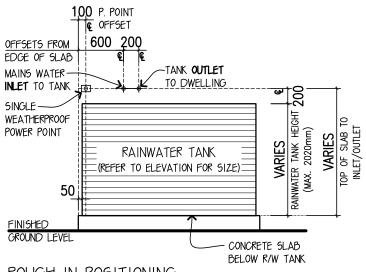








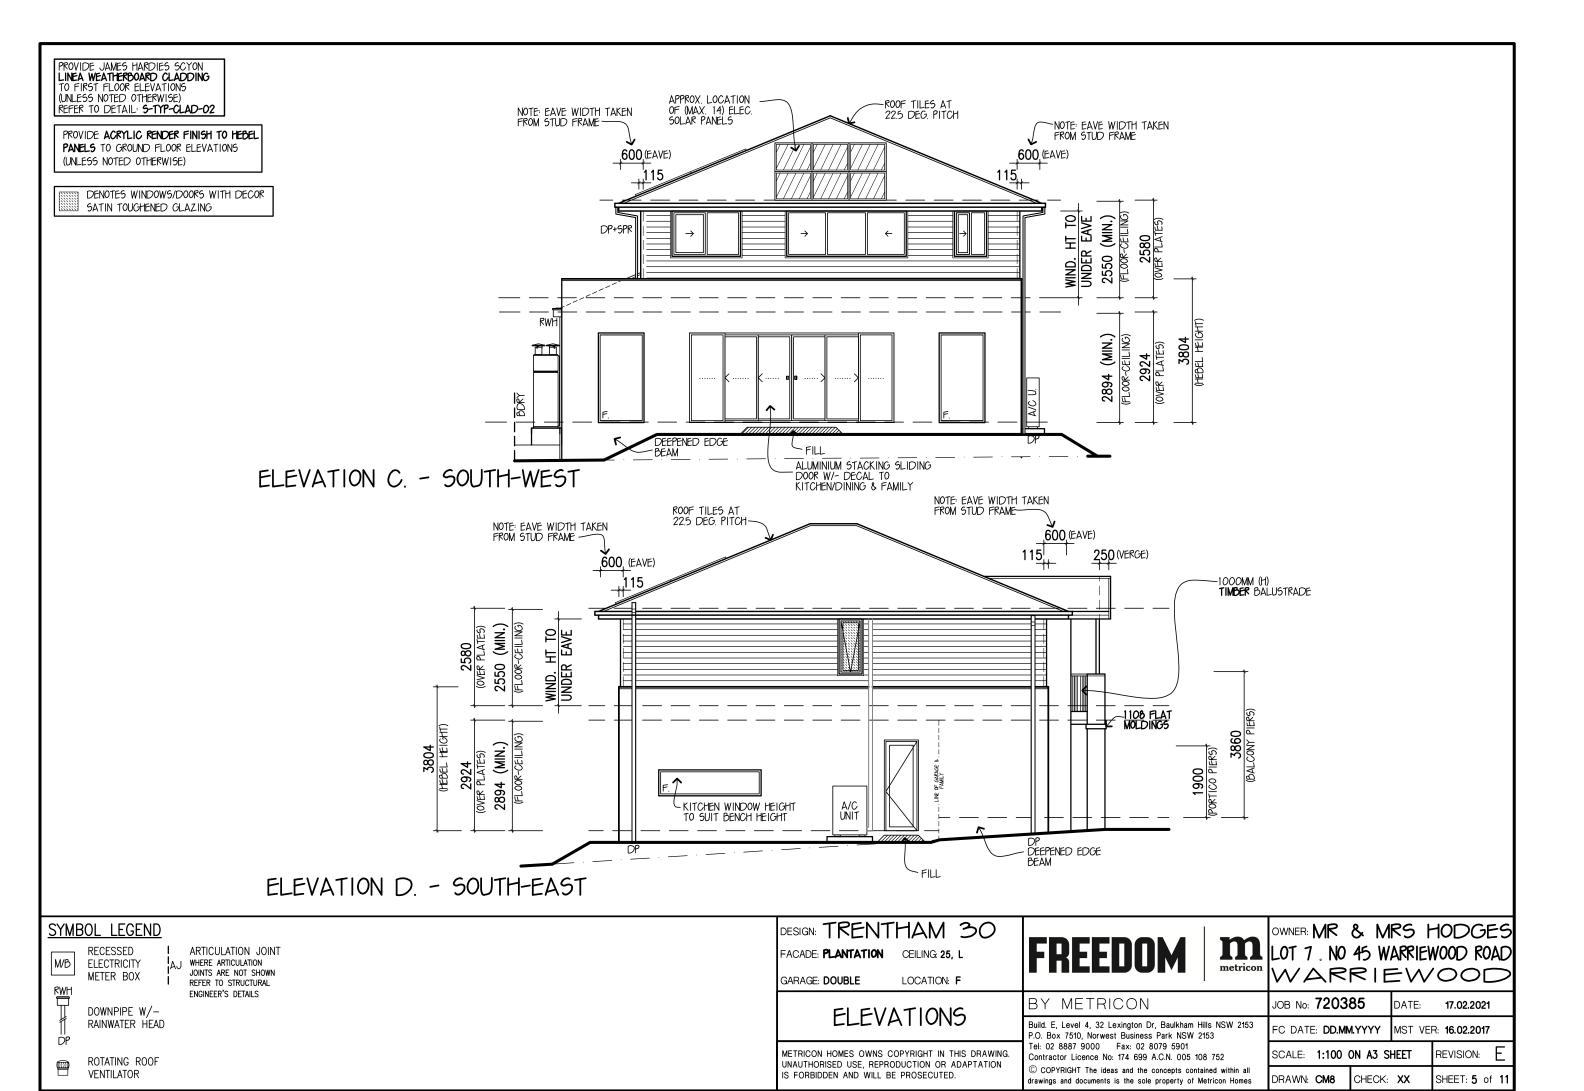

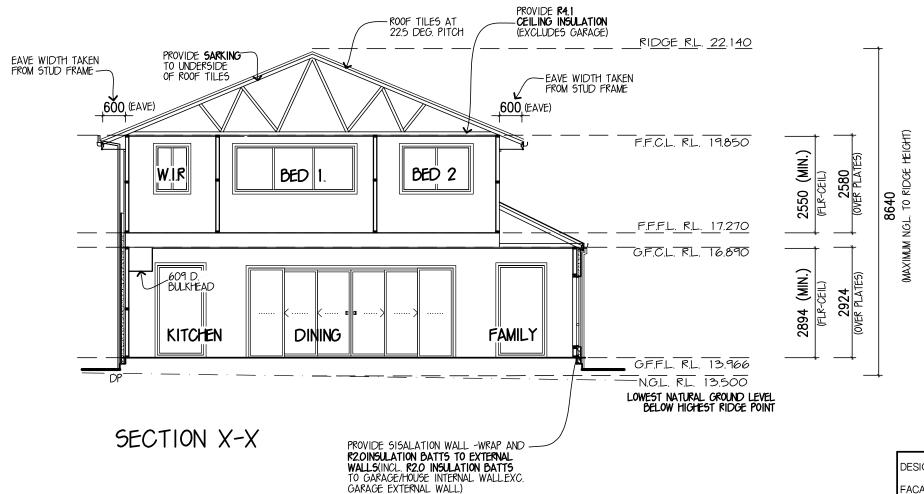

ROUGH-IN POSITIONING (NOT TO SCALE)

'EVOLUTION' MK2 TANK DETAIL (NOT SUITABLE FOR TANKS EXCEEDING 2020MM HIGH)

DESIGN: TRENTHAM 30

FACADE: **PLANTATION** CEILING: **25**, **L**

GARAGE: **DOUBLE**

LOCATION: F

SECTION

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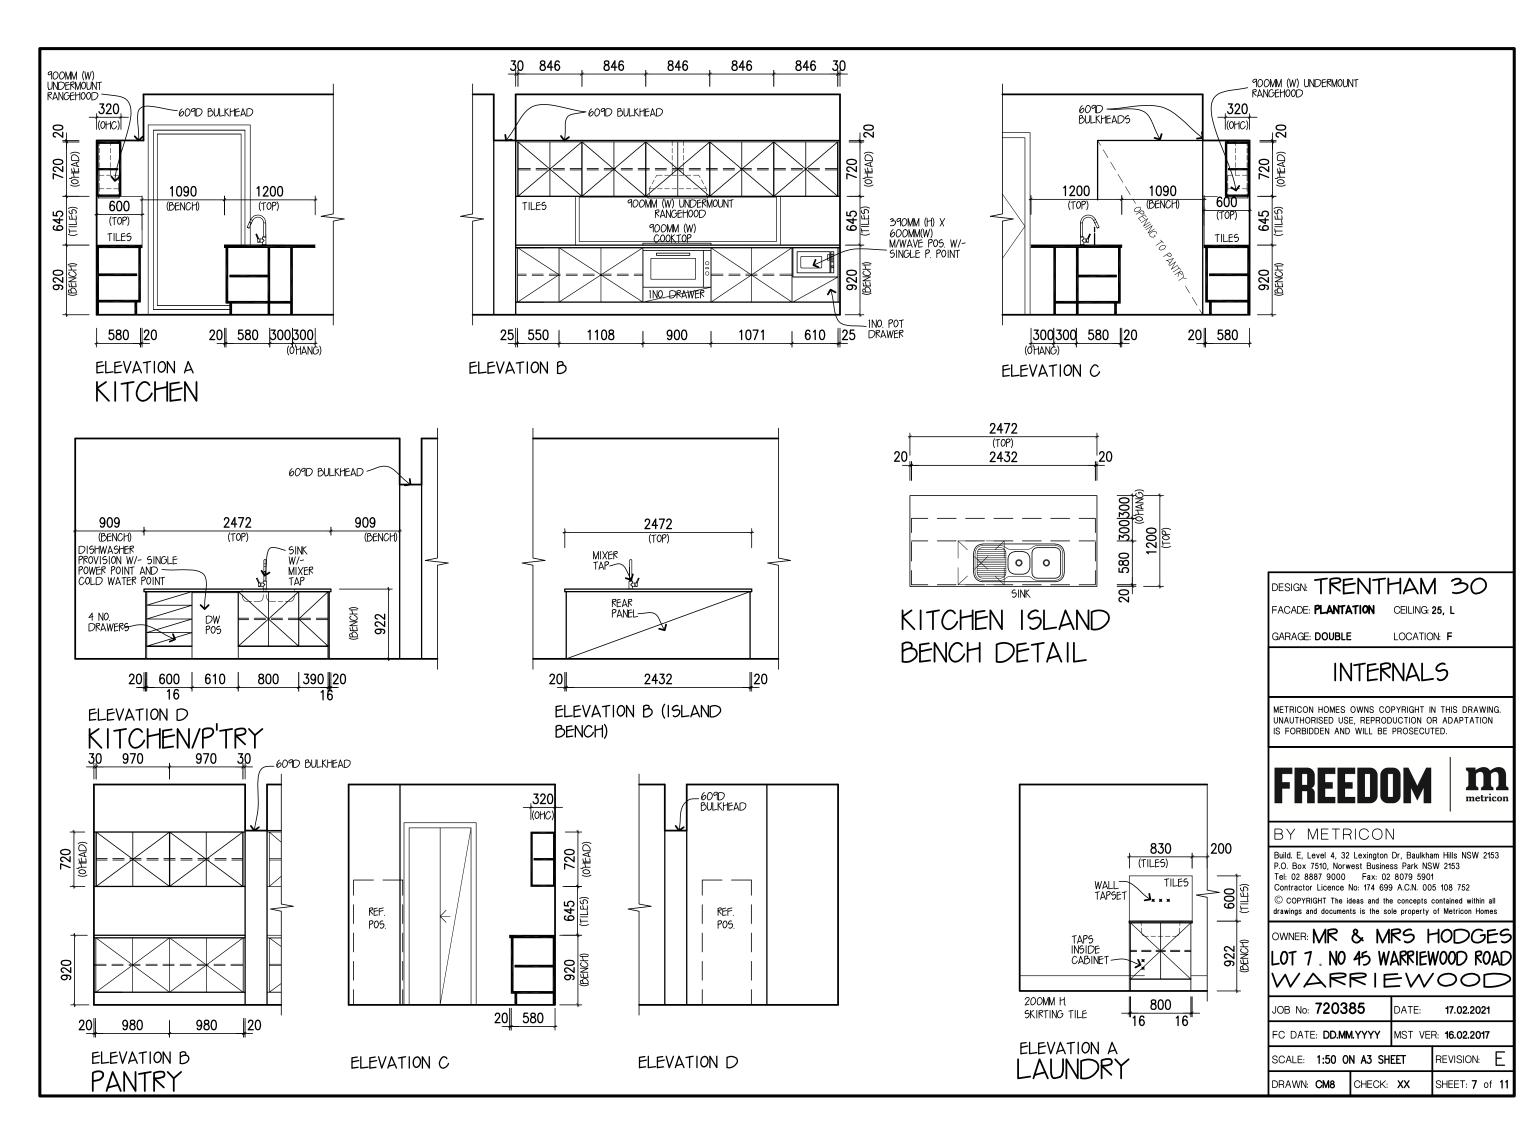



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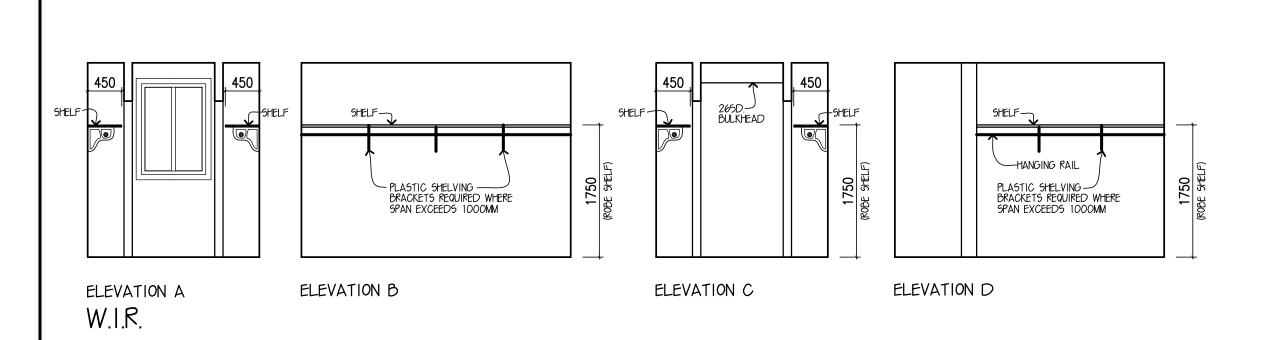
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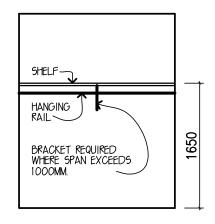
OWNER: MR & MRS HODGES LOT 7 . NO 45 WARRIEWOOD ROAD WARRIEWOOD

JOB No: 7203	85	DATE:	17.02.2021
FC DATE: DD.MM.YYYY		MST VE	R: 16.02.2017
SCALE: 1:100	ON A3 S	HEET	REVISION: E
DRAWN: CM8	CHECK:	XX	SHEET: 6 of 11







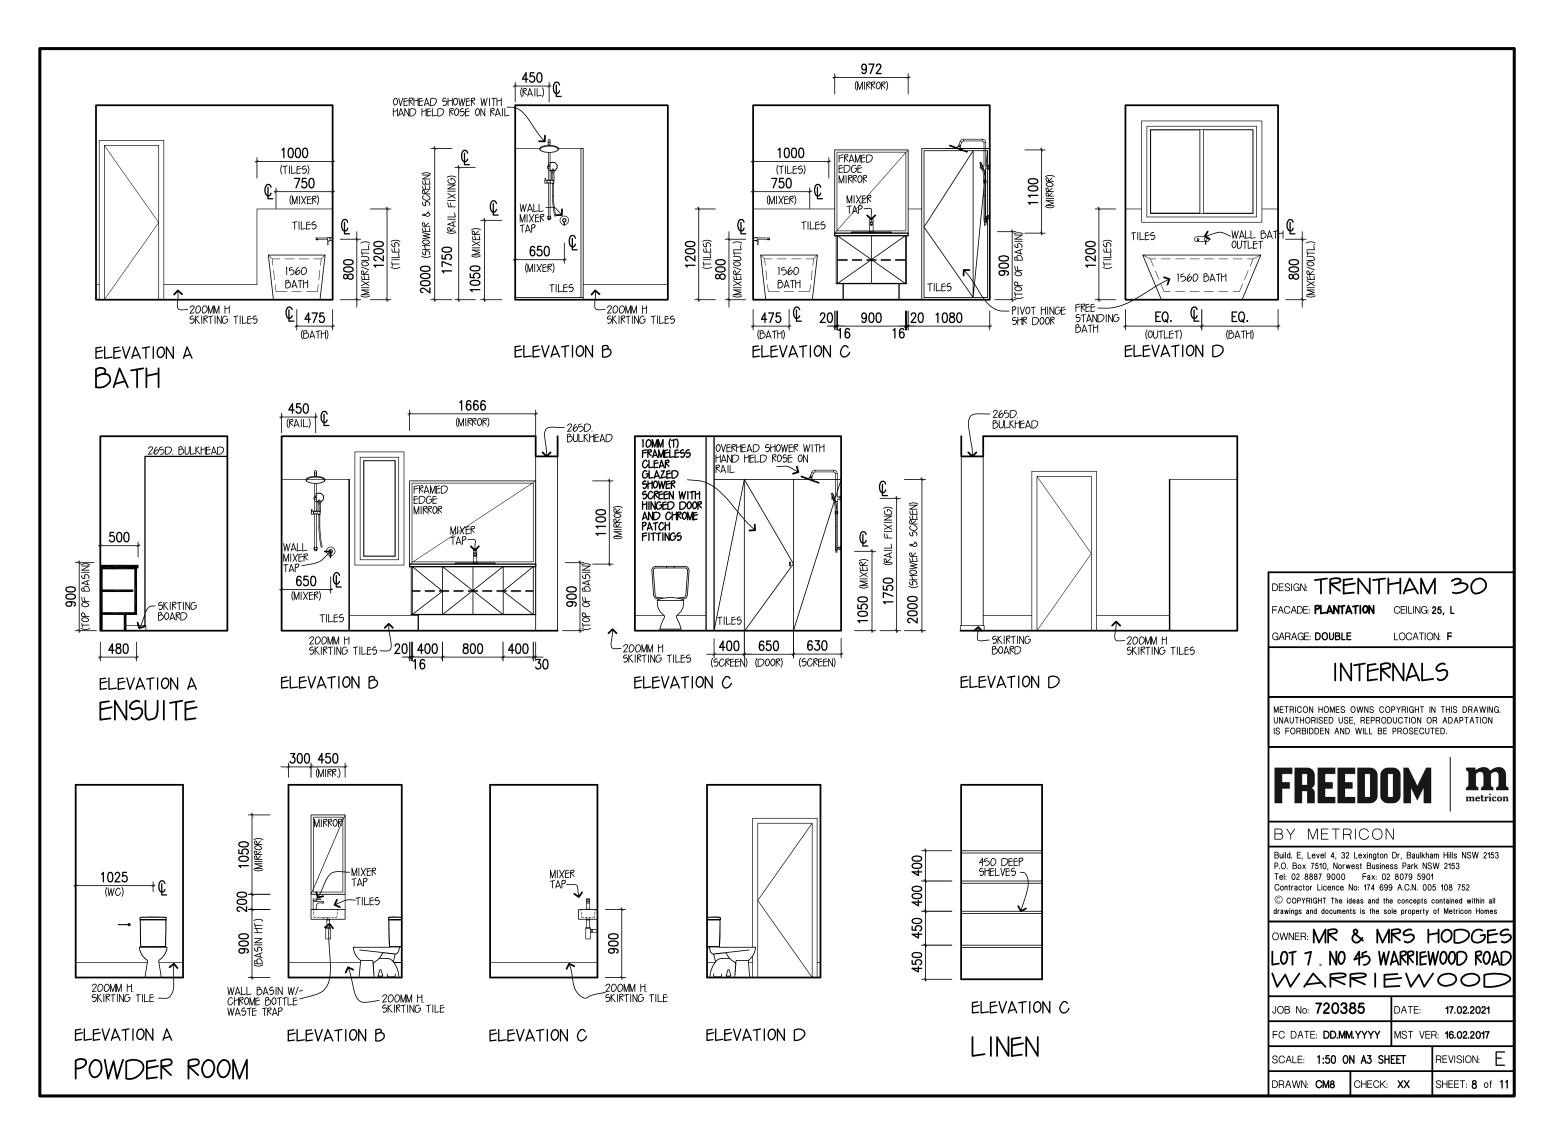

BED'S 2,3&4 (TYPICAL)

ROBE

DESIGN: TRENTHAM 30

FACADE: **PLANTATION** CEILING: 25, L

GARAGE: **DOUBLE** LOCATION: **F**

INTERNALS

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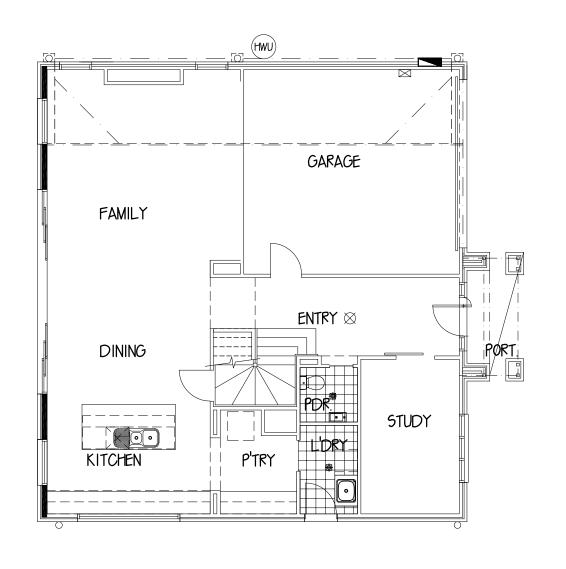
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OWNER MR & MRS HODGES LOT 7. NO 45 WARRIEWOOD ROAD WARRIEWOOD

JOB No: 720385	DATE:	17.02.2021
EC DATE: DD MM YYYY	MST VER	16.02.2017

SCALE:	1:50 0	N A3 SHEET	REVISION:	Ε
DRAWN:	CM8	CHECK: XX	SHEET: 9 of	11



FLOOR COVERINGS LEGEND



WET AREA FLOOR TILING TOTAL AREA: 5.32 SQM



CARPET FLOOR AREAS TOTAL AREA: **** SQM



TIMBER FLOOR AREAS TOTAL AREA: **** SQM



TILED FLOOR AREAS TOTAL AREA: **** SQM

DESIGN: TRENTHAM 30

FACADE: **PLANTATION** CEILING: 25, L

GARAGE: **DOUBLE**

LOCATION: F

GROUND FLOOR

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OWNER MR & MRS HODGES LOT 7 NO 45 WARRIEWOOD ROAD


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JOB No: 720385	DATE: 17.02.2021
FC DATE: DD.MM.YYYY	MST VER: 16.02.2017

SCALE: 1:100 ON A3 SHEET REVISION: DRAWN: CM8 CHECK: XX SHEET:10 of 11



FLOOR COVERINGS LEGEND

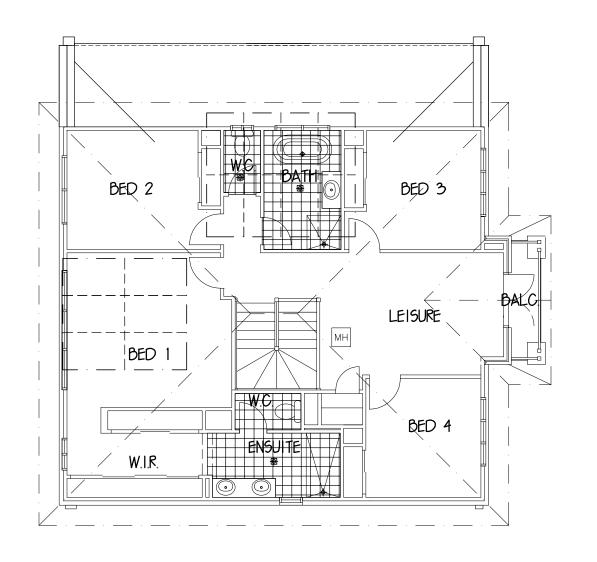

WET AREA FLOOR TILING TOTAL AREA: 14.4 SQM



CARPET FLOOR AREAS TOTAL AREA: **** SQM



TIMBER FLOOR AREAS TOTAL AREA: **** SQM



TILED FLOOR AREAS TOTAL AREA: **** SQM

DESIGN: TRENTHAM 30

FACADE: **PLANTATION** CEILING: 25, L

GARAGE: **DOUBLE**

LOCATION: F

FIRST FLOOR

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FREEDOM

DRAWN: CM8

OWNER: MR & MRS HODGES LOT 7. NO 45 WARRIEWOOD ROAD
WARRIEWOOD

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FC DATE: DD.MM.YYYY	MST VE	R: 16.02.2017	,
SCALE: 1:100 ON A3 S	HEET	REVISION:	F

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SHEET: 11 of 11

GENERAL DRAINAGE NOTES

- THE CONTRACTOR SHALL ADEQUATELY DRAIN THE SITE DURING ALL STAGES OF
- CONTRACTOR SHALL VERIFY ALL LEVELS DIMENSIONS AND SERVICES PRIOR TO COMMENCEMENT OF WORK.
- ALL APPROPRIATE PERMITS SHALL BE OBTAINED AND FEES PAID FOR BY THE CONTRACTOR
- ANY PAVEMENT OR FEATURES DAMAGED DURING THE COURSE OF THIS CONTRACT SHALL BE REINSTATED TO THEIR FORMER CONDITION.
- THE CONTRACTOR SHALL ARRANGE A SITE INSPECTION WITH THE CIVIL ENGINEERING SUPERVISING OFFICER PRIOR TO THE COMMENCEMENT OF WORK TO RECORD ANY DAMAGE TO EXISTING FEATURES.
- ALL EXISTING PIT COVERS, DOWNPIPE CONNECTIONS AND SIMILAR FEATURES IN CONSTRUCTION AREAS ARE TO BE ADJUSTED TO SUIT AS PART OF THIS
- ALL CONCRETE PAVEMENT SHALL BE FINISHED WITH A NON SKID FLOAT, (NO BROOMED FINISH)
- BEFORE COMMENCEMENT OF WORK A TEMPORARY BENCH MARK IS TO BE ESTABLISHED BY THE CONTRACTOR IN A POSITION ON SITE SAFE FROM DISTURBANCE
- ALL FILLING SHALL BE UNIFORMITY PLACED IN LAYERS NOT EXCEEDING 200mm LOOSE MEASUREMENT. EACH LAYER SHALL BE WITHIN 85% TO 115% OF OPTIMUM MOISTURE CONTENT AND BE PROPERLY COMPACTED, AS SPECIFIED, BASED ON THE STANDARD COMPACTION TEST AS OUTLINED IN AS 1289-1977.
- CRUSHED ROCK PAVEMENT COMPACTIONS SHALL BE TO 100% STANDARD MAXIMUM 5. DRY DENSITY FOR BASE COARSE, AND 98% FOR SUB BASE COARSE.
- ANY SHORTFALL IN INDIGENOUS TOPSOIL REQUIRED TO BRING THE GARDEN AND GRASSED AREAS TO THE DESIGN LEVELS SHALL BE MADE UP WITH APPROVED IMPORTED TOPSOIL. NO ADDITIONAL PAYMENT WILL BE MADE FOR IMPORTED
- EXCAVATED MATERIAL SHALL BE STOCKPILED ON SITE AS DIRECTED BY THE SUPERINTENDENT. EXCESS TO BE REMOVED FROM SITE AT CONTRACTORS **EXPENSE**
- TOPSOIL TO BE STRIPPED TO A DEPTH OF 150mm UNDER FILL AREAS AND ALL OTHER AREAS. THIS TOPSOIL SHALL BE STOCKPILED ON SITE AS DIRECTED BY SUPERINTENDENT. EXCESS SOIL TO BE STOCKPILED ON SITE AS DIRECTED BY THE SUPERINTENDENT, OR REMOVED FROM THE SITE AT THE CONTRACTORS EXPENSE, IE SO DIRECTED
- ALL STORMWATER DRAINS SHALL BE BEDDED ON A MINIMUM OF 80mm COMPACTED THICKNESS 20 N.S. CLASS 3 FINE CRUSHED ROCK, IN SOIL BASED TRENCHES . INCREASE TO 200mm THICKNESS IN ROCK BASED TRENCHES
- 100mm DIAMETER STORMWATER DRAINS SHALL BE LAID AT A MINIMUM GRADE OF 1:100 UNLESS OTHERWISE SHOWN.
- 150mm DIAMETER STORMWATER DRAINS SHALL BE LAID AT A MINIMUM GRADE OF 1:100, UNLESS OTHERWISE SHOWN.
- TRENCH EXCAVATIONS; WHERE ONE OR BOTH SIDES OF ANY TRENCH EXCEED 1.5 M IN DEPTH, THE CONTRACTOR SHALL ENSURE THAT THE PROVISIONS OF MINES ACT 1958 AND THE MINES (TRENCHES) REGULATIONS 1979 ARE COMPLIED WITH.
- TRENCHES TRAVERSING EXISTING OR PROPOSED PAVEMENTS INCLUDING ASPHALT AND CONCRETE SHALL BE BACKFILLED WITH "FIRST CLASS MATERIAL" AND COMPACTED, PAVEMENT SHALL BE REINSTATED TO THE SATISFACTION OF THE
- ALL SURPLUS EXCAVATED MATERIAL SHALL BE REMOVED FROM SITE.
- FOOTPATHS, DRIVEWAYS, ROADWAYS, KERBS, R.O.W.'S OR EXISTING FEATURES DISTURBED, BROKEN OR AFFECTED BY THE WORKS ARE TO BE REINSTATED TO THE COMPLETE SATISFACTION OF THE CITY ENGINEER OR HIS REPRESENTATIVE.
- ALL CONCRETE TO BE SAW CUT AND BROKEN OUT TO THE NEAREST JOINT
- 22. ALL NATURE STRIPS AND LAWN AREAS OUTSIDE PRIVATE PROPERTY TO BE REINSTATED WITH TOP SOIL AND SEEDED.
- 23. CONTRACTOR TO CONTACT LOCAL COUNCIL ENGINEERING DEPARTMENT AT LEAST 48 HOURS PRIOR TO THE COMMENCEMENT OF CONSTRUCTION OF OUTFALL DRAINAGE TO ARRANGE FOR COUNCIL SUPERVISION AND INSPECTION IF REQUIRED
- 24. THE CONTRACTOR IS TO VERIFY ALL LOCATIONS AND DEPTH OF SERVICES WITH THE RELEVANT AUTHORITIES FOR THE CONSTRUCTION OF DRAINS AND SERVICES OUTSIDE THE PROPERTY BOUNDARY PRIOR TO THE COMMENCEMENT OF WORK AND SHALL BE FULLY RESPONSIBLE FOR RECTIFICATION OF ANY DAMAGED
- 25. ALL EXCESS TOPSOIL SHALL BE REMOVED OFF SITE AT THE CONTRACTOR'S EXPENSE.
- ALL ADDITIONAL FILL MATERIAL REQUIRED DUE TO OVER EXCAVATION OR A SHORTFALL OF SUITABLE EXCAVATED MATERIAL SHALL BE IMPORTED AT THE CONTRACTORS EXPENSE.
- AT THE TIME OF THE PREPARATION OF THE DRAINAGE DESIGN, IF THE LANDSCAPING DESIGN WAS NOT SUPPLIED TO THIS OFFICE, THEN THE DRAINAGE SYSTEM MAY BE SUBJECT TO CHANGE. THIS OFFICE OR A QUALIFIED PRACTITIONER SHALL REVIEW THE DRAINAGE DESIGN WHEN LANDSCAPING DESIGN IS FINALISED.

DRAINAGE NOTES:

- ALL SURFACE DRAINAGE WORKS SHALL BE INSTALLED IN ACCORDANCE WITH CLAUSE 5.6.3 DRAINAGE REQUIREMENTS OF AS 2870-2011, WHEREIN FOR BUILDINGS ON MODERATELY, HIGHLY AND REACTIVE SITES:
- SURFACE DRAINAGE SHALL BE CONTROLLED THROUGHOUT CONSTRUCTION AND BE COMPLETED BY THE FINISH OF CONSTRUCTION.
- THE BASE OF TRENCHES SHALL SLOPE AWAY FROM THE BUILDING.
- WHERE PIPES PASS UNDER THE FOOTING SYSTEMS, CLAY PLUGS ARE ADOPTED TO PREVENT THE INGRESS OF WATER.
- FOR BUILDINGS ON HIGHLY AND REACTIVE SITES, DRAINER SHALL PROVIDE DRAINAGE ARTICULATION TO ALL STORMWATER, SANITARY PLUMBING DRAINS AND DISCHARGE PIPES IN ACCORDANCE WITH CLAUSE 5.6.4 PLUMBING REQUIREMENTS, WHEREIN FLEXIBLE JOINTS IMMEDIATELY OUTSIDE BUILDING AND COMMENCING WITHIN 1m OF THE BUILDING PERIMETER ARE REQUIRED TO ACCOMMODATE THE REQUIRED DIFFERENTIAL MOVEMENT BASE ON THE SOIL CLASSIFICATION, REFER TABLE 'MIN. REQUIREMENTS FOR EXPANSION AND ALLOWABLE IN FITTINGS
- SURFACE WATER MUST BE DIVERTED AWAY FROM THE DWELLING AND GRADED AWAY FROM ALL FOUNDATIONS TO GIVE A SLOPE OF NOT LESS THAN 50mm OVER THE FIRST 1000mm FROM THE DWELLING.
- SUBSURFACE DRAINS TO REMOVE GROUND OR TABLE WATER SHALL BE DETAILED BY THE DESIGN ENGINEER. FURTHERMORE, DAMP-PROOF MEMBRANE IN ACCORDANCE WITH 5.3.3 SHALL BE INSTALLED FOR GROUNDWATER OR AGGRESSIVE SOILS.
- DRAINAGE DESIGN IS IN ACCORDANCE WITH AS3500.

MATERIALS

- 1. PROPOSED 100 & 150 Ø STORMWATER DRAINS SHALL BE FORMED OF UNPLASTICISED POLYVINYL CHLORIDE PIPES AND FITTINGS CLASS SH (SEWER CLASS) MANUFACTURED TO CONFORM TO AS.1260.
- PROPOSED 225 DIAMETER AND LARGER STORMWATER DRAINS SHALL BE FORMED OF FIBRE REINFORCED CONCRETE CLASS 2, RUBBER RING JOINTED PIPE MANUFACTURED TO CONFORM TO AS 4058. (CLASS 3 WHERE INDICATED). USE UPVC TO AS1260. (CLASS SH) WHERE SHOWN ON THE

SERVICE

- PRIOR TO THE COMMENCEMENT OF WORK THE CONTRACTOR SHALL LOCATE EXISTING SERVICES TO BE RETAINED WHERE PROPOSED SERVICES CROSS THEM. AND ASCERTAIN FOR HIMSELF THAT NO CLASHES OF SERVICES WILL OCCUR
- WHERE PROPOSED SERVICES TRAVERSE EXISTING ASPHALT AND CONCRETE PAVEMENTS THE PAVEMENT IS TO BE SAW CUT TO FULL DEPTH OF PAVEMENT PRIOR TO EXCAVATION
- TRENCHES TRAVERSING EXISTING OR PROPOSED PAVEMENTS INCLUDING ASPHALT AND CONCRETE SHALL BE BACKFILLED WITH CLASS 2 FINE CRUSHED ROCK AND COMPACTED ALL TO THE SATISFACTION OF THE SUPERINTENDENT
- THE CONTRACTOR SHALL CO-ORDINATE THE LAYING OF ALL SERVICES TO AVOID CLASHES
- LAY ALL SERVICES TO NOMINATED LEVELS WHERE GIVEN, OTHER SERVICES SHALL BE LAID TO COMPLY WITH MINIMUM COVER REQUIREMENTS
- DIFFERENT PARALLEL SERVICES THAT ARE IN CLOSE PROXIMITY TO EACH OTHER MAY BE LAID IN A COMMON TRENCH, SUBJECT TO THE APPROVAL OF THE RELEVANT AUTHORITY AND THE SUPERINTENDENT.

SITE DRAINAGE REQUIREMENTS - CONSTRUCTION STAGE:


THE GEOTECHNICAL REPORT HAS RECOMMENDED THE USE OF A CERTAIN FOOTING THAT IS APPROPRIATE FOR THIS SITE. WHILE MAKING THIS RECOMMENDATION IT HAS BEEN ASSUMED THAT CERTAIN SITE DRAINAGE REQUIREMENTS AS PER AS2870-2011 & BCA HAS BEEN MET. DURING THE CONSTRUCTION OF THE FOOTING THE FOLLOWING SITE DRAINAGE REQUIREMENTS ARE LISTED AS BEING PART OF THE FINAL FOOTING DESIGN BY INTRAX CONSULTING ENGINEERS.


- MUST PREVENT WATER PONDING AGAINST OR NEAR THE FOOTING
- THE GROUND IN THE IMMEDIATE VICINITY OF THE PERIMETER FOOTING SHALL BE GRADED TO A FALL OF 50mm MIN. AWAY FROM THE FOOTING OVER A DISTANCE OF 1000mm (1:20) AND SHAPED TO PREVENT PONDING OF WATER (THIS INCLUDES THE GROUND UPHILL FROM THE FOOTING ON A CUT/FILL SITE) - WHERE FILLING IS PLACED ADJACENT TO THE BUILDING, THE FILLING SHALL BE COMPACTED AND GRADED TO ENSURE DRAINAGE OR WATER AWAY FROM THE BUILDING

- ALL COLLECTED STORMWATER MUST BE DISCHARGED TO A LPOD
- SURFACE DRAINAGE OF THE SITE SHALL BE CONTROLLED FROM THE START OF THE SITE PREPARATION AND CONSTRUCTION; SURFACE DRAINAGE INCLUDES SURFACE WATER RUN-OFF AND BUILDING WATER (ROOF/FLOOR/CONCRETE) RUN-OFF:
 - -ALL WATER RUN-OFF SHALL BE CONTROLLED AT ALL TIMES - USE TEMPORARY DOWNPIPES TO COLLECT WATER FROM THE ROOFED BUILDING FRAME
 - WHEN SILT PITS ARE USED TO GATHER SURFACE WATER FROM AREAS ADJACENT TO THE FOOTINGS, THESE SILT PITS ARE TO BE AT LEAST 1000mm AWAY FROM THE FOOTING AND CONNECTED TO THE STORMWATER SYSTEM WITH SOLID PIPE;
 - STORMWATER DRAINS SHALL BE AT LEAST 90mm AND HAVE A MINIMUM FALL OF 1:100 AND 100mm COVER UNDER THE SOIL AND/OR PAVED AREAS:
 - INSPECTION OPENINGS SHOULD BE PROVIDED AT EACH PIPE CONNECTION POINT AND AT A NOMINAL SPACING OF 25m
 - AVOID UNDERMINING THE FOOTING WITH ANY TRENCHES OR PIPE OR PITS UNLESS THE FOOTING HAS BEEN DESIGNED TO ALLOW FOR SUCH
- SUB-SURFACE DRAINAGE IS REQUIRED TO REMOVE ANY UNWANTED GROUND WATER BY MEANS 90mm SLOTTED PIPE IN A 300mm WIDE TRENCH (MIN. FALL OF 1:100), BASE OF THE TRENCH IS FILLED WITH 10mm CRUSHED ROCK OR SIMILAR COVERING THE SLOTTED PIPE - AG DRAINS MUST BE INSTALLED AT THE BASE OF ALL SITE CUTS THAT
- EXCEED 400mm IN HEIGHT, ALONG THE HIGH SIDE OF A SLOPING SITE AND POSSIBLY ALONG THE LOW SIDE OF A SLOPING SITE ALONG THE BOUNDARY. TO BE CONNECTED TO STORMWATER SYSTEM VIA A SILT PIT - AG DRAINS TO BE LAID APPROX. 200mm INTO UNDISTURBED CLAY OR COMPACTED CLAY
- AC CONDENSERS, HW OVERFLOW, WATER TANKS AND ADJOINING PROPERTIES ARE ALL POTENTIAL SOURCES OF UNWANTED WATER. THIS WATER MUST BE CONTROLLED AND DIRECTED TO THE LPOD. POSSIBLE WATER IMPACTING THE SITE FROM AN ADJOINING PROPERTY ESPECIALLY IF THERE IS A FOOTING ON OR NEAR A BOUNDARY MUST BE ADDRESSED. LOCALISED FOOTING STRENGTHENING IS TO BE CONSIDERED DURING CONSTRUCTION ILO DRAINAGE THAT MAY JEOPARDISE THE
- GRATED DRAINS MAY BE UTILISED IN A PAVED AREA (E.G. DRIVERWAY/GARAGE INTERFACE) WHERE THE PAVING NECESSARILY SLOPES TOWARDS THE HOUSE OR GARAGE. SPOON DRAINS MAY ALSO BE USED IN CONJUNCTION WITH A PAVED SURFACE.
- THE GROUND BENEATH A TIMBER DECK MUST BE GRADED SO THAT THE AREA BENEATH THE DECK IS ABOVE THE ADJACENT FINISHED GROUND LEVEL TO PREVENT PONDING.
- ALL TRENCHES MUST BE DUG AT A SIMILAR GRADE AS THE PIPES THE TRENCHES HOUSE.
 - ALL TRENCHES MUST GENERALLY SLOPE AWAY FROM THE FOOTINGS - TRENCHES MUST BE 'CLAY PLUGGED' OR CONCRETED WHEN PASSING PERPENDICULARLY UNDER ANY PART OF THE FOOTING AND ON ANY
 - SLOTTED PIPE SIDE OF A CONNECTION PIT - ALL TRENCHES WITHIN 1500mm OF ANY FOOTING MUST BE EFFECTIVELY SEALED FROM SURFACE WATER, WITH AT LEAST THE TOP 300mm OF THE TRENCH FILLED WITH LOCAL CLAY COMPACTED TO AN IMPERMEABLE TOP LAYER. APPROVED MOISTURE BARRIER USE WITH TRENCHES IS AN
 - OPTION - CONCRETE PAVING IS ADVISED OVER ANY TRENCHES WITHIN 1000mm OF ANY FOOTING.
- FLEXIBLE PLUMBING JOINTS ARE REQUIRED FOR H1/H2/E/P SITES TO ALLOW FOR EXPECTED VERTICAL GROUND MOVEMENTS (REFER GEOTECHNICAL REPORT). THE JOINTS MUST BE SET AT THE MIDWAY POINT WHEN INSTALLED & MUST ALSO INCORPORATE SWIVEL JOINTS IN
 - DRAINS EMERGING FROM UNDER THE FOOTING REQUIRE THE FLEXIBLE JOINT TO BE WITHIN 1000mm OF THE OUTSIDE OF THE PERIMETER FOOTING - INSTALLATION, LOCATION AND NUMBER OF JOINTS TO COMPLY WITH MANUFACTURER'S SPECS
- PLUMBING PENETRATING THE FOOTING MUST BE AVOIDED WHERE PRACTICABLE, IF UNAVOIDABLE THEN THE PIPE MUST PASS THROUGH THE MIDDLE THIRD OF THE FOOTING DEPTH AND LAGGING TO THE PIPE PROVIDED

MAINTENANCE:

- THE MAINTENANCE OF THE SITE AROUND A NEW HOME IS AN IMPORTANT FACTOR IN THE LONG-TERM PERFORMANCE OF THE FOOTING SYSTEM
- THE PRIMARY OR IECTIVE OF THIS MAINTENANCE IS TO MINIMIZE THE VARIATION IN SOIL MOISTURE LEVELS AROUND THE FOOTING THAT COULD LEAD THE EXCESSIVE SOIL MOVEMENT AND POSSIBLE DISTRESS OF THE SUPERSTRUCTURE AND/OR FOOTING. WHEN THE SLAB FORMS PART OF THE TERMITE BARRIER SYSTEM FOR THE HOUSE, THEN IT IS ALSO NECESSARY TO MAINTAIN THE EFFECTIVENESS OF THAT BARRIER WITH APPROPRIATE MAINTENANCE **ACTIVITIES**
- WHEN A CONCRETE SLAB-ON-GROUND IS USED AS PART OF THE TERMITE BARRIER SYSTEM AS OUTLINES IN AS3660.0, THEN IT CANNOT BE TOO HIGHLY STRESSED THAT REGULAR INSPECTION AND MAINTENANCE OF THE SLAB SURROUNDING BY A COMPETENT PROFESSIONAL IS REQUIRED TO ENSURE THAT ANY TERMITE INFESTATION IS DETECTED AND TREATED PROMPTLY.
- ONGOING MAINTENANCE AND INSPECTION ON A REGULAR BASIS IS A REQUIREMENT OF AS3660.1 AND OWNER SHOULD BE CLEARLY ADVISED IF THEIR RESPONSIBILITIES TO ENSURE THAT THEIR INVESTMENT IS PROPERLY PROTECTED.
- LEAKING TAPS, DOWNPIPES, SEWERS, GUTTERS AND DRAINAGE CAN ALSO AFFECT THE MOISTURE CONTENT OF THE SOIL AND THESE MUST BE INSPECTED REGULARLY TO ENSURE AGAINST DAMAGE TO THE FOOTINGS. SIMILARLY, GUTTERS, DOWNPIPE AND COLLECTION POINTS CAN GET BLOCKED WITH LEAVES AND OTHER DEBRIS, PREVENTING THE EFFECTIVE DRAINAGE OF STORMWATER AWAY FROM THE HOUSE. AGAIN, REGULAR INSPECTIONS AND MAINTENANCE SHOULD BE CARRIED OUT TO PREVENT BLOCKAGES.
- IT IS IMPORTANT FOR BUILDER TO MAKE THE HOMEOWNER AWARE OF THE MAINTENANCE ISSUES ASSOCIATED WITH ENSURING THE LONG-TERM PERFORMANCE OF THE FOOTING SYSTEM.

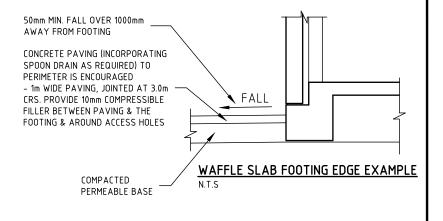

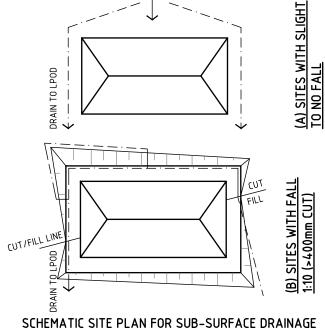

SCHEMATIC SITE PLAN FOR SUB-SURFACE DRAINAGE

CONSTRUCTION ISSUE	29.07.21	R.Y.
REMARK/COMMENT	DATE:	APPR.



Intrax Consulting Group VIC | NSW | SA | QLD | W.


PROPOSED RESIDENCE - 720385 LOT 7 NO. 45 WARRIEWOOD ROAD WARRIEWOOD


CLIENT **METRICON HOMES PTY LTD - NSW**

CONSTRUCTION ISSUE DRAWING

GENERAL NOTES REV ENGINEER: F.S DRAWN:Z.X. SHEET NO. NO. OF SHEETS 159253 01 S22 28


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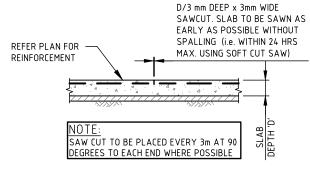
TYPICAL CONCRETE DRIVEWAY CROSS-SECTION

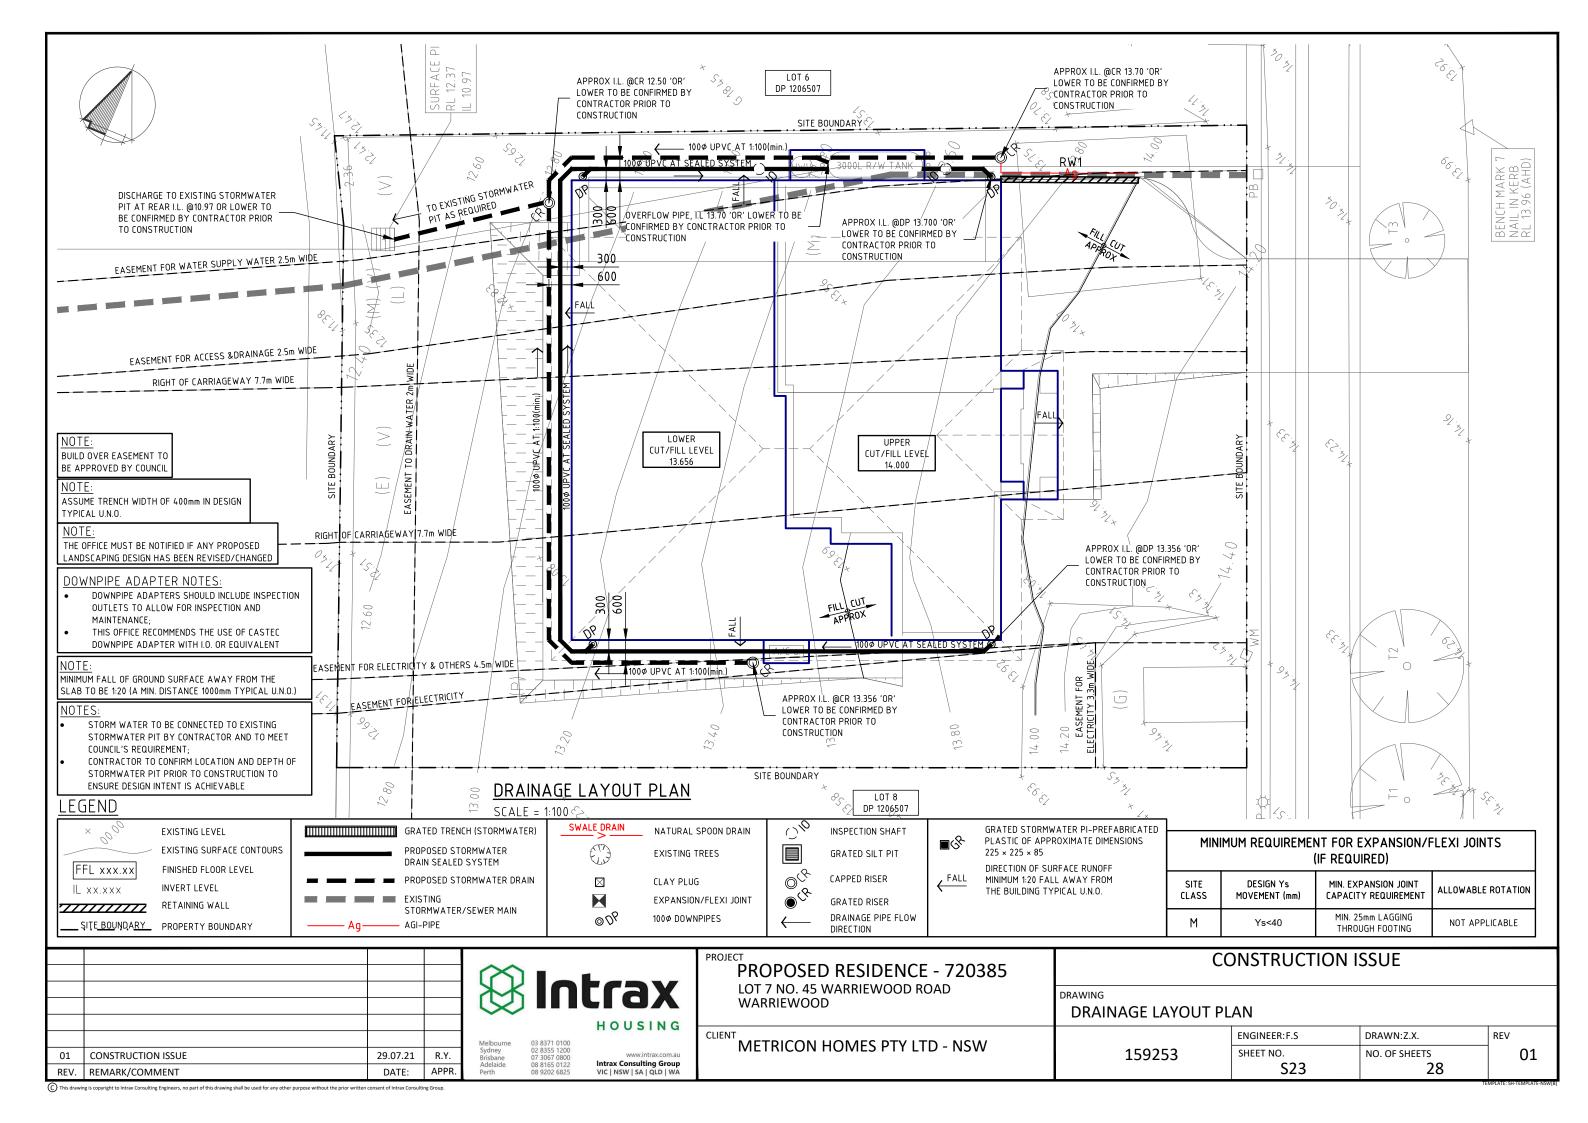NOTE: (DRIVEWAY AT 'V' SHAPED)

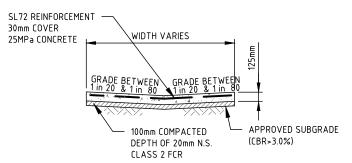


TYPICAL BENCHING DETAIL


- PREVENT "OVERPOUR" OF CONCRETE BY LINING ANY COLLAPSED SIDES OF TRENCHES WITH FIBRE CEMENT SHEETING, FORMPLY, BOARDS OR COMPACTED SOIL BACKFILLING BEHIND VAPOUR BARRIER (OR DAMP-PROOF MEMBRANE) DURING POUR.
- FALL "CUT" BENCHING AWAY FROM THE FOOTING.
- TERMINATE VAPOUR BARRIER (OR DAMP-PROOF MEMBRANE) UNDER DPM OR "CUT" BENCHING.
- PLACE DPM BETWEEN PAVING AND FOOTING.
 MINIMUM EDGE EXPOSURE (E) OF 70mm MAY BE REQUIRED FOR TERMITE PROTECTION TO COMPLY WITH AS3660.1 AND IS REQUIRED ON "E" CLASS SITES TO COMPLY WITH THE SOUTH AUSTRALIA HOUSING CODE (THE GREATER THE EXPOSURE HOWEVER, THE GREATER THE OPPORTUNITY TO DRY OUT FROM THE OUTSIDE FACE).
- THE DPM (VISCOUS DAMP PROOF MEMBRANE AS USED BY BRICKLAYERS) SHOULD SIT ON THE 'CUT' BENCH LEVEL FOR A MINIMUM OF 75mm. IT SHOULD THEN EXTEND UP THE FACE OF THE FOOTING TO END AT THE TOP OF THE PAVEMENT.

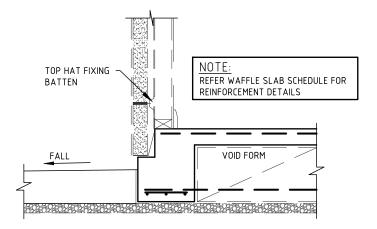

TYPICAL SAWCUT DETAIL

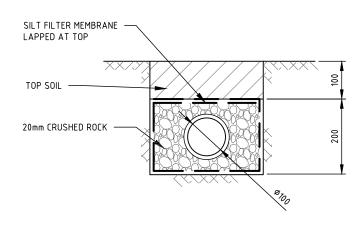

TYPICAL A.G. PIPE DETAIL

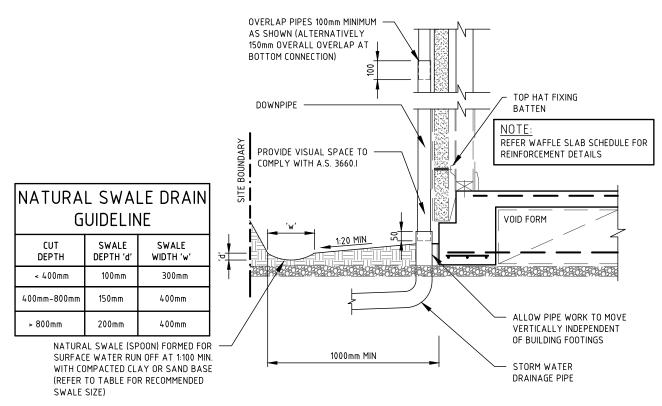

TYPICAL DOWNPIPE & SWALE DRAIN DETAIL (IF REQUIRED)

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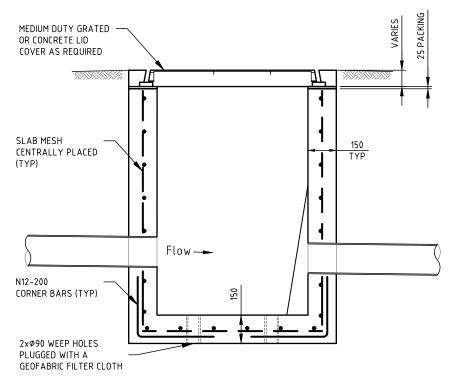
HOUSING


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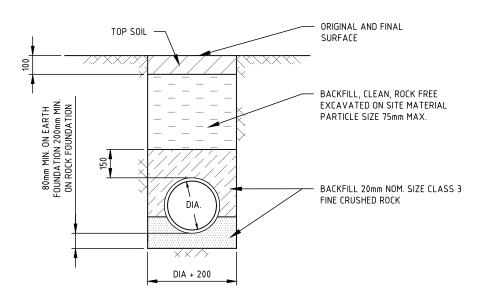
PROPOSED RESIDENCE - 720385 LOT 7 NO. 45 WARRIEWOOD ROAD WARRIEWOOD

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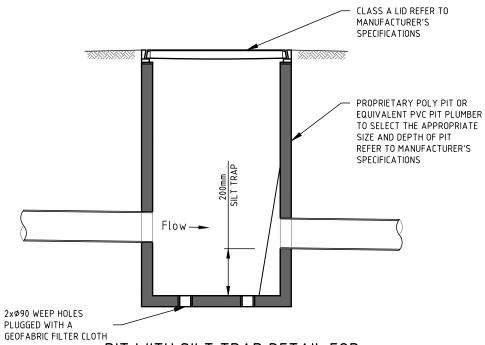
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DRAINAGE DETAILS - S	HEET 1		
	ENGINEER: F.S	DRAWN: Z.X.	REV
159253	SHEET NO. \$24	NO. OF SHEETS 28	01





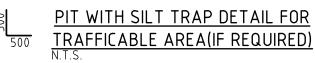


TRENCH CONDITIONS FOR DRAINAGE PIPE
INSTALLATION (NOT UNDER PAVEMENTS)
SCALE = 1:20



PIT WITH SILT TRAP DETAIL FOR

NON-TRAFFICABLE AREA(IF REQUIRED)

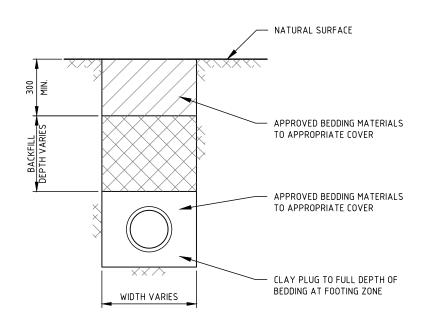

TYPICAL CLAY PLUG DETAIL

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CONSTRUCTION ISSUE


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DRAINAGE DETAILS - SHEET 2

ENGINEER: F. S DRAWN: Z.X. REV


159253 | ENGINEER: F.S | DRAWN: Z.X. | REV | SHEET NO. | NO. OF SHEETS | O1 | S25 | 28 |

MINIMUM REQUIREMENTS FOR SEWER ARTICULATION									
SITE CLASS	DESIGN Ys MOVEMENT (mm)	SEWER EXIT POINTS & ORG							
	DESIGN YS MOVEMENT (MM)	SWIVEL	EXPANDER						
М	Ys<40	0	0						

NOTE: EXPANDER REQUIRED ON ALL RISERS FOR (CLASS E, Ys >75mm OR EQUIVALENT SITES

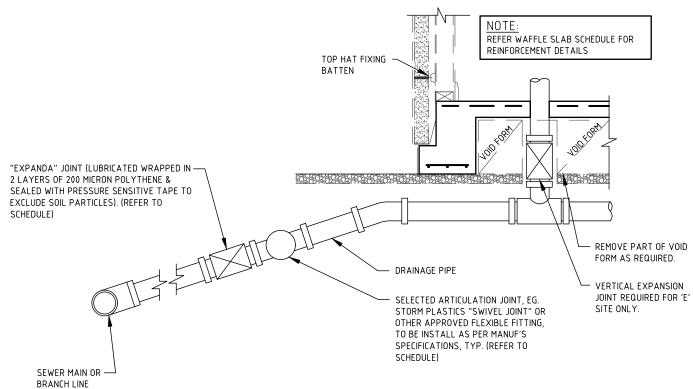

TYPICAL UNDER WAFFLE SLAB PIPE DETAIL SCALE = 1:20

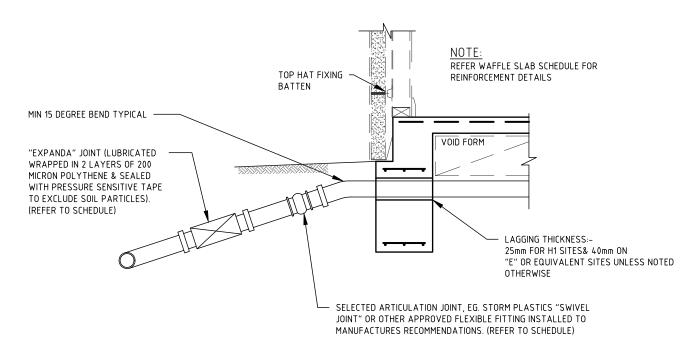

TYPICAL PIPE THROUGH FOOTING DETAIL - SECTION SCALE = 1:20

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LOT 7 NO. 45 WARRIEWOOD ROAD
WARRIEWOOD

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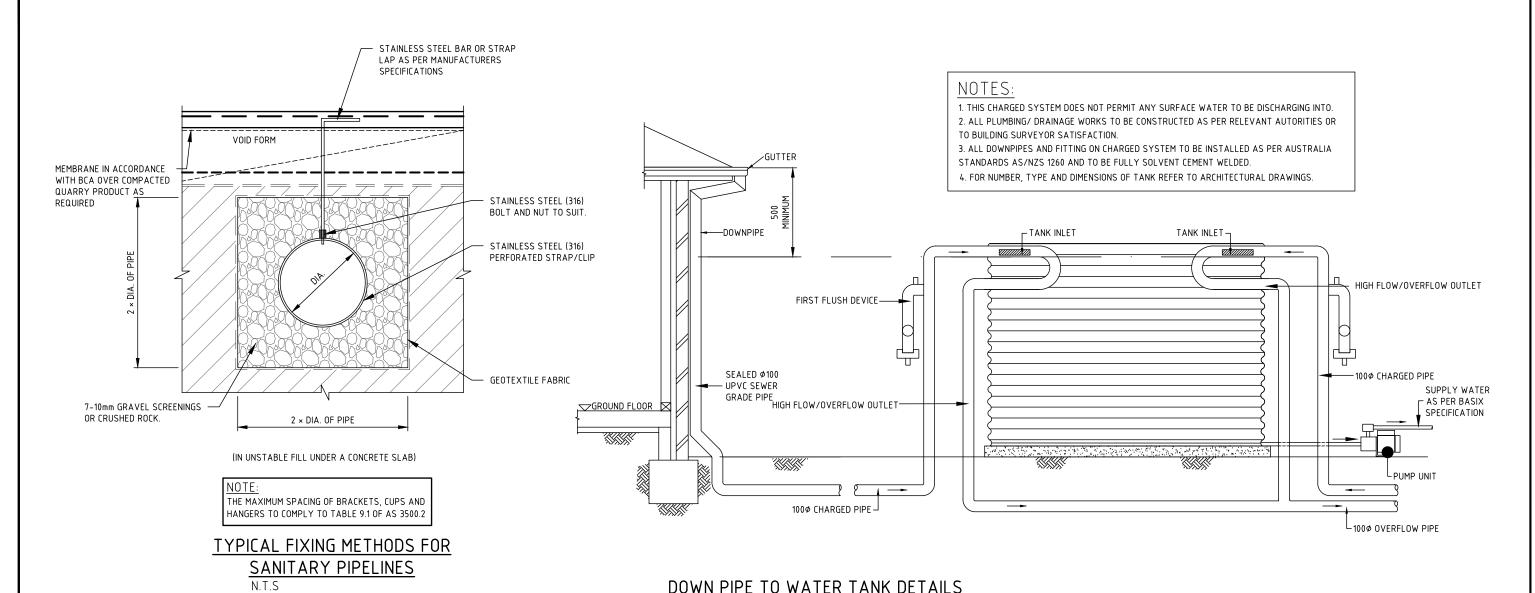
CONSTRUCTION ISSUE

DRAWING
DRAINAGE DETAILS - SHEET 3

ENGINEER: F.S DRAWN: Z.X. REV
SHEET NO. NO. OF SHEETS
S26 28

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DOWN PIPE TO WATER TANK DETAILS

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				Melbourne	03 8371 0100	HOUSING	METRICON HOMES PTY LTD - NSW		ENGINEER: F.S	DRAWN:Z.X.	REV
01	CONSTRUCTION ISSUE	29.07.21	R.Y.	Sydney Brisbane	02 8355 1200 07 3067 0800	www.intrax.com.au Intrax Consulting Group	INIETRICON HOIVIES PTY LTD - NSVV	159253	SHEET NO.	NO. OF SHEETS	01
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PROPOSED DEVELOPMENT LOT 7 NO. 45 WARRIEWOOD ROAD, WARRIEWOOD

GENERAL DRAINAGE NOTES

- 1. THE CONTRACTOR SHALL ADEQUATELY DRAIN THE SITE DURING ALL STAGES OF CONSTRUCTION.
- 2. CONTRACTOR SHALL VERIFY ALL LEVELS DIMENSIONS AND SERVICES EXISTING AND REPORT ANY DISCREPANCIES TO BUILDER WITHIN 5 DAYS OF MOBILISATION TO SITE.
- 3. ALL APPROPRIATE PERMITS SHALL BE OBTAINED AND FEES PAID FOR BY THE CONTRACTOR.
- 4. ANY PAVEMENT OR FEATURES DAMAGED DURING THE COURSE OF THIS CONTRACT SHALL BE REINSTATED TO THEIR FORMER CONDITION.
- 5. THE CONTRACTOR SHALL ARRANGE A SITE INSPECTION WITH THE CIVIL ENGINEERING SUPERVISING OFFICER PRIOR TO THE COMMENCEMENT OF WORK TO RECORD ANY DAMAGE TO EXISTING FEATURES.
- 6. ALL EXISTING PIT COVERS, DOWNPIPE CONNECTIONS AND SIMILAR FEATURES IN CONSTRUCTION AREAS ARE TO BE ADJUSTED TO SUIT.
- 7. ALL CONCRETE PAVEMENT SHALL BE FINISHED WITH A NON SKID FLOAT, (NO BROOMED FINISH).
- 8. BEFORE COMMENCEMENT OF WORK A TEMPORARY BENCH MARK IS TO BE ESTABLISHED BY THE CONTRACTOR IN A POSITION ON SITE SAFE FROM DISTURBANCE.
- 9. ANY SHORTFALL IN INDIGENOUS TOPSOIL REQUIRED TO BRING THE GARDEN AND GRASSED AREAS TO THE DESIGN LEVELS SHALL BE MADE UP WITH APPROVED IMPORTED TOPSOIL. NO ADDITIONAL PAYMENT WILL BE MADE FOR IMPORTED TOPSOIL.
- 10. EXCAVATED MATERIAL SHALL BE STOCKPILED ON SITE AS DIRECTED BY THE SUPERINTENDENT. EXCESS TO BE REMOVED FROM SITE AT CONTRACTORS EXPENSE.
- 11. TOPSOIL TO BE STRIPPED TO A DEPTH OF 150mm UNDER FILL AREAS AND ALL OTHER AREAS. THIS TOPSOIL SHALL BE STOCKPILED ON SITE AS DIRECTED BY SUPERINTENDENT. EXCESS SOIL SHALL BE REMOVED FROM THE SITE AT THE CONTRACTORS EXPENSE.
- 12. ALL STORMWATER DRAINS SHALL BE BEDDED ON A MINIMUM OF 80mm COMPACTED THICKNESS 20 N.S. CLASS 3 FINE CRUSHED ROCK, IN SOIL BASED TRENCHES. INCREASE TO 200mm THICKNESS IN ROCK BASED TRENCHES.
- 13. 100mm AND 150mm DIAMETER STORMWATER DRAINS SHALL BE LAID AT A MINIMUM GRADE OF 1:100, UNLESS OTHERWISE SHOWN.
- 14. FOOTPATHS, DRIVEWAYS, ROADWAYS, KERBS, R.O.W.'S OR EXISTING FEATURES DISTURBED, BROKEN OR AFFECTED BY THE WORKS ARE TO BE REINSTATED TO THE COMPLETE SATISFACTION OF THE CITY ENGINEER OR HIS REPRESENTATIVE.
- 15. ALL CONCRETE TO BE SAW CUT AND BROKEN OUT TO THE NEAREST JOINT.
 16. ALL NATURE STRIPS AND LAWN AREAS OUTSIDE PRIVATE PROPERTY TO BE
- REINSTATED WITH TOP SOIL AND SEEDED.

 17. CONTRACTOR TO CONTACT LOCAL COUNCIL ENGINEERING DEPARTMENT AT LEAST

 48 HOURS PRIOR TO THE COMMENCEMENT OF CONSTRUCTION OF OUTFALL

 DRAINAGE TO ARRANGE FOR COUNCIL SUPERVISION AND INSPECTION IF REQUIRED
- BY COUNCIL.

 18. THE CONTRACTOR IS TO VERIFY ALL LOCATIONS AND DEPTH OF SERVICES WITH THE RELEVANT AUTHORITIES FOR THE CONSTRUCTION OF DRAINS AND SERVICES OUTSIDE THE PROPERTY BOUNDARY PRIOR TO THE COMMENCEMENT OF WORK, AND SHALL BE FULLY RESPONSIBLE FOR RECTIFICATION OF ANY DAMAGED
- SERVICE.

 19. ALL ADDITIONAL FILL MATERIAL REQUIRED DUE TO OVER EXCAVATION OR A SHORTFALL OF SUITABLE EXCAVATED MATERIAL SHALL BE IMPORTED AT THE CONTRACTORS EXPENSE.

AND ALLOWABLE IN FITTINGS									
SITE CLASS	MIN. REQUIRED EXPANSION JOINT CAPACITY	ALLOWABLE ROTATION							
Έ′	150mm	15°							
'H'	70mm	15°							
'P'	70mm PLUS ADDITIONAL REQUIREMENTS IN THE CASE OF FILL (MIN. DEPENDENT ON SITE CONDITION)	15°							
'M'	MIN. 25mm LAGGING THROUGH FOOTINGS	NOT APPLICABLE							

THE CONTRACTOR TO REFER SOIL CLASSIFICATION REPORT TO DETERMINE THE TYPE OF EXPANSION JOINT TO BE USED

DRAINAGE NOTES:

- 1.ALL SURFACE DRAINAGE WORKS SHALL BE INSTALLED IN ACCORDANCE WITH CLAUSE 5.6.3 DRAINAGE REQUIREMENTS OF AS 2870-2011, WHEREIN FOR BUILDINGS ON MODERATELY, HIGHLY AND REACTIVE SITES:
 - •SURFACE DRAINAGE SHALL BE CONTROLLED THROUGHOUT CONSTRUCTION AND BE COMPLETED BY THE FINISH OF CONSTRUCTION.
 - •WHERE PIPES PASS UNDER THE FOOTING SYSTEMS, CLAY PLUGS ARE ADOPTED TO PREVENT THE INGRESS OF WATER.

2.FOR BUILDINGS ON HIGHLY AND REACTIVE SITES, DRAINER SHALL PROVIDE DRAINAGE ARTICULATION TO ALL STORMWATER, SANITARY PLUMBING DRAINS AND DISCHARGE PIPES IN ACCORDANCE WITH CLAUSE 5.6.4 PLUMBING REQUIREMENTS, WHEREIN FLEXIBLE JOINTS IMMEDIATELY OUTSIDE BUILDING AND COMMENCING WITHIN 1m OF THE BUILDING PERIMETER ARE REQUIRED TO ACCOMMODATE THE REQUIRED DIFFERENTIAL MOVEMENT BASE ON THE SOIL CLASSIFICATION, REFER TABLE 'MIN. REQUIREMENTS FOR EXPANSION AND ALLOWABLE IN FITTINGS.

3.DRAINAGE DESIGN IS IN ACCORDANCE WITH AS3500.

MATERIALS

- 1. PROPOSED 100¢ AND 150¢ STORMWATER DRAINS AND FITTINGS SHALL BE UPVC CLASS SN8/10— UNLESS OTHER WISED SPECIFIED ON PLANS.
- PROPOSED 225¢ AND 300¢ STORMWATER DRAINS, USE UPVC CLASS SH TO AS1260, UNLESS OTHERWISE SPECIFIED ON THE PLANS.
- 3. PROPOSED 375¢ OR LARGER STORMWATER DRAINS, USE FRC RRJ JOINT CLASS 4 WHERE COVER EXCEEDS 600mm, UNLESS OTHERWISE SPECIFIED ON THE PLANS.
- 4. PROPOSED 375¢ OR LARGER STORMWATER DRAINS, USE RCP RRJ JOINT CLASS 2 WHERE COVER IS 600mm OR LESS, UNLESS OTHERWISE SPECIFIED ON THE PLANS.
- 5. WHERE CONSTRUCTION LOADS CAN'T BE ACHIEVED, CONCRETE ENCASE THE PIPE OR IMPLEMENT LOW IMPACT CONSTRUCTION METHODS.

 6. IT IS THE CONTRACTORS RESPONSIBILITY TO CHECK PIPE TYPE AND CLASS REQUIREMENTS.
- 6. IT IS THE CONTRACTORS RESPONSIBILITY TO CHECK PIPE TYPE AND CLASS REQUIREMENTS PRIOR TO CONSTRUCTION. IF THERE ARE ANY CONCERNS THEY SHOULD BE RAISED WITH THE DESIGNER PRIOR TO COMMENCEMENT OF CONSTRUCTION.

SERVICE

- WHERE PROPOSED SERVICES TRAVERSE EXISTING ASPHALT AND CONCRETE PAVEMENTS THE PAVEMENT IS TO BE SAW CUT TO FULL DEPTH OF PAVEMENT PRIOR TO EXCAVATION. THE INTERFACE BETWEEN EXISTING KERB AND CHANNEL (TO BE REMOVED) AND EXISTING ASPHALT SHALL BE SAWCUT.
- THE CONTRACTOR SHALL CO-ORDINATE THE LAYING OF ALL SERVICES TO AVOID CLASHES
- 3. LAY ALL SERVICES TO NOMINATED LEVELS WHERE GIVEN, OTHER SERVICES SHALL BE LAID TO COMPLY WITH MINIMUM COVER REQUIREMENTS.
- 4. DIFFERENT PARALLEL SERVICES THAT ARE IN CLOSE PROXIMITY TO EACH OTHER MAY BE LAID IN A COMMON TRENCH, SUBJECT TO THE APPROVAL OF THE RELEVANT AUTHORITY AND THE SUPERINTENDENT.

WARNING

THE BUILDER/CONTRACTOR SHALL PROVE ALL EXISTING SERVICES WITHIN 3 DAYS OF MOBILISATION OR ANY WORKS OCCURRING ON SITE.

THESE PLANS ARE TO BE READ IN CONJUNCTION WITH THE ARCHITECTURAL & LANDSCAPE PLANS FOR EXTERNAL WORKS.

ALL UNDERGROUND & SURFACE DRAINAGE WORKS SHALL BE INSTALLED IN ACCORDANCE WITH CLAUSE 5.6.3 DRAINAGE REQUIREMENTS OF AS 2870-2011 & AS3500.3-2018. SURFACE DRAINAGE SHALL BE CONTROLLED THROUGHOUT CONSTRUCTION AND BE COMPLETED BY THE FINISH OF CONSTRUCTION.

ALL FINISHED SURFACE LEVEL TO BE SLOPED AWAY FROM FINISHED FLOOR LEVE AND DRAIN TOWARDS STORMWATER PITS

ALL INTERNAL DRAINAGE TO BE CONSTRUCTED AS PER AUSTRALIAN STANDARD AS3500.3-2018

STORMWATER PIPE TO BE LAID 800mm CENTERS AWAY FROM EDGE OF SLAB UNLESS SPECIFIED OTHERWISE

PROVIDE 2-N12 BARS × 1200 LONG TOP FOR ALL RE-ENTRY CORNERS OF PITS. (TYPICAL).

- THE GROUND IN THE IMMEDIATE VICINITY OF THE PERIMETER FOOTING SHALL BE GRADED TO A FALL OF 50mm MIN. AWAY FROM THE FOOTING OVER A DISTANCE OF 1000mm (1:20) AND SHAPED TO PREVENT PONDING OF WATER (THIS INCLUDES THE GROUND UPHILL FROM THE FOOTING ON A CUT/FILL SITE) WHERE FILLING IS PLACED ADJACENT TO THE BUILDING, THE FILLING SHALL BE COMPACTED AND GRADED TO ENSURE DRAINAGE OR WATER AWAY FROM THE BUILDING.
- 3. ALL COLLECTED STORMWATER MUST BE DISCHARGED TO THE LPOD.

SITE DRAINAGE REQUIREMENTS - CONSTRUCTION STAGE:

PREVENT WATER PONDING AGAINST OR NEAR ANY EXISTING FOOTING.

- 4. INSTALL SUB-SURFACE DRAINAGE TO AS2439.1 100mm DIAMETER SN8 IN A 300mm WIDE TRENCH (MIN. FALL OF 1:100), BASE OF THE TRENCH IS FILLED WITH 12mm SINGLE SIZE AGGREGATE.
 - AG DRAINS MUST BE INSTALLED AT THE BASE OF ALL SITE CUTS THAT EXCEED 400mm IN HEIGHT, ALONG THE HIGH SIDE OF A SLOPING SITE AND POSSIBLY ALONG THE LOW SIDE OF A SLOPING SITE ALONG THE BOUNDARY. TO BE CONNECTED TO STORMWATER SYSTEM VIA A SILT PIT.

 AG DRAINS TO BE LAID APPROX. 200mm INTO UNDISTURBED CLAY OR
- COMPACTED CLAY.

 TRENCHES MUST BE 'CLAY PLUGGED' OR CONCRETED WHEN PASSING

 PERPENDICULARLY UNDER ANY PART OF THE FOOTING AND ON ANY SLOTTED
- PIPE SIDE OF A CONNECTION PIT

 ALL TRENCHES WITHIN 1500mm OF ANY FOOTING MUST BE EFFECTIVELY SEALED
 FROM SURFACE WATER, WITH AT LEAST THE TOP 300mm OF THE TRENCH FILLED
 WITH LOCAL CLAY COMPACTED TO AN IMPERMEABLE TOP LAYER. APPROVED
 MOISTURE BARRIER USE WITH TRENCHES IS AN OPTION.
- 6. FLEXIBLE PLUMBING JOINTS ARE REQUIRED FOR H1/H2/E/P SITES TO ALLOW FOR EXPECTED VERTICAL GROUND MOVEMENTS (REFER GEOTECHNICAL REPORT). THE JOINTS MUST BE SET AT THE MIDWAY POINT WHEN INSTALLED & MUST ALSO INCORPORATE SWIVEL JOINTS IN THE SYSTEM
 - DRAINS EMERGING FROM UNDER THE FOOTING REQUIRE THE FLEXIBLE JOINT TO BE WITHIN 1000mm OF THE OUTSIDE OF THE PERIMETER FOOTING
 INSTALLATION, LOCATION AND NUMBER OF JOINTS TO COMPLY WITH MANUFACTURER'S SPECS.

FOR INFILTRATION, DISPERSION AND ABSORPTION SYSTEM, THIS OFFICE TO BE NOTIFIED IMMEDIATELY IF SHALLOW ROCK PRESENTED ON SITE DURING TRENCHING AND EXCAVATION

IMPORTANT NOTES:

AT NO TIME IS ANY EXISTING OR PROPOSED FOOTING TO BE UNDERMINED DURING CONSTRUCTION. BUILDER TO ENSURE AND CONFIRM PRIOR TO COMMENCEMENT OF CONSTRUCTION. THIS OFFICE TO BE CONTACTED IF ANY DISCPREPANCY

PROVIDE FLEXI JOINTS AND CLAY PLUGS AS PER AS2870

ALL CONCRETE JOINTS ARE SAWCUT JOINTS
U.N.O. REFER TYPICAL DETAIL AND NOTES

BUILDER TO CONFIRM ALL PIT LEVELS AND COVERS PRIOR TO COMMENCEMENT OF CONSTRUCTION

ALL DOWNPIPES LOCATION ARE PRELIMINARY ONLY.
CONTRACTOR TO REFER LATEST ARCHITECT PLANS FOR
EXACT LOCATION OF ALL DOWNPIPES. CONNECTION TO BE
DONE ACCORDANCE TO PLUMBING STANDARD AS3500

AUTHORITY APPROVAL REQUIRED PRIOR TO COMMENCEMENT OF CONSTRUCTION

ALL HWS AND AC UNIT OVERFLOWS TO BE CONNECTED TO THE PROPOSED STORMWATER DRAINAGE SYSTEM

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Α	FOR CONSTRUCTION	02.08.21	R.J.				
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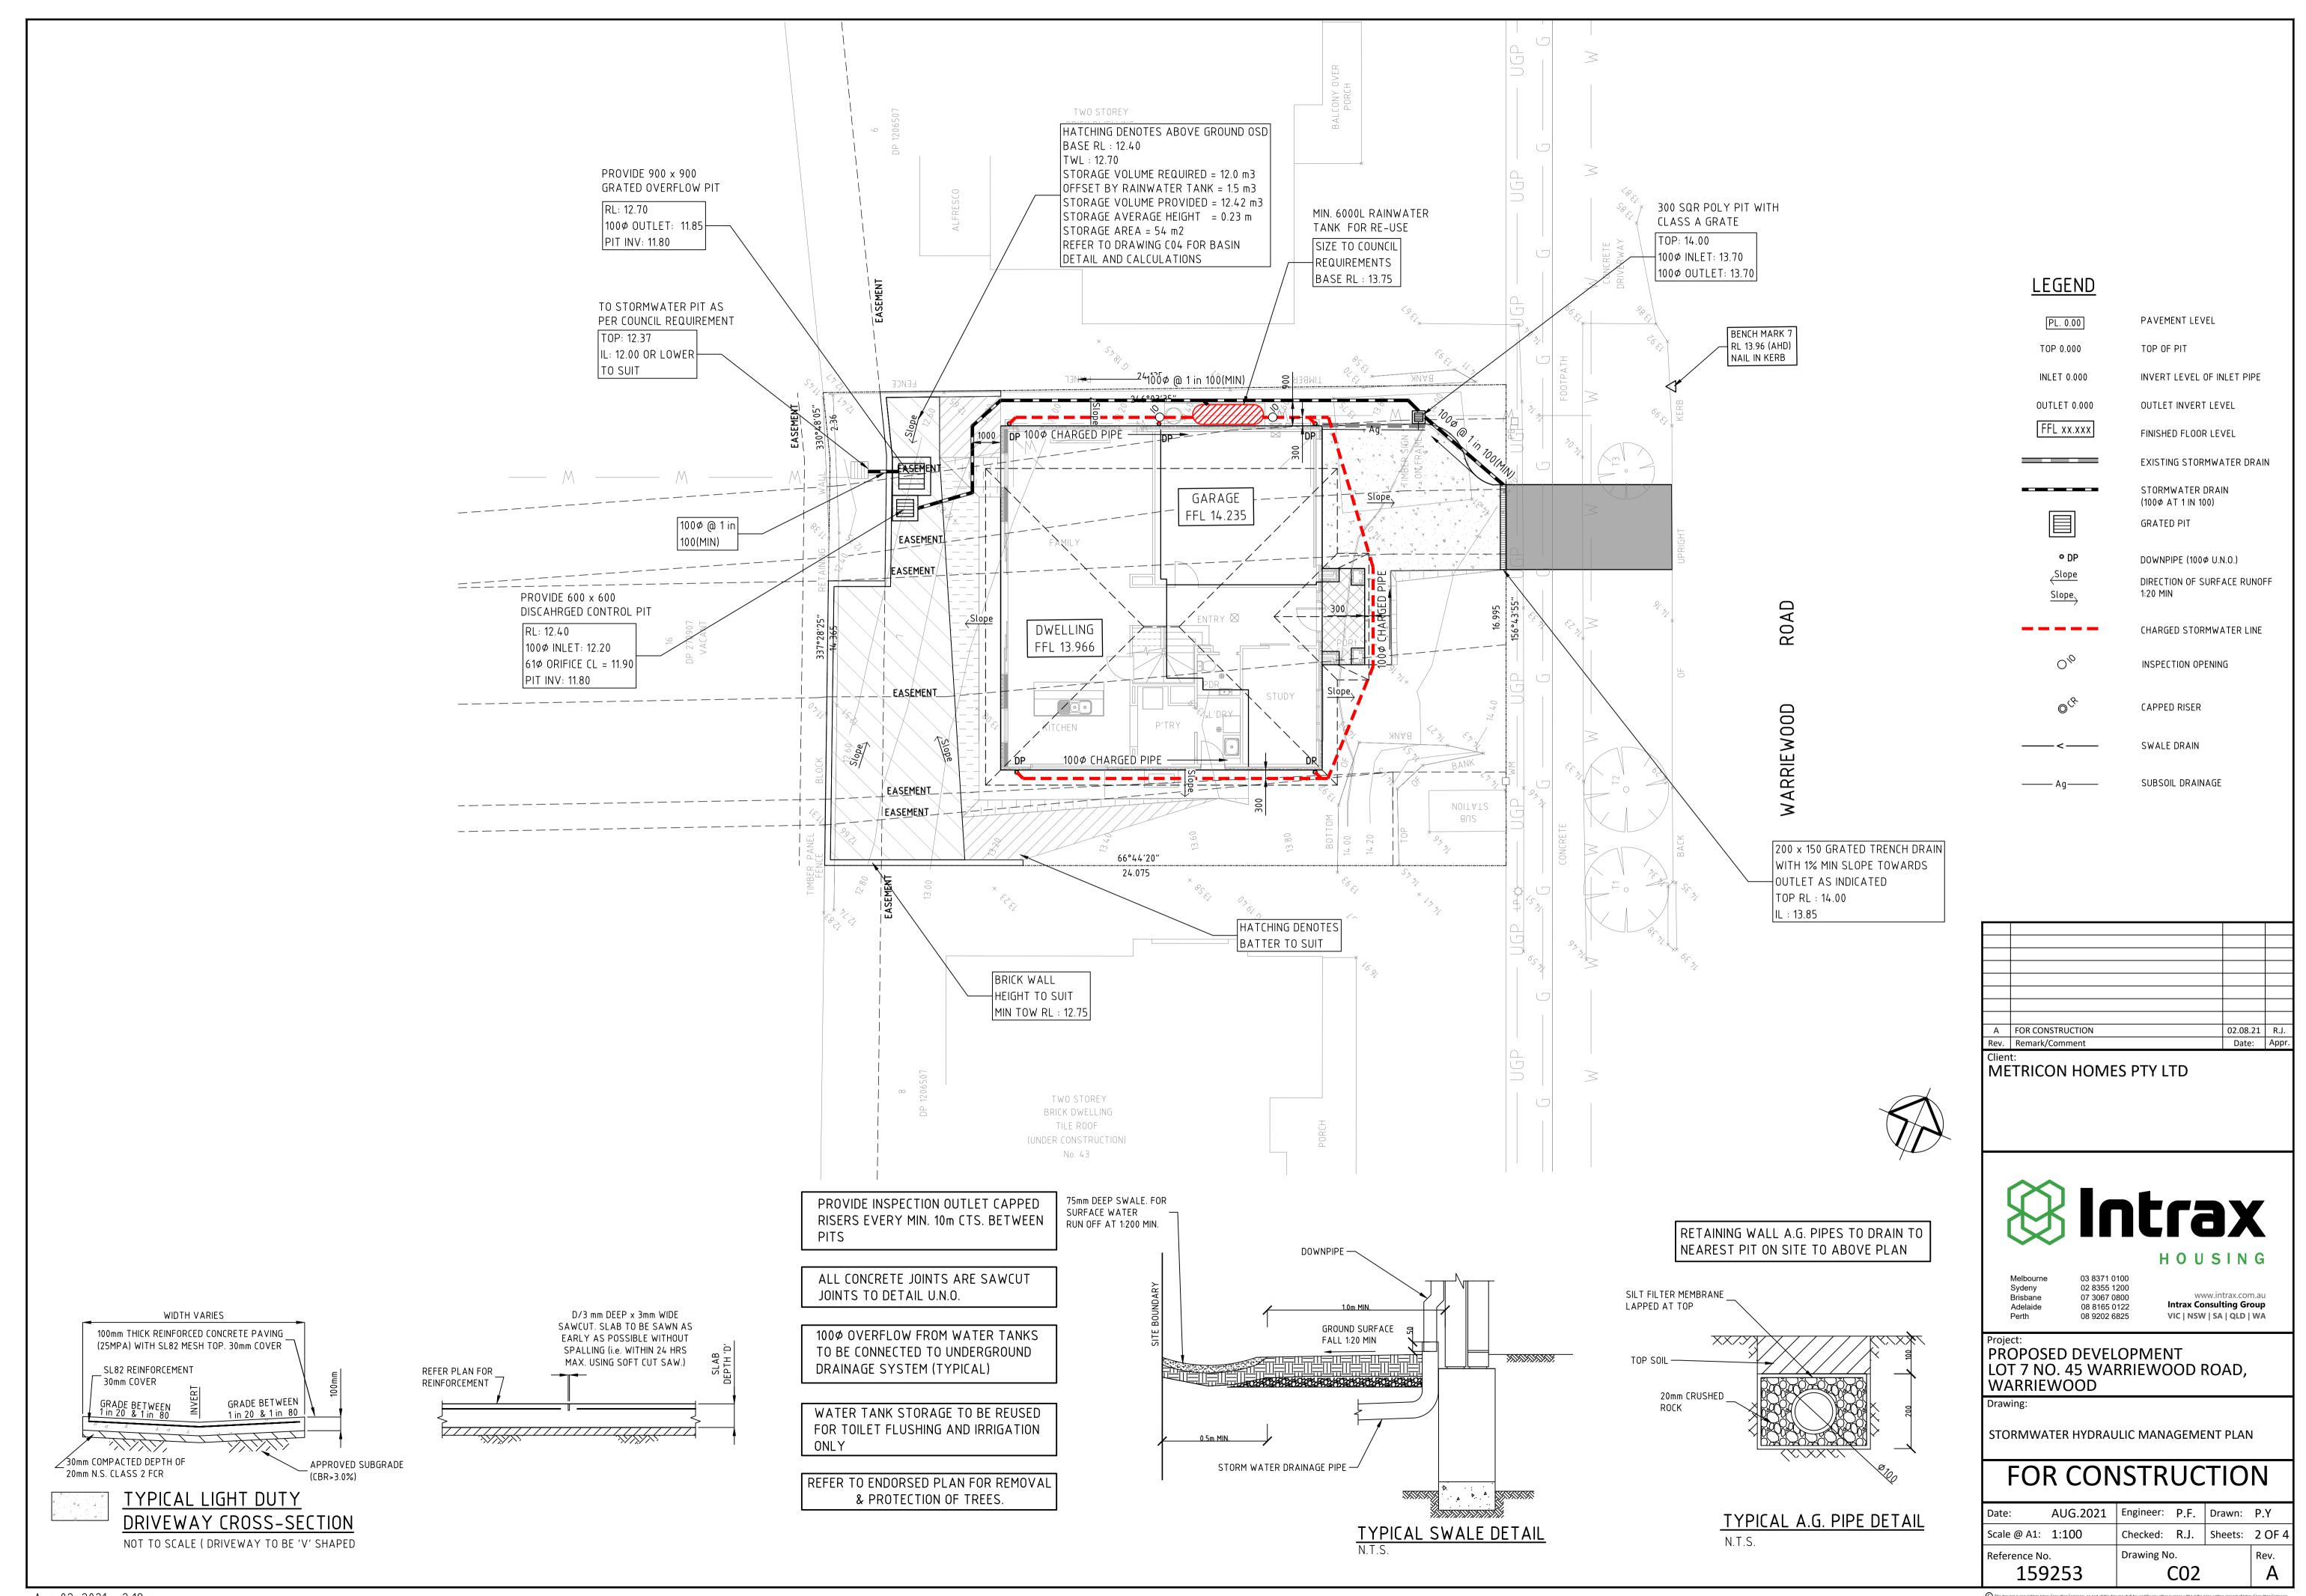
PROPOSED DEVELOPMENT LOT 7 NO. 45 WARRIEWOOD ROAD, WARRIEWOOD


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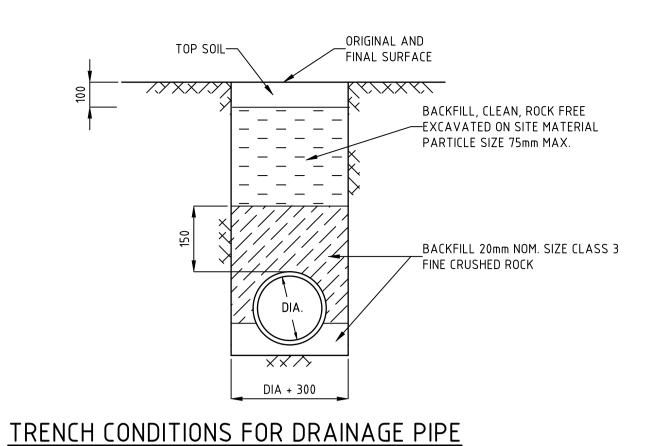
GENERAL NOTES

FOR CONSTRUCTION

Date:	AUG.2021	Engineer:	P.F.	Drawn:	P.Y
Scale @ A1:	N/A	Checked:	R.J.	Sheets:	1 OF 4
Reference No).	Drawing N	Rev.		
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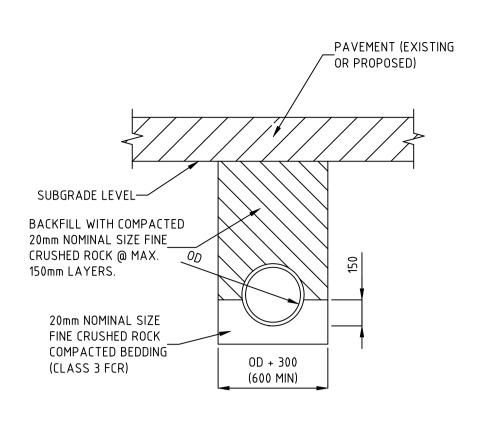




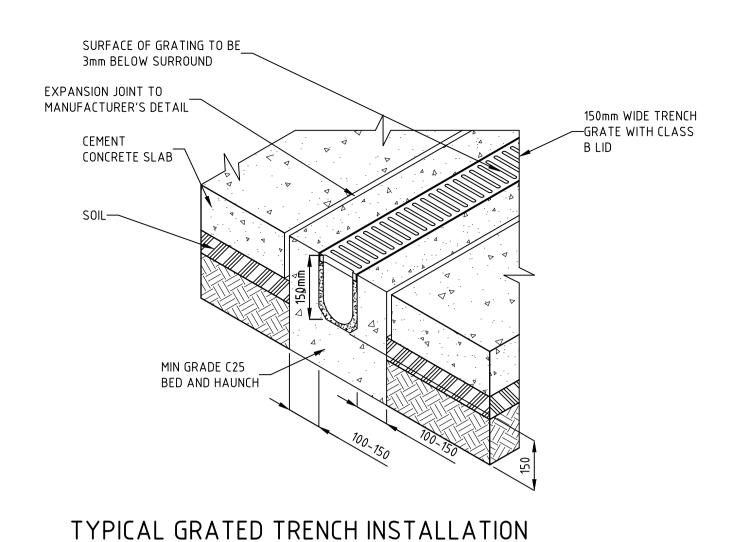


INSTALLATION (NOT UNDER PAVEMENTS)

NOT TO SCALE




PIPE TRENCH UNDER PAVEMENT

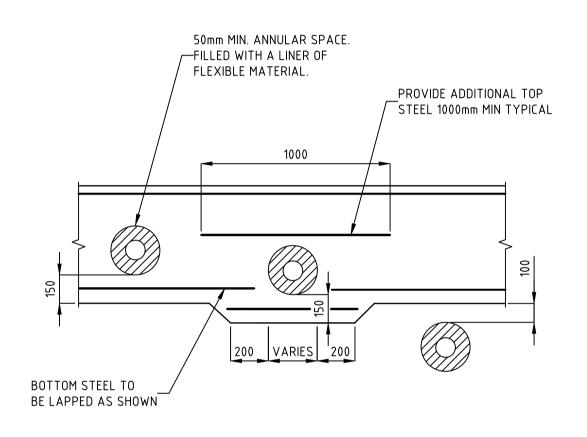



TYPICAL PIPE PENETRATION DETAIL

SCALE 1:20

NOT TO SCALE

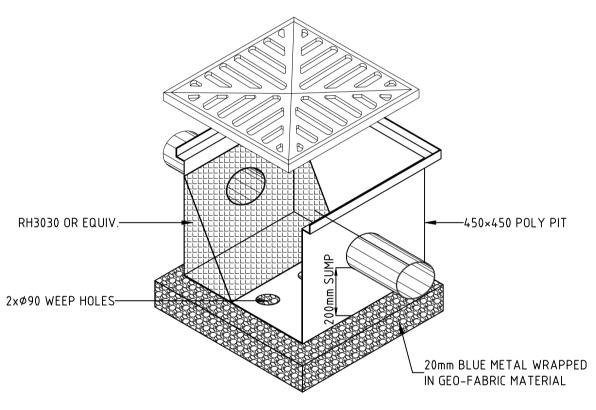

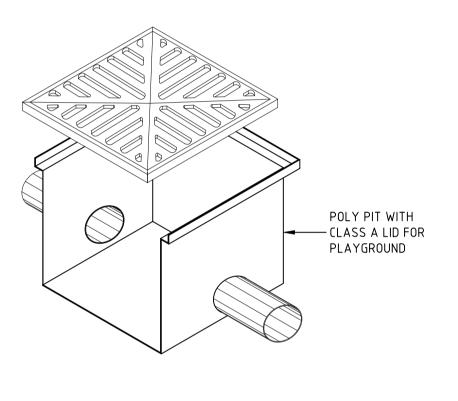

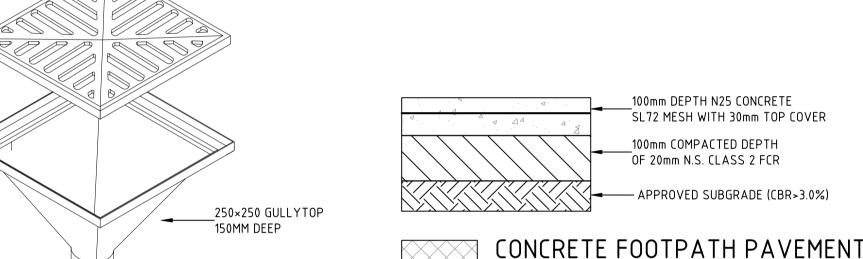

POLY PIT CLASS A COVER (EVERHARD OR SIMILAR) SILT ARRESTOR PIT

NOT TO SCALE

(EVERHARD OR APPROVED


NOT TO SCALE (NO VEHICLE TRAFFIC ALLOWED)


POLY PIT CLASS A COVER

EQUIVALENT)


COVER (EVERHARD OR


GULLYTOP CLASS A APPROVED EQUIVALENT) NOT TO SNOATLEO SCALE

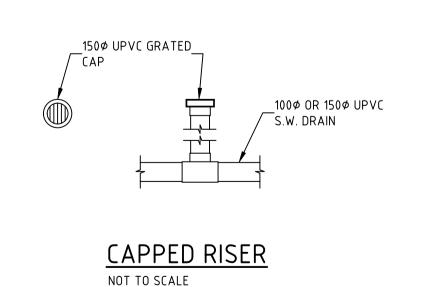

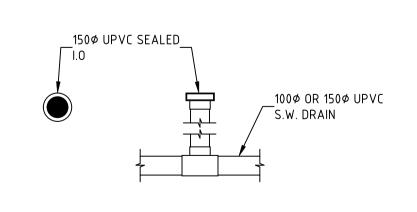

SEALED INSPECTION OPENING DETAIL NOT TO SCALE

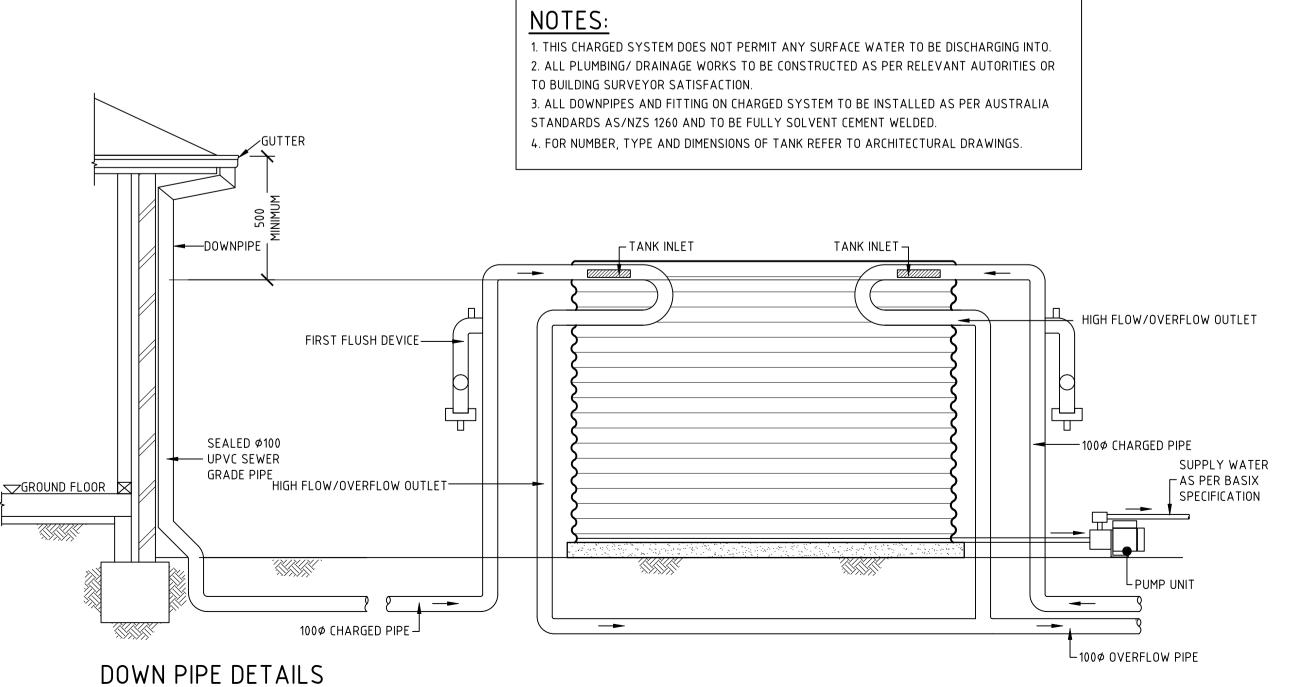

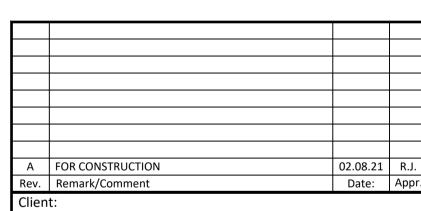

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FOR ISOLATION JOINT DETAILS



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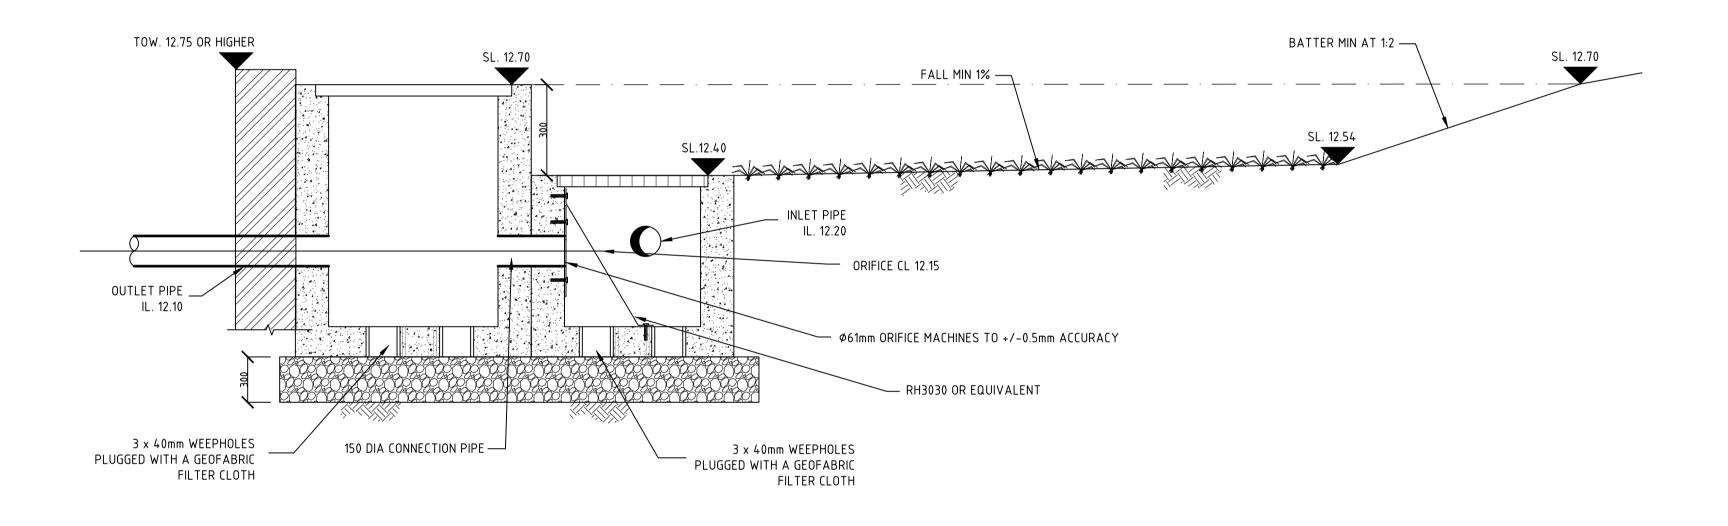
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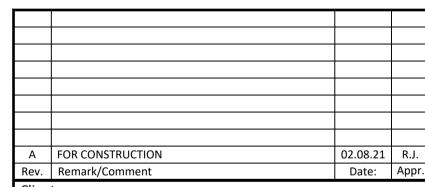
STORMWATER HYDRAULIC DETAILS

FOR CONSTRUCTION

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Reference No)	Drawing No.			Rev.
Scale @ A1:	NTS	Checked:	R.J.	Sheets:	3 OF 4
Date:	AUG.2021	Engineer:	P.F.	Drawn:	P.Y



STANDARD OSD BASIN NOT TO SCALE



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Project:
PROPOSED DEVELOPMENT
LOT 7 NO. 45 WARRIEWOOD ROAD,
WARRIEWOOD

OSD BASIN DETAIL

FOR CONSTRUCTION

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Scale @ A1:	NTS	Checked:	R.J.	Sheets:	4 OF 4
Reference No).	Drawing No	Rev.		
159	253		Α		

DATE: 05/07/21

ADDRESS: Lot 7, 45 Warriewood Road, Warriewood 2102.

