Certificate number: 1018810S

Water Commitments	Show on DA plans	Show on CC/CDC plans & specs	Certifier check
Fixtures			
The applicant must install showerheads with a minimum rating of 3 star (> 7.5 but <= 9 L/min) in all showers in the development.		~	-
The applicant must install a toilet flushing system with a minimum rating of 4 star in each toilet in the development.		~	V
The applicant must install taps with a minimum rating of 4 star in the kitchen in the development.		~	
The applicant must install basin taps with a minimum rating of 4 star in each bathroom in the development.		V	
Alternative water			
Rainwater tank			
The applicant must install a rainwater tank of at least 4000 litres on the site. This rainwater tank must meet, and be installed in accordance with, the requirements of all applicable regulatory authorities.	~	~	V
The applicant must configure the rainwater tank to collect rain runoff from at least 130 square metres of the roof area of the development (excluding the area of the roof which drains to any stormwater tank or private dam).		V	V
The applicant must connect the rainwater tank to:			
all toilets in the development		-	V
the cold water tap that supplies each clothes washer in the development		~	V
 at least one outdoor tap in the development (Note: NSW Health does not recommend that rainwater be used for human consumption in areas with potable water supply.) 			V

consumption in areas with potable water supply.)		~	~
Thermal Comfort Commitments	Show on DA plans	Show on CC/CDC plans & specs	Certifier check
Simulation Method			
The applicant must attach the certificate referred to under "Assessor Details" on the front page of this BASIX certificate (the "Assessor Certificate") to the development application and construction certificate application for the proposed development (or, if the applicant is applying for a complying development, to that application). The applicant must also attach the Assessor Certificate to the application for an occupation certificate for the proposed development.			
The Assessor Certificate must have been issued by an Accredited Assessor in accordance with the Thermal Comfort Protocol.			
The details of the proposed development on the Assessor Certificate must be consistent with the details shown in this BASIX certificate, including the Cooling and Heating loads shown on the front page of this certificate.			
The applicant must show on the plans accompanying the development application for the proposed development, all matters which the Assessor Certificate requires to be shown on those plans. Those plans must bear a stamp of endorsement from the Accredited Assessor to certify that this is the case. The applicant must show on the plans accompanying the application for a construction certificate (or complying development certificate, if applicable), all thermal performance specifications set out in the Assessor Certificate, and all aspects of the proposed development which were used to calculate those specifications.	~	~	~
The applicant must construct the development in accordance with all thermal performance specifications set out in the Assessor Certificate, and in accordance with those aspects of the development application or application for a complying development certificate which were used to calculate those specifications.		~	~
The applicant must construct the floors and walls of the dwelling in accordance with the specifications listed in the table below.			

Floor and wall construction Area				
floor - concrete slab on ground All or	part of floor area square metres			
floor - suspended floor above garage All or	part of floor area			
Energy Commitments		Show on DA plans	Show on CC/CDC plans & specs	Certifier
Hot water				
The applicant must install the following hot water system in the development, or a system with a high instantaneous with a performance of 5 stars.	er energy rating: gas	~	~	~
Cooling system				
The applicant must install the following cooling system, or a system with a higher energy rating, in at airconditioning; Energy rating: EER $3.0 - 3.5$	least 1 living area: 3-phase		V	~
The applicant must install the following cooling system, or a system with a higher energy rating, in at airconditioning; Energy rating: EER 3.0 - 3.5 $$	least 1 bedroom: 3-phase		~	V
The cooling system must provide for day/night zoning between living areas and bedrooms.			V	V
Heating system				
The applicant must install the following heating system, or a system with a higher energy rating, in at airconditioning; Energy rating: EER $3.0 - 3.5$	least 1 living area: 3-phase		V	~
The applicant must install the following heating system, or a system with a higher energy rating, in at airconditioning; Energy rating: EER 3.0 - 3.5	least 1 bedroom: 3-phase		~	~
The heating system must provide for day/night zoning between living areas and bedrooms.			V	V
Ventilation				
The applicant must install the following exhaust systems in the development:				1
At least 1 Bathroom: individual fan, ducted to façade or roof, Operation control: manual switch on/of	f			
Kitchen: individual fan, not ducted; Operation control: manual switch on/off			Ü	J
Laundry: natural ventilation only, or no laundry; Operation control: n/a				-
Artificial lighting				
The applicant must ensure that the "primary type of artificial lighting" is fluorescent or light emitting di following rooms, and where the word "dedicated" appears, the fittings for those lights must only be ca light emitting foliode (LED) lamps:	ode (LED) lighting in each of the pable of accepting fluorescent or			
at least 5 of the bedrooms / study;			, , , , , , , , , , , , , , , , , , ,	-
Energy Commitments		Show on DA plans	Show on CC/CDC plans & specs	Certifier check
at least 2 of the living / dining rooms;				U
• the kitchen;			Ü	J
all bathrooms/toilets;				0
• the laundry;			J	
• all hallways;			Š	J
Natural lighting				
The applicant must install a window and/or skylight in the kitchen of the dwelling for natural lighting.				
The applicant must install a window and/or skylight in 4 bathroom(s)/toilet(s) in the development for n	atural lighting			~
The applicant mast mistain a william and/or stryinght in a pathiotomys/tolled/s/ in the development for h	attarar ngritting.			1.0



Certificate no.:
Assessor Name:
Accreditation no.:
Certificate date:
Dwelling Address:

Proposed Road Warriewood, NSW 2102

www.nathers.gov.au

0003890274 Ian Fry VIC/BDAV/12/1441 27 May 2019



AREAS	
SITE:	349.90 m²
GROUND FLOOR:	98.55 m²
FIRST FLOOR:	116.33 m²
GARAGE:	27.45 m ²
PORCH:	1.99 m²
BALCONY:	N/A m²
	m²
	m²
TOTAL:	244.32 m²

	2.3	NEIGHBOUR NOTIFICATION PLAN
	2.2	SITE ANALYSIS
	2.1	CONSTRUCTION PLAN
	10	WET AREA DETAILS
	9	WET AREA DETAILS
	8	ELECTRICAL LAYOUT
	7	SECTION
M.H.	6	ELEVATIONS
MD	5	ELEVATIONS
SM	4	FIRST FLOOR PLAN
PJ	3	GROUND FLOOR PLAN
PG.	2	SITE PLAN
BG	1	COVER SHEET
BY	SHEET	DESCRIPTION

2.4 SHADOWN DIAGRAMS

Clarendon Homes

The applicant must install a gas cooktop & electric oven in the kitchen of the dwelling.

The applicant must install a fixed outdoor clothes drying line as part of the development.

DATE

QUOTE NUMBER

QUOTE

KITCHEN

TILES

STAIRS

LANDSCAPE

HYDRAULICS

ENGINEER

PEG OUT

ZURCORP ELECTRICAL

ZURCORP SECURITY

AIR CONDITIONING

BL No. 2298C ABN 18 003 892 706

CLIENT'S SIGNATURE:

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DIMENSIONS TO BE READ IN

DATE:

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REV

PADDINGTON 29 MKII Malibu R/H Garage

17.07.19 EXTERNAL COLOURS

21.02.19 CONTRACT DRAWINGS

07.02.19 | PRELIMINARY TENDER

AMENDMENTS

03.06.19 LODGEMENT PLANS & HYDRAULICS

24.05.19 RESITING ON UNREG. CONTOUR

13.03.19 | LOCATION OF SERVICES AREA

Sapphire Specification

DATE

CLIENT: **CONTRACT DRAWINGS** Ms. LIU DRAWN: DATE: PG. 24.05.19 SITE ADDRESS: F RATIO @ A3: CHECKED: Lot 15 N∖A J.S Proposed Road JOB No: 29913475 NSW SHEET: **WYDDIE/WOUD 3103**

Ν 0 R T

SUBJECT TO REGISTRATION OF 10.7 CERTIFICATE

(A) EASEMENT FOR SEWER PURPOSES 5 WIDE VIDE 63908113

(H) PROPOSED EASEMENT FOR ACCESS AND MAINTENANCE


LAND AND CONFIRMATION FROM

D.P: UNREGISTERED L.G.A: **NORTHERN BEACHES**

15

LOT

SITING HAS BEEN COMPLETED IN ACCORDANCE WITH PITTWATER DCP 21 - D16

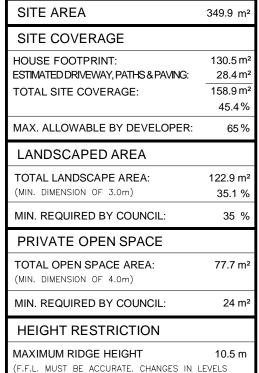

Maximum 1000mm CUT Maximum 1000mm FILL

WIND CLASSIFICATION: "N2"

SLAB CLASSIFICATION: "H1"

NOTE:


ALL GROUND LINES ARE APPROXIMATE. EXTENT OF FILL & BATTER WILL BE DETERMINED ON SITE. SEDIMENT BARRIERS ARE TO BE CUSTOMISED SITE SPECIFIC

STORMWATER TO STREET VIA RAINWATER TANK

REFER TO HYDRAULIC DETAILS

GARAGE FLOOR LEVEL

LEVEL WITH T.K. T.K. RL7.900

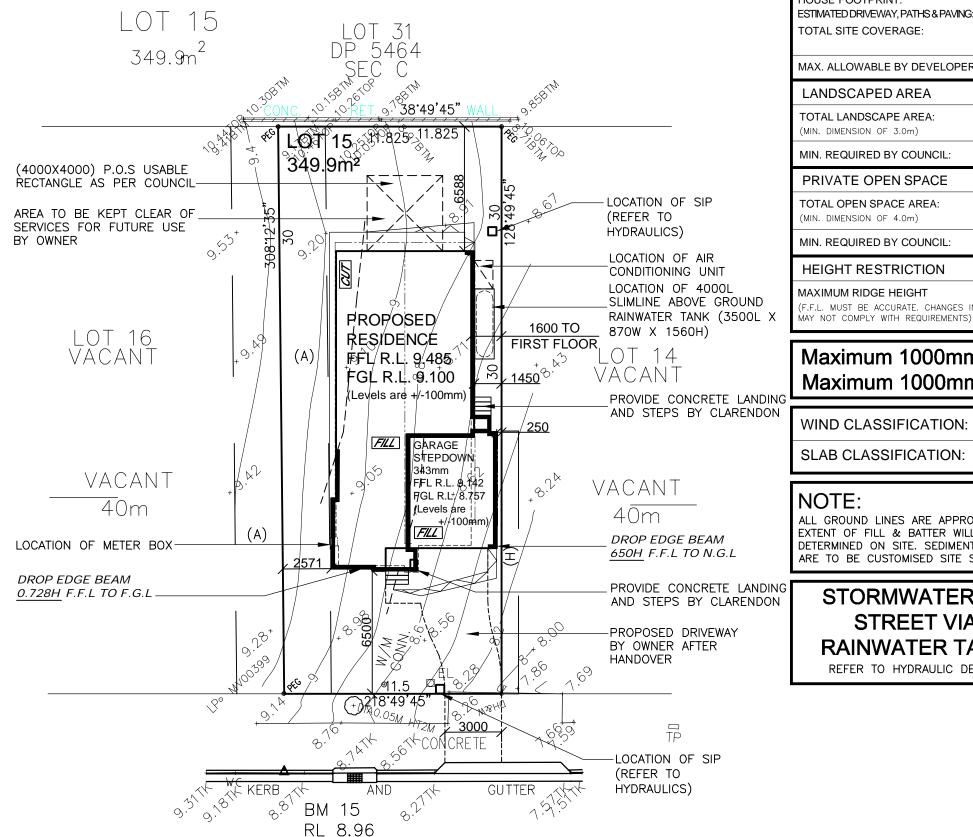

SITE PLAN EXISTING GRADE (4%) RL7.900 2000 TRANSITION

(AHD)

BUBALO STREE

3640 EXISTING CROSSOVER 7700 SETBACK TO GARAGE DRIVEWAY GRADIENT PROFILE

BOUNT R.L. 8

SCALE-1:100

SCALE 1:200

GENERAL NOTES

A) THIS SURVEY IS SPECIFICALLY FOR CONTOUR PURPOSES ONLY. THE BOUNDARIES OF THE SUBJECT PROPERTY HAVE NOT BEEN INVESTIGATED

B) AREAS AND DIMENSIONS ARE SUBJECT TO SURVEY

C) SERVICES SHOWN HAVE BEEN DERIVED FROM VISUAL EVIDENCE APPARENT AT THE TIME OF SURVEY. THE RELEVANT SERVICE AUTHORITY SHALL BE CONTACTED TO VERIFY THE EXISTENCE AND POSITION OF ALL SERVICES PRIOR TO THE COMMENCEMENT OF ANY CONSTRUCTION OR EXCAVATION

D) CONTOURS ARE INDICATIVE OF SURFACE TOPOGRAPHY ONLY. SURVEYED SPOT LEVELS ARE THE ONLY VALUES TO BE RELIED ON FOR REDUCED LEVELS ON PARTICULAR FEATURES.

ClarendonHomes

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PRODUCT: PADDINGTON 29 MKII Malibu R/H Garage

Sapphire Specification # DIMENSIONS TO BE READ IN

CLIENT: **CONTRACT DRAWINGS** Ms. LIU DRAWN: DATE: 24.05.19 SITE ADDRESS: BG RATIO @ A3: CHECKED: Lot 15 1:200 BG Proposed Road SHEET: 29913475 NSW /// V D D I E / / / / U 21/02

NOTE: HEIGHT OF DROP EDGE BEAM MAY VARY DUE TO SITE CONDITIONS **UPON COMPLETION OF SITE WORKS**


DENOTES WINDOWS/DOORS WITH LOW E GLAZING

NOTES: FOR DROP-OFF'S REFER TO FRAMING DETAILS CDN 21.010-21.080


NUMBER OF STEPS REQUIRED MAY VARY DEPENDING ON SITE CONDITIONS



DENOTES WINDOWS WITH 6.38mM TRANSLUCENT LAMINATED GLAZING

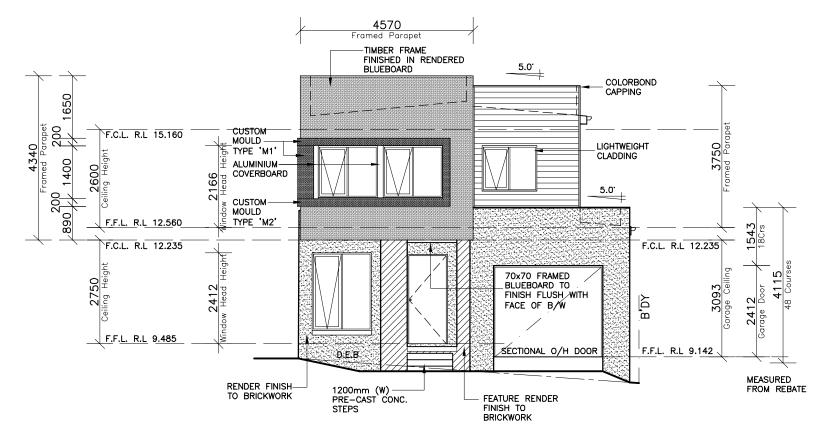

ELEVATION 1 -NORTH WEST-

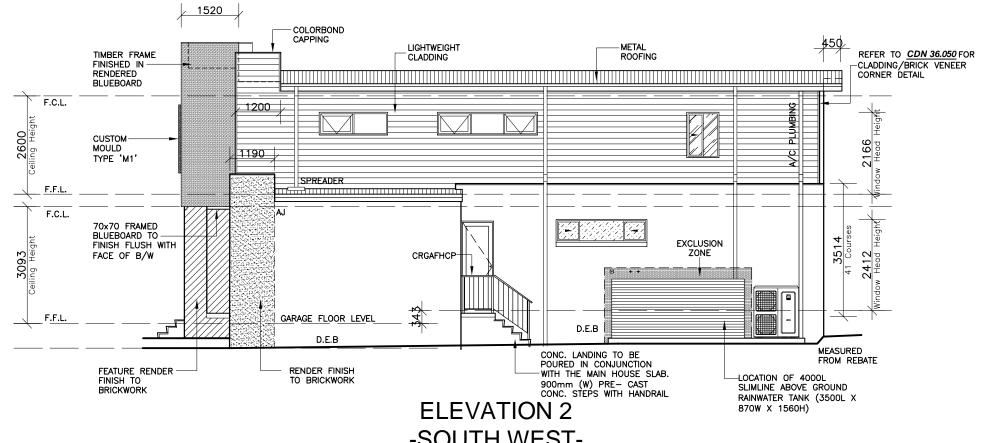

-SOUTH WEST-

CLIENT'S SIGNATURE:

Clarendon Homes

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DIMENSIONS TO BE READ IN

PRODUCT: PADDINGTON 29 MKII Malibu R/H Garage

Sapphire Specification

CLIENT: **CONTRACT DRAWINGS** Ms. LIU DRAWN: DATE: PG. 24.05.19 SITE ADDRESS: F Lot 15 RATIO @ A3: CHECKED: 1:100 J.S Proposed Road JOB No: 29913475 NSW SHEET: /// DDIE/// OUD 3103


NOTE: HEIGHT OF DROP EDGE BEAM MAY VARY DUE TO SITE CONDITIONS UPON COMPLETION OF SITE WORKS DENOTES WINDOWS/DOORS WITH LOW E GLAZING

NOTES: FOR DROP-OFF'S REFER TO FRAMING DETAILS CDN 21.010-21.080

NUMBER OF STEPS REQUIRED MAY VARY DEPENDING ON SITE CONDITIONS



ELEVATION 3 -SOUTH EAST-

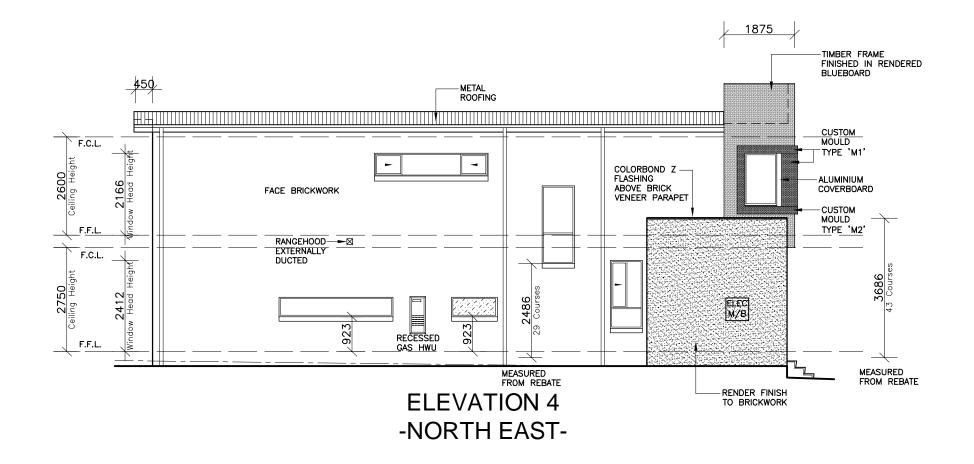

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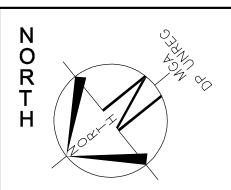
DIMENSIONS TO BE READ IN

DATE:

PRODUCT: PADDINGTON 29 MKII Malibu R/H Garage

Sapphire Specification

CLIENT: **CONTRACT DRAWINGS** Ms. LIU DRAWN: PG. DATE: 24.05.19 SITE ADDRESS: RATIO @ A3: CHECKED: 1:100 J.S F Lot 15 J.S Proposed Road JOB No: 29913475 NSW SHEET: \\\ \ D D | E \\\\ ∩ ∩ \ 21 ∩ 2




SUBJECT TO REGISTRATION OF LAND AND CONFIRMATION FROM 10.7 CERTIFICATE

(A) EASEMENT FOR SEWER PURPOSES 5 WIDE VIDE 63908113 (H) PROPOSED EASEMENT FOR ACCESS AND MAINTENANCE

LOT 15

D.P: UNREGISTERED L.G.A: NORTHERN BEACHES

SITING HAS BEEN COMPLETED IN ACCORDANCE WITH PITTWATER DCP 21 - D16

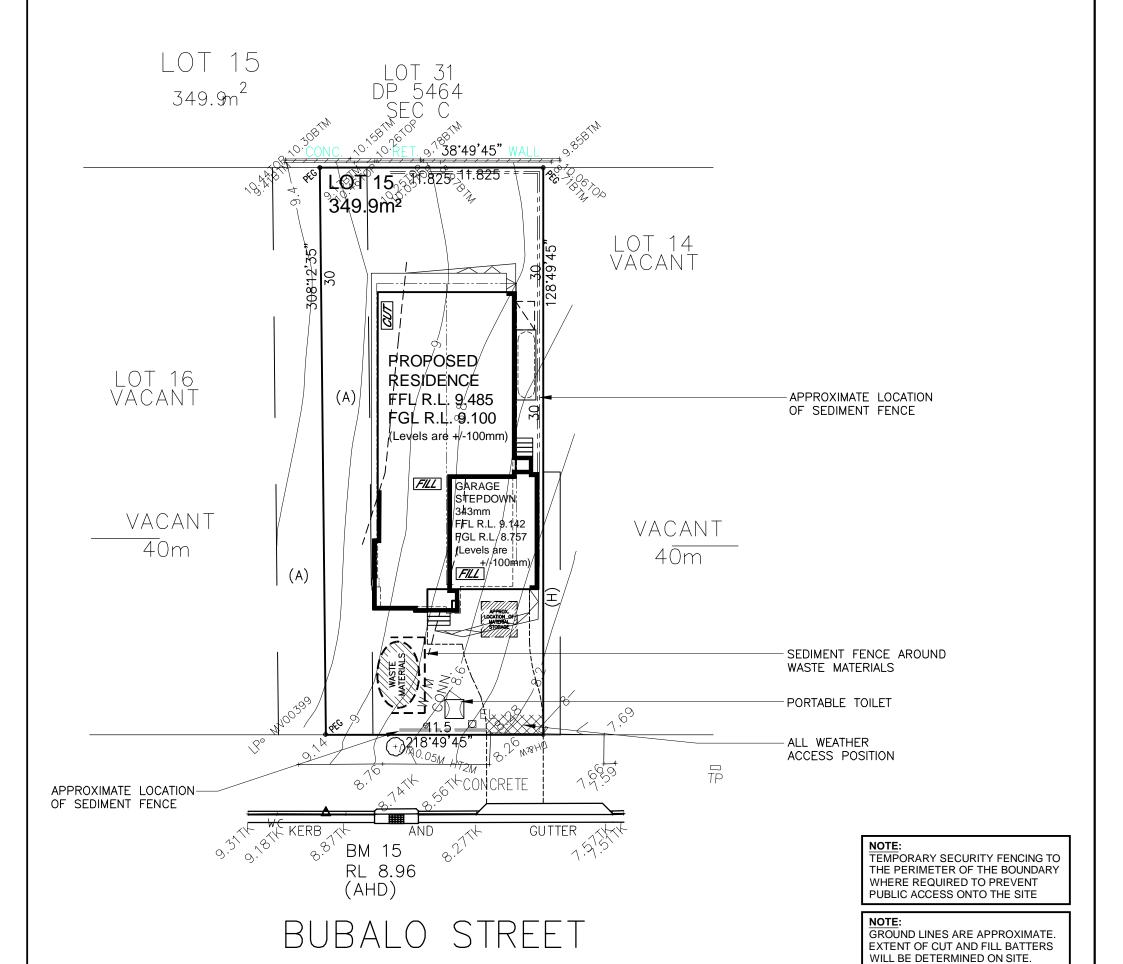

CONSTRUCTION MANAGEMENT PLAN **EROSION AND SEDIMENT CONTROL PLAN**

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DIMENSIONS TO BE READ IN

PRODUCT: PADDINGTON 29 MKII Malibu R/H Garage

Sapphire Specification

CLIENT: Ms. LIU

CONTRACT DRAWINGS DRAWN: DATE: 24.05.19 PG. SITE ADDRESS: RATIO @ A3: CHECKED: Lot 15 1:200 J.S Proposed Road 29913475 NSW /// V D D I E / / / / U 21/02

SEDIMENT CONTROL NOTES GEOTERIL FLIER A


SEDIMENT FENCE

F

CUSTOMISED TO SITE CONDITIONS

5. ALL DISTURBED AREAS SHALL BE REVEGITATED AS SOON AS THE RELEVANT

SOIL AND TOPSOIL STOCKPILES SHALL BE LOCATED AWAY FROM DRAINAGE LINES AND AREA WHERE WATER CONCENTRATE. ALL ROADS AND FOOTPATHS TO BE SWEPT DAILY. FILTER SHALL BE CONSTRUCTED BY STRETCHING A FILTER FABRIC (PROPEX OR AP POST AT 3.0m CENTRES. FABRIC SHALL BE BURIED 150mm ALONG ITS LOWER EDGE. . DUST PREVENTION MEASURES TO BE MAINTAINED AT ALL TIMES.

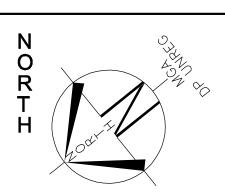


SUBJECT TO REGISTRATION OF LAND AND CONFIRMATION FROM 10.7 CERTIFICATE


(A) EASEMENT FOR SEWER PURPOSES 5 WIDE VIDE 63908113 (H) PROPOSED EASEMENT FOR ACCESS AND MAINTENANCE

LOT 15

D.P: UNREGISTERED L.G.A: NORTHERN BEACHES

SITING HAS BEEN COMPLETED IN ACCORDANCE WITH PITTWATER DCP 21 - D16

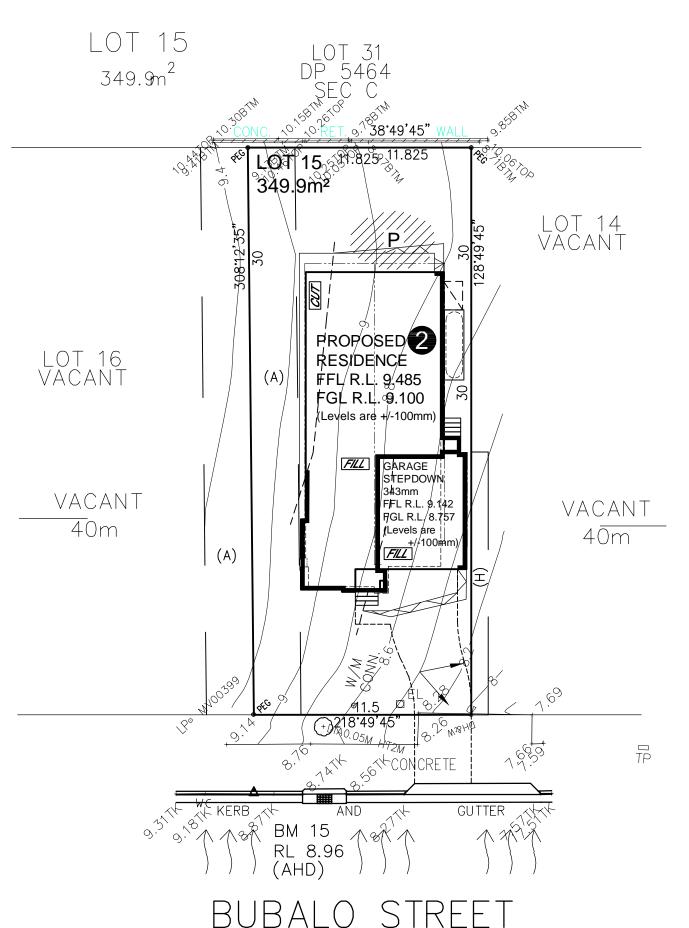

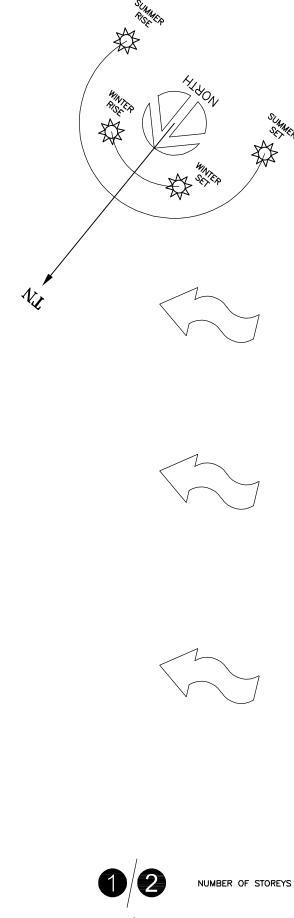



PRINCIPAL PRIVATE OPEN SPACE



MAIN VIEWS



NOISE IMPACT



PREVAILING WINDS

SITE ANALYSIS PLAN

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BL No. 2298C ABN 18 003 892 706

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DIMENSIONS TO BE READ IN

PRODUCT:
PADDINGTON 29 MKII
Malibu
R/H Garage

Sapphire Specification


Ms. LIU

SITE ADDRESS:
Lot 15

Proposed Road

/// DDIE/// OUD 3103

CLIENT:

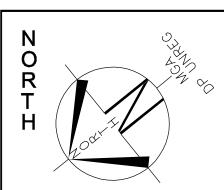


SUBJECT TO REGISTRATION OF LAND AND CONFIRMATION FROM 10.7 CERTIFICATE

(A) EASEMENT FOR SEWER PURPOSES 5 WIDE VIDE 63908113 (H) PROPOSED EASEMENT FOR ACCESS AND MAINTENANCE


LOT 15

D.P: UNREGISTERED L.G.A: NORTHERN BEACHES

SITING HAS BEEN COMPLETED IN ACCORDANCE WITH PITTWATER DCP 21 - D16

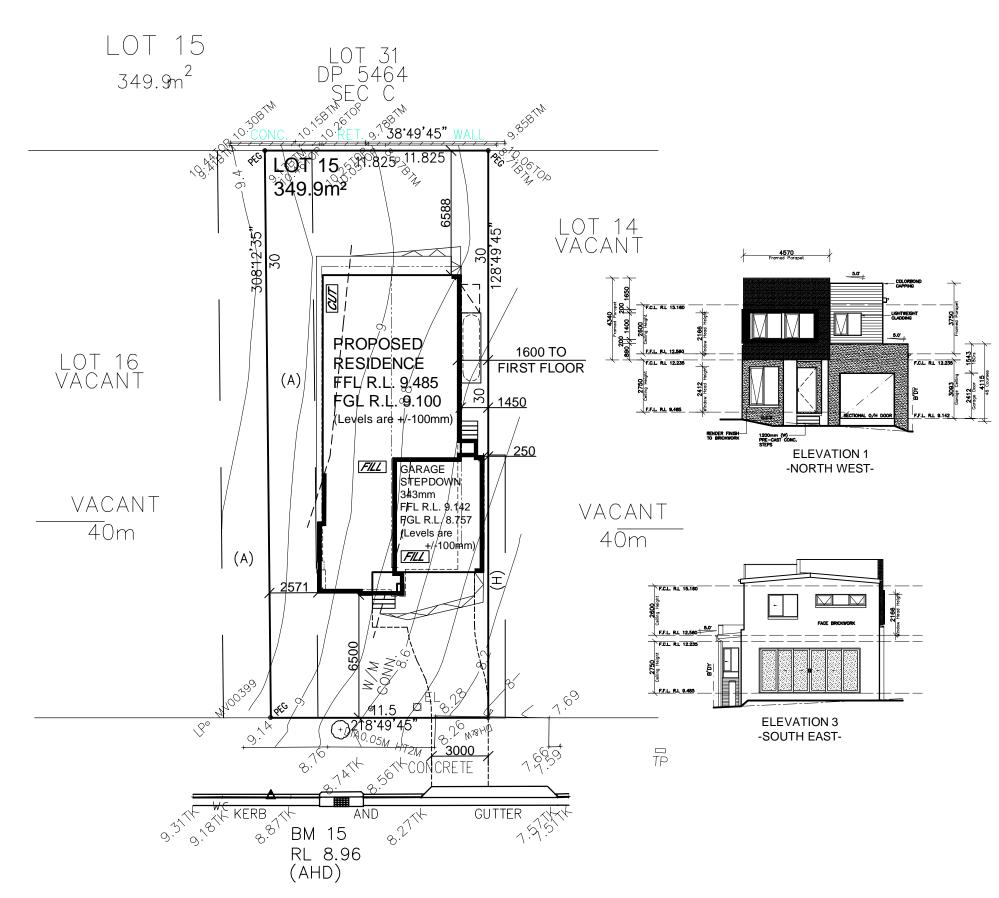

BUBALO STREET

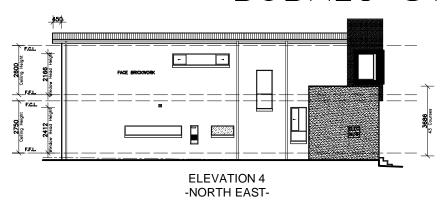



ELEVATION 2 -SOUTH WEST-

NEIGHBOUR NOTIFICATION PLAN


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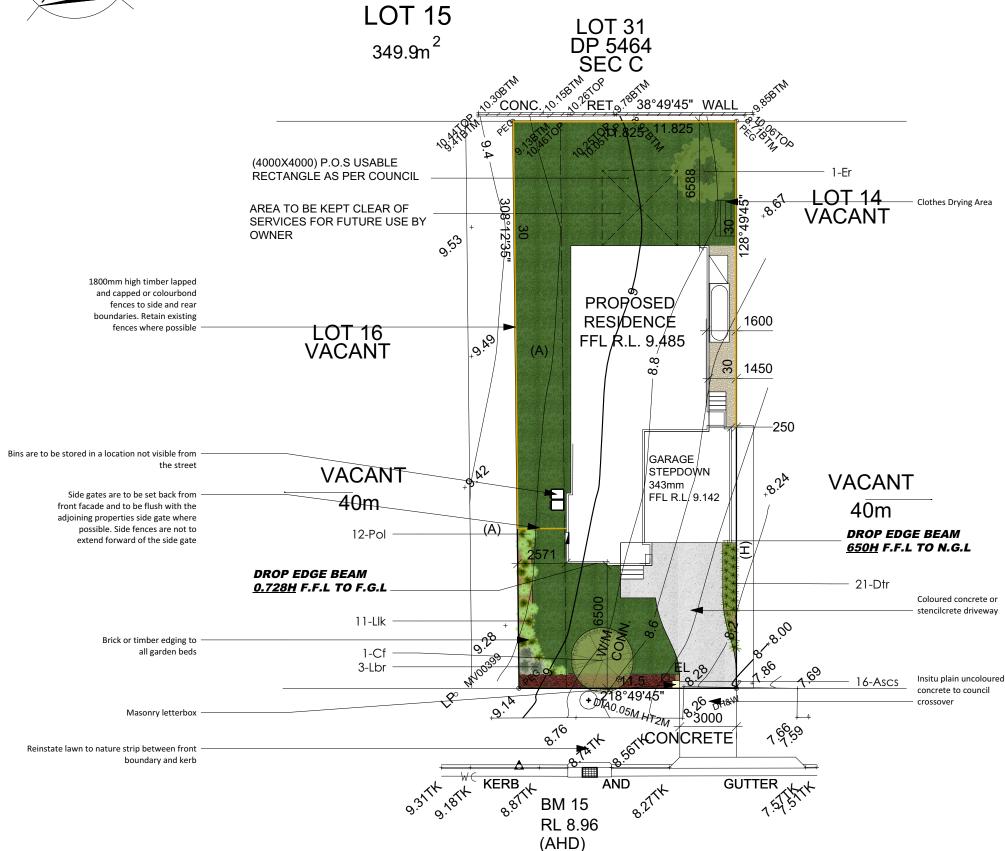
DIMENSIONS TO BE READ IN

PRODUCT:
PADDINGTON 29 MKII
Malibu
R/H Garage

Sapphire Specification



O R

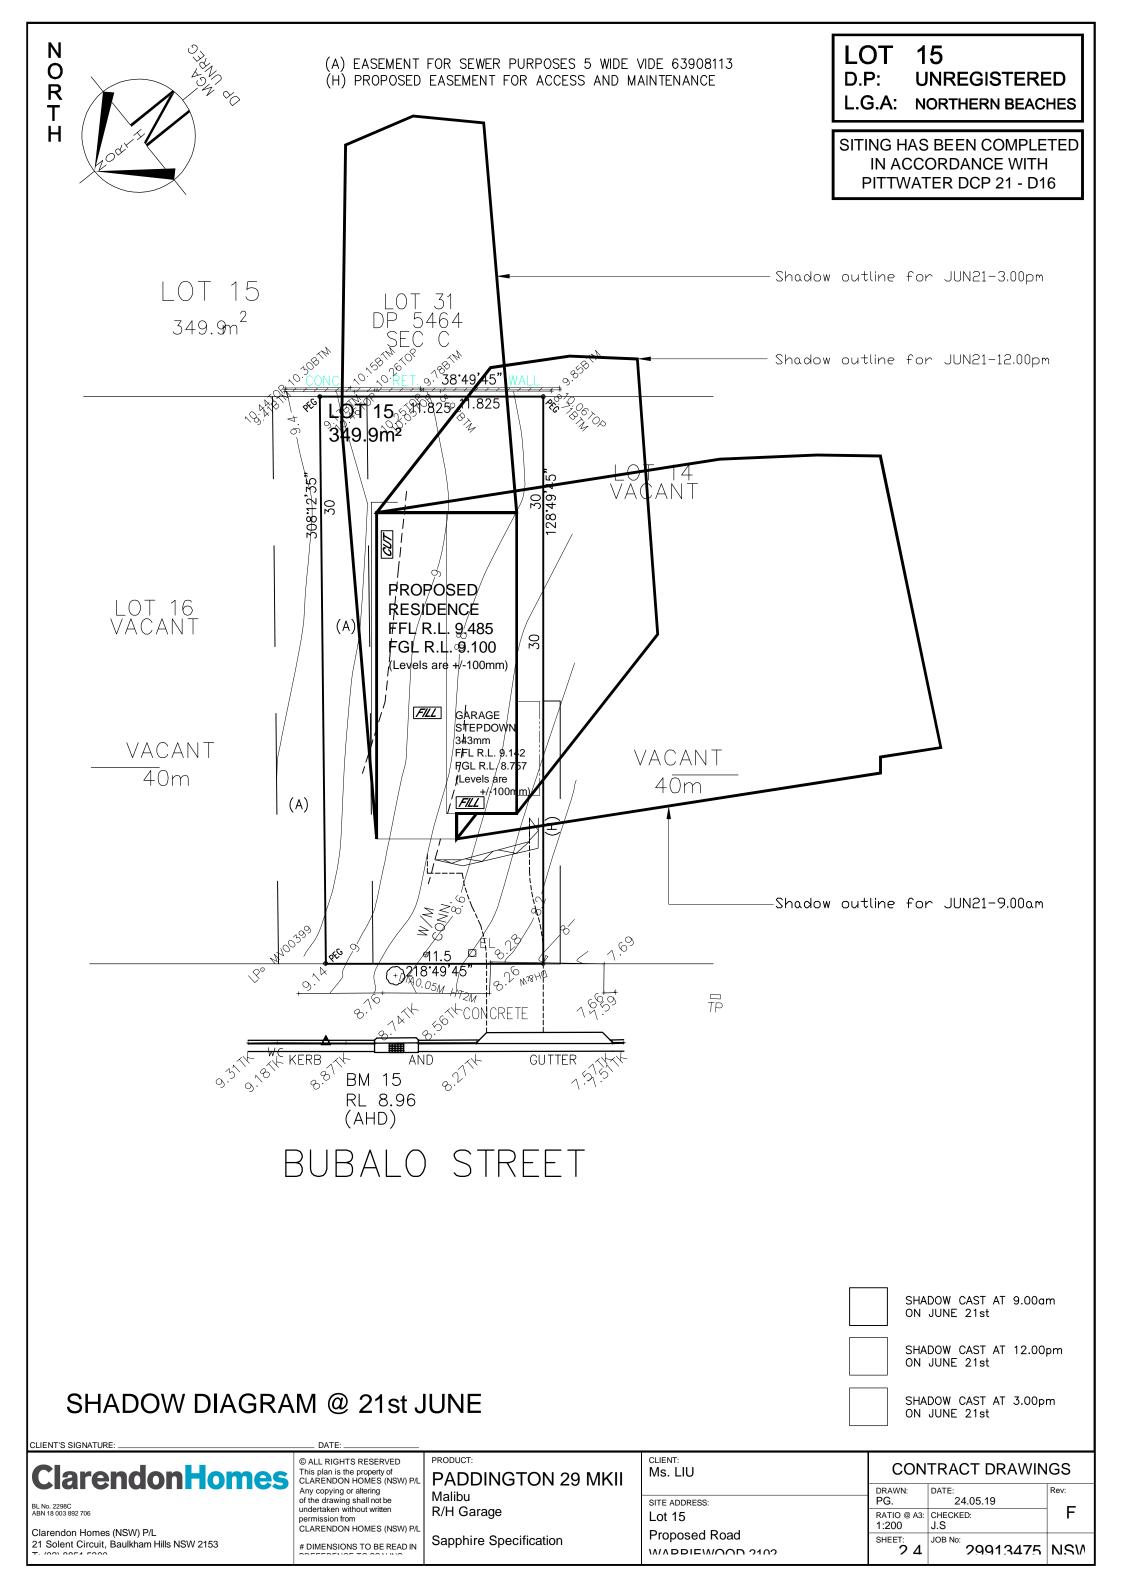

Legend

Colour / Stencil Concrete Pebbles / Decorative Gravel Areas Planting Areas Lawn Areas

1800mm High Boundary Fencing

Revision Schedule

	Issue: Description:		By:	Date:
s	Α	Submission Plan	JST	06/03/19
	В	Client: Tree	JS	12/03/19
	С	Client: Tree	JST	13/03/19
	D	Bldr: Contours	JS	27/05/19

Drafted:	Scale: 1:200	
JS	0 0 1 2 3M	
Sheet:	Reference:	
1 of 3	LP 01	

Designed by:

Julian Saw

Diploma of Horticulture (Landscape Design)

- See Architects drawings for site levels, setbacks and extent of cut and fill.
- 2. This plan shall be read in conjunction with the Hydraulie Engineers drawings.
- 3. All relevant australian standards are to be adhered to. 4. Any structural items are to be installed as per the
- manufacturer/engineers specifications.

SITE CALCULATIONS LOT AREA 349.9 sq m

LANDSCAPED AREA TOTAL 122.9 sq m 35.122%

Click Here to View Our Plant Profiles!

Client: Ms Liu

Client Signatures:

2.

Job No. 190087

Drawing: Landscape Plan

Address: Lot 15 Proposed Road

Warriewood

Northern Beaches

DappleDesigns

Ph: 0437 043 112 www.dappledesigns.com.au

BUBALO STREET

(A) EASEMENT FOR SEWER PURPOSES 5 WIDE VIDE 63908113 (H) PROPOSED EASEMENT FOR ACCESS AND MAINTENANCE

in accordance with councils Tree **Protection Detail**

Any existing trees are to be protected

Click Here to View Our Plant Profiles!

LANDSCAPE SPECIFICATION

SITE ESTABLISHMENT

ALL RUBBISH, DEBRIS, FALLEN BRANCHES SHALL BE CLEARED FROM LANDSCAPED AREAS AND DISPOSED OF USING SKIP BINS ONSITE OR BY TRANSPORTING TO THE LOCAL WASTE MANANAGEMENT FACILITY. ANY UNUSED BRICKS, CONCRETE BLOCKS OR TIMBER SHOULD BE EITHER RE-USED ONSITE WHERE POSSIBLE OR RECYCLED AT THE LOCAL WASTE MANANAGEMENT FACILITY.

TREE PROTECTION

TREES TO BE RETAINED SHALL BE PROTECTED DURING SITE WORKS AND TREE PROTECTION BARRIERS INSTALLED ACCORDING TO TREE PROTECTION DETAILS. NO EXCAVATION OR CHANGE IN SOIL LEVEL SHOULD TAKE PLACE AROUND THE BASE OF SUCH TREES. ANY ARBORIST REPORT MUST BE ADHERED TO AND TREE PROTECTION ZONES MAINTAINEDWHERE APPLICABLE.

WEED ERADICATION

AREAS TO BE LANDSCAPED ARE TO BE SPRAYED WITH GLYPHOSATE AT THE RECOMMENDED RATE AT LEAST 1 WEEK PRIOR TO ANY LANDSCAPE WORKS TAKING PLACE IN ORDER TO ALLOW WEEDS TO DIE OFF. CARE IS TO BE TAKEN TO PROTECT REMAINING VEGETATION FROM THE HERBICIDE APPLICATION AND SHOULD ONLY BE UNDERTAKEN IN STILL WEATHER. ALL WEEDS ARE THEN TO BE DISPOSED OF APPROPRIATELY AT THE LOCAL WASTE MANANAGEMENT FACILITY.

GARDEN BED PREPERATION

ENSURE ALL GARDEN BEDS HAVE BEEN EXCAVATED TO 250MM BELOW FINISHED LEVELS. RIP THE SUBGRADE A FURTHER 100MM IN DEPTH. INSTALL PREMIUM GARDEN SOIL OR MIX NATURAL TOP SOIL WITH IMPORTED SOIL TO A DEPTH OF 250MM. INSTALL 75MM DEPTH OF LEAF LITTER MULCH FROM ANL LANDSCAPE SUPPLIES OR EQUIVALENT.

LAWN AREA PREPERATION

EXCAVATE LAWN AREAS TO A DEPTH OF 100MM BELOW REQUIRED FINISHED LEVELS. DO NOT EXCAVATE WITHIN WITHIN TREE PROTECTION ZONES WHERE APPLICABLE OR WITHIN 1500MM OF THE TRUNK OF ANY EXISTING TREES TO BE RETAINED. ENSURE THAT ALL SURFACE WATER IS DIRECTED TOWARD ANY DRAINAGE PITS, KERBS AND AWAY FROM ANY BUILDINGS. SUBGRADE IS TO BE RIPPED TO A DEPTH OF 150MM AND A 50MM DEEP LAYER OF TURF UNDERLAY INSTALLED ON TOP. LAWNS SHOULD HAVE AN EVEN GRADE SO THAT NO PONDING OR POOLING OCCURS. 'SIR LAUNCHER' FERTILISER OR EQUIVELANT SHOULD BE SPREAD OVER LAWN AREAS PRIOR TO LAYING TURF. LAY *'SIR WALTER BUFFALO'* TURF ROLLS CLOSELY BUTTED ENSURING NO GAPS BETWEEN ARE PRESENT. ROLL AND WATER THOROUGHLY AFTER LAYING.

PI ANTING

PLANTS ARE TO BE HEALTHY, FREE OF PEST/DISEASES AND TRUE TO TYPE & SPECIES. REFER TO LANDSCAPE PLAN FOR LOCATION AND SPACING. ALL PLANTS SHOULD BE PLACED IN A HOLE DUG TWICE THE SIZE OF THE POT. GENTLY TEESE THE ROOTS OF ANY POT BOUND PLANTS. THE BASE OF THE TRUNK SHOULD BE INSTALLED LEVEL WITH THE SURFACE OF THE GROUND AND DISH CREATED AROUND THE BASE OF EACH PLANT TO AID WITH WATER RETENTION. WATER THOROUGHLY AFTER PLANTING.

STAKING

ALL TREES AND TOP HEAVY SCREENING SHRUBS SHOULD BE STAKED WITH 2 X 25MM X 25MM LONG TIMBER STAKES PER PLANT. LENGTH OF STAKES IS DEPENDENT ON THE HEIGHT AND STABILITY OF THE TREE/SHRUB. STAKES SHOULD BE FIRMLY POSITIONED. HESSIAN TAPE IS TO BE PLACED AROUND THE TREE AND STAKES ALLOWING SOME MOVEMENT IN ORDER TO ALLOW THE TRUNK TO DEVELOP STRENGTH OVERTIME.

GARDEN EDGING

USE EITHER *'HAVEN' BRICK EDGING* OR SIMILAR LAID ON A 50MM THICK BED OF MORTAR, OR *TREATED TIMBER EDGING* SECURED WITH INGROUND TIMBER STAKES. ALL GARDENS ARE TO HAVE EDGING INSTALLED AND BE INSTALLED AS PER PLAN.

RETAINING WALLS

REFER TO MANUFACTURERS INSTRUCTIONS FOR CONSTRUCTION OF RETAINING WALLS. DETAILS ON THIS PLAN ARE A GUIDE ONLY.

COMPLETION

SITE IS TO BE CLEARED OF ANY SURPLUS MATERIALS AND DEBRIS PRIOR TO PRACTICAL COMPLETION. WORK IS TO BE COMPLETED TO THE SATISFACTION OF COUNCILS GUIDELINES AND ANY DA CONDITIONS

MAINTENANCE PERIOD

A 12 MONTH MAINTENANCE PERIOD FROM THE DATE OF PRACTICAL COMPLETION WILL APPLY. DURING THIS TIME THE OWNER IS RESPONSIBLE FOR RECTIFYING ANY DEFECTIVE WORK. DURING THE MAINTENACE PERIOD THE FOLLOWING ACTIVITIES ARE

TO BE UNDERTAKEN.

a) REPLACEMENTS: ANY PLANTS/TREES THAT HAVE DIED SHALL BE REPLACED WITH THE SAME SPECIES AND SIZE AS INDICATED ON THIS PLAN. THE SPECIMENS MUST BE IN GOOD HEALTH AND FREE FROM PESTS AND DISEASES.
b) WATERING: REGULAR WATERING OF PLANTS IS REQUIRED. PLANTS SHOULD BE WATERED TWICE A WEEK WITHIN

THE FIRST

2 MONTHS OF PLANTING AND AND DURING DRY PERIODS. LESS FREQUENT WATERING IS REQUIRED ONCE PLANTS

ARE ESTABLISHED AND DURING PERIODS OF RAIN. THE CONTRACTOR/OWNER SHOULD USE THEIR DISCRETION.

c) GARDEN BEDS: GARDEN AREAS SHOULD BE REGULARLY WEEDED AND MULCH TOPPED UP IF REQUIRED. NO BARE SOIL IS TO BE PRESENT AND SPECIFIED DEPTHS MAINTAINED.

d) LAWN AREAS: LAWN AREAS SHALL BE MOWN REGULARLY (AT LEAST ONCE A WEEK IN GROWING SEASON) IN ORDER TO PROMOTE A THICK LAWN THAT OUTCOMPETES ANY WEEDS. LAWN CLIPPINGS ARE NOT TO BE SPREAD OVER GARDEN AREAS. ANY DEAD AREAS OF LAWN OCCURING THE MAINTENANCE PERIOD, ARE TO BE REPLACE WITH THE TURF VARIETY SPECIFED IN THE PLAN.

e) PRUNING: ADEQUATE HORTICULTURAL PRUNING METHODS SHOULD BE USED ON PLANTS AS BECOMES NECESSARY. ANY HEDGES ARE TO BE TRIMMED REGULARLY, DEAD AND DANGEROUS TREE BRANCHES PRUNED AND LIGHT PRUNING OF SHRUBS TO PROMOTE THICK FOLIAGE COVER.

f) FERTILISING: 'ORGANIC LIFE' FERTILISER OR EQUIVELANT SHALL BE APPLIED AS PER MANUFACTURERS INSTRUCTIONS TO ALL GARDEN BEDS ONCE PER MONTH. DYNAMIC LIFTER OR SIMILAR SHOULD BE APPLIED TO ALL LAWN AREAS TWICE A YEAR, ONCE IN MID SPRING AND ONCE IN EARLY SUMMER. WATER THOROUGHLY AFTER EACH APPLICATION OF FERTILISER.

PLANT LIST

TYPE	SYMBOL	BOTANIC NAME	COMMON NAME	MATURE HEIGHT X WIDTH	NATIVE?	QTY	POT SIZE
TREES							
	Cf	CORYMBIA FICIFOLIA	red flowering gum	8M X 3M	YES	1	45LTR
	Er	ELAEOCARPUS RETICULATUS	BLUEBERRY ASH	9M X 4M	YES	1	45LTR
SHRUBS							
	Lbr	LEUCOPHYTA BROWNII	cushion plant	1M X 1M	YES	3	200MM
GRASSES & STRAP LEAF PLANTS							
	Dtr	DIANELLA TASMANICA 'TAS RED'	TAS RED DIANELLA	0.45M X 0.45M	YES	21	140MM
	Llk	LOMANDRA LONGIFOLIA 'KATRINUS'	Katrinus	0.75M X 0.75M	YES	11	140MM
	Pol	POA LABILLARDIERI	TUSSOCK GRASS	0.8M X 0.8M	YES	12	140MM
HEDGES							
	Ascs	ACMENA SMITHII 'CHERRY SURPRISE'	CHERRY SURPRISE LILY PILLY	TRIMMED UP TO 1M	YES	16	200MM

Revision Schedule

Issue:	Description:	Ву:	Date
А	Submission Plan	JST	06/03/1
В	Client: Tree	JS	12/03/1
С	Client: Tree	JST	13/03/1
D	Bldr: Contours	JS	27/05/1

JS

Sheet:

Reference:

2 of 3

LP 01

Scale: 1:200

Designed by:

Drafted:

Julian Saw Diploma of Horticulture (Landscape Design)

General Notes

- See Architects drawings for site levels, setbacks and extent of cut and fill.
- 2. This plan shall be read in conjunction with the Hydraulic Engineers drawings.
- 3. All relevant australian standards are to be adhered to.
- 4. Any structural items are to be installed as per the manufacturer/engineers specifications.
- This plan is indicative only and not for construction purposes

SITE CALCULATIONS

LOT AREA	349.9 sq m	
	422.0	25.422

Click Here to View Our Plant Profiles!

Client: Ms Liu

Client Signatures:

1. 2.

Job No. 190

Drawing: Plant List/Specification


190087


Address: Lot 15 Proposed Road Warriewood

Council: Northern Beaches



Ph: 0437 043 112 www.dappledesigns.com.au

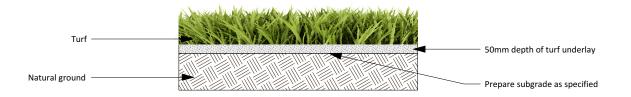

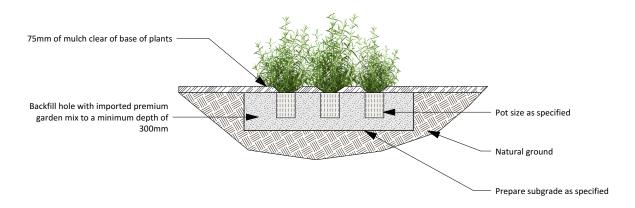

DETAILS


- 1. TURF ROLLS ARE TO BE IN GOOD HEALTH, FREE FROM PESTS AND DISEASES AND WITHOUT HOLES
- 2. APPLY WATER SAVING CRYSTALS TO THE GROUND PRIOR TO LAYING
- 3. BUT ROLLS CLOSELY TOGETHER TO AVOID GAPS AND DIEBACK
- 4. WATER THROUROUGHLY AFTER PLANTING AND REGULARLY UNTIL ESTABLISHED

TURF LAYING DETAIL

SCALE 1:20

TOP VIEW

FRONT VIEW

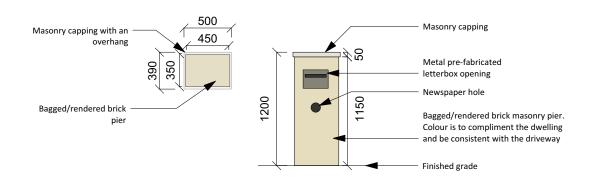

DETAILS


- 1. COLOUR CHOSEN IS TO COMPLIMENT THE DWELLING
- 2. ENSURE THAT NO CEMENT OR RENDER IS LEFT ON THE BRICKWORK OR LETTERBOX OPENING
- 3. BRICK PIER IS TO LEVEL AND STRAIGHT

LETTERBOX DETAIL

SCALE 1:40

- 1. SPECIMENS ARE TO BE IN GOOD HEALTH AND FREE FROM PESTS AND DISEASES
- 2. GENTLY LOOSEN ROOTS IF REQUIRED, PRIOR TO PLANTING
- 3. WATER THROUROUGHLY AFTER PLANTING
- 4. REFER TO PLAN FOR QUANTITIES AND SPACING

SHRUB & GROUNDCOVER PLANTING DETAIL

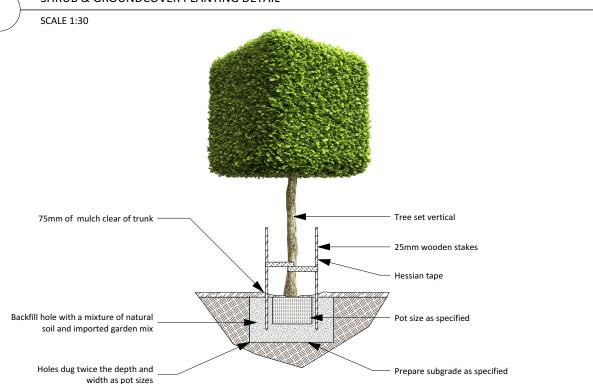

DETAILS

- 1. SPECIMENS ARE TO BE IN GOOD HEALTH AND FREE FROM PESTS AND DISEASES
- 2. WATER THROUROUGHLY AFTER PLANTING

TREE PLANTING DETAIL

SCALE 1:40

Revision Schedule

	Issue:	Description:	By:	Date:
	Α	Submission Plan	JST	06/03/19
	В	Client: Tree	JS	12/03/19
	С	Client: Tree	JST	13/03/19
	D	Bldr: Contours	JS	27/05/19

Drafted:	Scale: 1:200
JS	0 0 1 2 3M
Sheet:	Reference:

3 of 3 LP 01

Designed by:

Julian Saw Diploma of Horticulture (Landscape Design)

- 1. See Architects drawings for site levels, setbacks and extent of cut and fill.
- 2. This plan shall be read in conjunction with the Hydraulic
- Engineers drawings 3. All relevant australian standards are to be adhered to.
- 4. Any structural items are to be installed as per the
- manufacturer/engineers specifications.
- 5. This plan is indicative only and not for construction purposes

SITE CALCULATIONS

LOT AREA 349.9 sq m

LANDSCAPED AREA TOTAL 122.9 sq m 35.122%

Click Here to View Our Plant Profiles!

Ms Liu

Client:

Client Signatures:

2.

Job No. 190087

Drawing: Construction Details

Address: Lot 15 Proposed Road

Warriewood

Council: Northern Beaches



Ph: 0437 043 112 www.dappledesigns.com.au

LIFESTYLE

- STUDIO

BY CLARENDON HOMES

Client

Site Address:

Lot 15 Bubalo Street Warriewood NSW

Job Number:

29913475

House Type:

Paddington MK 11 / Malibu

Date Issued:

28/06/2019

Developer:

Roof BASIX Rating:

Medium

Wall BASIX Rating:

Dark

Main Brick: Austral





Window Frame Colour: Black



Front Entry Door Colour: Sikkens Silver Grev



Blueboard: Grey Moggy T10 50K-2 Moulds: Mojo







Feature: Render

Colour 1: Viking Grey T10 37-L1

Colour 2: Mojo T172-8

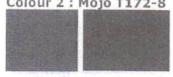

Gutter: Basalt Fascia: Basalt

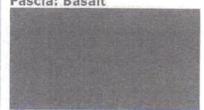

Lightweight Cladding: Mojo T172-8



Driveway Type: To compliment facade

*By client after handover

Roof Type/Style: Metal/

Colourbond Colour: Basalt



Downpipes: Basalt Watertank: Basalt



Garage Door Type & Colour: Deco Chestnut Natural



Chestnut

Letterbox: To compliment facade

*By client after handover

NOTE: Colours are indicative only and should not be used as a true representation of the product.

Signature