General Information:

Subject Parcel Address : 35 Beaconsfield Street, Newport, NSW, 2106 Subject Lot/Sec/DP : L 1 DP 158869 Approx Area m²: 603.88 m²

LEP Zoning Info:

Council - Description Northern Beaches Council LEP2014

LEP 2014 Zoning Info:

Info table Code Description


Zoning E4 - Environmental Living

BALUSTRADES AND HANDRAILS


A continuous Balustrade must be provided along the side of any roof to which access provided or any stairway or ramp, any floor, corridor, hallway, balcony, veranda, mezzanine, access bridge or the like and along the side of any path of access to a puilding if it is not bounded by a wall and any level is more than 1.0 metre (1000mm bove the adjoining floor or finished ground level.

Handrails where installed must be a minimum of 1.0 metre (1000mm) above a floor or anding and a minimum of 865mm above the nosing of a stair or ramp

A Handrail MUST BE located along at least one side of the stairway flight or ramp and be located along the full length of the flight or ramp except in the case of a winder and a newel post is provided and/or where the handrail is associated with a Balustrade. A Handrail would NOT BE required where the flight consist's of 5 riser's or less as the hange in elevation is less than 1.0 metre (1000mm) in height.

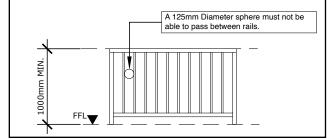

DA - Development Application

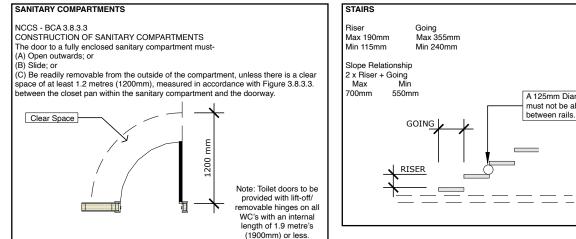

builders note:

check suitability, sizes and colours of window and external door frames before ordering from manufacturer.

check suitability, sizes and performance requirements of glazing before ordering from manufacturer.

check suitability of proposed building materials and products before commencement of any works.

any variations to plans requested by builder or owner must be verified with MB Design & Drafting before commencement of any works. If in doubt, ASK!





Client	Power	Cover Page		Contact:	
Site	35 Beaconsfield Street,			MB Design & Drafting M J Bantick Faulconbridge NSW	Cool
	Newport, NSW, 2106	General information, Area Schedule, 3D image of proposed.	mb design & drafting	0421 759 088 mbdetaildrafting@gmail.com	Scale Unless
Lot	1 D.P. 158869	Illustrations not to scale unless otherwise noted		mbaotanaraning@gmail.com	


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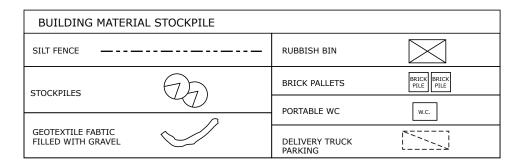
A 125mm Diameter sphere must not be able to pass


Pages List				
P-01	Cover Page			
P-02	Site Plan			
P-03	Waste Management Plan			
P-04	Proposed Deck Plan Level 1			
P-05	Proposed Deck Plan Level 2			
P-06	Section AA			
P-07	South Elevation			
P-08	East and West Elevations			
P-09	Building Codes and Australian Standards			

Area Schedule 603.88 m² Site Survey DP Area Existing Dwelling Footprint 224.20 m Existing Concrete Driveway 38.20 m² Existing Rear Awning (Demolish 42.80 m² Existing In ground Swimming Pool 12.50 m² Existing Swimming Pool Pave 21.72 m² 54.10% 326.92 m² Existing Site Cover 45.90% 276.96 m² Existing Landscape/Soft/Perviou Proposed Concrete Steps 4.50 m² 8.57 m² Proposed Concrete Slab (extended existing slab Proposed Deck Area 35.89 m² 3.98 m Proposed Stairs 1.21 m² Proposed Landing (stair) Proposed Site Cover 56.30% 339.99 m² 43.70% 263.89 m² posed Landscape/So

Drawn by Date of Issue Project Number MJB 2021-14 June 30, 2021 P-01 ale: 1:100 @ A3 Amendments Description ss otherwise noted DA CC Release Alterations & Additions



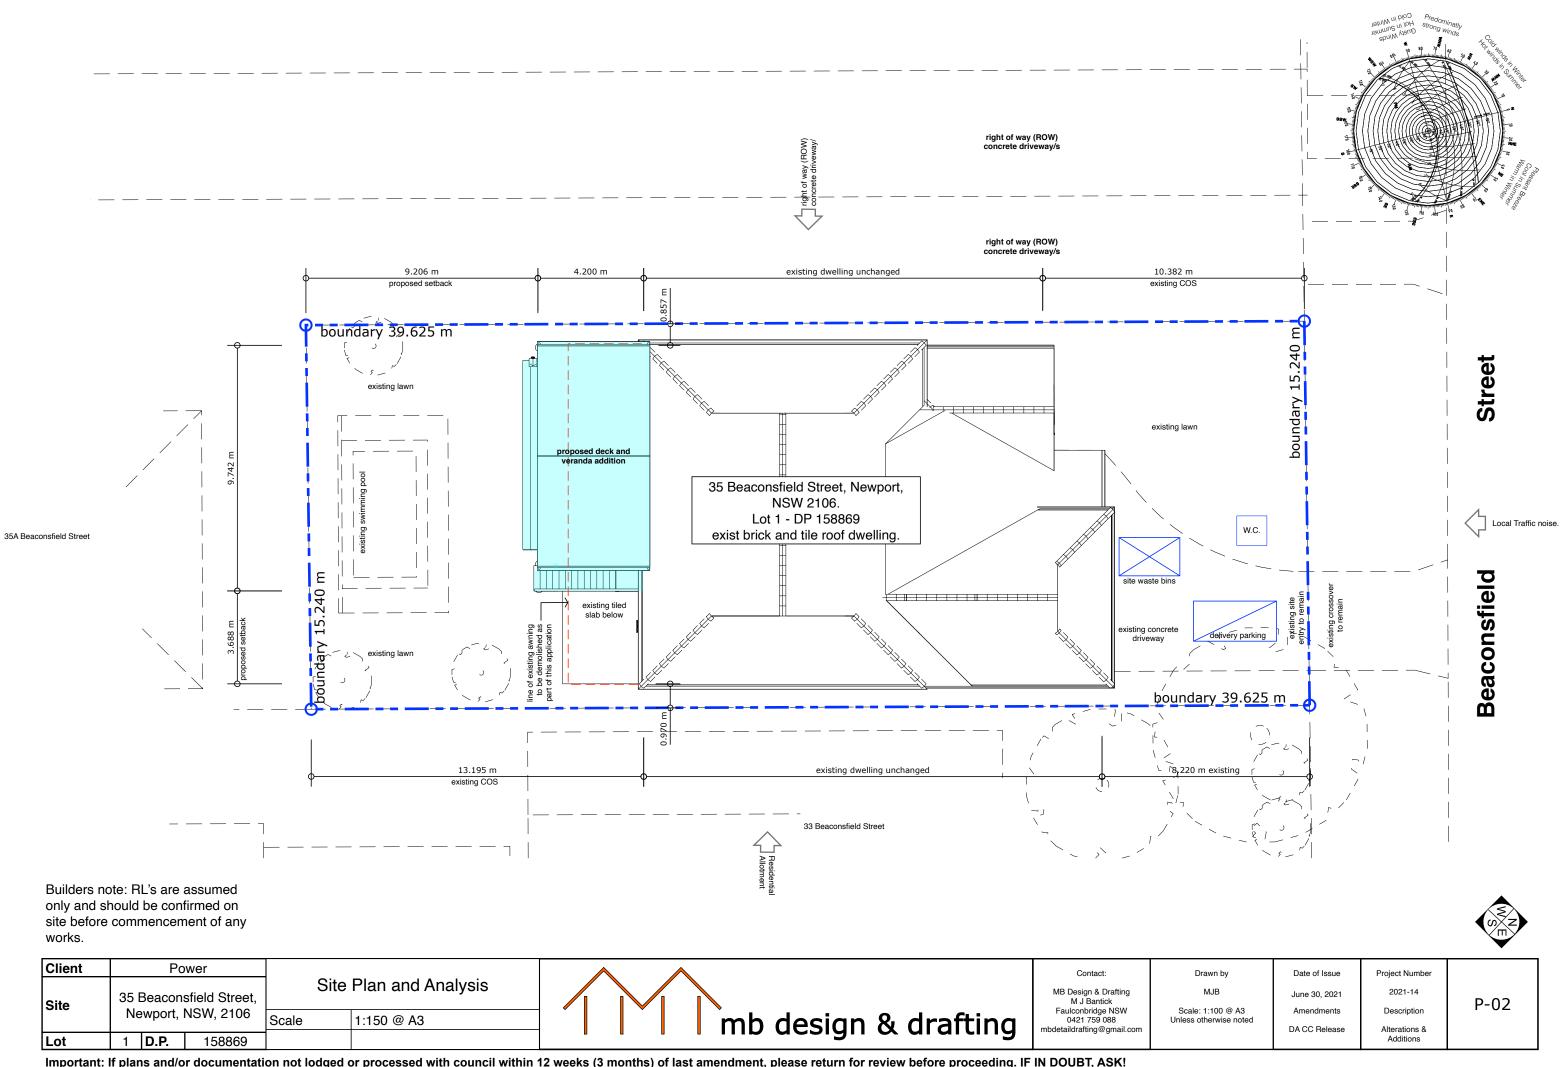

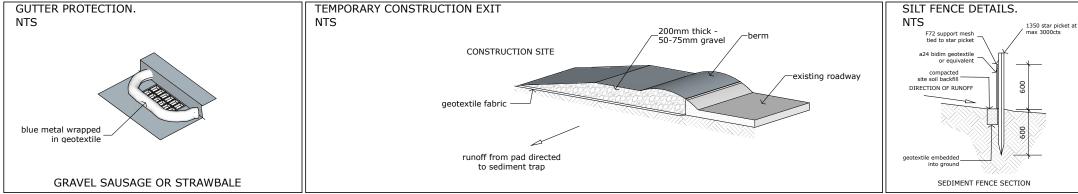

SILT FENCES

-FILTERS SILT FROM LOW TO MEDIUM FLOWS OF SURFACE WATER ON GENTLY SLOPING OR STEEP UNEVEN TERRAIN -CONSIST OF A FILTER FABRIC (GEOTEXTILE FILLER), ATTACHED TO A STEEL MESH OR WIRE CABLE. WHICH IS SUPPORTED ON A STAR PICKETS OR WOODEN POSTS AT 2.5-3m CENTRES -THE LOWER END OF THE FABRIC IS EMBEDDED INTO THE GROUND AS SHOWN -GENERALLY FOLLOW THE CONTOURS OF THE LAND

SILTATION MANAGEMENT PROCEDURE

1. ERECT SILT FENCE AND GRAVEL DRAIN 2. COMMENCE CONSTRUCTION & EARTH WORKS

EXCAVATE BASEMENT AND PLACE TEMPORARY PUMPOUT SEDIMENT PIT (IF REQUIRED) 4. FINISH CONSTRUCTION AND EARTH WORKS

S. SILT FENCE AND GRAVEL DRAIN ARE NOT TO BE REMOVED UNTIL WORKS ARE COMPLETE AND GARDEN HAS BEEN FULLY REVEGITATED

WASTE & RECYCLING MANAGEMENT PLAN

During construction, waste will be separated on site and contained. Hard waste will be removed by appropriate sub contractors for recycling. Asbestos materials to be removed by suitably qualified contractors. Removal and disposal to be to relevant laws, OH&S, codes of practice, Australian Standards & Workcover standards. Disposal to be at a licenced landfill site only. Soft waste will be disposed of through appropriate waste management facilities. All spoil from cut and fill and excavation works shall be either utilised where necessary or evenly spread over the site. Landscaping works are to be completed as soon as possible to assist with siltation, erosion and sediment control.

After occupation it is proposed that the domestic household waste will be stored in council provided bins and collected as part of councils rubbish and recycled collection services.

Pending collection, the bins will be stored on the site away from the public view.

EROSION CONTROL NOTES

1. ALL EROSION AND SEDIMENT CONTROL MEASURES TO BE INSTALLED PRIOR TO SITE DISTURBANCE AND TO BE INSPECTED AND MAINTAINED DAILY BY

SITE MANAGER 2. STRIPPING OF GRASS AND VEGETATION ETC. FROM SITE SHALL BE KEPT TO A

MINIMUM

3. TOPSOIL FROM ALL AREAS THAT WILL BE DISTRIBUTED TO BE STRIPPED AND STOCKPILED AND TO BE KEPT CLEAR FROM DRAINS, GUTTERS AND FOOTPATHS

AND STOCKPTED AND TO BE KEPT CLEAR FROM DRAINS, GUTTERS AND FOUTPATHS
4. DRAINAGE IS TO BE CONNECTED TO STORMWATER SYSTEM AS SOON AS POSSIBLE
5. ROADS AND FOOTPATH TO BE SWEPT AT LEAST DAILY
6. ALL SEDIMENT CONTROL MEASURES TO BE INSPECTED AFTER EACH RAINFALL
EVENT FOR STRUCTURAL DAMAGE AND ALL TRAPPED SEDIMENT TO BE REMOVED TO

A NOMINATED SOIL STOCKPILE

WARNING: HEAVY FINE


IT IS ILLEGAL TO ALLOW SOIL, CEMENT, SLURRY OR OTHER BUILDING MATERIALS TO BE PUMPED, DRAINED OR ALLOWED TO ENTER THE STORMWATER SYSTEM

TELSTRA NOTES:

(REFER FILE RWN 2731 - DATED 15.05.06

-DIAL #1100 "DIAL BEFORE YOU DIG" CARS AND LIGHT TRUCKS ONLY -POTHOLE (HAND EXCAVATION) TO PHYSICALLY LOCATE THE PRESENCE OF TELSTRA -CONDUITS TO AVOID ANY DAMAGE WHEN EXCAVATING FOR THE PROPOSED DRIVEWAY -TELSTRA MANHOLE MUST HAVE A MINIMUM CLEARANCE OF 800mm FROM THE PROPOSED DRIVEWAY LINE LEVELS SURROUNDING THE TELSTRA MANHOLE ON AND WITHIN THE FOOTPATH ARE NOT TO BE ALTERED -TELSTRA MANHOLE AND PITS ARE NOT TO BE DAMAGED -DUTY OF CARE MUST BE ADHERED TO AT ALL TIMES -IF ABOVE REQUIREMENTS CAN NOT BE ACHIEVED CONTACT (02)8851 3732-YOU MUST REFER TO TELSTRA FILE RWN 2731

Client	Power	Waste Management Plan			Contact:	
Site	35 Beaconsfield Street,				MB Design & Drafting M J Bantick	
	Newport, NSW, 2106	Scale	nts	mb design & drafting	Faulconbridge NSW 0421 759 088 mbdetaildrafting@gmail.com	Sca Unless
Lot	1 DP 158869	1			, modelandrahing@gmail.com	

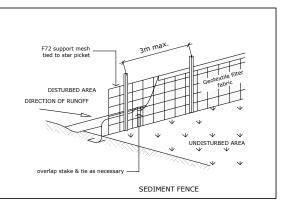

Drawn by

MJB

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June 30, 2021 Amendments DA CC Belease


Date of Issue

Project Number

2021-14

Description


Alterations 8 Additions

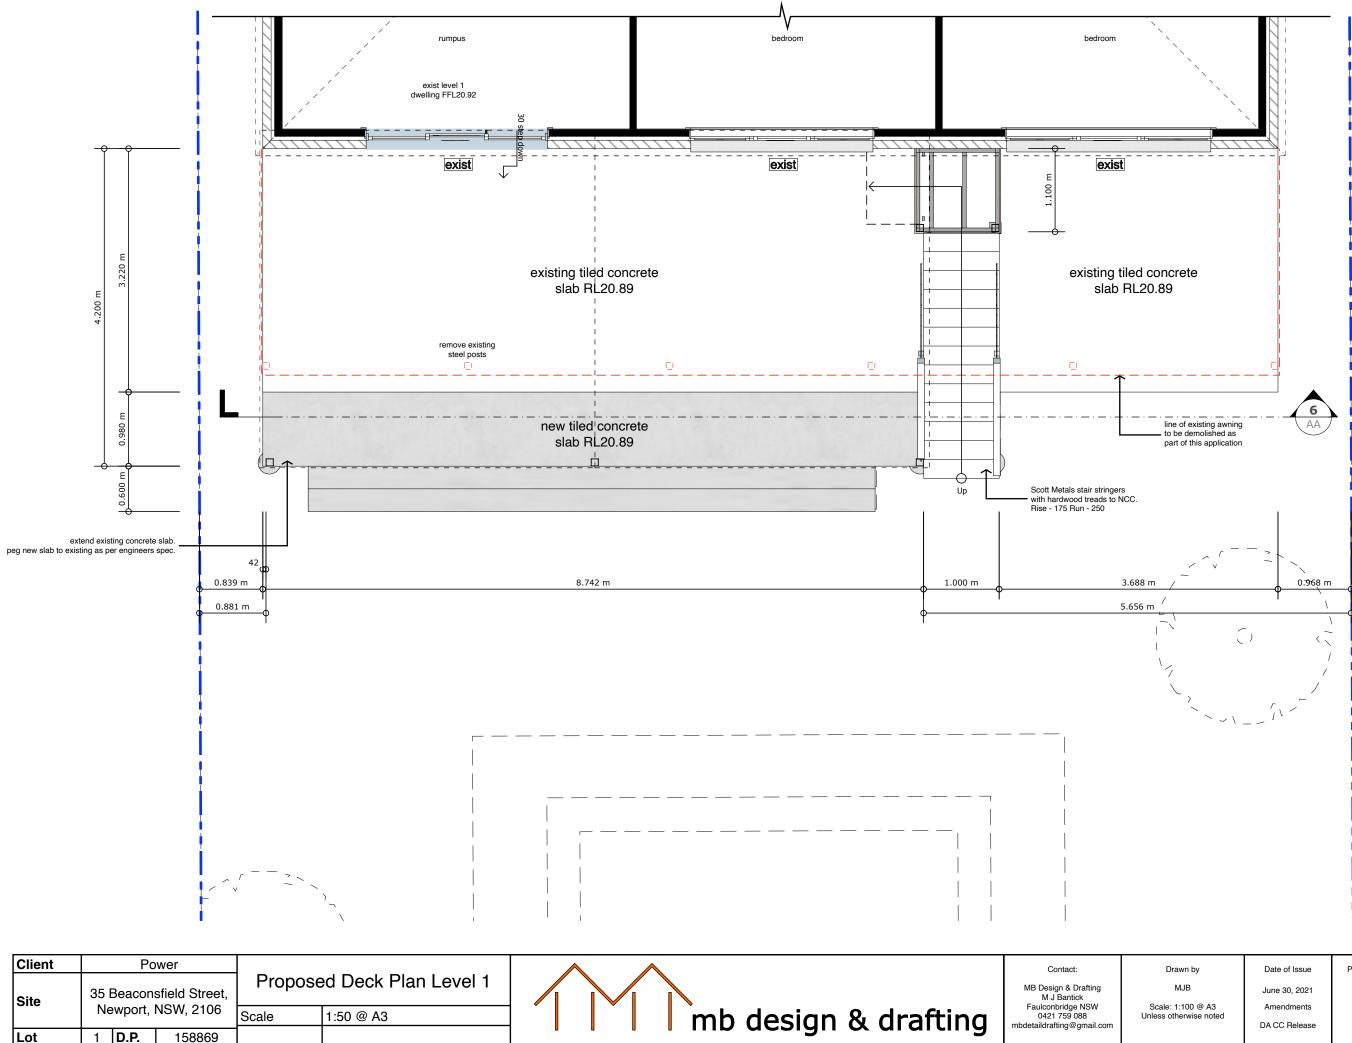

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Lot

Project Number 2021-14 P-04 Description Alterations & Additions

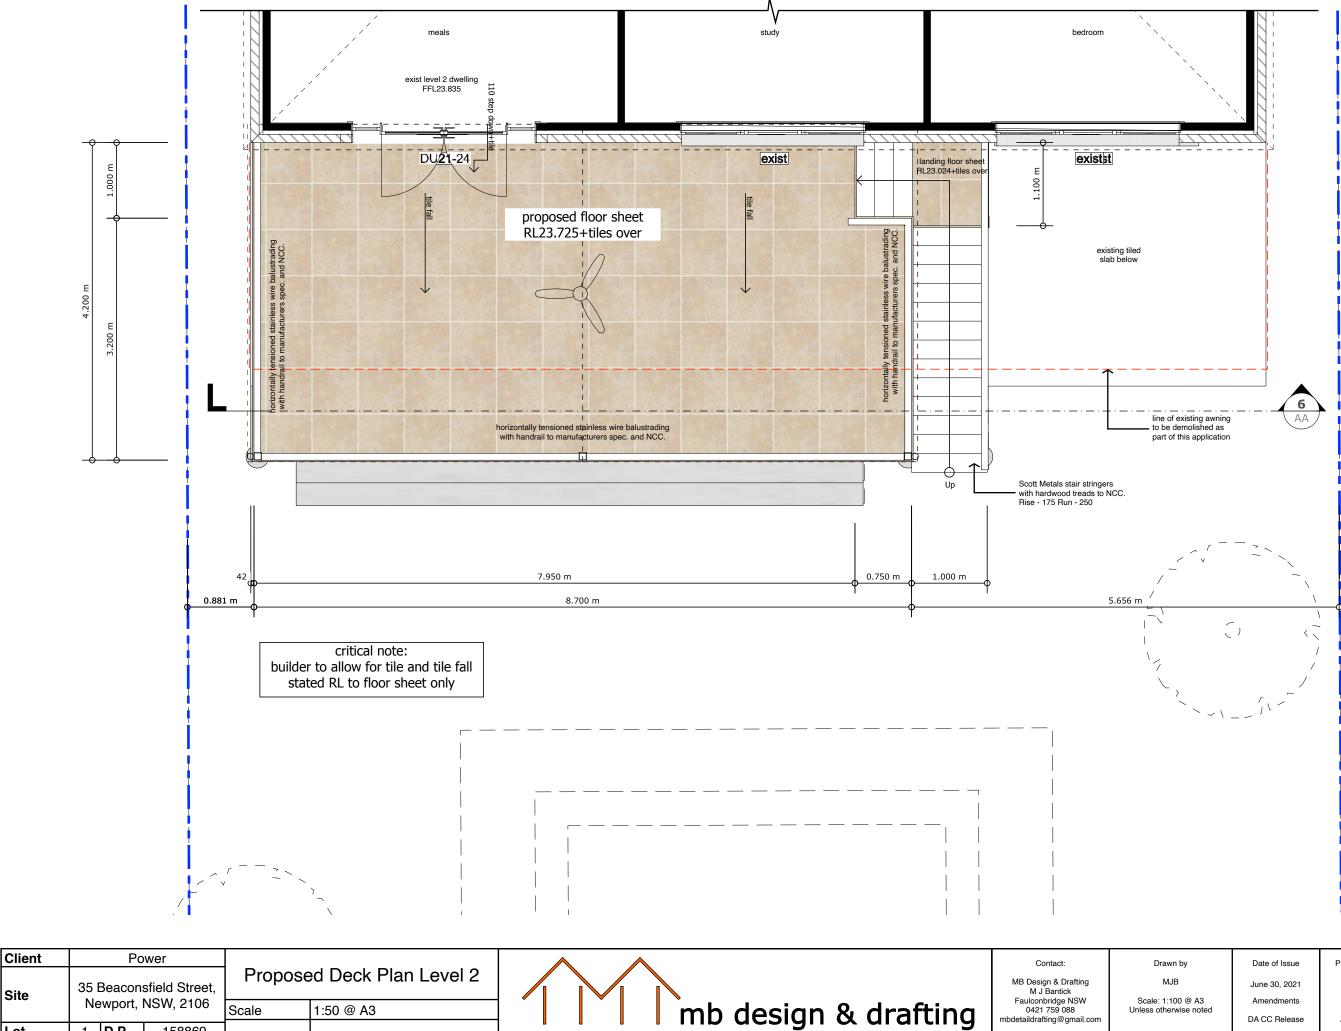

Site

Lot

1 **D.P.**

158869


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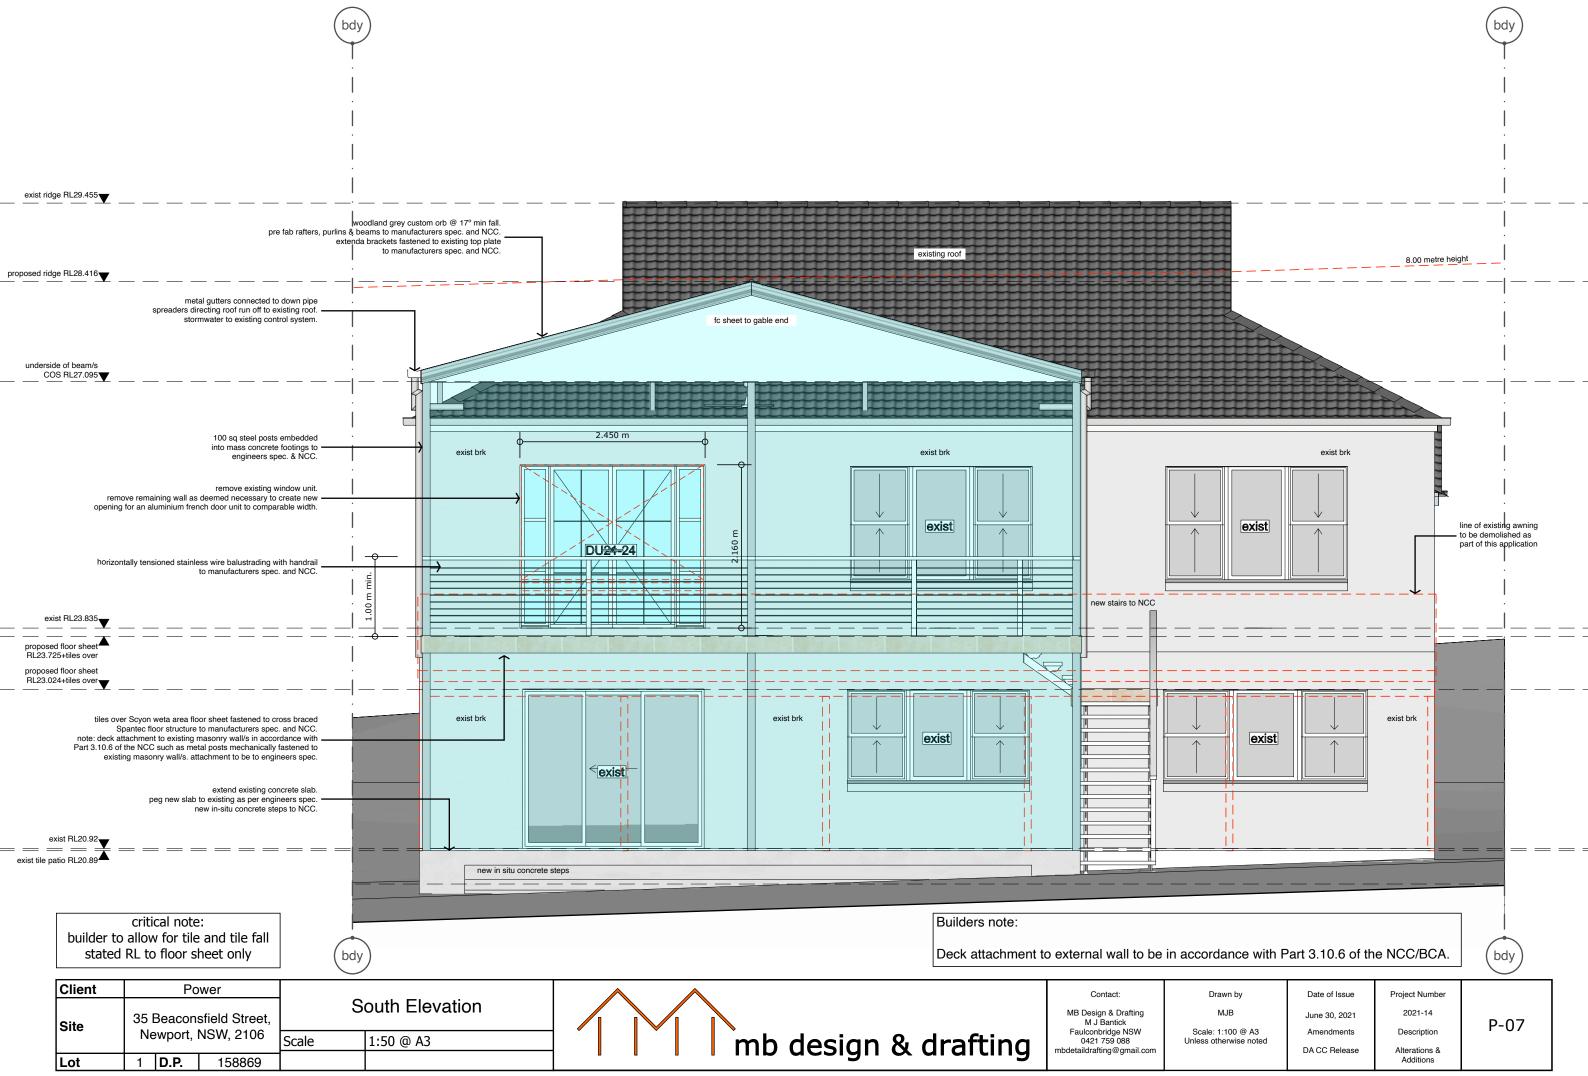
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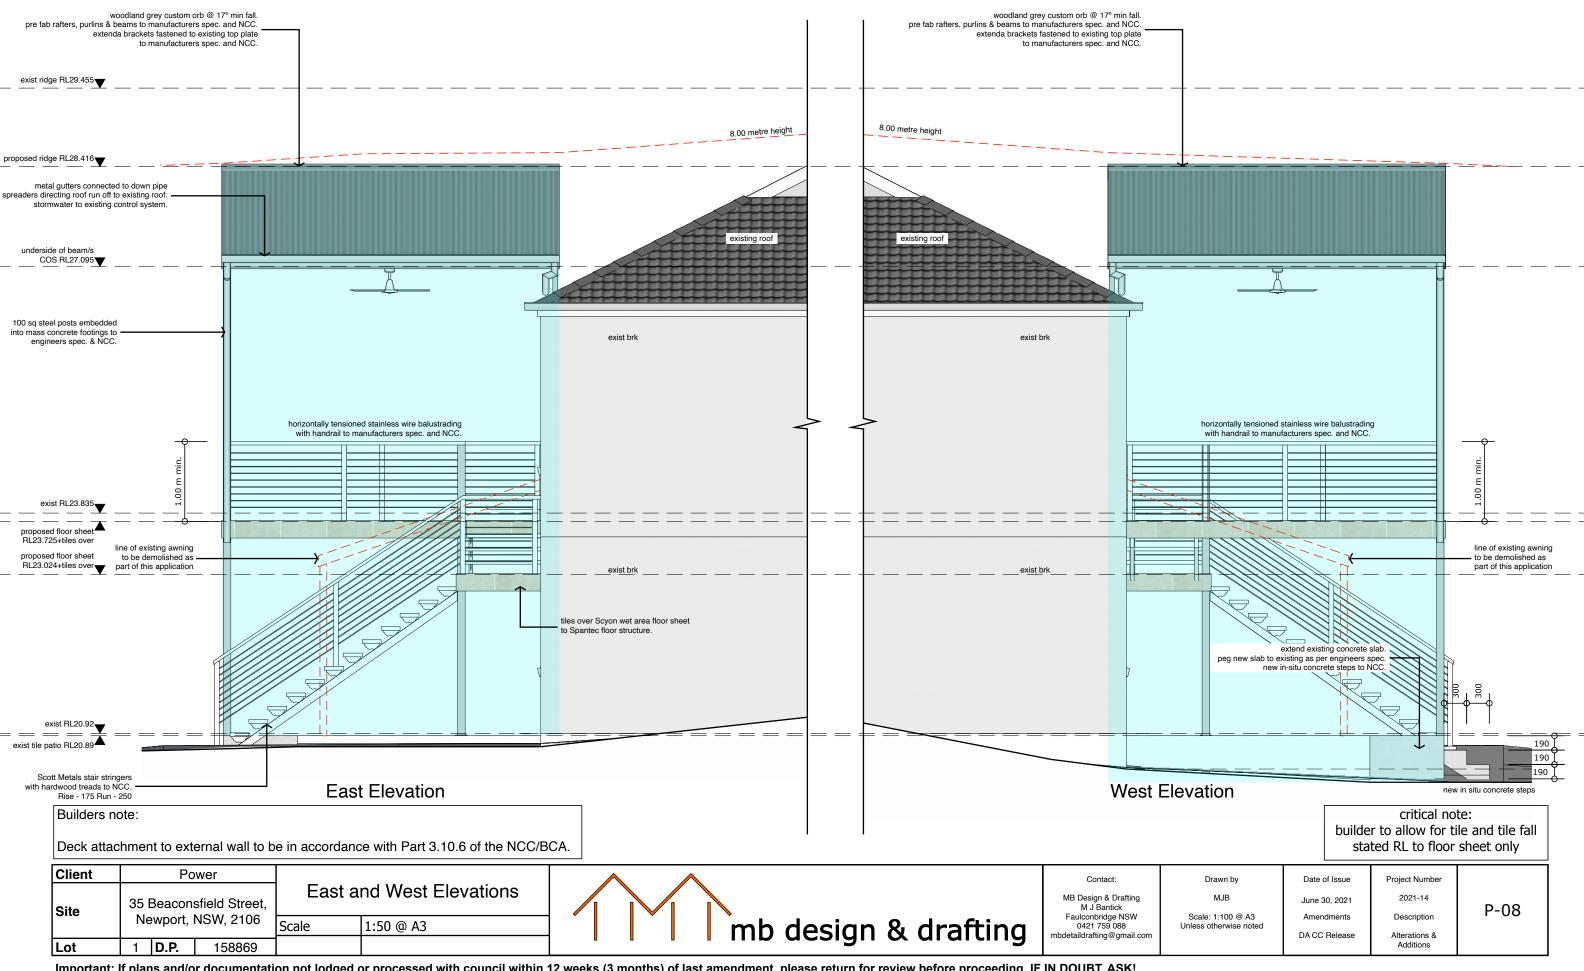
Project Number 2021-14 Scale: 1:100 @ A3 Unless otherwise noted Amendments Description DA CC Release Alterations & Additions

taildrafting@gmail.co

P-05





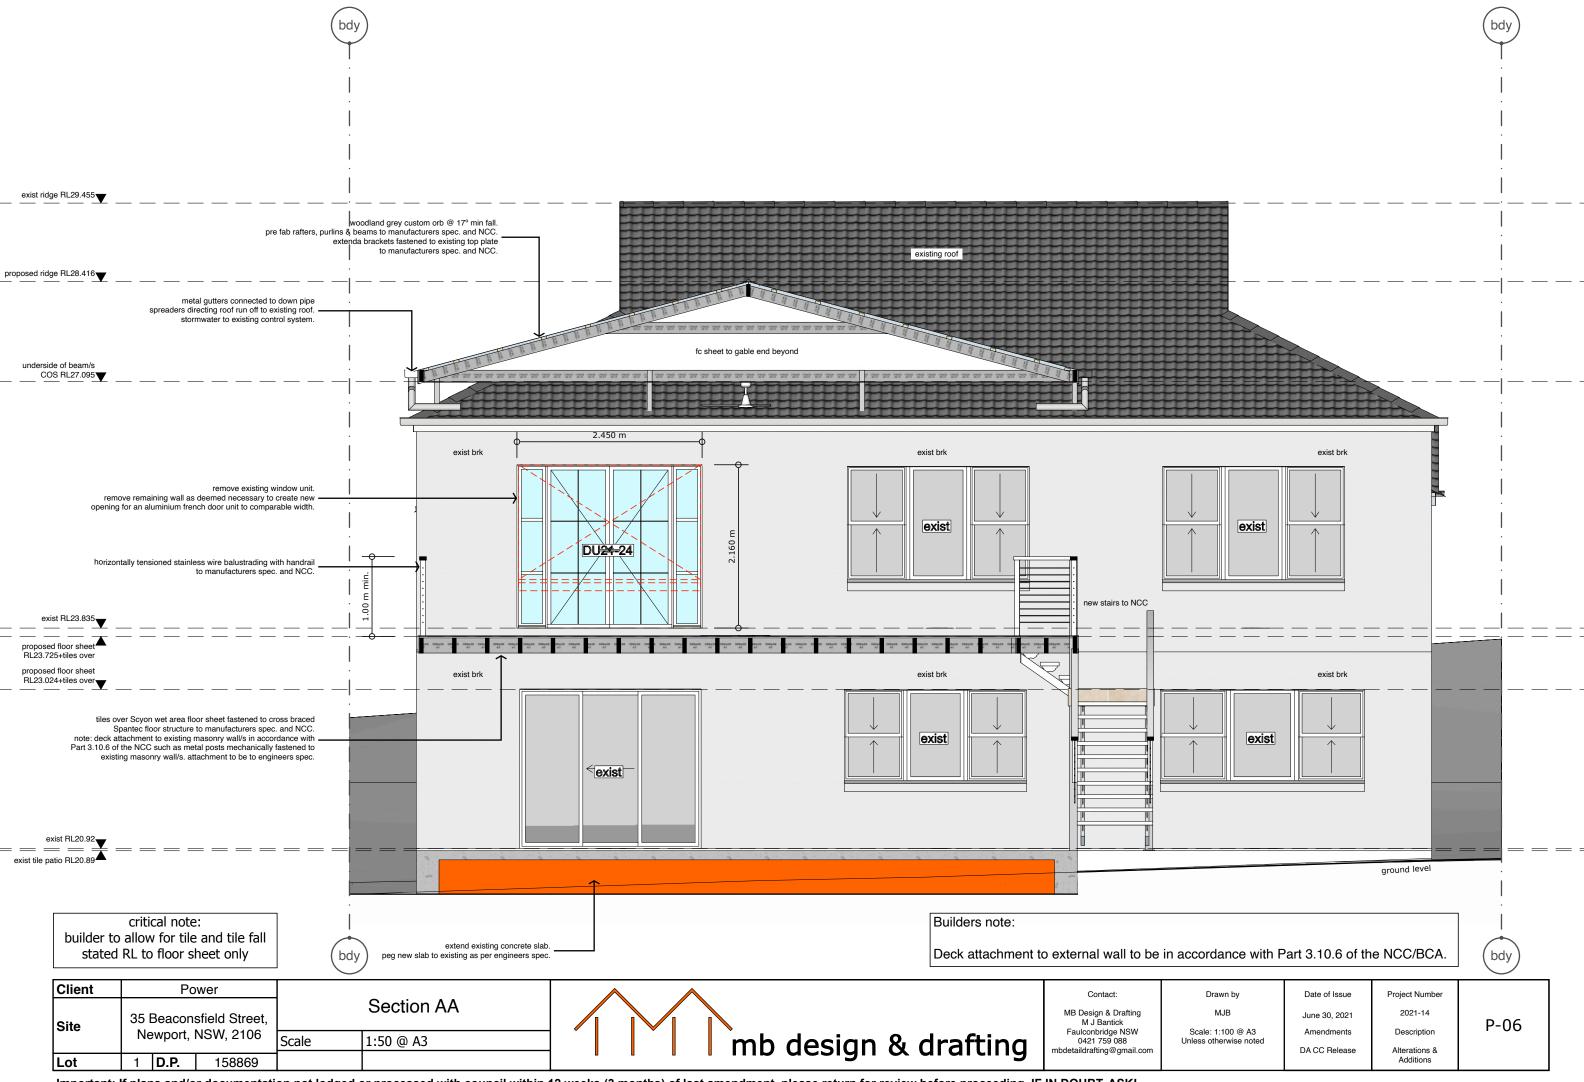

Building Codes

Part 2.0 Application Part 2.1 Structure Part 2.2 Damp and weatherproofing Part 2.3 Fire safety Part 2.4 Health and amenity Part 2.5 Safe movement and access Part 2.6 Energy efficiency Part 2.7 Ancillary provisions and additional construction requirements Section 3 Acceptable Construction Part 3.0 Structural provisions Part 3.1 Site preparation Part 3.1.1 Earthworks Part 3.1.2 Earth retaining structures Part 3.1.3 Drainage Part 3.1.4 Termite risk management Part 3.2 Footings and slabs Part 3.2.2 Preparation Part 3.2.3 Concrete and reinforcing Part 3.2.4 Site classification Part 3.2.5 Footing and slab construction Part 3.3 Masonry Part 3.3.1 Unreinforced masonry Part 3.3.2 Reinforced masonry Part 3.3.3 Masonry accessories Part 3.3.4 Weatherproofing of masonry Part 3.3.5 Masonry veneer Part 3.3.6 Isolated masonry piers Part 3.4.0 Framing Part 3.4.1 Subfloor ventilation Part 3.4.2 Steel framing Part 3.4.3 Timber framing Part 3.4.4 Structural steel members Part 3.5 Roof cladding, gutters and downpipes and wall cladding

Part 3.5.1 Sheet roofing Part 3.5.2 Roof tiles and shingles Part 3.5.3 Gutters and downpipes Part 3.5.4 Timber and composite wall cladding Part 3.5.5 Metal wall cladding

Part 3.6 Glazing

Part 3.7 Fire Safety Part 3.7.1 Fire properties for materials and construction Part 3.7.2 Fire separation of external walls Part 3.7.3 Fire protection of separating walls and floors Part 3.7.4 Fire separation of garage top dwellings Part 3.7.5 Smoke alarms and evacuation lighting

Part 3.8 Health and Amenity Part 3.8.1 Wet areas and external waterproofing Part 3.8.2 Room heights Part 3.8.3 Facilities Part 3.8.4 Light Part 3.8.5 Ventilation Part 3.8.6 Sound insulation Part 3.8.7 Condensation management Part 3.9 Safe Movement and Access

Part 3.9.1 Stairway and ramp construction Part 3.9.2 Barriers and handrails

Part 3.10 Ancillary Provisions and Additional Construction Requirements Part 3.10.1 Swimming pools Part 3.10.2 Earthquake areas Part 3.10.3 Flood hazard areas Part 3.10.4 Construction in alpine areas Part 3.10.5 Construction in bushfire prone areas Part 3.10.6 Attachment of decks and balconies to external walls of buildings Part 3.10.7 Boilers, pressure vessels, heating appliances, fireplaces, chimneys and flues

Part 3.12 Energy Efficiency Part 3.12.1 Building fabric Part 3.12.2 External glazing Part 3.12.3 Building sealing Part 3.12.4 Air movement Part 3.12.5 Services

Australian Standards

AS 2601 - THE DEMOLITION OF STRUCTURES AS 3660.1 - PROTECTION OF BUILDING FROM SUBTERAINIAN TERMITES AS 2870 - RESIDENTIAL SLABS AND FOOTINGS AS 3600 - CONCRETE STRUCTURES AS 2159 - PILING - DESIGN AND INSTALLATION AS 3700 AND/OR AS 4773 - MASONRY CODE AS 1250 - THE USE OF STEEL IN STRUCTURES AS 3623 - DOMESTIC STEEL FRAMING AS 4100 - STEEL STRUCTURES AS 1684 - RESIDENTIAL TIMBER FRAME CONSTRUCTION AS 1720.10 - TIMBER STRUCTURES CODE. AS 2049 - ROOF TILES AS/NZS 3500 PART 3.2 - STORMWATER DRAINAGE AS/NZS 3500 PART 3.2 - DOMESTIC INSTALLATION - SECTION 5 - STORMWATER DRAINAGE AS1288 - GLASS IN BUILDINGS AS 2047 - WINDOWS IN BUILDINGS AS 3786 - SMOKE ALARMS AS 2918 - DOMESTIC SOLID FUEL BURNING APPLIANCES - INSTALLATION

AS 3740 - WATERPROOF OF WET AREAS IN RESIDENTIAL BUILDING

AS 1170.1 - DEAD AND LIVE LOADS AND LOAD COMBINATIONS AS 1170.2 AND/OR AS 4055 - WIND LOADS

AS 1120.1 - TIMBER STRUCTURE CODES

AS 2327.1 - COMPOSITE CONSTRUCTION IN STEEL AND CONCRETE

TERMITE PROTECTION NOTE:

UPON INSTALLATION OF A TERMITE MANAGEMENT SYSTEM, A DURABLE NOTICE IS TO BE **DISPLAYED WITHIN THE METER BOX.**

THE NOTICE SHALL INDICATE:

1) THE METHOD OF PROTECTION USED.

2) DATE OF INSTALLATION.

3) LIFE EXPECTANCY OF ANY CHEMICAL SYSTEM USED AS LISTED ON THE NATIONAL REGISTER LABEL, AND

FREQUENCY OF FUTURE INSPECTIONS FOR TERMITE ACTIVITY.

Client	Power	Building Codes and		Contact:	Drawn by
Site	35 Beaconsfield Street,	Australian Standards		MB Design & Drafting M J Bantick Faulconbridge NSW 0421 759 088 mbdetaildrafting@gmail.com	MJB Scale: 1:100 @ A3 Unless otherwise noted
	Newport, NSW, 2106	Scale nts	mb design & drafting		
Lot	1 D.P. 158869			mbdetaildraning@gmail.com	

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4) THE INSTALLATION OF MANUFACTURERS RECOMMENDATION'S FOR THE SCOPE AND

Date of Issue June 30, 2021 Amendments DA CC Belease Project Number 2021-14

Description Alterations & Additions

P-09