DA L A N D S C A P E PLAN

37-43 Hay Street Collaroy NSW 2097



LOCATION PLAN



GENERAL NOTES

All work to be carried out in accordance with the Building Code of Australia, all Local and State Government Ordinances, relevant Australian Standards, Local Authorities Regulations and all other relevant Authorities concerned.

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This shall include r.c. slabs and footings, r.c. All structural work and site drainage to be subject to Engineer's details or certification where required by Council. This shall include r.c. slabs and footings, r.c. and steel beams & columns, wind bracing to AS 1170 and AS4055, anchor rods or bolts, tie downs, fixings etc., driveway slabs and drainage to Council's satisfaction. All timbers to be in accordance with SAA Timber Structure Code AS1720 and SAA Timber Framing Code AS 1684. All work to be carried out in a professional and workman- shiplike manner according to the plans

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COLLAROY LIVING RESIDENCES DA LANDSCAPE Project 37-43 Hay Street Collaroy NSW 2097 Address Date 07/03/2024 Drawing Title TITLE PAGE Scale N.T.S@A1

LANDSCAPE MAINTENANCE NOTES

MONTH	MOWING EDGING BLOWING	FERTILISING (SEASOL)	CHECK	HAND WEED REMOVAL	PRUNING	WEED SPARAYING	WATERING/ IRRIGATION	PLANT REPLACEMENT IF REQUIRED
DEC	W	М	М	W	F	М	D	W
JAN	W	М	M	W	F	М	D	W
FEB	W	М	М	W	F	М	D	W
MAR	F	М	М	F	М	М	D	W
APR	F	N/A	М	F	М	М	D	W
MAY	F	N/A	М	М	М	М	D	W
JUNE	М	N/A	М	M	N/A	N/A	2ND D	W
JULY	М	N/A	М	M	N/A	N/A	2ND D	W
AUG	M	N/A	М	М	N/A	N/A	2ND D	W
SEP	M	М	М	М	N/A	N/A	2ND D	W
ОСТ	F	F	М	F	М	М	D	W
NOV	F	F	М	F	M	М	D	W

DRAWING LIST

Sheet Number	Sheet Title	Date of Current						
L-00	TITLE PAGE	07/03/2024						
L-01	LEVEL 1 LANDSCAPE PLAN	07/03/2024						
L-02	LEVEL 2 LANDSCAPE PLAN	07/03/2024						
L-03	LANDSCAPE AREA CALCULATION PLAN - LEVEL 1	07/03/2024						
L-04	LANDSCAPE AREA CALCULATION PLAN - LEVEL 2	07/03/2024						
L-05	PLANTING SCHEDULE AND DETAILS	07/03/2024						
L-06	SPECIFICATION	07/03/2024						


07/03/24 DA ISSUE ISSUE DATE COMMENT

Drawing No.**1500**

AMENDMENTS

Page

L-00

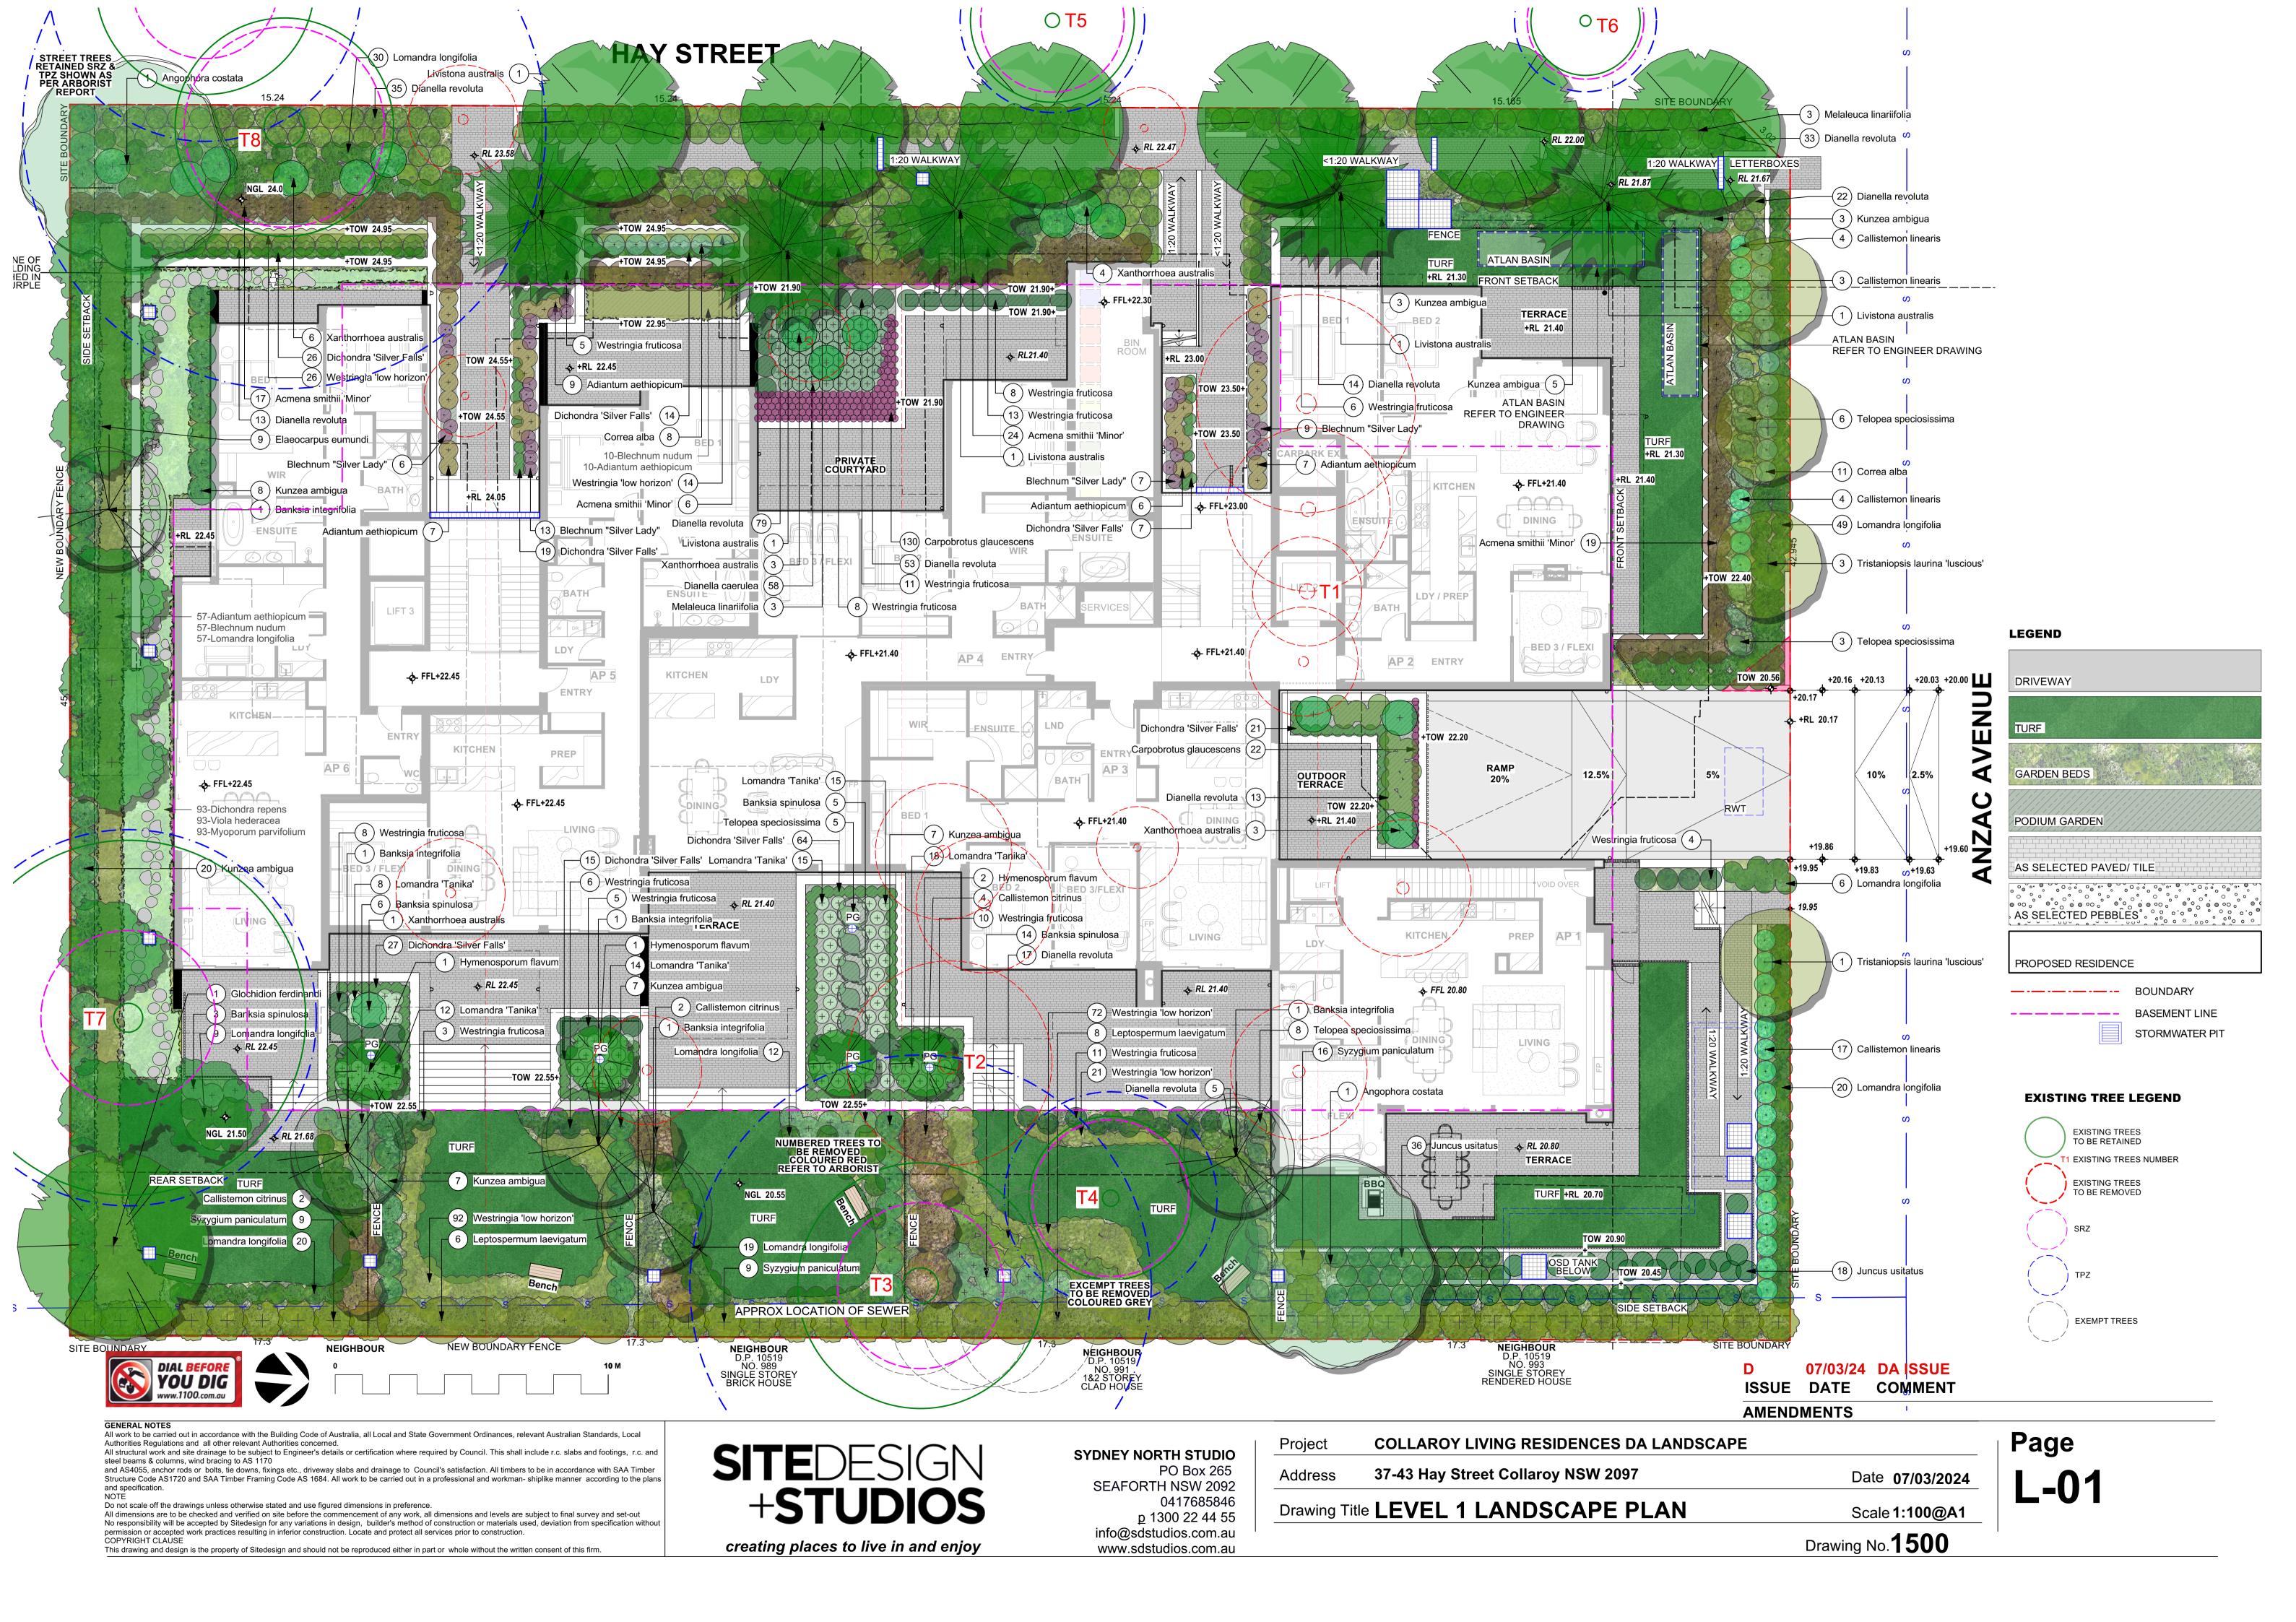

HAY STREET



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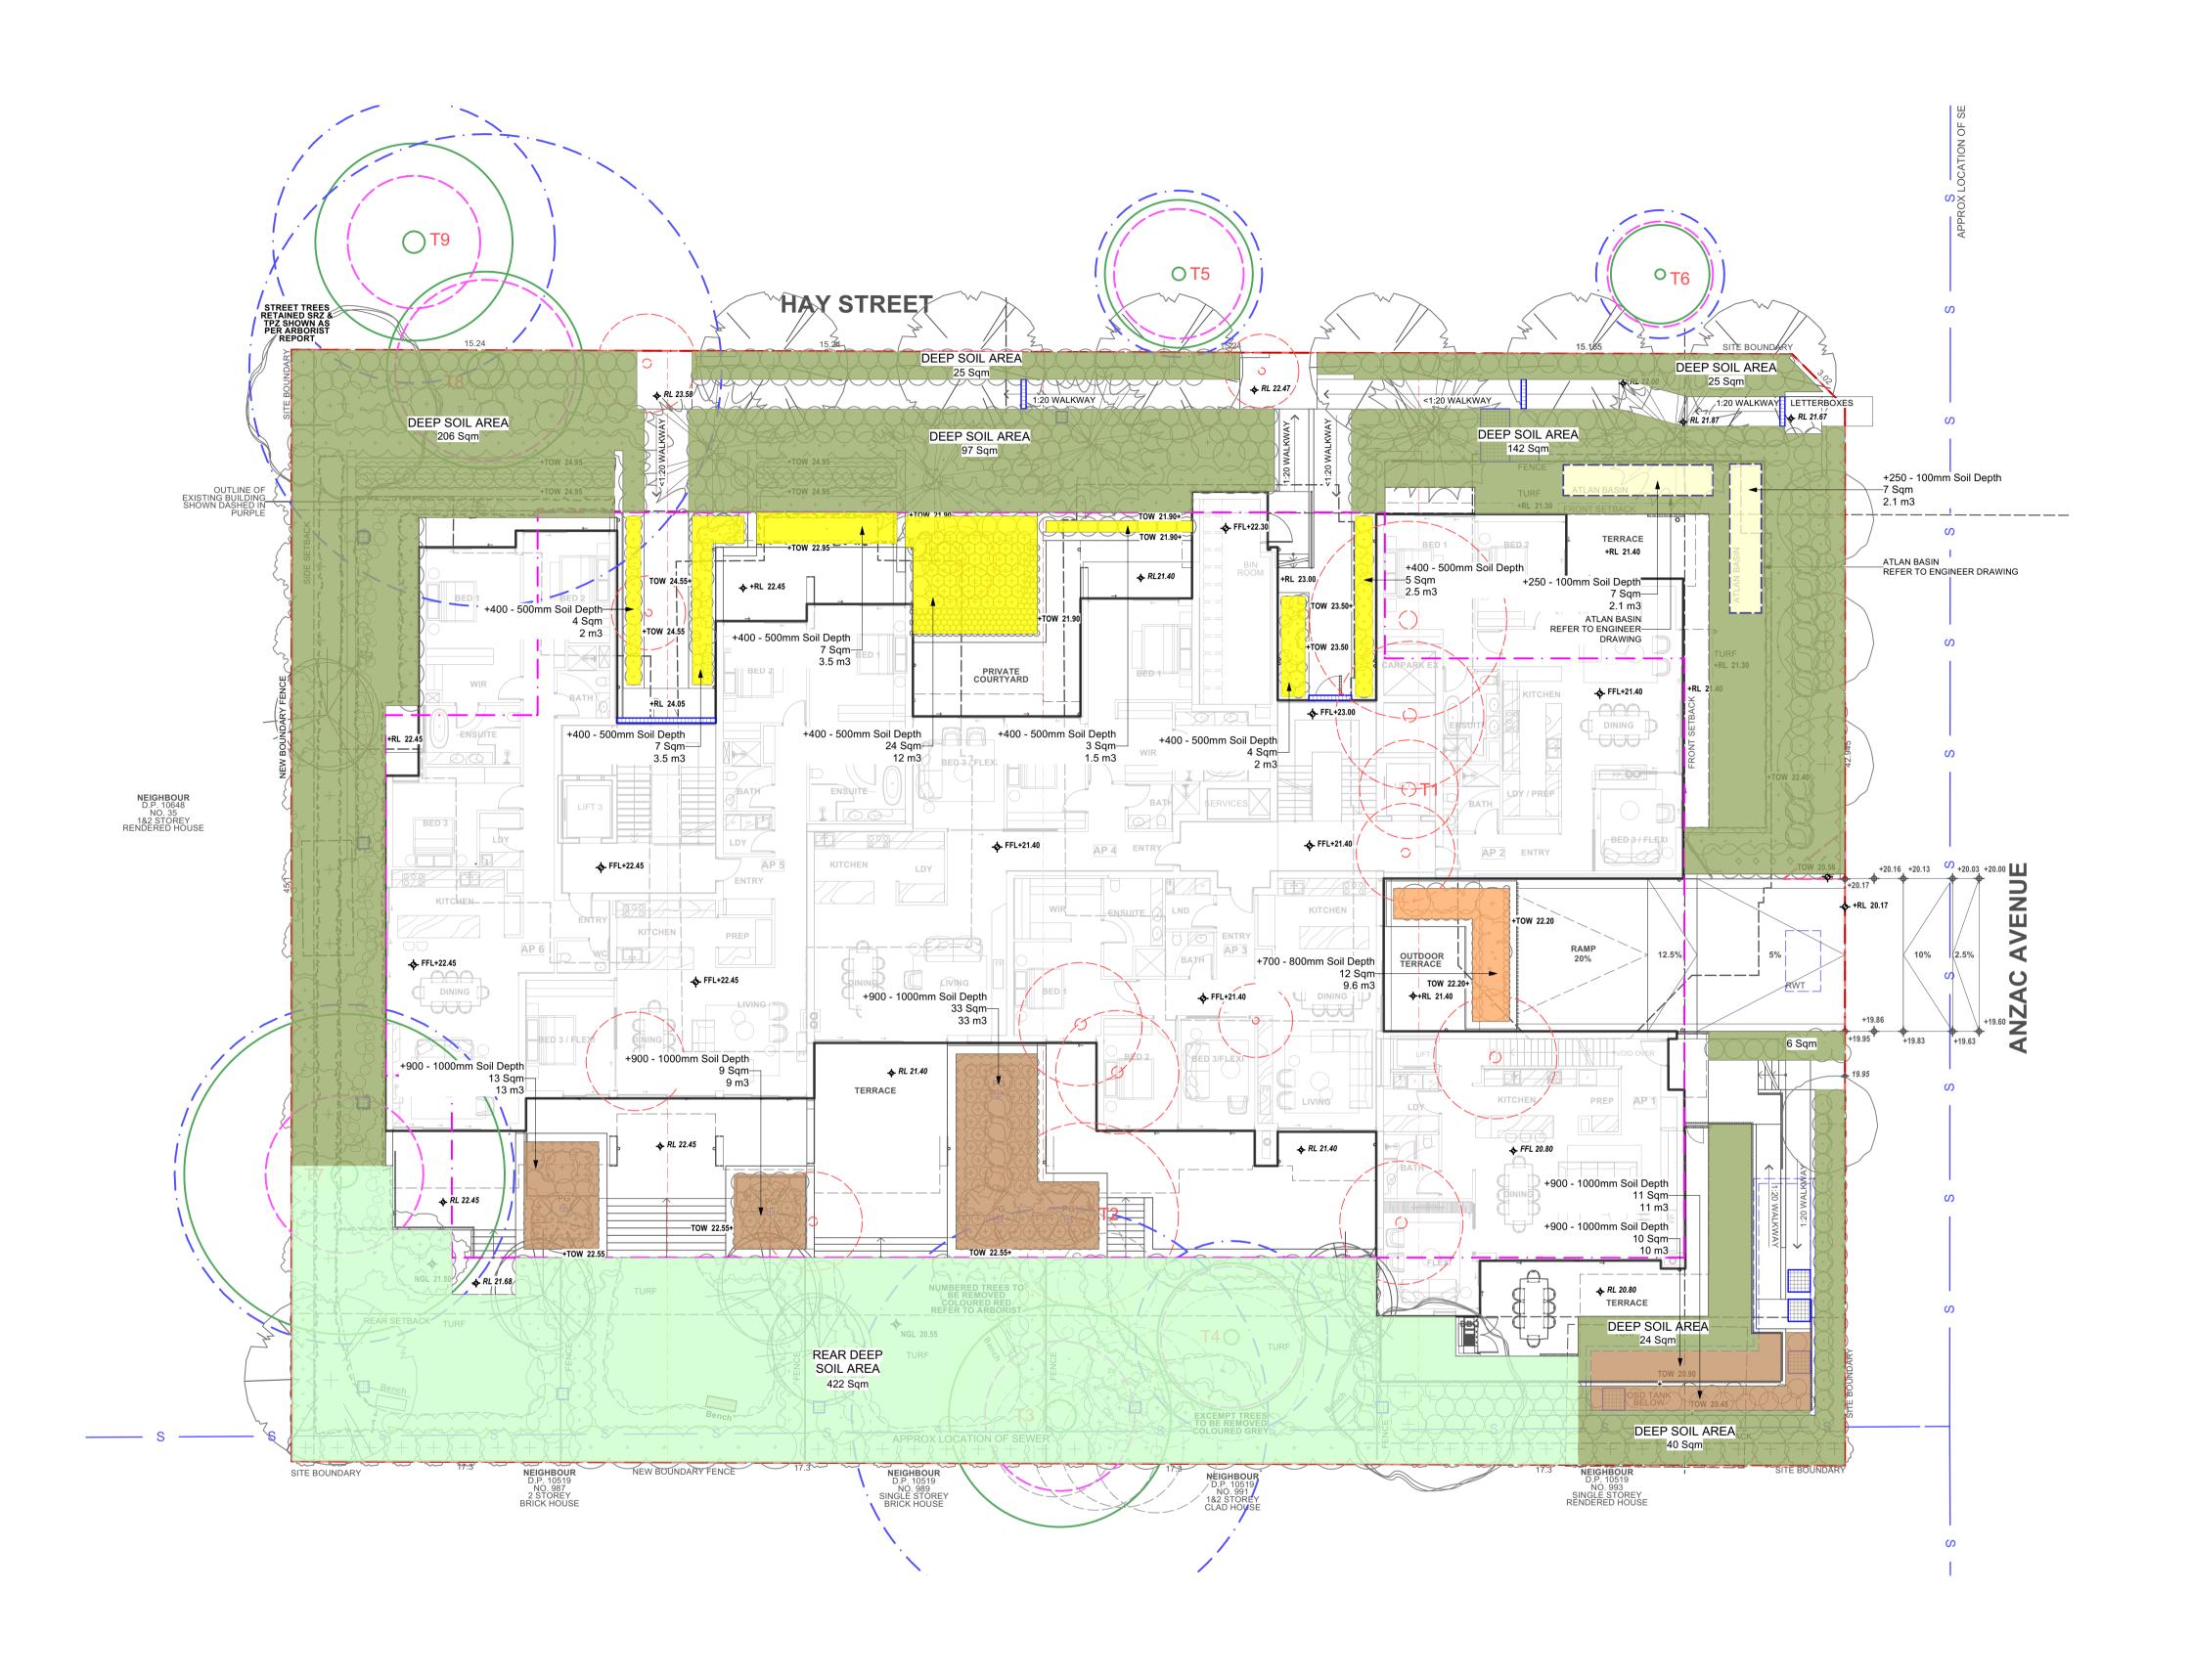
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Drawing No.**1500**



DEEP SOIL CALCULATION

: 15% sqm Control : 425.87 Sqm Required sqm : 565 Sqm Achieved Complies : yes

REAR DEEP SOIL CALCULATION

: 65% of 15% sqm Control : 276.81 Sqm Minimum sqm : 422 Sqm Achieved sqm Complies : yes

LANDSCAPE CALCULATION

Total Site Area : 2839.1 Sqm Total Landscaped on structure : 156 + 71 Sqm (Level 1 + Level 2) = 227 Sqm : 565 Sqm Deep Soil Area Rear Deep Soil Area : 422 Sqm Total Landscaped Area = 1214 Sqm or 42.76% of Total Site Area Council Deep Soil Requirement is 30 % Complies

KEY

250-300MM SOIL DEPTH 400-500MM SOIL DEPTH 600-800MM SOIL DEPTH 900-1000MM SOIL DEPTH DEEP SOIL ZONE

EXISTING TREE LEGEND

REAR DEEP SOIL ZONE

EXISTING TREES TO BE RETAINED 1 EXISTING TREES NUMBER **EXISTING TREES** TO BE REMOVED **EXEMPT TREES**

07/03/24 DA ISSUE

ISSUE DATE COMMENT

AMENDMENTS

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Project

37-43 Hay Street Collaroy NSW 2097 Address Drawing Title LANDSCAPE AREA CALCULATION PLAN Scale 1:100@A1

COLLAROY LIVING RESIDENCES DA LANDSCAPE

- LEVEL 1 Drawing No.**1500**


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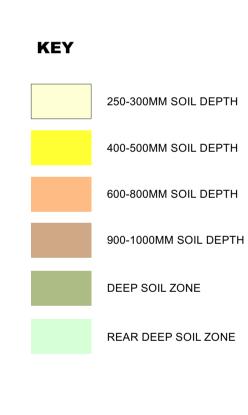
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L-03 Date 07/03/2024


CALCULATION

Total Site Area : 2839.1 sqm Total Landscaped on structure : 71 Sqm



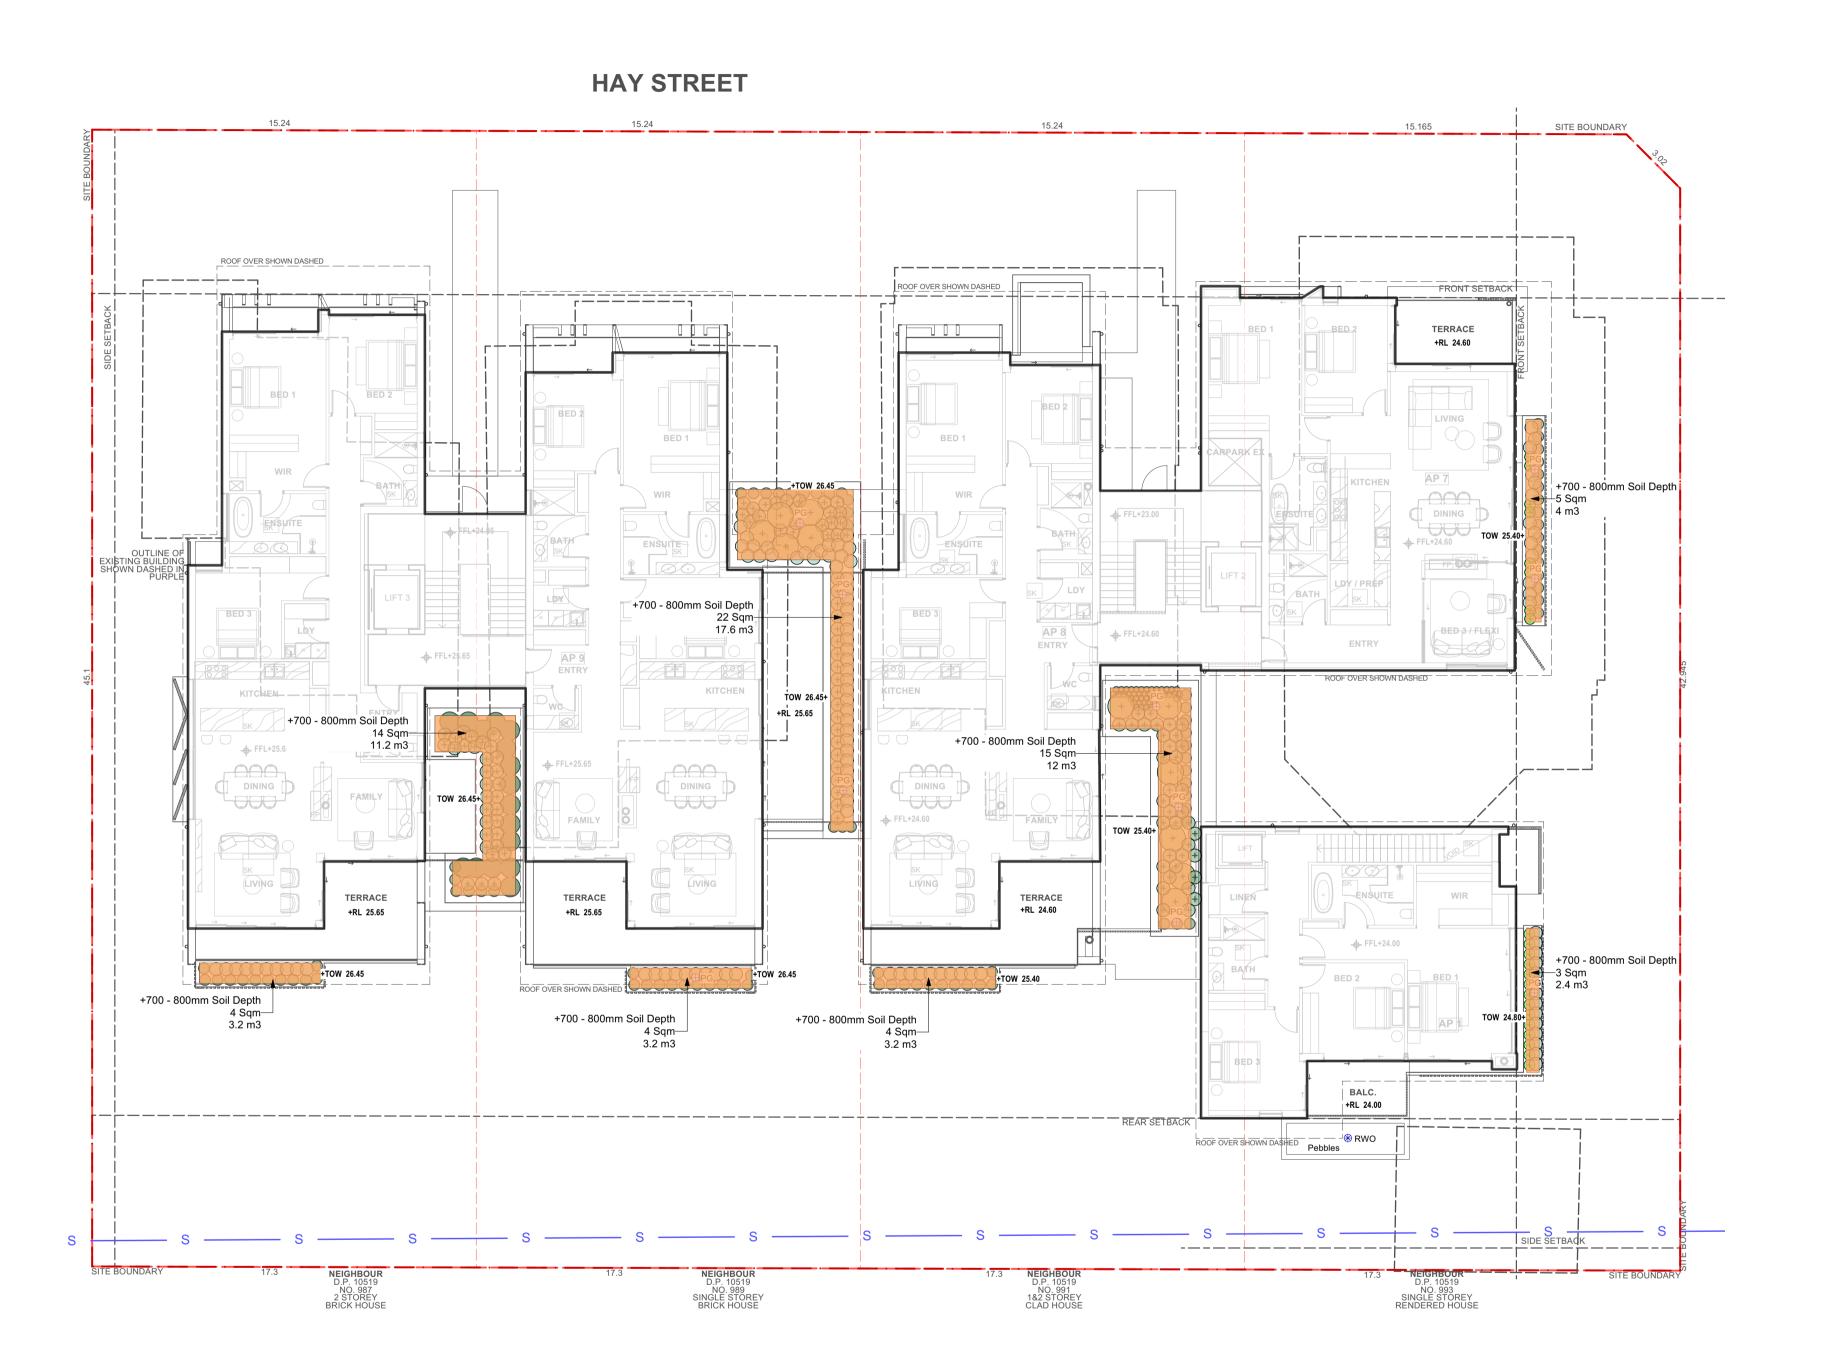

EXISTING TREE LEGEND

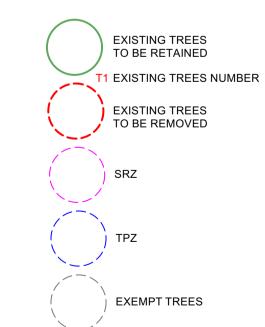





07/03/24 DA ISSUE

Drawing No.**1500**

ISSUE DATE COMMENT **AMENDMENTS**

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COLLAROY LIVING RESIDENCES DA LANDSCAPE Project 37-43 Hay Street Collaroy NSW 2097 Address Date 07/03/2024 Drawing Title LANDSCAPE AREA CALCULATION PLAN Scale 1:100@A1

- LEVEL 2

Page

Plant List Scheduled Size | Mature Height | Mature Spread Qty Common Name **Botanical Name** Trees 2 Sydney Red Gum, Smooth-barked Apple 'N' Angophora costata 45L 15 - 20m 6 - 10m **ACost** Coastal Banksia 'N' 45L Banksia integrifolia 8m 3m 2.0 - 3.5m 6 - 10m EE Smoothed leaved Quandong 'N' Elaeocarpus eumundi 45L Glo-fer Cheese Tree 'N' Glochidion ferdinandi 45L 5 - 10m 6 - 10m Native frangipani 'N' 45L 6m 2.5m 4 Hymenosporum flavum 45L 10m Cabbage-tree Palm 'N' Livistona australis 3m Flax-leaved Paperbark 'N' Melaleuca linariifolia 45L 5 - 10m 6 - 10m 200mm 5 - 10m Magenta Lillypilly 'N' 6 - 10m Syzygium paniculatum TLaur-lus Kanooka, Water Gum 'N' Tristaniopsis laurina 'luscious' 45L 6 - 10m 3.5 - 6m Shrubs 200mm 2-3m Lillypilly 'N' Acmena smithii 'Minor' 2m Acm-smi 28 Hairpin Banksia 'N' 0.9 - 1.2m Ban-spi Banksia spinulosa 200mm 0.9 - 1.5m 45L 2.0 - 3.5m Scarlet Bottlebrush 'N' Callistemon citrinus 3 - 5m Cal-cit cal-lin 28 Narrow-leaved Bottlebrush 'N' Callistemon linearis 200mm 1.5 - 3m 0.6 - 0.9m White Correa 'N' 200mm 0.9 - 1.5m 0.9 - 1.2m Correa alba 100 'Blue Bird' Crassula arborescens 'Bluebird' 150mm 0.0 - 0.3m 0.3 - 0.6m Cra-arb Kun-amb 60 Tick Bush 'N' Kunzea ambigua 200mm 1.5 - 3m 1.2 - 2.0m 300mm 14 Coast Tea-Tree 'N' Leptospermum laevigatum 1.5 - 4m 1.2 - 2.0m 1.5 - 3m 200mm 0.9 - 1.2m Waratah 'N' Telopea speciosissima Wes-fru 114 Coastal Rosemary 'N' 200mm 0.6m 0.9m Westringia fruticosa **Ground Covers** Common Maidenhair 'N' Adiantum aethiopicum 200mm 0.3 - 0.45m 0.0 - 0.3mAga-att 11 lion's tail Agave attentuata 150mm 0.75 - 0.9m 0.5 - 1.2m 35 Fishbone Water Fern 'N' Blechnum "Silver Lady" 150mm 0.75 - 0.9m 0.3 - 0.6m 67 Fishbone Water Fern 'N' 150mm 0.75 - 0.9m 0.3 - 0.6m ble-nud Blechnum nudum 152 Coastal Moonflower, Pigface, Iceplant 'N' Carpobrotus glaucescens 150mm 0.0 - 0.3m 1.2 - 2.0m 150mm 0.0 - 0.3m 1.2 - 2.0m cas'ci' 87 Casuarina "Cousin It' Casuarina "Cousin It' 93 Kidney Weed 'N' Dichondra repens 150mm 0.0 - 0.3m 0.9 - 1.2m Dic-rep 193 Silver falls kidney weed Dichondra 'Silver Falls' 150mm 1.2m 0.5m dic-sf 150mm 0.45 - 0.6m Myo-par 136 Carpet Spreading Myoporum 'N' Myoporum parvifolium 0.3m22 Blue Chalk Sticks 150mm 0.15m 0.5m Senecio mandraliscae sen-ma 0.8m vio-he 93 Native Violet 'N' Viola hederacea 150mm 0.2m wes-lh' coastal rosmary 'N' Westringia 'low horizon' 150mm 0.4m 0.8m Grasses 170 Blue Flax-lily 'N' Dianella caerulea 150mm 0.4m 0.6m Dia-cae 0.3 - 0.6m 284 Spreading Flax Lily 'N' Dianella revoluta 150mm 0.3 - 0.45m Dia-rev-lr 150mm 0.8m 54 tussock grass 'N' Juncus usitatus 1m 150mm Spiny-headed Mat-Rush 'N' 0.6m 0.8m Lom-lon Lomandra longifolia 82 Fine-leaved mat rush 'N' Lomandra 'Tanika' 150mm 0.5m 0.6m lom-ta 17 Grass Tree 'N' Xan-arb 300mm 1m 1m Xanthorrhoea australis 2568 Total NOTE:

'Blue Bird'









Bottlebrush



Livistona australis

Cabbage Tree Palm

Callistemon linearis

Narrow-leaved bottlebrush

Adiantum aethipicum

Common maidenhair



Correa alba

White correa

Agave attenuata

Lion's tail

Melaleuca linariifolia Fine Leafed Paperbark

COMPLETION AND THE DATE OF FINAL COMPLETION.

LANDSCAPE MAINTENANCE NOTES

MAINTENANCE AND ESTABLISHMENT AFTER PRACTICAL COMPLETION HAS BEEN CONFIRMED. SITE CONTROL: REPORT TO THE PRINCIPAL'S DESIGNATED REPRESENTATIVE ON ARRIVING AT AND BEFORE LEAVING THE SITE. PLANT ESTABLISHMENT PERIOD: THE PERIOD BETWEEN THE DATE OF PRACTICAL MAINTENANCE/ ESTABLISHMENT PERIOD: 12 MONTHS.

OF THE WORKS. THE CONTRACTOR SHALL COMMENCE AND FULLY IMPLEMENT THE SHORT-TERM

THE CONTRACTOR SHALL CONTINUOUSLY MAINTAIN ALL AREAS OF THE CONTRACT DURING THE PROGRESS

PLANT ESTABLISHMENT: MAINTAIN THE CONTRACT AREA DURING THE PLANT ESTABLISHMENT PERIOD. ENSURE THE GENERAL APPEARANCE AND PRESENTATION OF THE LANDSCAPE AND THE QUALITY OF PLANT MATERIAL AT DATE OF PRACTICAL COMPLETION IS MAINTAINED FOR THE FULL PLANTING ESTABLISHMENT PERIOD. EXISTING PLANT MATERIAL: MAINTAIN EXISTING PLANTING WITHIN THE LANDSCAPE CONTRACT AREA AS SPECIFIED FOR NEW PLANTING.

REPLACEMENTS: REPLACE FAILED, DEAD AND/OR DAMAGED PLANTS AT MINIMUM 3 WEEK INTERVALS AS NECESSARY

THROUGHOUT THE FULL PLANT ESTABLISHMENT PERIOD. REPORTING: SUBMIT REGULAR REPORTS BY THE LAST FRIDAY OF EACH MONTH SUMMARISING THE GENERAL STATUS OF WORKS. INCLUDE A MAINTENANCE SCHEDULE, A LOG BOOK OF MAINTENANCE ACTIVITY, SOIL TEST RESULTS AS REQUIRED FOR ANY FERTILISING PROGRAMS, AND PLANT REPLACEMENT REQUIREMENTS. WATER RESTRICTIONS: COORDINATE THE WATER SUPPLY AND CONFIRM THE WATERING REGIME AGAINST RELEVANT

GOVERNMENT LEGISLATION AND RESTRICTIONS AT THE TIME. STAKES AND TIES: REMOVE AT THE END OF THE PLANTING ESTABLISHMENT PERIOD. TEMPORARY FENCES: REMOVE TEMPORARY PROTECTIVE FENCES AT THE END OF THE PLANTING ESTABLISHMENT PERIOD.

COMPLIANCE: PLANT ESTABLISHMENT SHALL BE DEEMED COMPLETE, SUBJECT TO THE FOLLOWING:

* REPAIRS TO PLANTING MEDIA COMPLETED.

* PESTS, DISEASE, OR NUTRIENT DEFICIENCIES OR TOXICITIES ARE NOT EVIDENT. * MULCHED SURFACES HAVE BEEN MAINTAINED IN A WEED FREE AND TIDY

CONDITION AND TO THE SPECIFIED DEPTH

* VEGETATION IS ESTABLISHED AND WELL FORMED.

* PLANTS HAVE HEALTHY ROOT SYSTEMS.


* VEGETATION IS NOT RESTRICTING ESSENTIAL SIGHT LINES AND SIGNAGE.


* COLLECTION AND REMOVAL OF LITTER COMPLETED. * REMOVAL OF MULCH FROM DRAINAGE AND ACCESS AREAS COMPLETED.

* ALL DEFECTS NOTIFICATIONS HAVE BEEN CLOSED OUT.






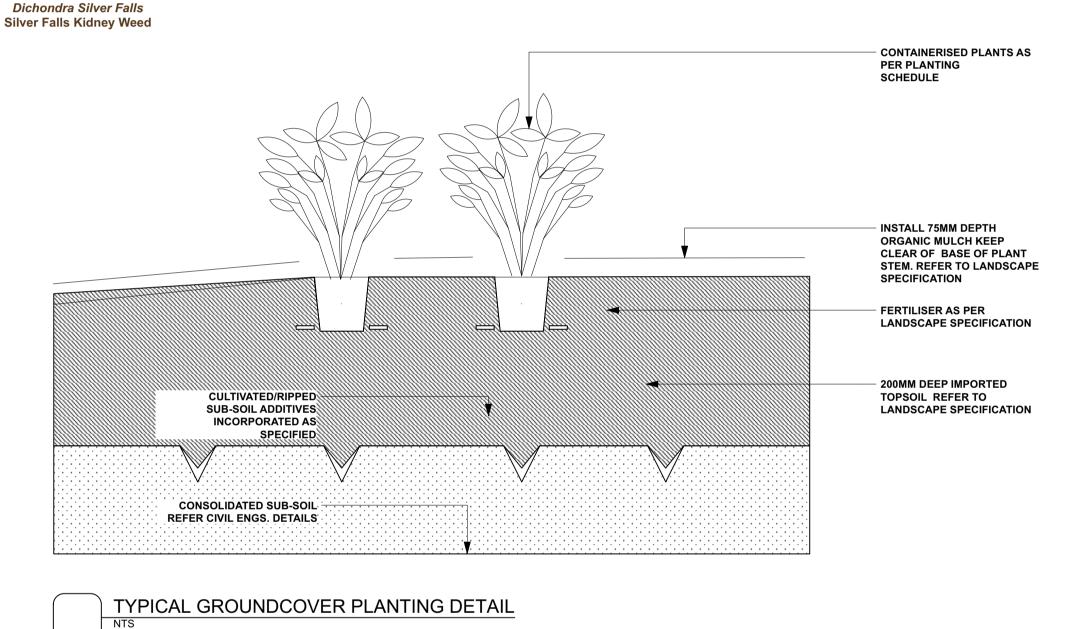

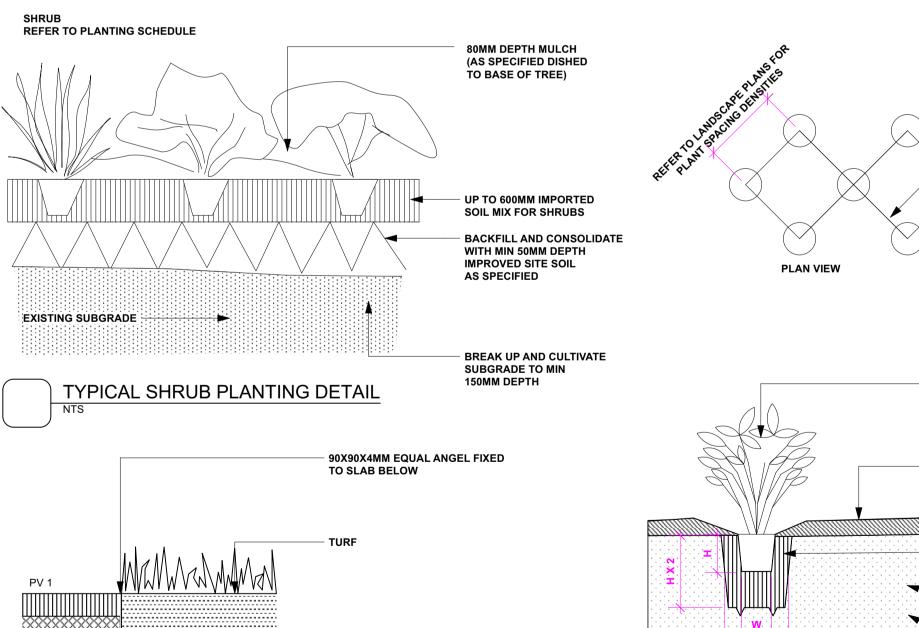

In Accordance with Warringah / Northern Beaches Councils Native Plant list.

75 % of Total Plants is Native Species 'N'

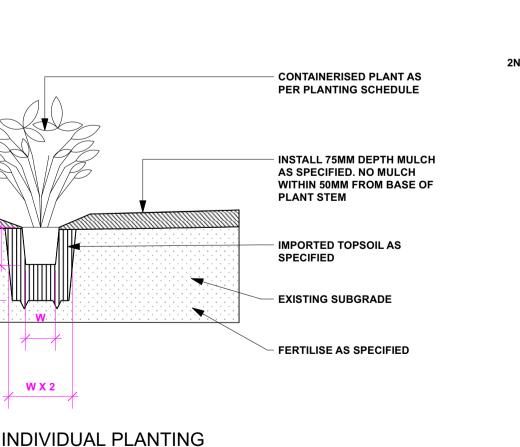


W X 2


STAGGERED PATTERN TO

CONTAINERISED PLANT AS

PER PLANTING SCHEDULE

DENSITIES AS SCHEDULE

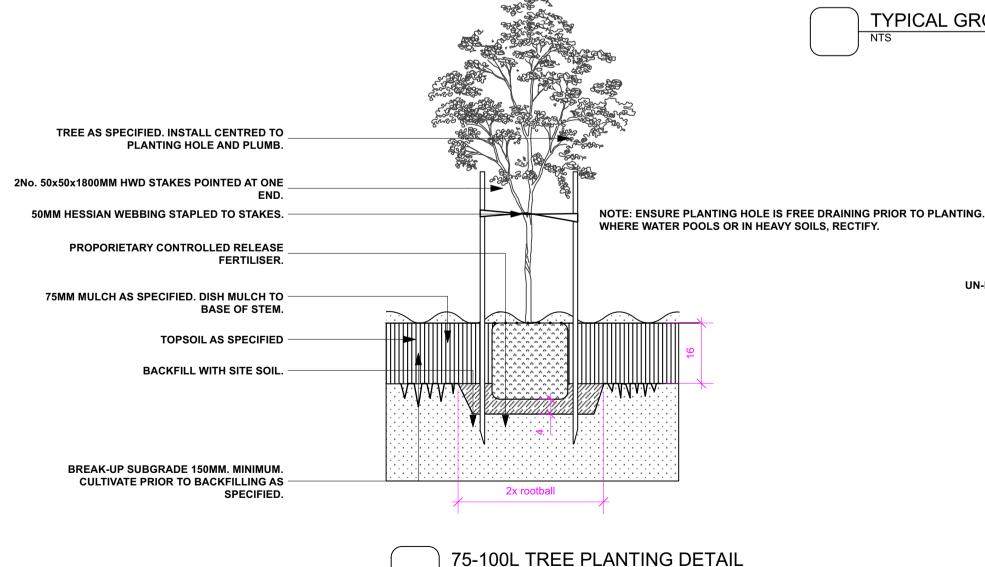

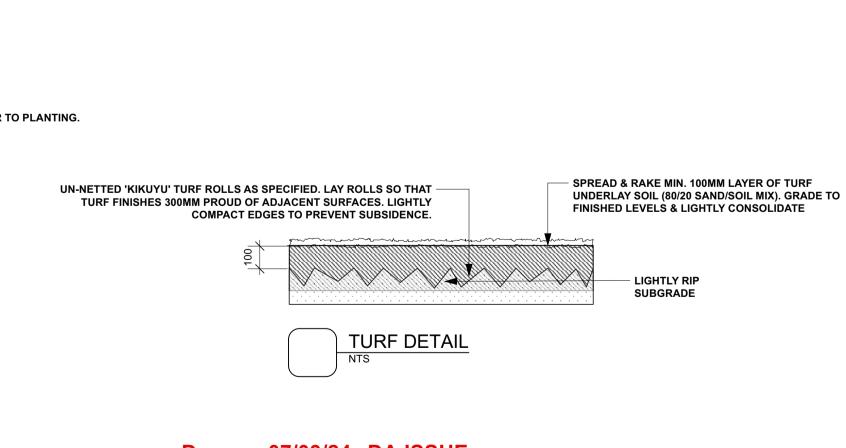

07/03/24 DA ISSUE ISSUE DATE COMMENT

AMENDMENTS

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EDGE TYPE 1 I 8MM CORTEN STEEL EDGE

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Project COLLAROY LIVING RESIDENCES DA LANDSCAPE Address

37-43 Hay Street Collaroy NSW 2097

Drawing Title PLANTING SCHEDULE AND DETAILS

Date 07/03/2024

Page

LIGHTLY RIP

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Scale N.T.S@A1 Drawing No. **1500**

LANDSCAPE WORK SPECIFICATION

PRELIMINARIES

1.01 GENERAL

The following general conditions should be considered prior to the commencement of landscape works:

The landscape plans should be read in conjunction with the architectural plans, hydraulic plans, service plans and survey prepared for the proposed development.

All services including existing drainage should be accurately located prior to the commencement of landscape installation. Any proposed tree planting which falls close to services will be relocated on site under the instruction of the landscape architect.

Installation of conduit for required irrigation, electrical and other services shall be completed prior to the commencement of hardscape works and

hardstand pours.

Anomalies that occur in these plans should be brought to our immediate attention.

All outdoor lighting specified by architect or client to be installed by qualified electrician

Where an Australian Standard applies for any landscape material testing or installation technique, that

standard shall be followed.

1.02 PROTECTION OF ADJACENT FINISHES

The Contractor shall take all precautions to prevent damage to all or any adjacent finishes by providing adequate protection to these areas / surfaces prior

to the commencement of the Works

1.03 PROTECTION OF EXISTING TREES

Existing trees identified to be retained shall be done so in accordance with NATSPEC Guide 2 "A Guide to Assessing Tree Quality". Where general works are occurring around such trees, or pruning is required, a qualified Arborist shall be engaged to oversee such works and manage tree health.

Existing trees designated on the drawing for retention shall be protected at all times during the construction period. Any soil within the drip-line of existing trees shall be excavated and removed by hand only. No stockpiling shall occur within the root zone of existing trees to be retained.

Any roots larger in diameter than 50mm shall only be severed under instruction by a qualified arborist. Roots smaller than 50mm diameter shall be cut cleanly with a saw.

Temporary fencing shall be installed around the base of all trees to be retained prior to the commencement of landscape works. Where possible this fencing

will be located around the drip line of these trees, or a minimum of 3m from the trunk. The fencing shall be maintained for the full construction period. 1.04 EROSION & POLLUTION CONTROL

The Contractor shall take all proper precautions to prevent the erosion of soil from the subject site. The contractor shall install erosion & sediment control barriers and as required by council, and maintain these barriers throughout the construction period. Note that the sediment control measures adopted should reflect the soil type and erosion characteristics of the site.

Erosion & pollution control measures shall incorporate the following:

- Construction of a sediment trap at the vehicle access point to the subject site.

- Sediment fencing using a geotextile filter fabric in the location indicated on the erosion control plan or as instructed on

site by the landscape architect.

- Earth banks to prevent scour of stockpiles

- Sandbag kerb sediment traps

Straw bale & geotextile sediment filter.

- Exposed banks shall be pegged with an approved Jute matting in preparation for mass planting

Refer to "Sitewise Reference Kit" as prepared by DLWC & WSROC (1997) for construction techniques

SOIL WORKS

2.01 MATERIALS

Specified Soil Conditioner (Generally to improve site soil)

The specified soil conditioner for site top-soil improvement shall be an organic mix, equal to "Botany Humus", as supplied by ANL. Note that for sites where soil testing indicates toxins or extremes in pH, or soils that are extremely poor, allow to excavate and supply 300mm of imported soil mix.

New gardens & proposed Planting New garden and planting areas shall consist of a 50/50 mix of clean site soil (refer d) below) and imported "Organic Garden Mix" as supplied by ANL or

approved equal. All mixes are to comply with AS 4419 Soils for landscaping & garden use, & AS 4454 Composts, Soil conditioners & mulches.

Specified Soil Mix - Turf

The specified soil mix for all turf areas shall be a min 75mm layer of imported soil mix consisting of 80% washed river sand (reasonably coarse), and 20% composted organic matter equivalent to mushroom compost or soil conditioner, or other approved lawn top dress.

Site Topsoil

Site topsoil is to be clean and free of unwanted matter such as gravel, cXXlay lumps, grass, weeds, tree roots, sticks, rubbish and plastics, and any deleterious materials and materials toxic to plants. The topsoil must have a pH of between 5.5 and 7. Use 100% imported soil mix when site when site

2.02 INSTALLATION

topsoil runs out.

a) Establishing Subgrade Levels

Subgrade levels are defined as the finished base levels prior to the placement of the specified material (i.e. soil conditioner). The following subgrade levels

shall apply:

GENERAL NOTES

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Mass Planting Beds - 300mm below existing levels with specified imported soil mix.

All work to be carried out in accordance with the Building Code of Australia, all Local and State Government Ordinances, relevant Australian Standards, Local

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Turf areas - 100mm below finished surface level.

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permission or accepted work practices resulting in inferior construction. Locate and protect all services prior to construction.

steel beams & columns, wind bracing to AS 1170

Note that all subgrades shall consist of a relatively free draining natural material, consisting of site topsoil placed previously by the Civil Contractor. No builders waste material shall be acceptable.

b) Subgrade Cultivation

Cultivate all subgrades to a minimum depth of 100mm in all planting beds and all turf areas, ensuring a thorough breakup of the subgrade into a reasonably coarse tilth. Grade subgrades to provide falls to surface and subsurface drains, prior to the placement of the final specified soil mix. c) Drainage Works

Install surface and subsurface drainage where required and as detailed on the drawing. Drain subsurface drains to outlets provided, with a minimum fall of 1:100 to outlets and / or service pits.

d) Placement and Preparation of Specified Soil Conditioner & Mixes.

Trees in turf & beds - Holes shall be twice as wide as root ball and minimum 100mm deeper - backfill hole with 50/50 mix of clean site soil and imported "Organic Garden Mix" as supplied by ANL or approved equal.

Mass Planting Beds - Install specified soil conditioner to a compacted depth of 100mm

Place the specified soil conditioner to the required compacted depth and use a rotary hoe to thoroughly mix the conditioner into the top 300mm of

garden bed soil. Ensure thorough mixing and the preparation of a reasonably fine tilth and good growing medium in preparation for planting. Turf Areas - Install specified soil mix to a minimum compacted depth of 75mm.

Place the specified soil mix to the required compacted depth and grade to required finished soil levels, in preparation for planting and turfing. **PLANTING**

3.01 MATERIALS

a) Quality and Size of Plant Material

All trees supplied above a 25L container size must be grown and planted in accordance with Clarke, R 1996 Purchasing Landscape Trees: A guide to assessing tree quality. Natspec Guide No. 2. Certification that trees have been grown to Natspec guidelines is to be provided upon request of Council's Tree Management Officer.

Above - Ground Assessment:

The following plant quality assessment criteria should be followed:

Plant true to type, Good vigour and health, free from pest & disease, free from injury, self-supporting, good stem taper, has been pruned correctly, is apically dominant, has even crown symmetry, free from included bark & stem junctions, even trunk position in pot, good stem structure

Below - Ground Assessment:

Good root division & direction, rootball occupancy, rootball depth, height of crown, non-suckering For further explanation and description of these assessment criteria, refer to Ross Clark's book.

All Plant material shall be to the type and size specified. No substitutions of plant material shall be permitted without written prior approval by the Landscape Architect. No plant shall be accepted which does not conform to the standards listed above.

b) Stakes and Ties

Provide min. 3 No. Stakes and ties to all plants identified as trees in the plant schedule. Stakes shall be sound, unpainted, straight hardwood, free of knots and pointed at one end. They shall be 2200mm x 50mm x 50mm Hardwood, or approved alternative. Ties shall be 50mm wide hessian webbing material.

c) Fertilisers

d) Mulch

Fertilisers shall be approved slow release fertilisers suitable for the proposed planting types. Note that for native plants, specifically Proteaceae family plants including Grevillea species, low phosphorus fertilizers shall be used.

Mulch shall be an approved equal to "Forest Blend" as supplied by ANL. Mulch shall be completely free from any soil, weeds, rubbish or other debris.

Turf shall be "Sir Walter" Buffalo or equivalent (unless stated otherwise), free from any weeds and other grasses, and be in a healthy growing condition.

3.02 INSTALLATION

a) Setting Out

All planting set out shall be in strict accordance with the drawings, or as directed. Note that proposed tree planting located near services should be adjusted at this stage. Notify Landscape Architect for inspection for approval prior to planting. b) Planting

All plant material shall be planted as soon after delivery as possible. Planting holes for trees shall be excavated as detailed and specified. Plant containers shall be removed and discarded, and the outer roots gently teased from the soil mass. Immediately set plant in hole and backfill with specified soil mix, incorporating the approved quantity of fertiliser for each plant type. Ensure that plants are set plumb vertically and root balls set to the consolidated finished grades detailed on the drawings. Compact the backfilled soil and saturate by hand watering to expel any remaining air pockets immediately after

c) Staking and Tying

Staking and tying shall be in strict accordance with the drawings and shall occur immediately following plant placement and soil backfilling. All plants identified as "Trees" on the planting schedule shall be staked with a min. 3 stakes.

d) Mulching

Mulch should be spread so that a compacted thickness of 75mm is achieved after settlement in all planting beds and around each individual plant. Apply immediately following planting and watering in, ensuring that a 50mm radius is maintained around the trunk of each plant. There shall be no mixing of soil and mulch material.

e) Turfing

Moisten soil prior to the turf being laid. Turf shall be neatly but jointed and true to grade to finish flush with adjacent surfaces. Incorporate a lawn fertilizer and thoroughly water in. Keep turf moist until roots have taken and sods/rolls cannot be lifted. Keep all traffic off turf until this has occurred. Allow for top dressing of all turf areas. All turf shall be rolled immediately following installation.

f) Steel Garden Edging

The Contractor shall install stone edging as shown on the drawings, to all mass planting beds adjoining turf or gravel mulched areas, and where required. The resultant edge shall be true to line and flush with adjacent surfaces.

HARDSCAPE WORKS

4.01 GENERAL

The Contractor shall undertake the installation of all hardscape works as detailed on the drawing, or where not detailed, by manufacturers specification.

Paving - refer to typical details provided, and applicable Australian Standards. Permeable paving may be used as a suitable means of satisfying Council permeable surface requirements, while providing a useable, hardwearing, practical surface. In most instances, the client shall nominate the appropriate paving material to be used.

Australian Standards shall be adhered to in relation to all concrete, masonry & metal work. Some details are typical and may vary on site. All hardscape works shall be setout as per the drawings, and inspected and approved by the Landscape Architect prior to installation. All workmanship shall be of the highest standard. Any queries or problems that arise from hardscape variations should be bought to the attention of the Landscape Architect.

Your attention is directed to any obligations or responsibilities under the Dividing Fences Act, 1991 in respect of adjoining property owner/s which may arise from this application. Any enquiries in this regard may be made to the Crown Lands Division on (02) 8836 5332

IRRIGATION WORKS

5.01 GENERAL (PERFORMANCE SPECIFICATION)

An automated drip-irrigation system is to be installed to all gardens, planters and lawn areas in accordance with the approved Irrigation Design.

This system shall be designed and installed by a qualified and licensed irrigation specialist, to the highest industry standards and to maximise the efficient usage of water.

The Installer is required to obtain all approvals necessary for the completion of works in accordance with the Laws of Australia, Laws of the State of NSW, Council By-Laws and Ordinances.

Drawings:

- The Landscape Contractor nominated Licensed Irrigation Specialist shall provide irrigation drawings for approval upon engagement.

Design Requirements:

- The irrigation system shall be installed prior to all planting works. It shall incorporate a commercially available irrigation system, with sub-surface dripper lines to irrigate all gardens, planters and lawn areas.

· It shall incorporate a suitable back flow prevention device for the scale of works, an in-line filter, check valves, and suitable high and low density poly hose fittings and PVC piping to achieve flow rates suitable for specified planting.

- The irrigation application rate shall not exceed the infiltration rate of the soil or creates run-off.

- The landscape contractor shall check the existing pressure available from the ring mains and size irrigation piping to suit. Supply shall be from local hose cock where available.

· All piping and fittings shall be buried 50mm below the finished soil levels in garden and lawn areas, and secured in position at 500mm centres with galv wire pins.

Size of pipes shall be selected to ensure the working pressure at the end of the line does not decrease by more than 5%.

- Co-ordination required by Landscape Contractor or Project Manager to provide required conduit, pipe work and penetration through slabs and planter walls for water

The Landscape Contractor shall be engaged with the Irrigation Specialist to co-ordinate with the Project Manager to identify the preferred service and conduit locations.

- Project Manager and Landscape Contractor to establish area suitable for irrigation control system with required area, power provision and water supply.

Upon completion of installation, the system shall be tested, including:

· Main Line Pressure Test: The main line is pressurised to test for leaks. All valves are shut and the pressure is taken over a determined length of time.

- Dripper Pressure Test: Measurement at flushing valves are taken and the pressure gauged to make sure it conforms to the manufacturer recommendations. The inlet pressure is then tested under the same conditions to check it does not exceed 300Kpa.

- All components are to be satisfactorily functional and operational prior to approval. Should any defect develop, or the capacity or efficiency of the system decline during the agreed maintenance system, then these faults shall be immediately rectified.

- A full 12 month warranty shall be included to cover labour and all parts.

Further Documentation:

On request, a detailed irrigation performance specification report can be issued.

12 MONTH MAINTENANCE

6.01 GENERAL

The consolidation and maintenance period shall be 12 months beginning from the approved completion of the specified construction work (Practical Completion). A qualified landscape maintenance contractor shall undertake the required landscape maintenance works. Consolidation and maintenance shall mean the care and maintenance of Contracted works by accepted landscaping or horticultural practices, ensuring that all plants are in optimum growing conditions and appearance at all times, as well as rectifying any defects that become apparent in the contracted works.

This shall include, but not be limited to, the following items where and as required: Watering all planting and lawn areas / irrigation maintenance.

Clearing litter and other debris from landscaped areas.

Removing weeds, pruning and general plant maintenance.

Replacement of damaged, stolen or unhealthy plants. Make good areas of soil subsidence or erosion.

Topping up of mulched areas.

Spray / treatment for Insect and disease control.

Fertilizing with approved fertilizers at correct rates.

Mowing lawns & trimming edges each 14 days in summer or 18 days in winter Adjusting ties to Stakes

Maintenance of all paving, retaining and hardscape elements.

On the completion of the maintenance period, the landscape works shall be inspected and at the satisfaction of the superintendent or landscape architect, the responsibility will be signed over to the client.xx

> 07/03/24 DA ISSUE ISSUE DATE COMMENT

AMENDMENTS

Page

COLLAROY LIVING RESIDENCES DA LANDSCAPE Project 37-43 Hay Street Collaroy NSW 2097 Address Date 07/03/2024 Drawing Title **SPECIFICATION** Scale N.T.S@A1

Drawing No. **1500**

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